

# Défense nationale .....

# DEW LINE CLEAN UP PROJECT

DRAWING INDEX						
DRAWING No.	TITLE	DRAWING No.	TITLE	DRAWING No.	TITLE	
SITING		SITING	SITING		STRUCTURAL	
H-B264/1-9101-101	OVERALL SITE PLAN	H <del>-B264/1-9101-114</del>	NORTH LANDFILL (LOBE A) PLAN AND CROSS SECTION	H <del>-B264/1-9101-204</del>	GARAGE PLAN AND SECTION	
H-B264/1-9101-102	PROJECT LAYOUT SHEET 1	H-B264/1-9101-115	NON-HAZARDOUS WASTE LANDFILL BERM CONSTRUCTION AND FINAL GRADING PLANS	H-B264/1-9101-205	MODULE TRAIN UNITS 1A-25 PLAN	
H-B264/1-9101-103	PROJECT LAYOUT SHEET 2	H-B264/1-9101-116	NON-HAZARDOUS WASTE LANDFILL CROSS SECTIONS AND DETAIL	H-B264/1-9101-206	MODULE TRAIN UNITS 1A-25 ELEVATIONS	
H-B264/1-9101-104	NORTHWEST LANDFILL AREA SITE PLAN	H-B264/1-9101-117	TIER II DISPOSAL FACILITY KEY TRENCH EXCAVATION PLAN & GRADING/INSTRUMENTATION PLAN	H-B264/1-9101-207	HANGAR PLAN AND SECTION	
H-B264/1-9101-105	NORTH LANDFILL AREA SITE PLAN	H-B264/1-9101-118	TIER II DISPOSAL FACILITY CROSS SECTION AND DETAIL	H <del>-B264/1-9101-208</del>	POL PUMPHOUSE PLAN AND ELEVATIONS	
H-B264/1-9101-106	STATION AREA-WEST SITE PLAN	H-B264/1-9101-119	SOUTH-LANDFILL (MIDDLE LOBE) EXCAVATION PLAN	H-B264/1-9101-209	RADAR TOWER/RADOME PLAN AND SECTION	
H-B264/1-9101-107	STATION AREA SITE PLAN	H-B264/1-9101-120	CLOSED LANDFARM CROSS SECTION	H-B264/1-9101-210	COMMUNICATION BISH ELEVATIONS	
H-B264/1-9101-108	STATION AREA SOUTH SITE PLAN	H-B264/1-9101-121 MISCELLANEOUS DE TAILS H-B264/1-9101-211 FEEDHORN-		COMMUNICATION BILLBOARD, FEEDHORN AND WAVEGUIDE PLAN, SECTIONS AND ELEVATIONS		
H-B264/1-9101-109	AIRSTRIP AREA SITE PLAN	H <del>-B264/1-9101-122</del>	MISCELLANEOUS DETAILS SHEET 2	H <del>-B264/1-9101-212</del>	FUEL TANKS PLAN AND ELEVATIONS	
H-B264/1-9101-110	SOUTH LANDFILL AREA SITE PLAN	STRUCTURAL		H-B264/1-9101-213	AIRSTRIP ANCILLARY FACILITIES STANDARD DETAILS	
H-B264/1-9101-111	LANDFARM AREA SITE PLAN	H-B264/1-9101-201	H-B264/1-9101-201 STATION AREA DEMOLITION SITE PLAN			
H-B264/1-9101-112	BEACH AREA SITE PLAN	H-B264/1-9101-202	AIRSTRIP AREA AND BEACH AREA DEMOLITION SITE PLANS	CANADA 2	STY THE QUEEN IN RIGHT OF 013, AS REPRESENTED BY THE	
H-B264/1-9101-113	NORTH LANDFILL (LOBE B) PLAN AND CROSS SECTION	H <del>-B264/1-9101-203</del>	WAREHOUSE PLAN, SECTION AND ELEVATION	MINISTER OF NATIONAL DEFENCE.		

#### NOTE


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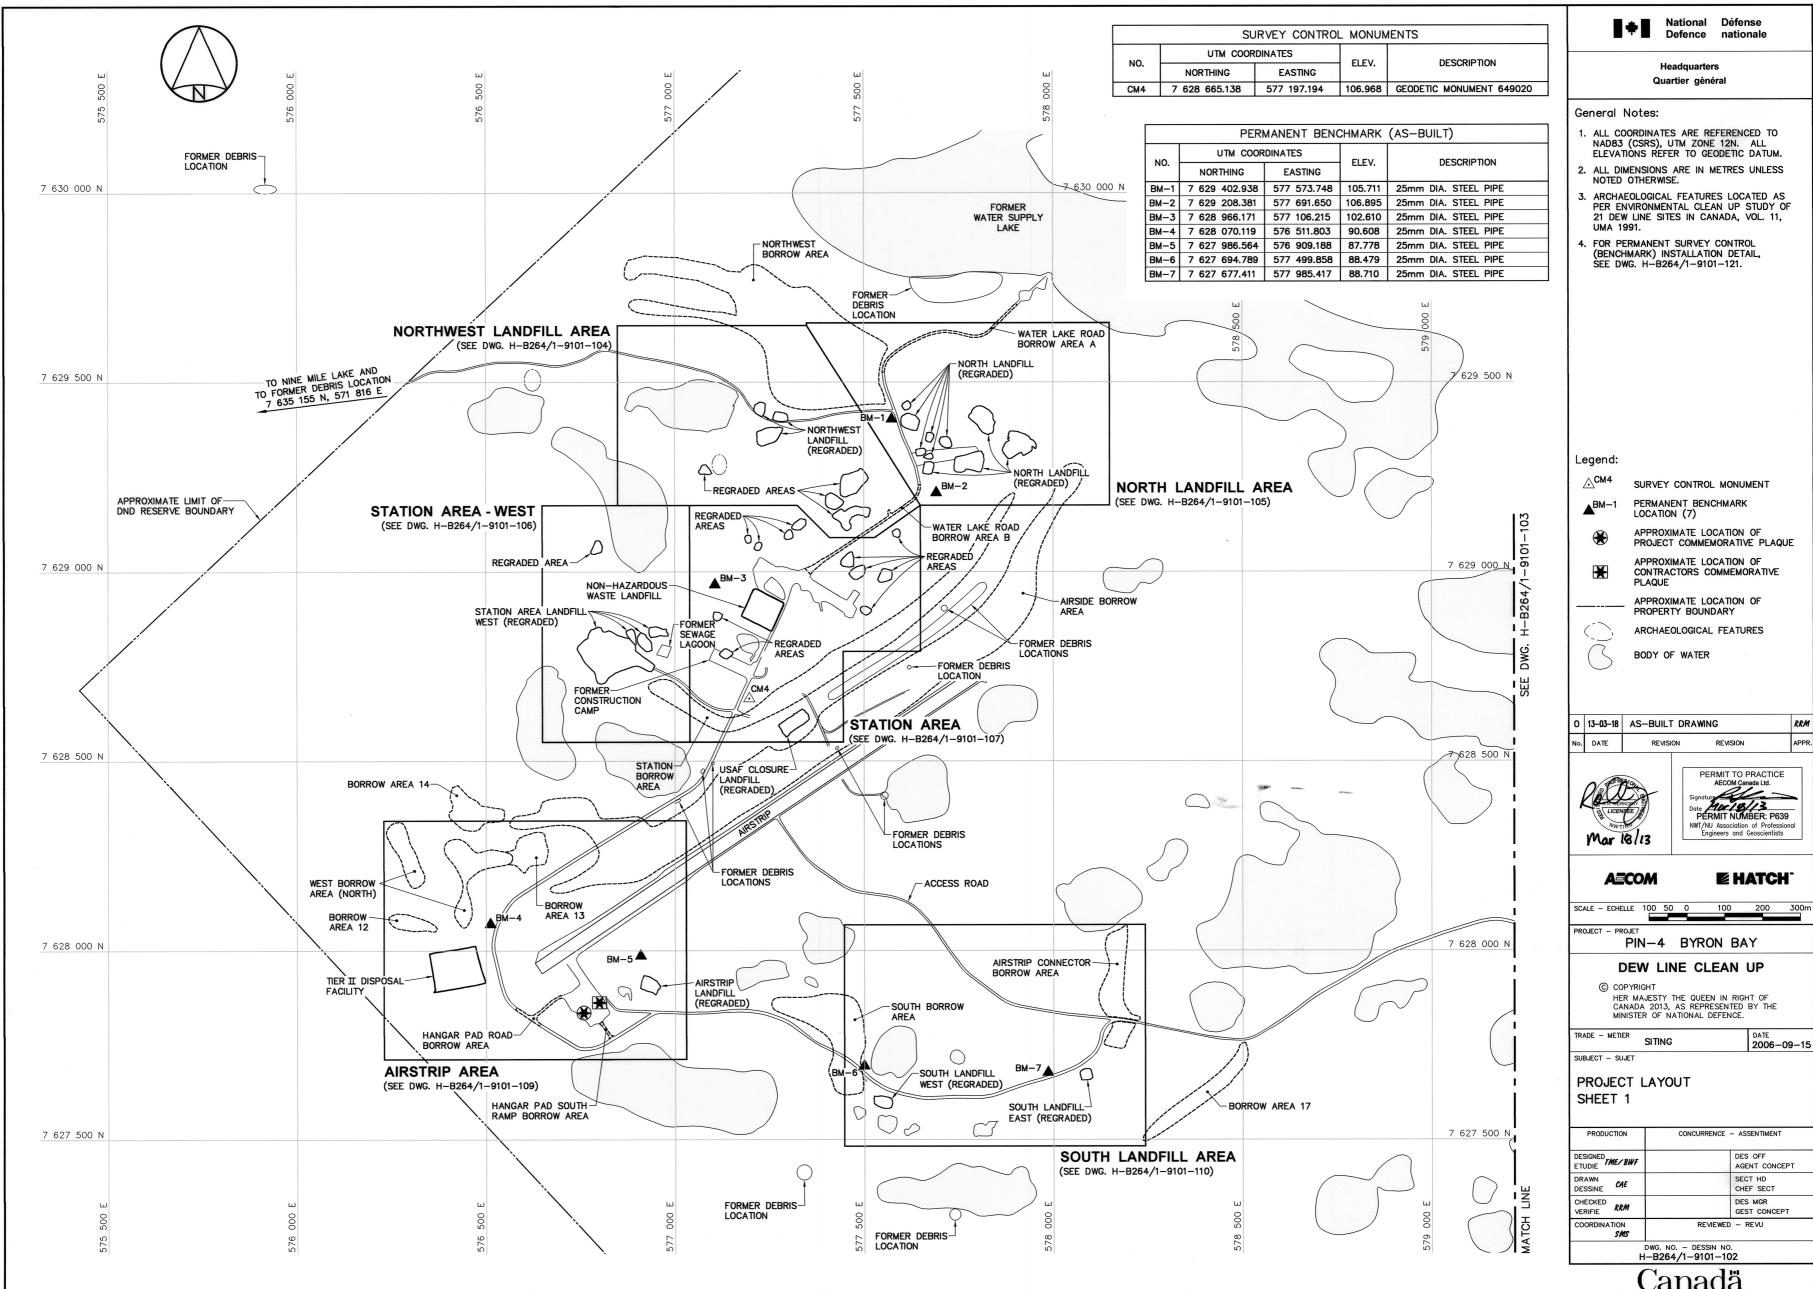



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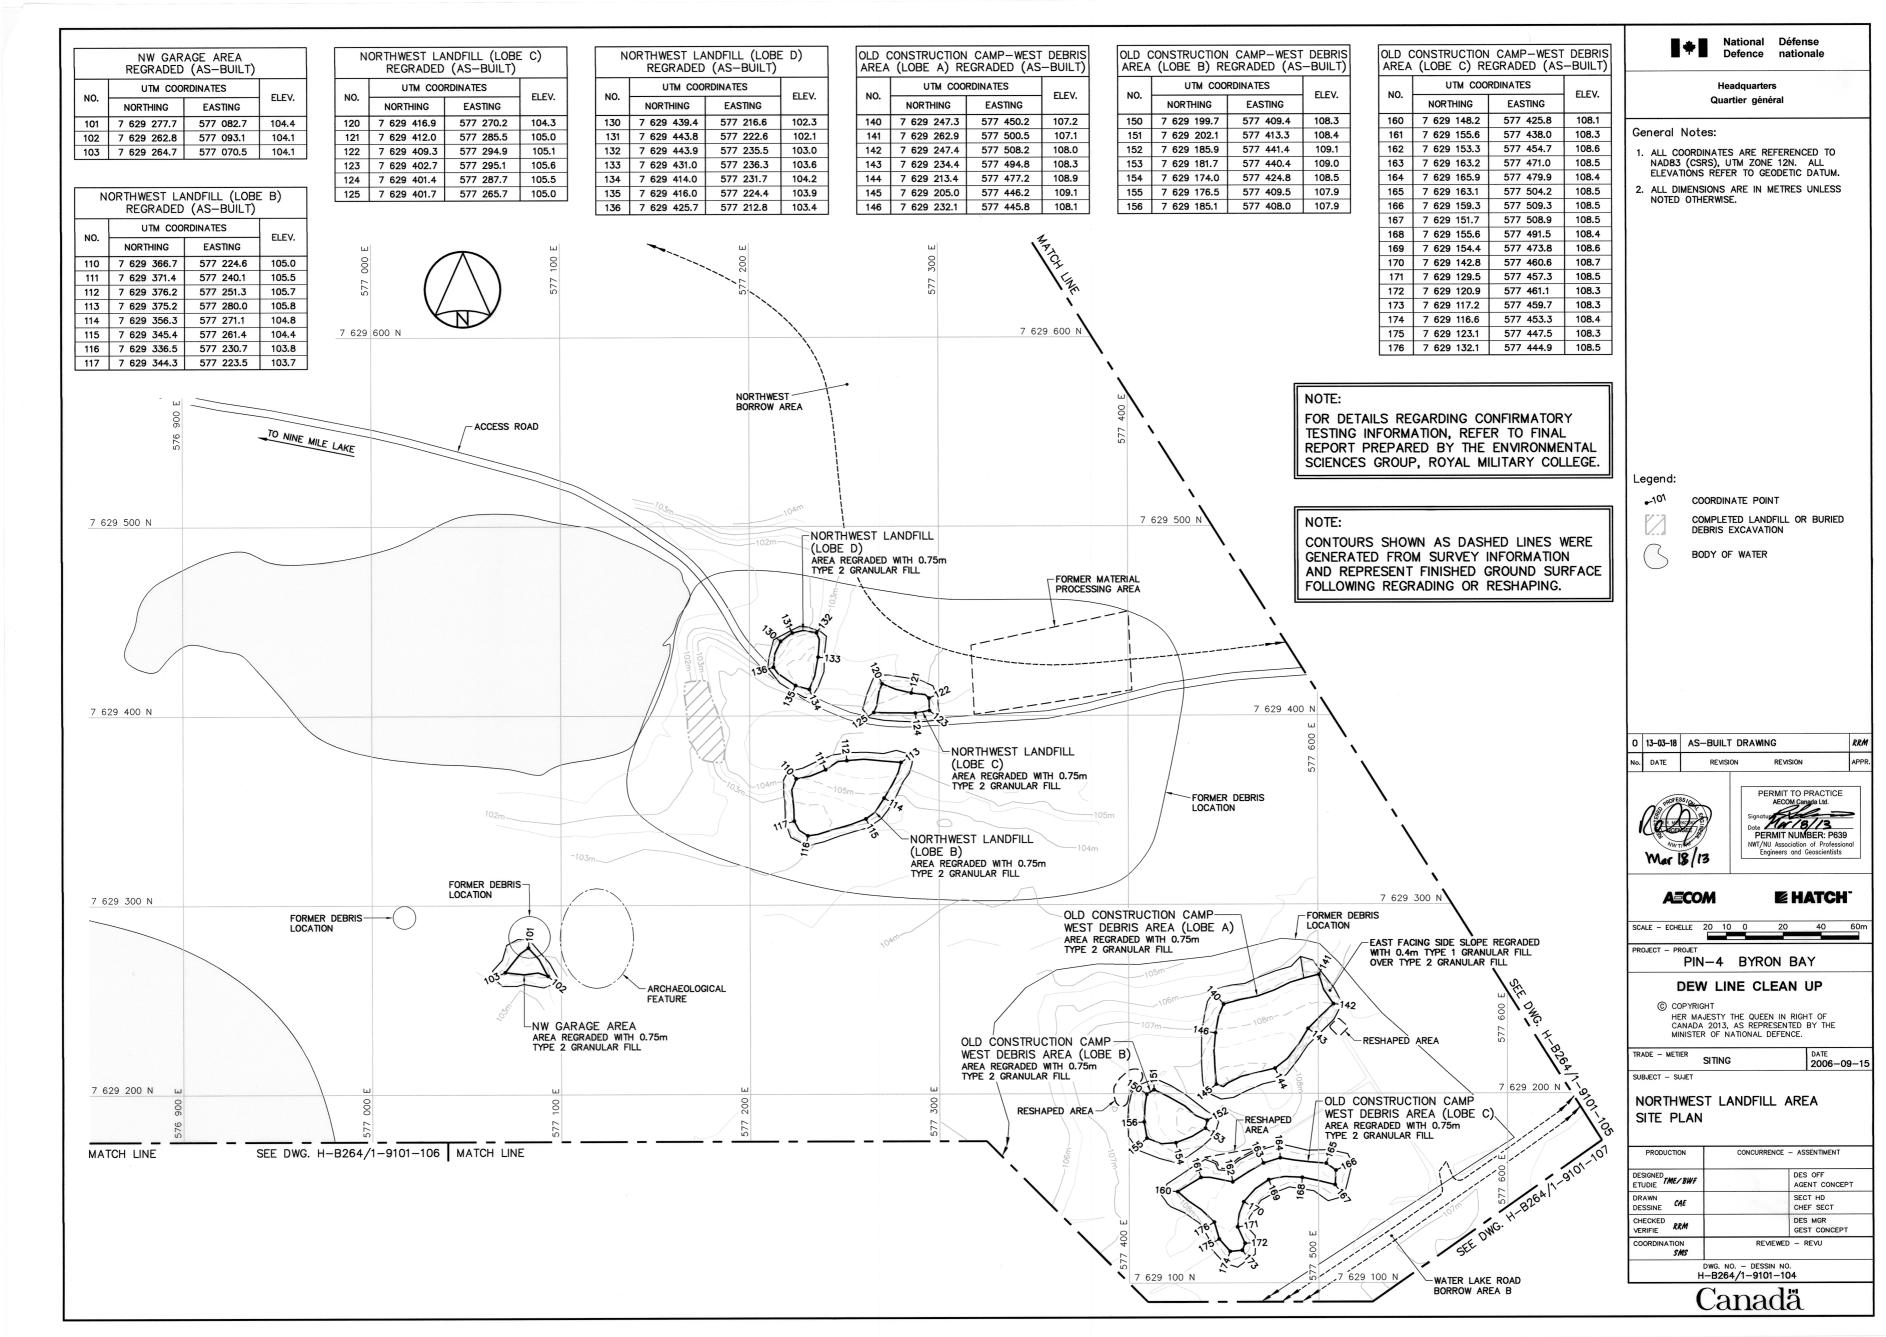



**MARCH, 2013** 





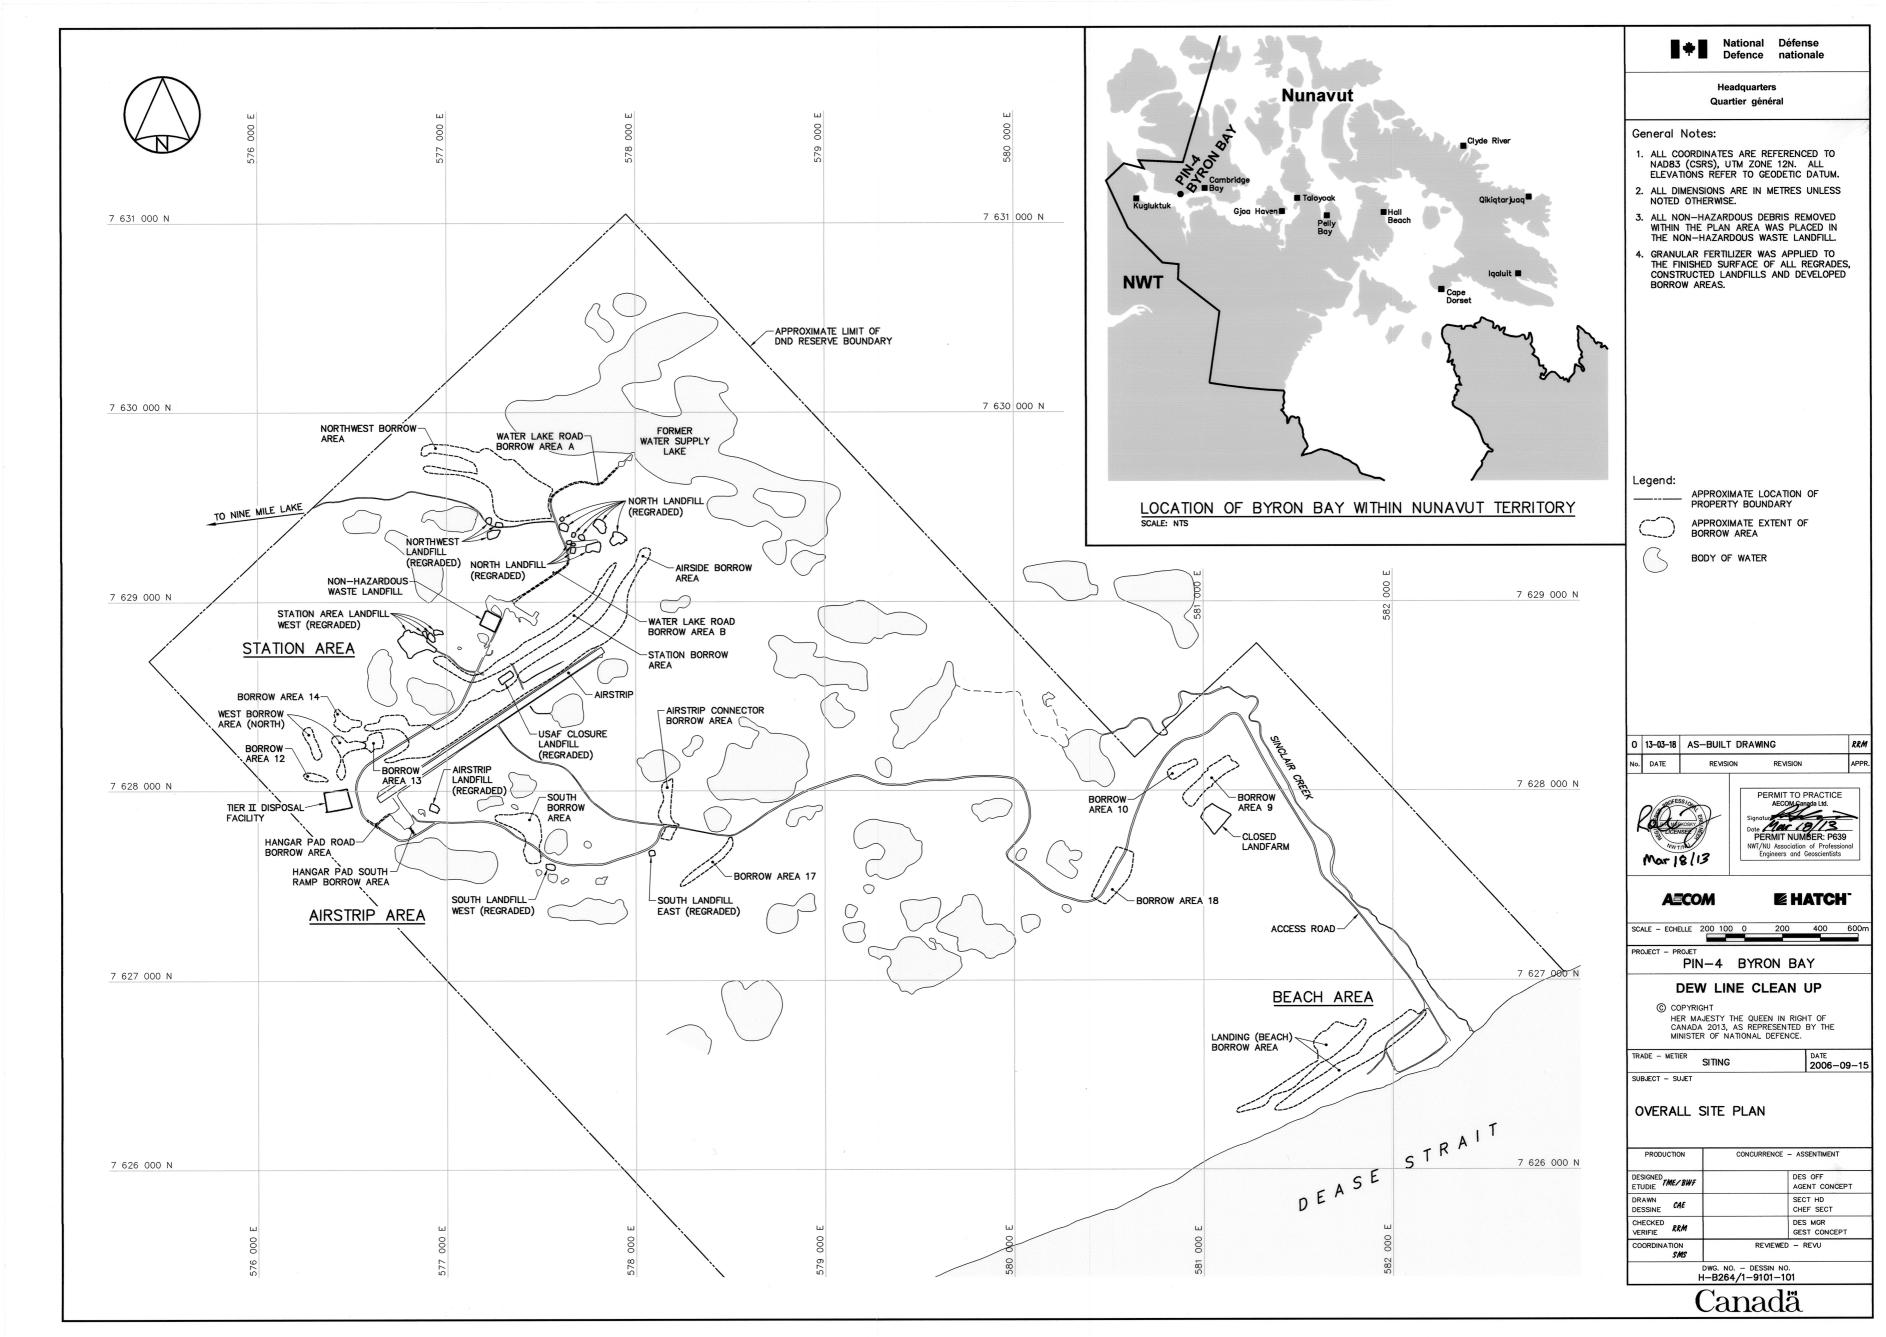

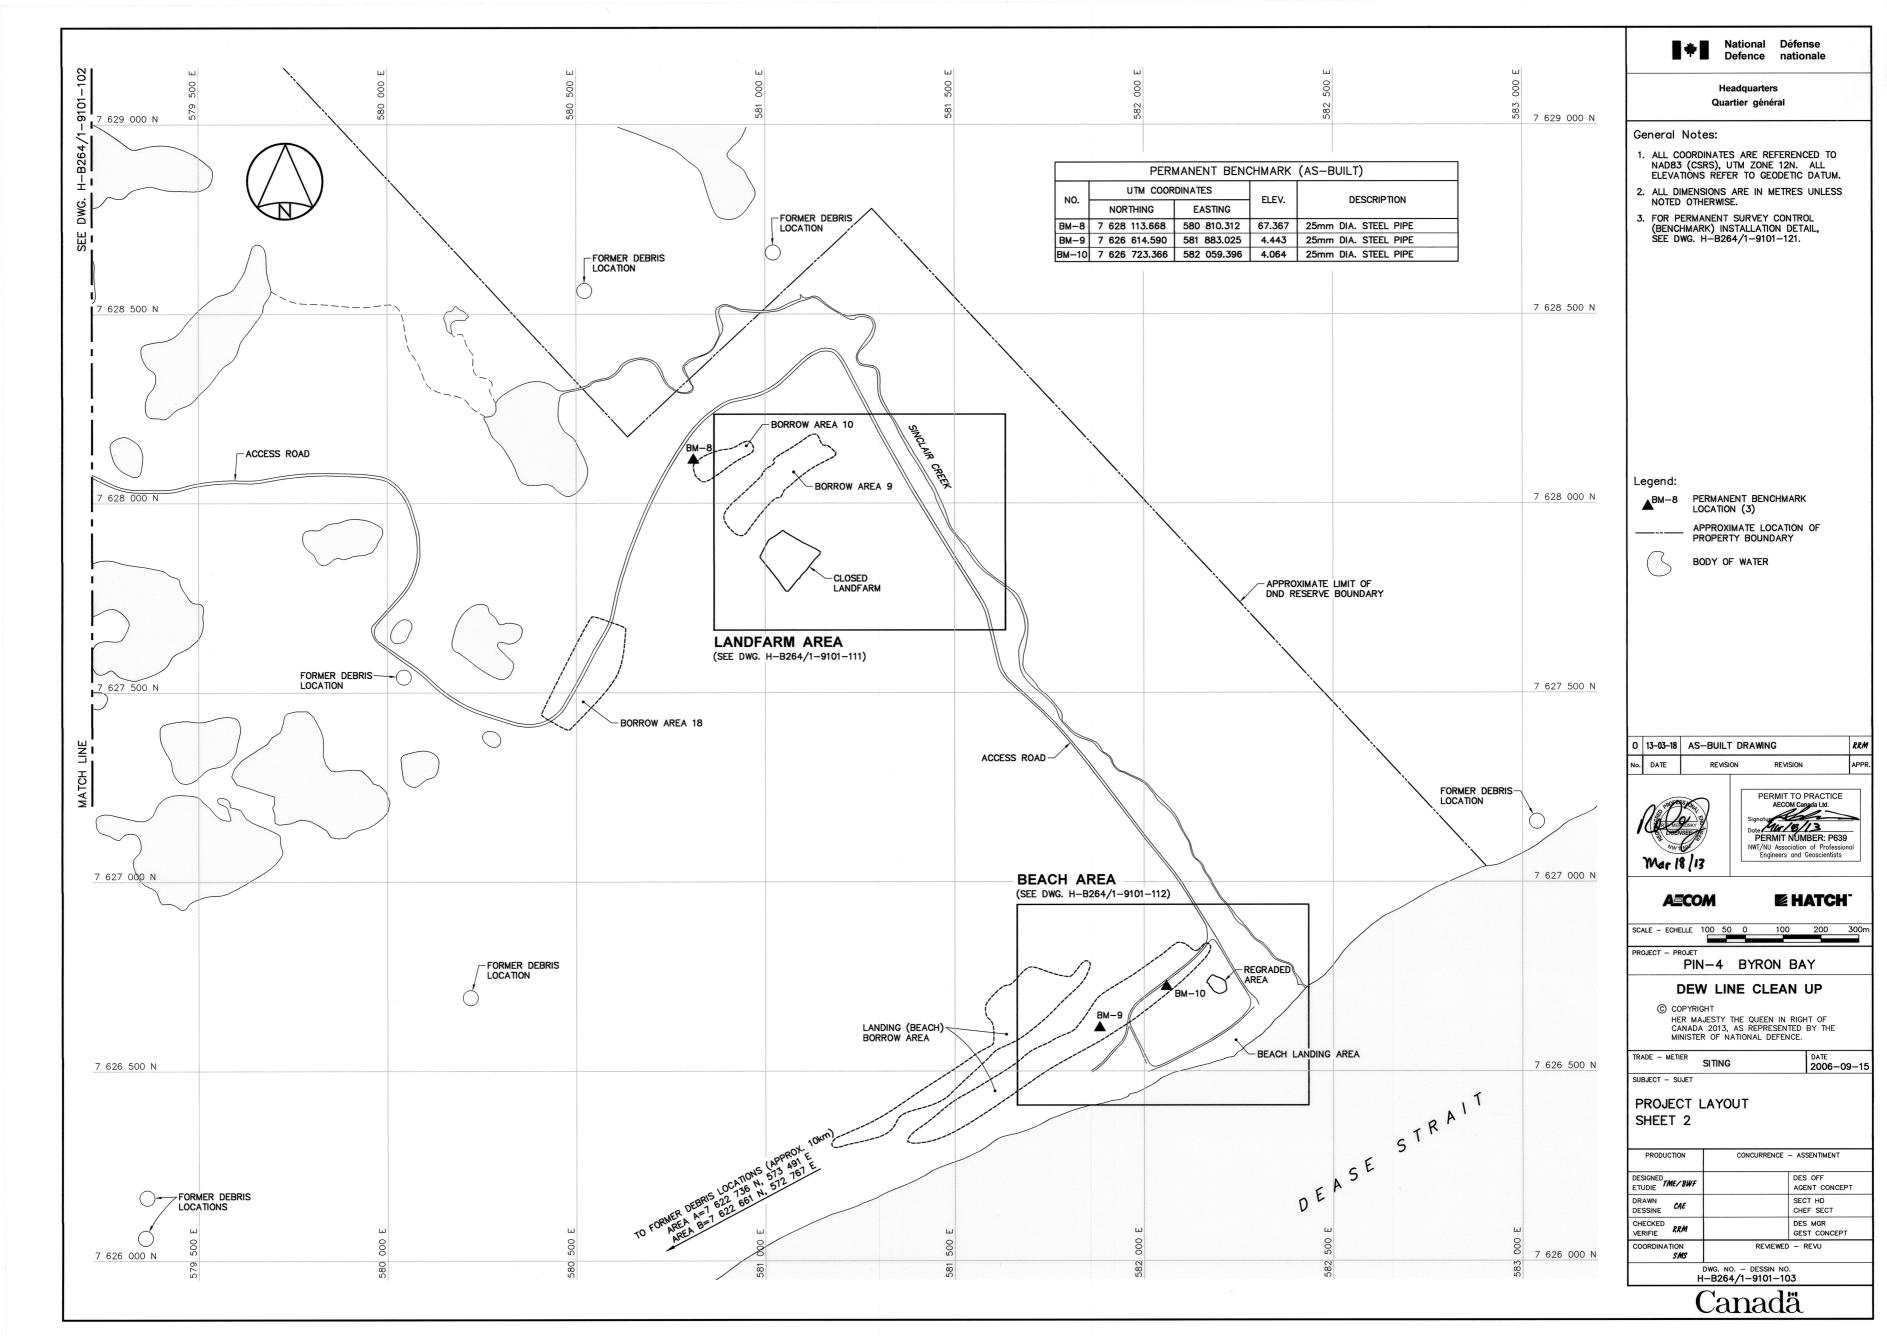

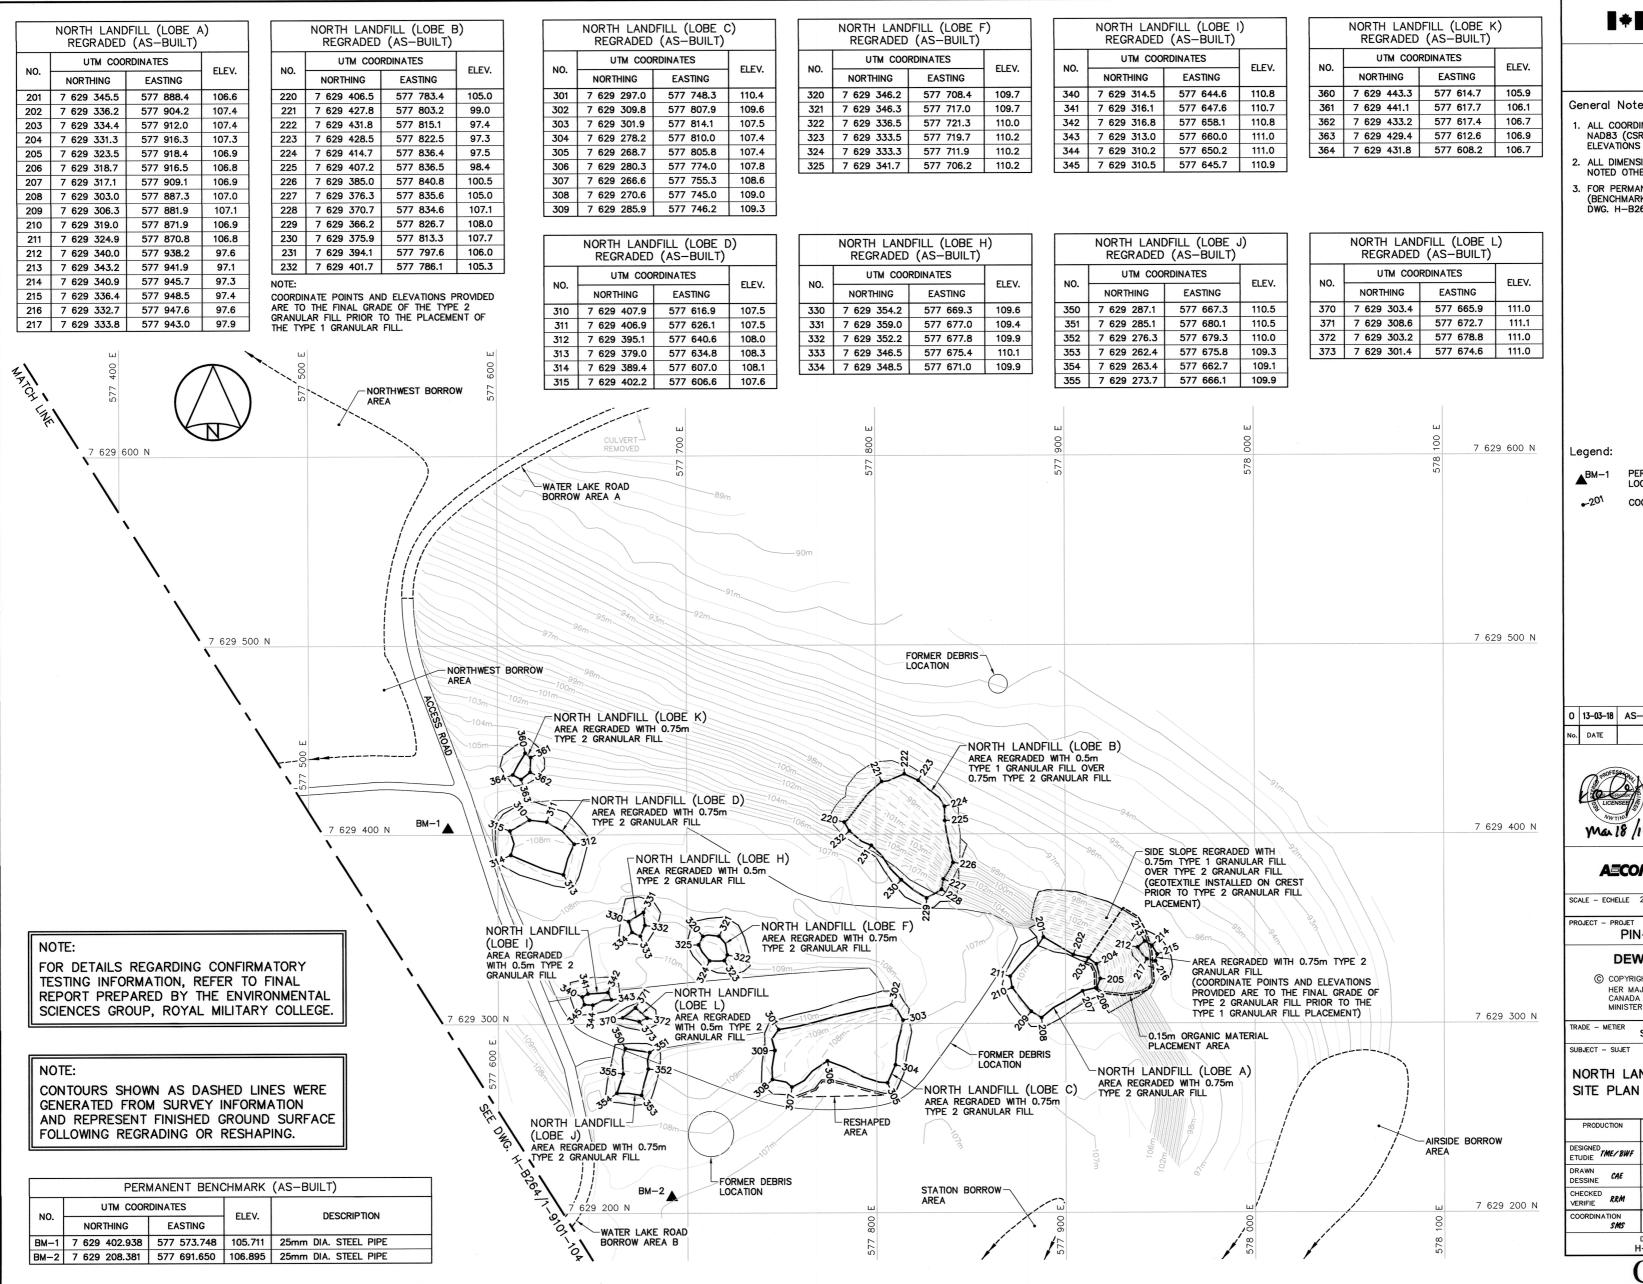

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#### General Notes:

- 1. ALL COORDINATES ARE REFERENCED TO NAD83 (CSRS), UTM ZONE 12N. ALL ELEVATIONS REFER TO GEODETIC DATUM.
- 2. ALL DIMENSIONS ARE IN METRES UNLESS NOTED OTHERWISE.
- 3. FOR PERMANENT SURVEY CONTROL (BENCHMARK) INSTALLATION DETAIL, SEE DWG. H-B264/1-9101-121.

PERMANENT BENCHMARK LOCATION (2)

COORDINATE POINT

O 13-03-18 AS-BUILT DRAWING APP REVISION





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**EHATCH** 

DATE 2006-09-15

PIN-4 BYRON BAY

# **DEW LINE CLEAN UP**


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NORTH LANDFILL AREA

PRODUCTION	CONCURRENCE - ASSENTIMENT
DESIGNED TME/BWF	DES OFF AGENT CONCEPT
DRAWN DESSINE CAE	SECT HD CHEF SECT
CHECKED RRM	DES MGR GEST CONCEPT
COORDINATION SMS	REVIEWED - REVU





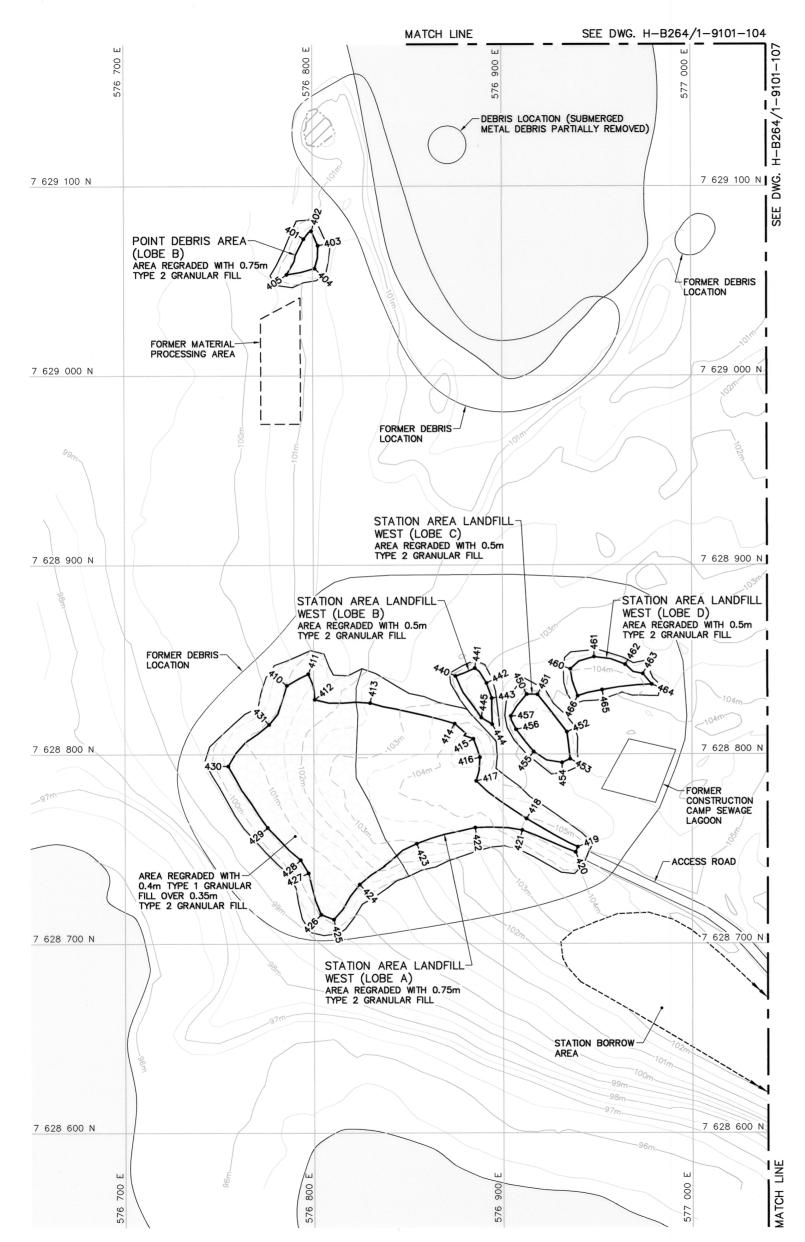

FOR DETAILS REGARDING CONFIRMATORY TESTING INFORMATION, REFER TO FINAL REPORT PREPARED BY THE ENVIRONMENTAL SCIENCES GROUP, ROYAL MILITARY COLLEGE.

#### NOTE:

CONTOURS SHOWN AS DASHED LINES WERE GENERATED FROM SURVEY INFORMATION AND REPRESENT FINISHED GROUND SURFACE FOLLOWING REGRADING OR RESHAPING.

POINT DEBRIS AREA (LOBE B) REGRADED (AS-BUILT)						
NO.	UTM COORDINATES					
NO.	NORTHING	EASTING	ELEV.			
401	7 629 072.3	576 795.3	101.8			
402	7 629 076.5	576 799.4	101.8			
403	7 629 068.8	576 802.9	102.0			
404	7 629 056.8	576 801.2	102.0			
405	7 629 053.5	576 786.3	101.4			

STATION AREA LANDFILL—WEST (LOBE A) REGRADED (AS—BUILT)					
NO.	UTM COO	RDINATES	ELEV.		
NO.	NORTHING	EASTING	ELEV.		
410	7 628 836.5	576 785.9	101.0		
411	7 628 842.6	576 797.3	101.5		
412	7 628 829.1	576 800.6	101.7		
413	7 628 827.2	576 829.9	102.7		
414	7 628 816.2	576 874.6	103.9		
415	7 628 808.2	576 884.5	104.9		
416	7 628 798.4	576 887.9	104.9		
417	7 628 785.9	576 886.0	104.3		
418	7 628 765.9	576 912.5	105.0		
419	7 628 751.0	576 939.6	105.5		
420	7 628 748.2	576 938.5	105.4		
421	7 628 759.9	576 910.3	105.0		
422	7 628 761.2	576 885.4	103.7		
423	7 628 752.8	576 854.5	103.0		
424	7 628 731.3	576 824.2	101.1		
425	7 628 712.9	576 810.5	100.1		
426	7 628 715.4	576 803.8	100.1		
427	7 628 737.3	576 797.2	100.6		
428	7 628 744.2	576 793.0	100.7		
429	7 628 761.3	576 775.6	100.5		
430	7 628 793.8	576 754.8	100.6		
431	7 628 815.8	576 776.4	101.1		

	UTM COO	ELEV.	
NO.	NORTHING	EASTING	ELEV.
440	7 628 841.4	576 875.2	103.2
441	7 628 845.6	576 885.4	103.4
442	7 628 837.7	576 891.6	103.5
443	7 628 829.7	576 894.2	103.6
444	7 628 815.8	576 894.5	103.6
445	7 628 819.4	576 888.7	103.5

STATION AREA LANDFILL-WEST (LOBE B)

N AREA LANDFILL-WEST (LOBE A) REGRADED (AS-BUILT)			STA	TIC	ON AREA LAN REGRADED	DFILL-WEST (I (AS-BUILT)	LOBE C)
UTM COO	RDINATES	ELEV.		UTM COORDINATES			5157
NORTHING	EASTING	ELEV.	NO	.	NORTHING	EASTING	ELEV.
7 628 836.5	576 785.9	101.0	450	5	7 628 831.8	576 912.7	104.2
7 628 842.6	576 797.3	101.5	45	1	7 628 831.6	576 918.4	104.1
7 628 829.1	576 800.6	101.7	452	2	7 628 811.8	576 933.9	104.7
7 628 827.2	576 829.9	102.7	453	3	7 628 797.5	576 935.7	104.8
7 628 816.2	576 874.6	103.9	454	4	7 628 795.5	576 931.4	104.9
7 628 808.2	576 884.5	104.9	455	5	7 628 801.3	576 916.4	104.6
7 628 798.4	576 887.9	104.9	456	3	7 628 813.1	576 907.1	104.3
7 628 785.9	576 886.0	104.3	45	7	7 628 820.2	576 904.3	104.1
7 628 765.9	576 912.5	105.0			1		
7 628 751.0	576 939.6	105.5					
7 628 748.2	576 938.5	105.4	STA	TIC	ON AREA LAN	DFILL-WEST (	LOBE D)
7 628 759.9	576 910.3	105.0			REGRADED	(AS-BUILT)	,
7 628 761.2	576 885.4	103.7		П	LITM COO	RDINATES	
		1070		- 1	J IW COO	INDINA ILO	1

STATION AREA LANDFILL-WEST (LOBE D) REGRADED (AS-BUILT)						
	итм соо	UTM COORDINATES				
NO.	NORTHING	EASTING	ELEV.			
460	7 628 845.1	576 935.9	104.0			
461	7 628 851.5	576 948.4	103.7			
462	7 628 847.5	576 964.9	103.7			
463	7 628 842.6	576 974.2	103.9			
464	7 628 837.0	576 978.9	103.9			
465	7 628 834.1	576 952.6	104.3			
466	7 628 830.8	576 939.6	104.3			



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#### General Notes:

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- 2. ALL DIMENSIONS ARE IN METRES UNLESS NOTED OTHERWISE.

# Legend:

COORDINATE POINT



COMPLETED LANDFILL OR BURIED DEBRIS EXCAVATION



BODY OF WATER

O 13-03-18		AS-BUILT DRA	R	
No.	DATE	REVISION	REVISION	Al





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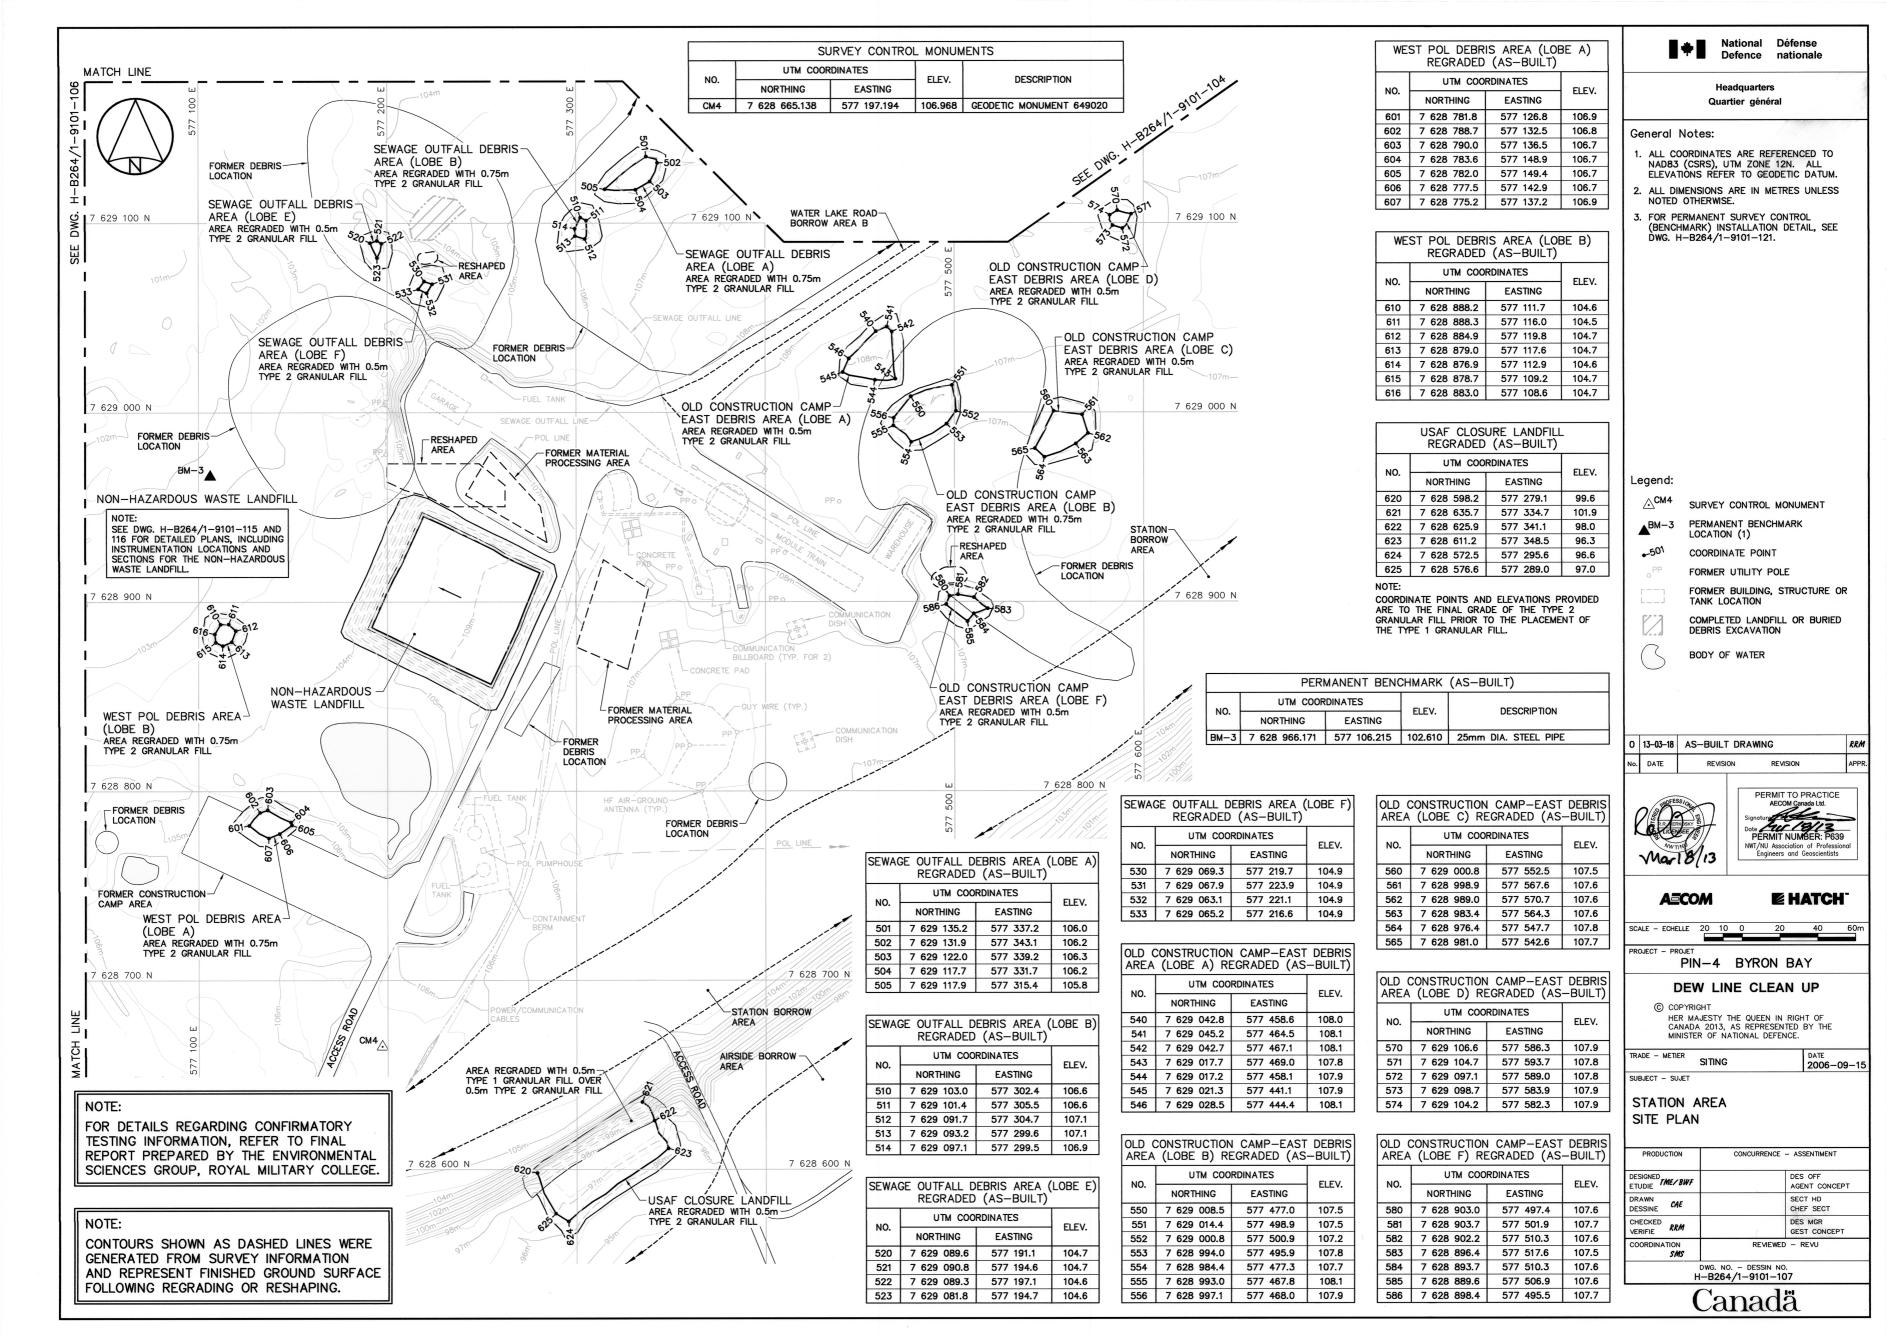
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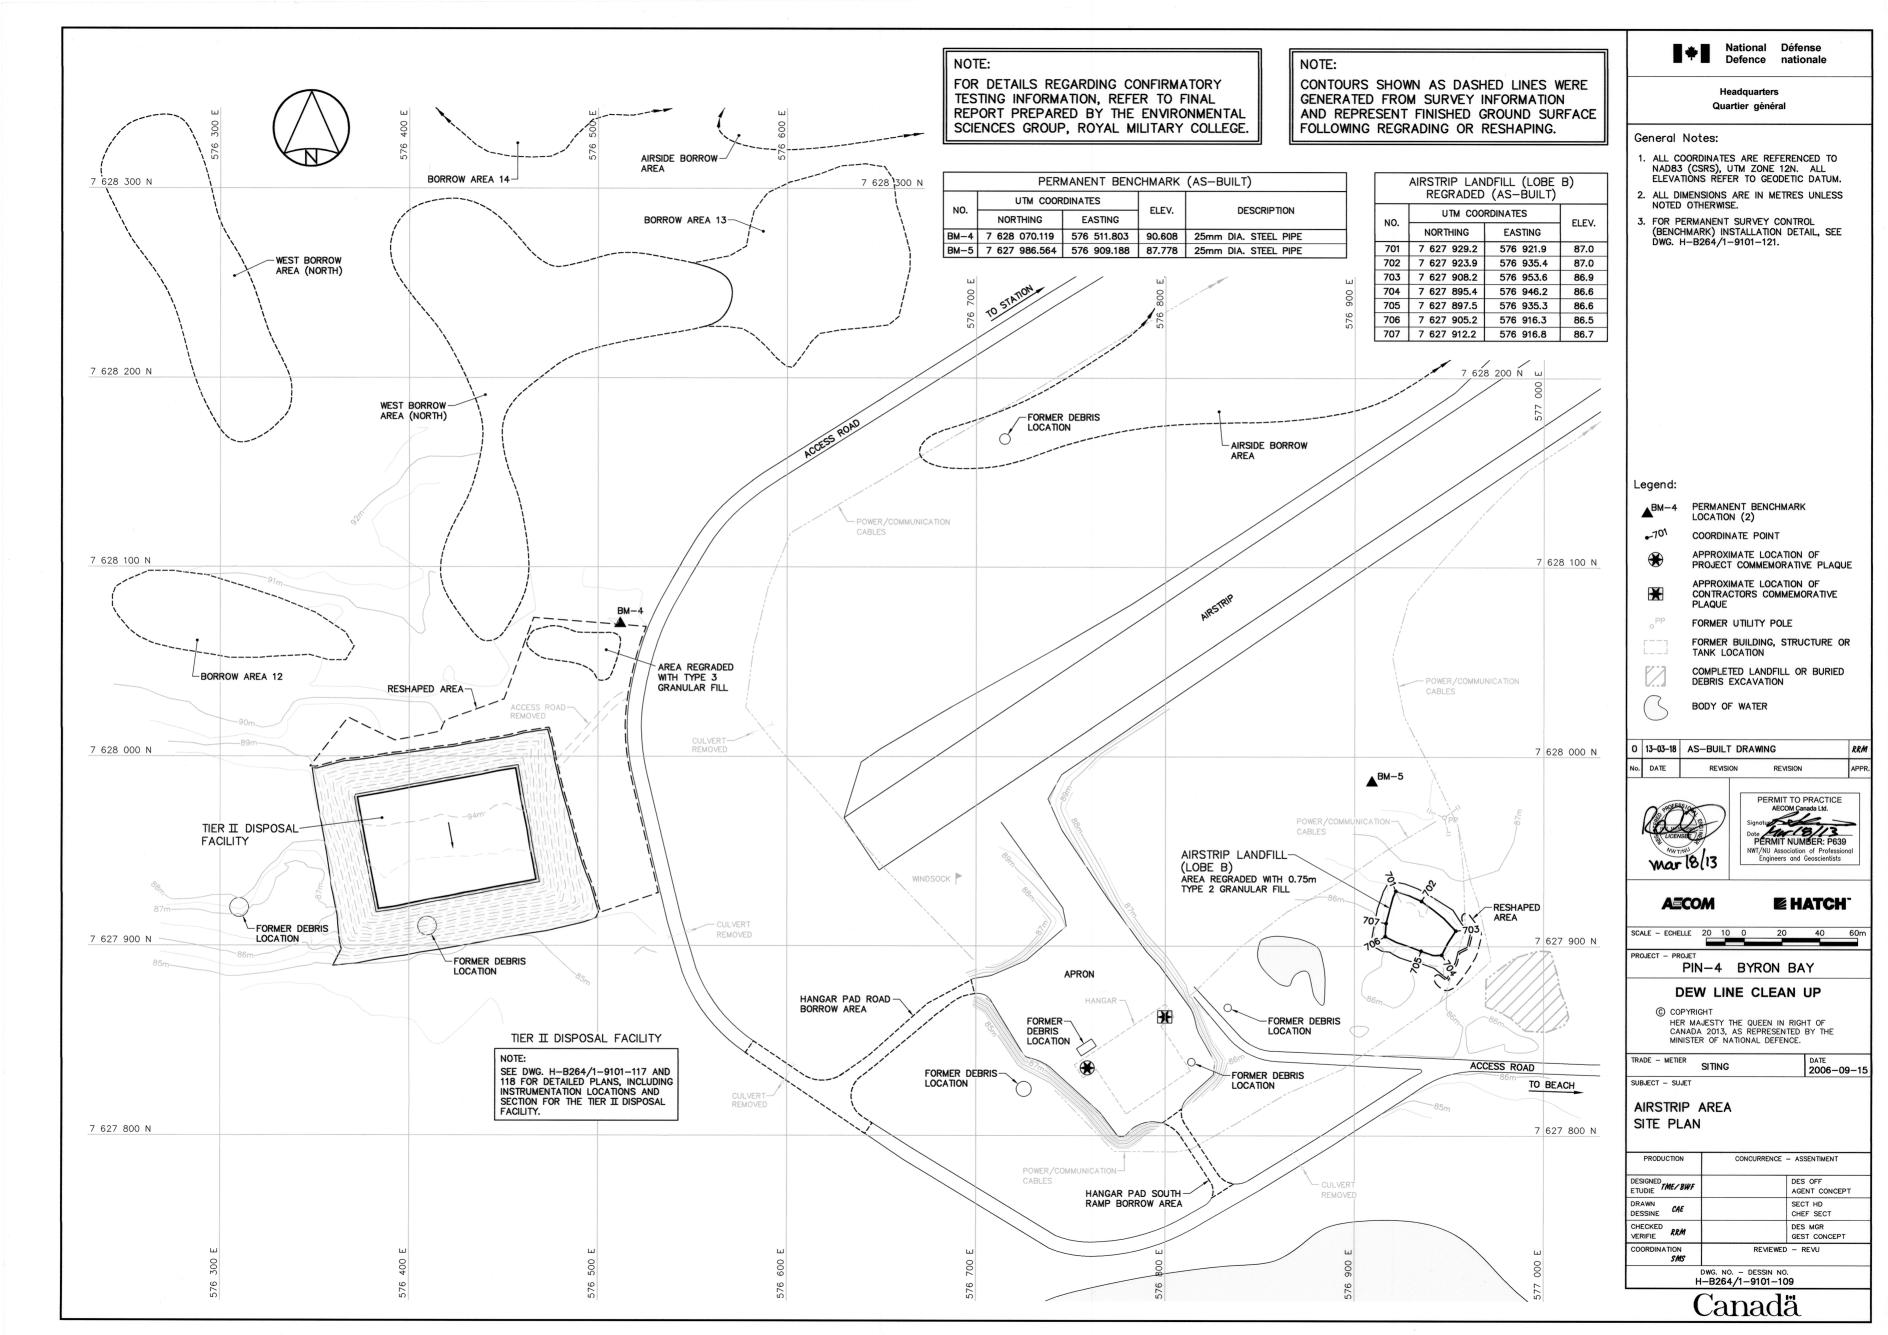
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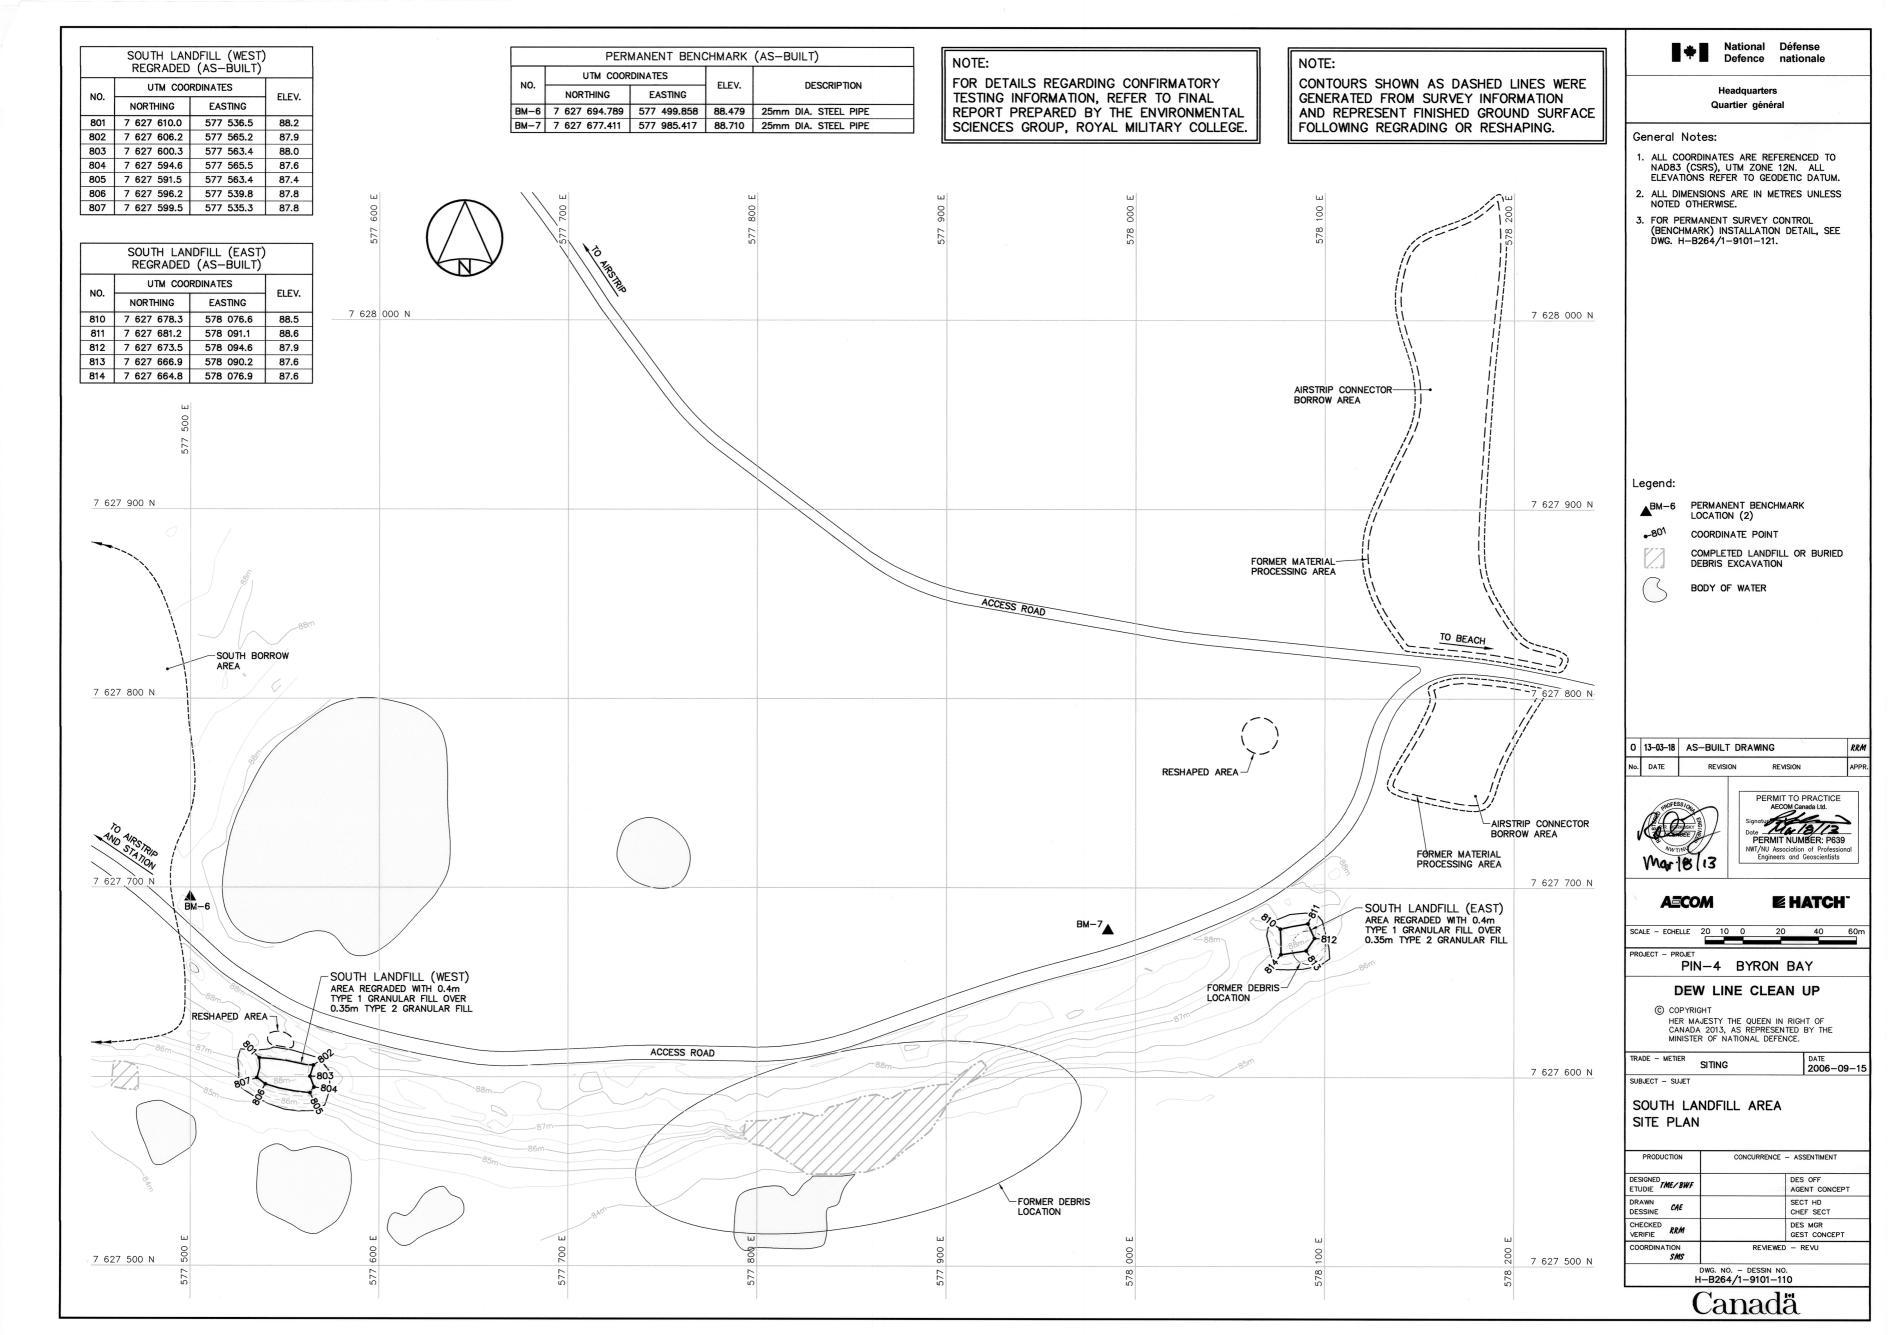
TRADE - METIER SITING 2006-09-15 SUBJECT - SUJET

#### STATION AREA-WEST SITE PLAN

PRODUCTION	CONCURRENCE - ASSENTIMENT
DESIGNED TME/BWF	DES OFF AGENT CONCEPT
DRAWN DESSINE CAE	SECT HD CHEF SECT
CHECKED RRM VERIFIE	DES MGR GEST CONCEPT
COORDINATION SMS	REVIEWED - REVU
DWG	. NO. – DESSIN NO. 264/1–9101–106







LANDFARM MONITORING WELLS NOTE: NOTE: REMOVED CONTOURS SHOWN AS DASHED LINES WERE FOR DETAILS REGARDING CONFIRMATORY UTM COORDINATES GENERATED FROM SURVEY INFORMATION TESTING INFORMATION, REFER TO FINAL NO. NORTHING **EASTING** REPORT PREPARED BY THE ENVIRONMENTAL AND REPRESENT FINISHED GROUND SURFACE MW-09 7 627 934.3 580 984.7 SCIENCES GROUP, ROYAL MILITARY COLLEGE. FOLLOWING REGRADING OR RESHAPING. MW-10 7 627 869.4 581 169.1 MW-11 7 627 803.3 581 132.4 MW-12 7 627 734.1 581 052.7 7 628 200 N 7 628 200 N BORROW AREA 9 BORROW AREA 10 7 628 100 N 7 628 100 N RESHAPED AREA 7 628 000 N 7 628 000 N 7 627 900 N 7 627 900 N FORMER DEBRIS CLOSED LANDFARM 7 627 800 N 7 627 800 N RESHAPED AREA-RESHAPED AREA-7 627 700 N 7 627 700 N



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#### General Notes:

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- 2. ALL DIMENSIONS ARE IN METRES UNLESS NOTED OTHERWISE.

Legend:

BODY OF WATER

13-03-18 AS-BUILT DRAWING DATE REVISION



A=COM

**■ HATCH** 

PERMIT TO PRACTICE

PROJECT - PROJET PIN-4 BYRON BAY

DEW LINE CLEAN UP

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TRADE - METIER SITING

DATE 2009-08-19

LANDFARM AREA

SITE PLAN

PRODUCTION	CONCURRENCE - ASSENTIMENT	
DESIGNED BHN/RRM	DES OFF	
ETUDIE	AGENT CONCEPT	
DRAWN	SECT HD	
DESSINE BHH	CHEF SECT	
CHECKED	DES MGR	
VERIFIE RRM	GEST CONCEPT	
COORDINATION SMS	REVIEWED - REVU	

DWG. NO. - DESSIN NO. H-B264/1-9101-111


LA	LANDING DEBRIS AREA (LOBE B) REGRADED (AS—BUILT)						
NO.	UTM COORDINATES						
NO.	NORTHING	EASTING	ELEV.				
901	7 626 730.8	582 177.3	3.5				
902	7 626 745.6	582 188.4	3.3				
903	7 626 741.4	582 199.7	3.3				
904	7 626 734.4	582 209.5	3.2				
905	7 626 723.1	582 212.6	3.0				
906	7 626 713.3	582 210.1	3.0				
907	7 626 711.5	582 199.1	3.2				

	PERMANENT BENCHMARK (AS-BUILT)					
110	UTM COOR	DINATES	ELEV.	DESCRIPTION		
NO.	NORTHING	EASTING	ELEV.	DESCRIPTION		
BM-9	7 626 614.590	581 883.025	4.443	25mm DIA. STEEL PIPE		
BM-10	7 626 723.366	582 059.396	4.064	25mm DIA. STEEL PIPE		

NOTE:
FOR DETAILS REGARDING CONFIRMATORY
TESTING INFORMATION, REFER TO FINAL
REPORT PREPARED BY THE ENVIRONMENTAL
SCIENCES GROUP, ROYAL MILITARY COLLEGE.

۱	NOIE:
	CONTOURS SHOWN AS DASHED LINES WERE GENERATED FROM SURVEY INFORMATION AND REPRESENT FINISHED GROUND SURFACE
I	GENERATED FROM SURVEY INFORMATION
ı	AND REPRESENT FINISHED GROUND SURFACE

NOTE: FOLLOWING REGRADING OR RESHAPING.

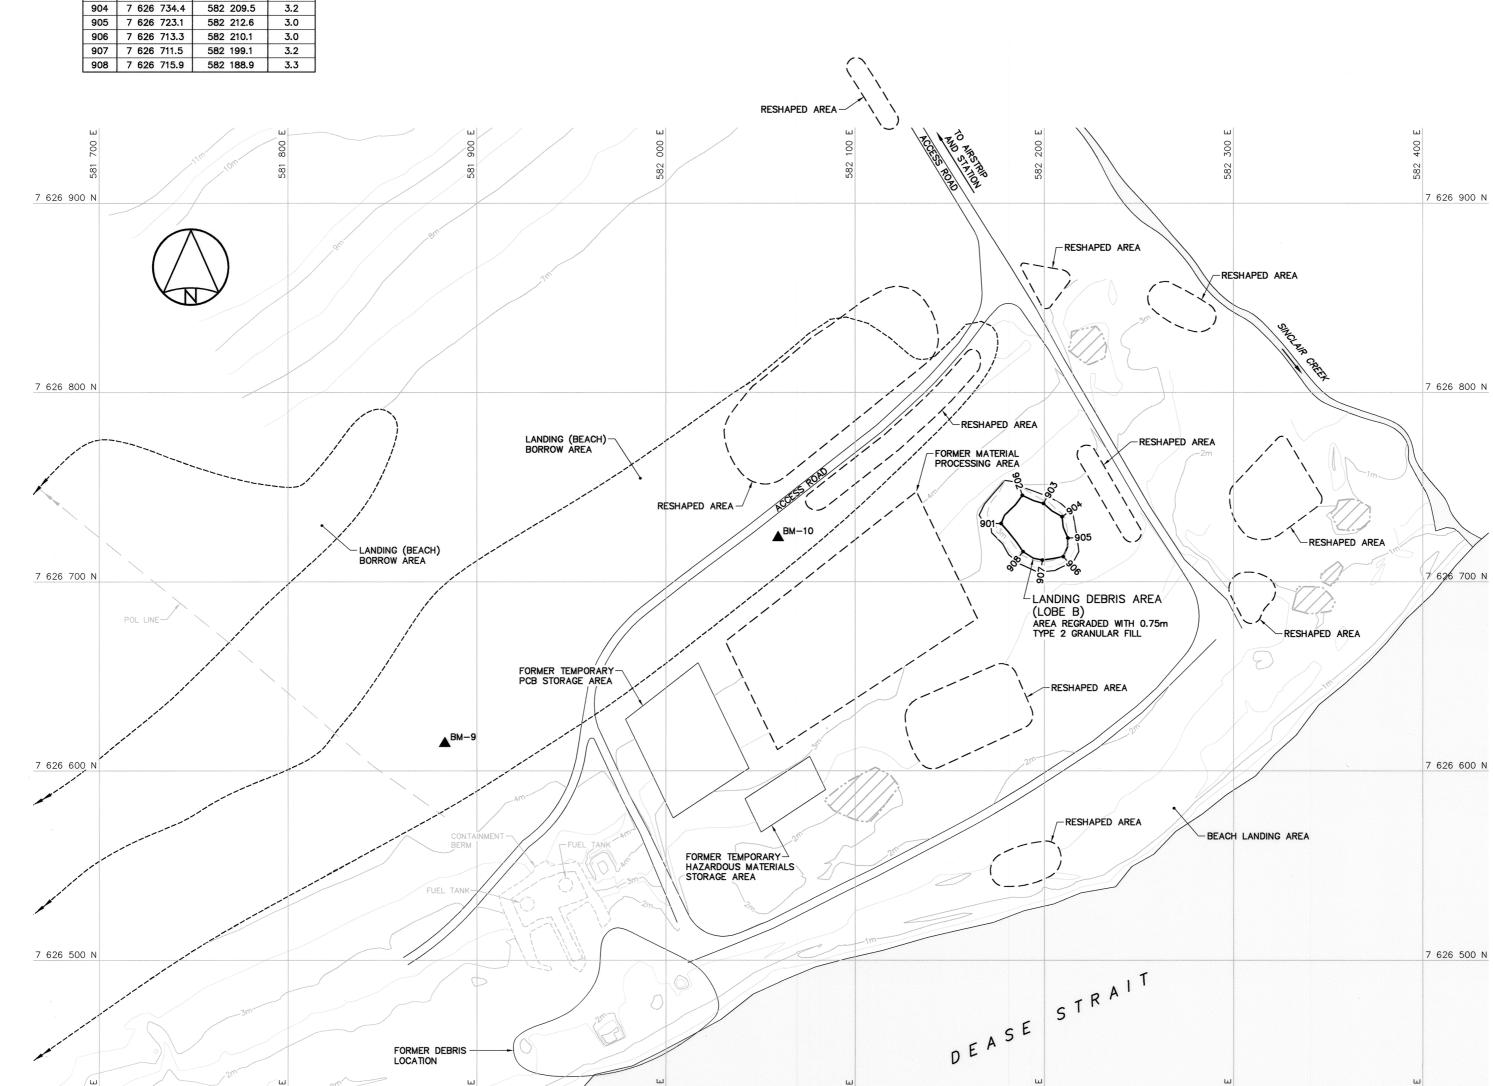



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#### General Notes:

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- 2. ALL DIMENSIONS ARE IN METRES UNLESS NOTED OTHERWISE.
- 3. FOR PERMANENT SURVEY CONTROL (BENCHMARK) INSTALLATION DETAIL, SEE DWG. H-B264/1-9101-121.

Legend:

PERMANENT BENCHMARK LOCATION (2)

COORDINATE POINT

FORMER BUILDING, STRUCTURE OR TANK LOCATION COMPLETED LANDFILL OR BURIED DEBRIS EXCAVATION



BODY OF WATER

0 13-03-18 AS-BUILT DRAWING RRM No. DATE REVISION REVISION



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SCALE - ECHELLE 20 10

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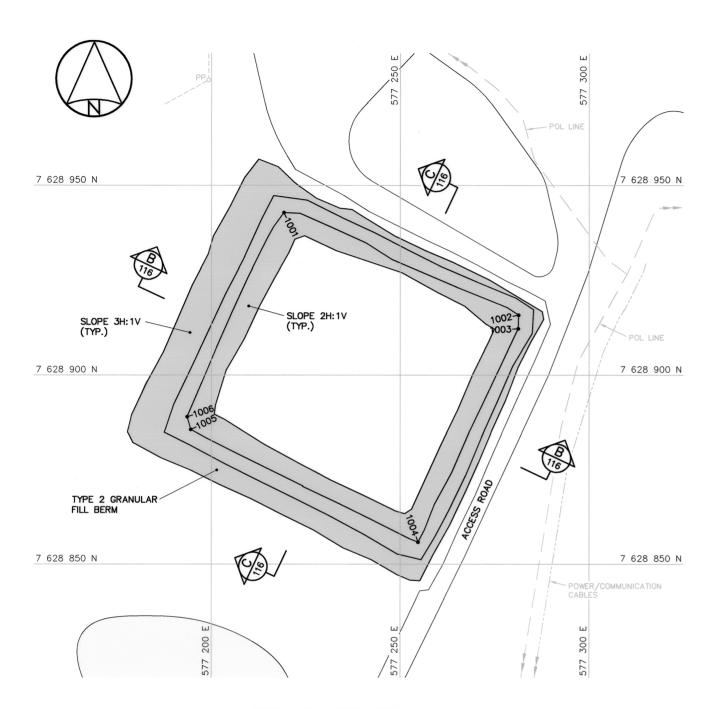
TRADE - METIER SITING SUBJECT - SUJET

DATE 2006-09-15

BEACH AREA SITE PLAN


PRODUCTION	CONCURRENCE - ASSENTIMENT
DESIGNED TME/BWF	DES OFF AGENT CONCEPT
DRAWN DESSINE CAE	SECT HD CHEF SECT
CHECKED RRM VERIFIE RRM	DES MGR GEST CONCEPT
COORDINATION SMS	REVIEWED - REVU

DWG. NO. - DESSIN NO. H-B264/1-9101-112



# BERM CONSTRUCTION PLAN

NON-HAZARDOUS WASTE LANDFIL BERM CONSTRUCTION (AS-BUILT)				
NO. UTM COORDINATES			ELEV.	
NO.	NORTHING	EASTING	ELEV.	
1001	7 628 942.9	577 219.3	106.6	
1002	7 628 915.8	577 281.4	107.7	
1003	7 628 912.2	577 281.3	107.7	
1004	7 628 855.8	577 254.8	107.8	
1005	7 628 885.6	577 194.6	106.6	
1006	7 628 889.0	577 193.7	106.5	

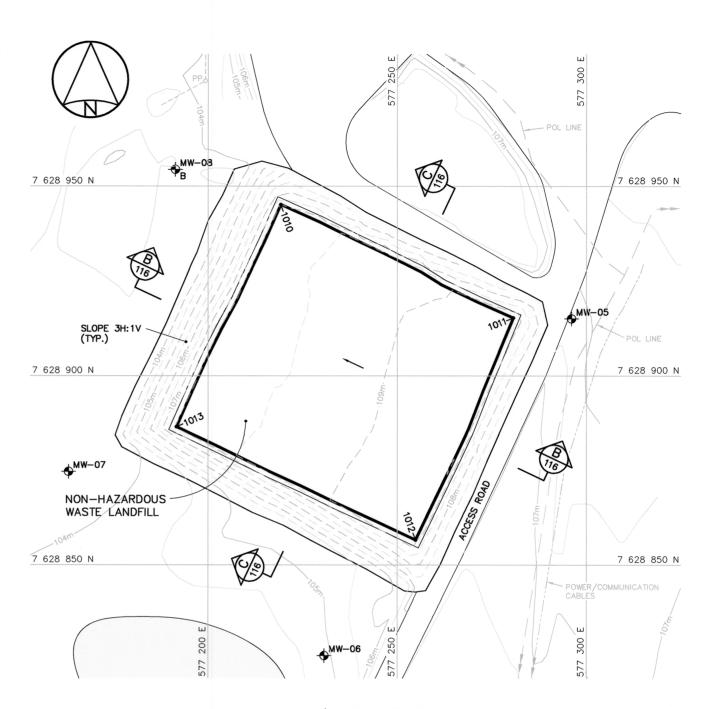

# FINAL GRADING/INSTRUMENTATION PLAN

NON-HAZARDOUS WASTE LAN FINAL GRADING (AS-BUILT			
NO.	итм соо	UTM COORDINATES	
NO.	NORTHING	EASTING	ELEV.
1010	7 628 945.2	577 219.3	108.0
1011	7 628 915.3	577 280.7	109.5
1012	7 628 856.6	577 254.9	109.4
1013	7 628 886.5	577 191.7	108.1
NOTE:			

COORDINATE POINTS AND ELEVATIONS PROVIDED ARE TO THE FINAL GRADE OF THE TYPE 2 GRANULAR FILL CAP PRIOR TO THE PLACEMENT OF THE TYPE 1 GRANULAR FILL ON THE SIDE SLOPES AND ORGANIC MATERIAL ON THE PLATEAU.

# NOTE:

FOR DETAILS REGARDING CONFIRMATORY TESTING INFORMATION, REFER TO FINAL REPORT PREPARED BY THE ENVIRONMENTAL SCIENCES GROUP, ROYAL MILITARY COLLEGE.

# NOTE:

NO.

MW-05

CONTOURS SHOWN AS DASHED LINES WERE GENERATED FROM SURVEY INFORMATION AND REPRESENT FINISHED GROUND SURFACE FOLLOWING REGRADING OR RESHAPING.

NON-HAZARDOUS WASTE LANDFILL MONITORING WELLS (AS-BUILT)

UTM COORDINATES

MW-08 7 628 954.4 577 191.4 103.6

**EASTING** 

577 296.1

577 230.7

577 163.2

NORTHING

7 628 915.1

MW-06 7 628 826.1

MW-07 7 628 874.6

ELEV.

107.9

104.7

103.7



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#### General Notes:

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- 2. ALL DIMENSIONS ARE IN METRES UNLESS
- 3. FOR MONITORING WELL INSTALLATION DETAILS, SEE DWG. H-B264/1-9101-121.

Legend:

-1001 COORDINATE POINT

→ MW-05 MONITORING WELL LOCATION (3)

MW-08 BACKGROUND MONITORING WELL LOCATION (1)

13-03-18 AS-BUILT DRAWING





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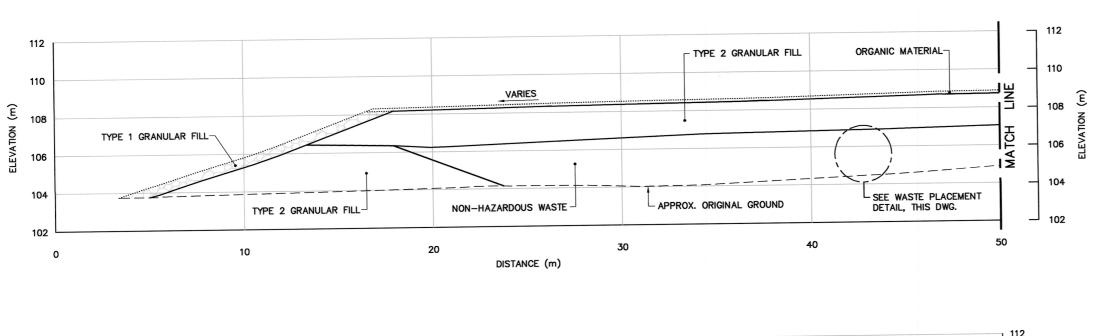
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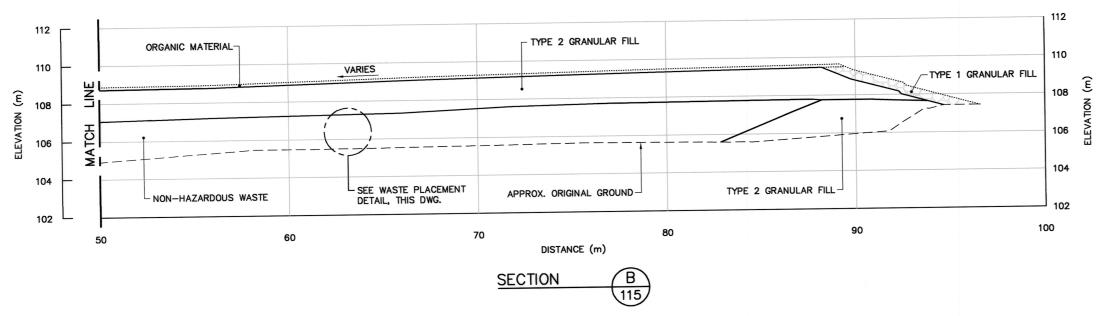
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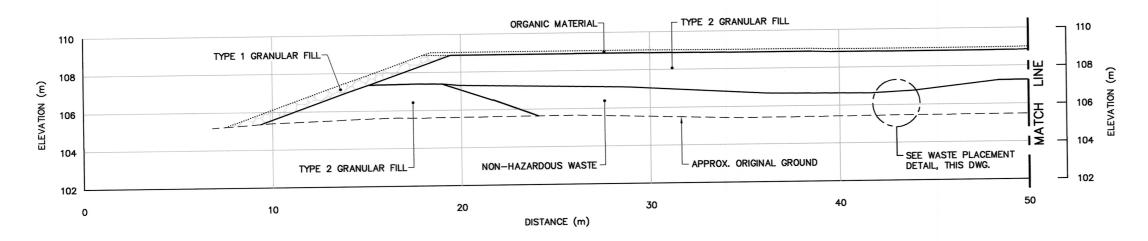
NON-HAZARDOUS WASTE LANDFILL BERM CONSTRUCTION AND FINAL **GRADING PLANS** 


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DRAWN DESSINE CAE	SECT HD CHEF SECT
CHECKED RRM VERIFIE	DES MGR GEST CONCEPT
COORDINATION REVIEWED - REVU	


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WASTE PLACEMENT DETAIL SCALE: NTS



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# General Notes:

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- 2. ALL DIMENSIONS ARE IN METRES UNLESS NOTED OTHERWISE.

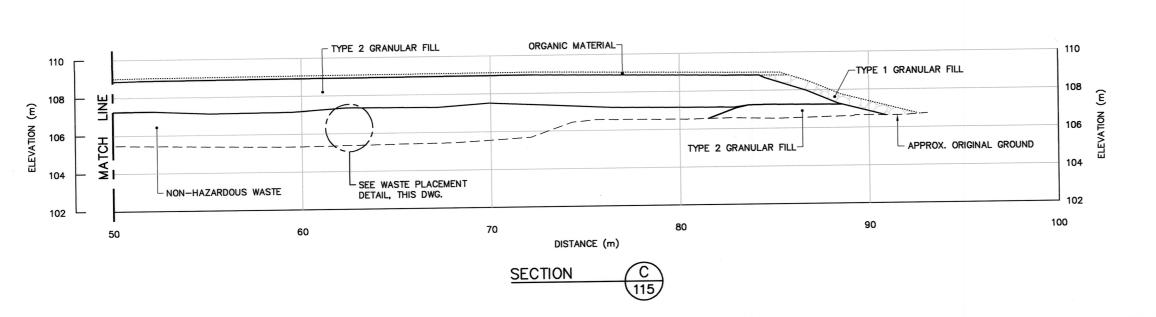Legend:

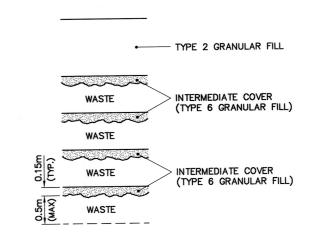GENERATED BASED ON AS-BUILT SURVEY INFORMATION

CONSTRUCTED AS PER DESIGN, NO AS-BUILT SURVEY INFORMATION

0 13-03-18 AS-BUILT DRAWING



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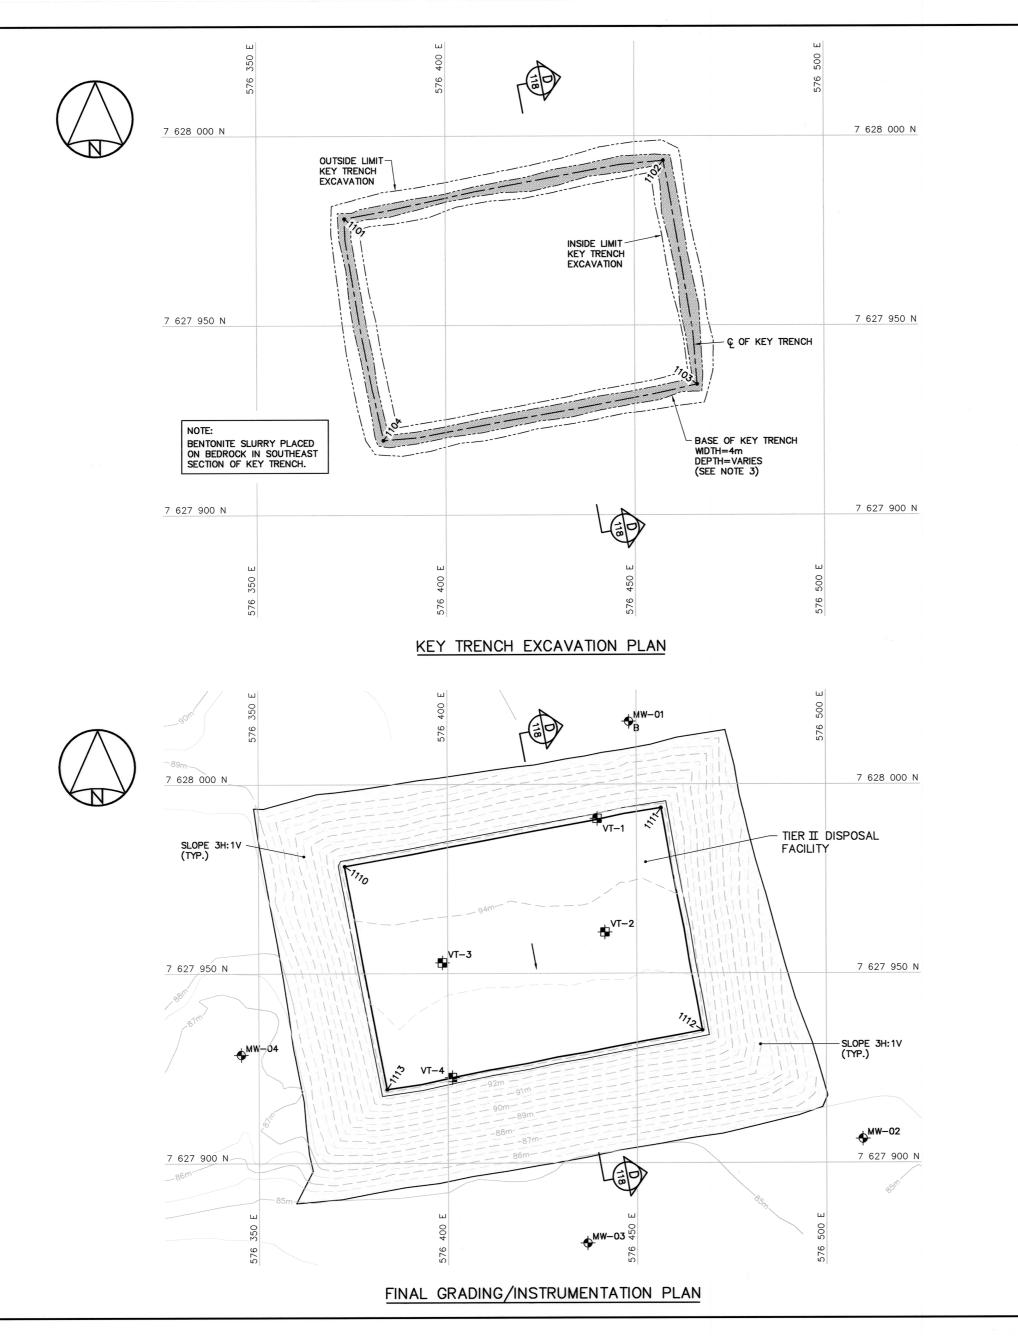
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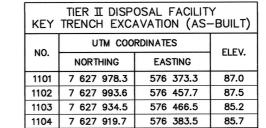
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MINISTER OF NATIONAL DEFENCE.

TRADE - METIER SITING

NON-HAZARDOUS WASTE LANDFILL CROSS SECTIONS AND DETAIL

DESIGNED ETUDIE DRAWN DESSINE CAE DES MGR GEST CONCEPT CHECKED RRM COORDINATION SMS DWG. NO. - DESSIN NO. H-B264/1-9101-116





FOR DETAILS REGARDING CONFIRMATORY TESTING INFORMATION, REFER TO FINAL REPORT PREPARED BY THE ENVIRONMENTAL SCIENCES GROUP, ROYAL MILITARY COLLEGE.

#### NOTE:

CONTOURS SHOWN AS DASHED LINES WERE GENERATED FROM SURVEY INFORMATION AND REPRESENT FINISHED GROUND SURFACE FOLLOWING REGRADING OR RESHAPING.

TIER II DISPOSAL FACILITY FINAL GRADING (AS-BUILT)				
NO.	UTM COORDINATES		FLEV.	
NO.	NORTHING	EASTING	ELEV.	
1110	7 627 978.4	576 372.9	94.4	
1111	7 627 993.8	576 456.5	94.2	
1112	7 627 935.0	576 467.3	93.2	
1113	7 627 919.4	576 383.9	93.2	

#### NOTE:

COORDINATE POINTS AND ELEVATIONS PROVIDED ARE TO THE FINAL GRADE OF THE TYPE 2 GRANULAR FILL CAP PRIOR TO THE PLACEMENT OF THE TYPE 1 GRANULAR FILL ON THE SIDE SLOPES AND ORGANIC MATERIAL ON THE PLATEAU.

TIER II DISPOSAL FACILITY MONITORING WELLS (AS-BUILT)			
UTM COORDINATES			ELEV.
NO.	NORTHING	EASTING	LLEV.
MW-01	7 628 016.6	576 448.1	89.8
MW-02	7 627 906.3	576 509.7	85.2
MW-03	7 627 878.8	576 436.9	84.7
MW-04	7 627 928.6	576 345.4	86.8

TIER II DISPOSAL FACILITY GROUND TEMPERATURE CABLES (AS-BUILT)			
UTM COORDINATES			ELEV.
NO.	NORTHING	EASTING	ELEV.
VT-1	7 627 991.0	576 439.6	94.4
VT-2	7 627 960.9	576 441.6	93.9
VT-3	7 627 952.9	576 398.7	93.8
VT-4	7 627 922.6	576 401.2	93.3



National Défense

#### General Notes:

- 1. ALL COORDINATES ARE REFERENCED TO NAD83 (CSRS), UTM ZONE 12N. ALL ELEVATIONS REFER TO GEODETIC DATUM.
- 2. ALL DIMENSIONS ARE IN METRES UNLESS NOTED OTHERWISE.
- 3. KEY TRENCH WAS EXCAVATED TO SATURATED GROUND OR ICE SATURATED PERMAFROST. EXCAVATION DEPTH WAS FIELD CONFIRMED BY THE SITE ENGINEER.
- 4. FOR MONITORING WELL INSTALLATION DETAILS, SEE DWG. H-B264/1-9101-121.
- 5. FOR GROUND TEMPERATURE CABLE INSTALLATION DETAIL, SEE DWG. H-B264/1-9101-121.

#### Legend:

COORDINATE POINT

MONITORING WELL LOCATION (3)

BACKGROUND MONITORING WELL LOCATION (1)

GROUND TEMPERATURE CABLE LOCATION (4)

0 13-03-18 AS-BUILT DRAWING





A=COM

**■ HATCH** 

2006-09-15

PIN-4 BYRON BAY

**DEW LINE CLEAN UP** 

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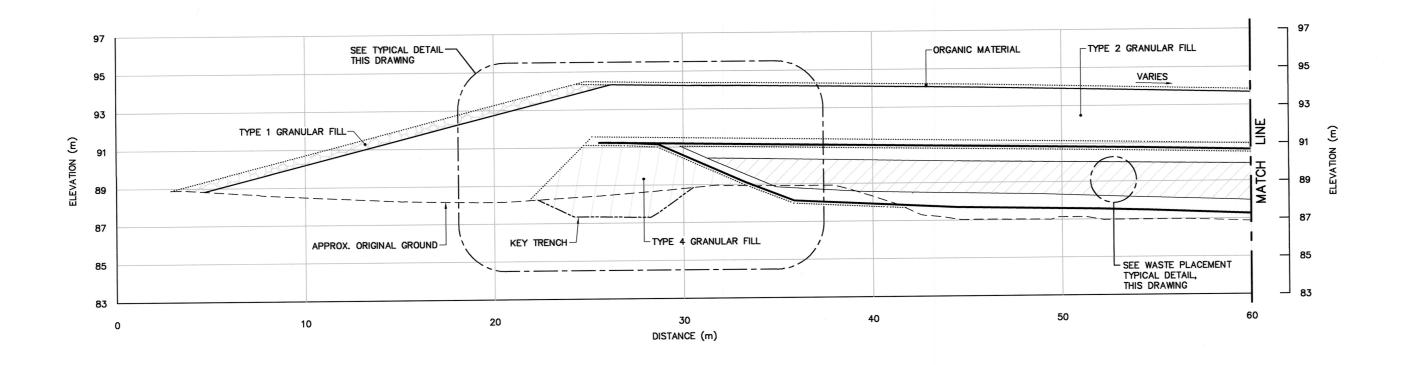
TRADE - METIER SITING


SUBJECT - SUJET


TIER II DISPOSAL FACILITY KEY TRENCH EXCAVATION PLAN & GRADING/INSTRUMENTATION PLAN

	No. of the contract of the con
PRODUCTION	CONCURRENCE - ASSENTIMENT
DESIGNED TME/BWF	DES OFF AGENT CONCEPT
DRAWN DESSINE CAE	SECT HD CHEF SECT
CHECKED RRM VERIFIE	DES MGR GEST CONCEPT
COORDINATION REVIEWED - REVU	
	/G. NO. – DESSIN NO. B264/1–9101–117





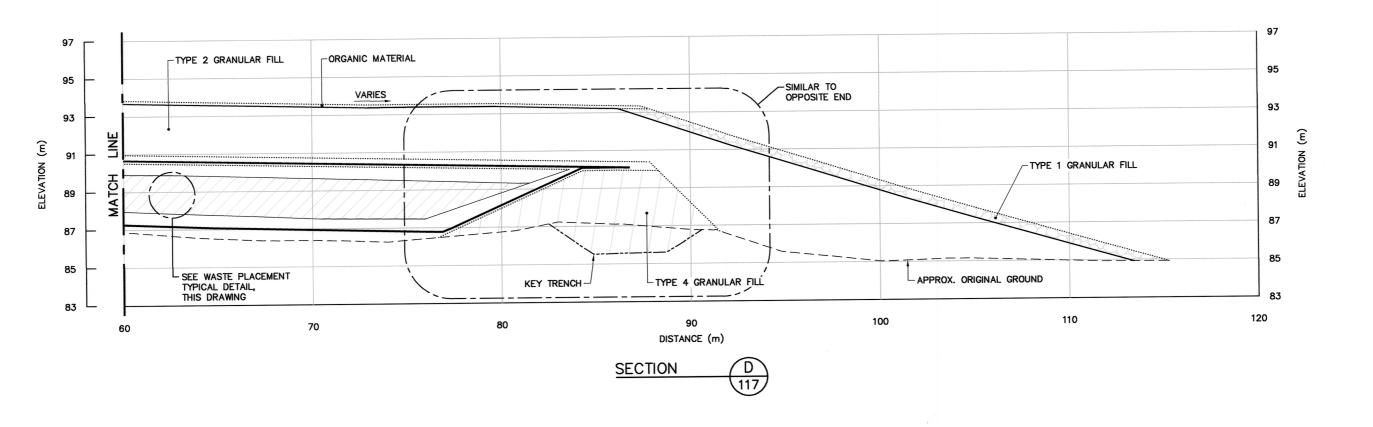

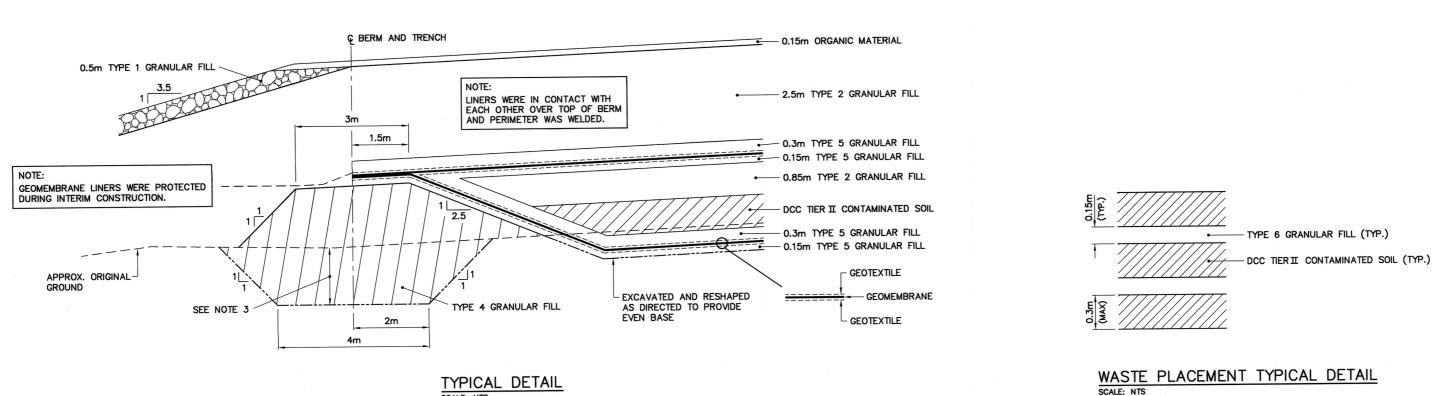

National Défense Defence nationale

#### General Notes:


- 1. ALL COORDINATES ARE REFERENCED TO NAD83 (CSRS), UTM ZONE 12N. ALL ELEVATIONS REFER TO GEODETIC DATUM.
- 2. ALL DIMENSIONS ARE IN METRES UNLESS NOTED OTHERWISE.
- KEY TRENCH WAS EXCAVATED TO SATURATED GROUND OR ICE SATURATED PERMAFROST. EXCAVATION DEPTH WAS FIELD CONFIRMED BY THE SITE ENGINEER.

Legend:

GENERATED BASED ON AS-BUILT SURVEY INFORMATION

CONSTRUCTED AS PER DESIGN, NO AS-BUILT SURVEY INFORMATION

0 13-03-18 AS-BUILT DRAWING DATE

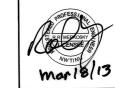

PERMIT TO PRACTICE
AECOM Canada Ltd.
Signatur
Date
PERMIT NUMBER: P639

E HATCH

DATE 2006-09-15

A=COM

PIN-4 BYRON BAY

**DEW LINE CLEAN UP** 


© COPYRIGHT


HER MAJESTY THE QUEEN IN RIGHT OF CANADA 2013, AS REPRESENTED BY THE MINISTER OF NATIONAL DEFENCE.

SITING

TIER II DISPOSAL FACILITY CROSS SECTION AND DETAIL

CONCURRENCE - ASSENTIMENT DES OFF AGENT CONCEPT ESIGNED TUDIE SECT HD CHEF SECT DRAWN DESSINE CAE CHECKED KRM REVIEWED - REVU DWG. NO. - DESSIN NO. H-B264/1-9101-118

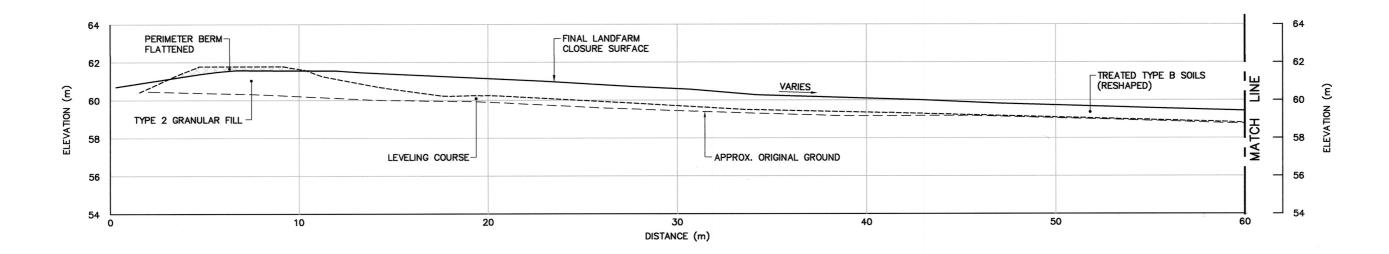

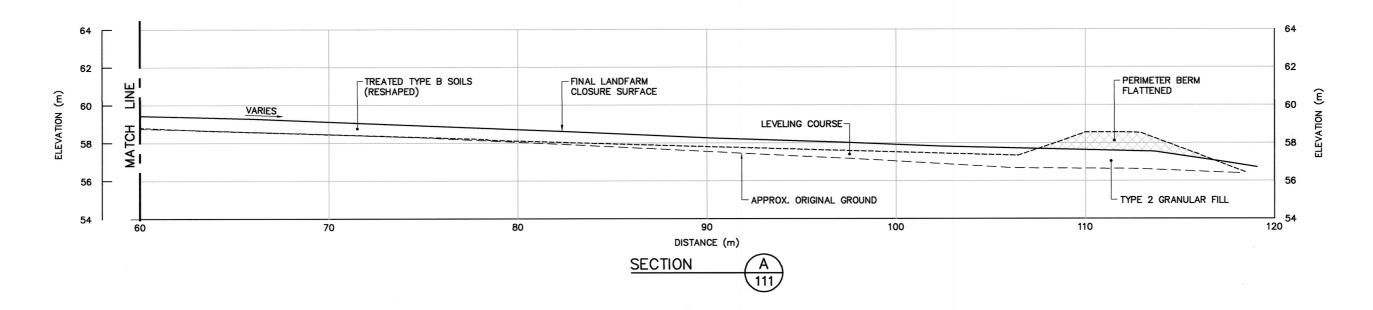

NOTE: LANDFARM LINER SYSTEM WAS REMOVED TO A MINIMUM DEPTH OF 0.3m BELOW FINAL CLOSURE SURFACE. National Défense Defence nationale

#### General Notes:


- ALL COORDINATES ARE REFERENCED TO NAD83 (CSRS), UTM ZONE 12N. ALL ELEVATIONS REFER TO GEODETIC DATUM.
- 2. ALL DIMENSIONS ARE IN METRES UNLESS NOTED OTHERWISE.

Legend:

GENERATED BASED ON FINAL AS-BUILT SURVEY INFORMATION

GENERATED BASED ON INTERMEDIATE AS-BUILT SURVEY INFORMATION

0 13-03-18 AS-BUILT DRAWING RRM o. DATE

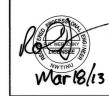



# **AECOM**

E HATCH'

SCALE - ECHELLE

PROJECT - PROJET
PIN-4 BYRON BAY

# **DEW LINE CLEAN UP**

AS SHOWN

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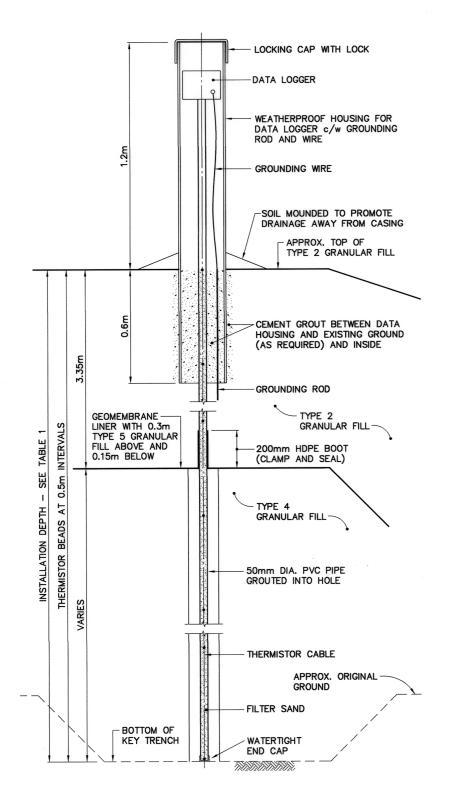
TRADE - METIER SITING SUBJECT - SUJET

DATE 2009-08-19


CLOSED LANDFARM CROSS SECTION

PRODUCTION CONCURRENCE - ASSENTIMENT DESIGNED BHN/RRM DES OFF AGENT CONCEPT DRAWN DESSINE BNH SECT HD CHEF SECT CHECKED KRM DES MGR GEST CONCEPT REVIEWED - REVU DWG. NO. - DESSIN NO. H-B264/1-9101-120

TABLE 1 GROUND TEMPERATURE CABLE INSTALLATION			
INSTRUMENT No.	APPROXIMATE DEPTH BELOW FINAL GRADE (m)	COMMENTS	
TIER II DISPOSAL F	ACILITY		
VT-1	6.39	INSTALLED THROUGH CENTERLINE BERM TO INVERT OF KEY TRENCH	
VT-2 5.65		INSTALLED TO 1.0m ABOVE ELEVATION OF BOTTOM LINER	
VT-3	4.96	INSTALLED TO 1.0m ABOVE ELEVATION OF BOTTOM LINER	
VT-4	6.75	INSTALLED THROUGH CENTERLINE BERM TO INVERT OF KEY TRENCH	



TYPICAL GROUND TEMPERATURE CABLE

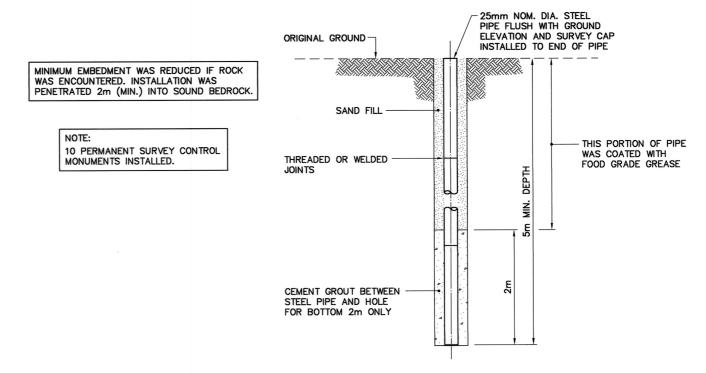


# TYPICAL PERMANENT SURVEY CONTROL MONUMENT

SCALE: NTS ALSO KNOWN AS PERMANENT BENCHMARK

> IF SOUND BEDROCK WAS ENCOUNTERED, A 2.5m (MIN.) OF SCREEN AND 0.5m (MIN.) OF EMBEDMENT WAS REQUIRED INTO SOUND BEDROCK.

NOTE:

8 MONITORING WELLS REMAINING. 4 MONITORING WELLS REMOVED.

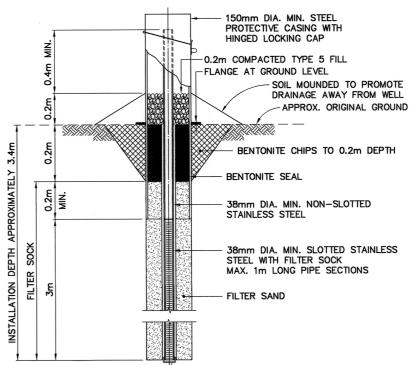

# TYPICAL MONITORING WELL

NSTALLATION DEPTH

**GROUT** 

FOR BEDROCK DEPTH > 0.7m INCLUDING TYPICAL BACKGROUND MONITORING WELL INSTALLATION

150mm DIA. MIN. STEEL PROTECTIVE CASING WITH HINGED LOCKING CAP

- FLANGE AT GROUND LEVEL

BENTONITE SEAL

FILTER SAND

0.2m COMPACTED TYPE 5 FILL

SOIL MOUNDED TO PROMOTE DRAINAGE AWAY FROM WELL

BENTONITE CHIPS TO 0.3m DEPTH


38mm DIA. MIN. NON-SLOTTED STAINLESS STEEL

38mm DIA. MIN. NON-SLOTTED STAINLESS STEEL

WATERTIGHT END CAP

38mm DIA. MIN. SLOTTED STAINLESS STEEL WITH FILTER SOCK MAX. 1m LONG PIPE SECTIONS

- APPROX. ORIGINAL GROUND

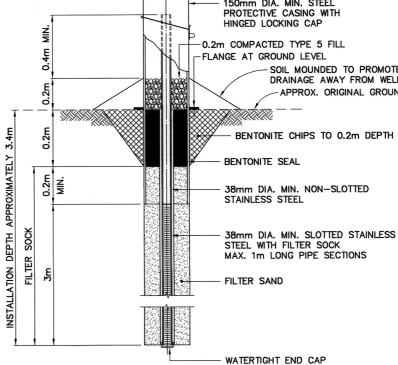

# TYPICAL MONITORING WELL

SCALE: NTS FOR BEDROCK DEPTH < 0.7m INCLUDING TYPICAL BACKGROUND MONITORING WELL INSTALLATION




National Défense Defence

Quartier général

#### General Notes:

- 1. ALL DIMENSIONS ARE IN METRES UNLESS NOTED OTHERWISE.
- 2. LOCATIONS OF INSTRUMENTATION ARE SHOWN ON THE DRAWINGS, INCLUDING COORDINATE TABLES.

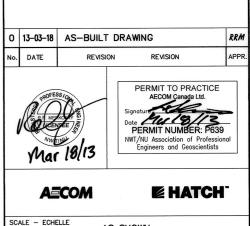

AS SHOWN PROJECT - PROJET PIN-4 BYRON BAY

### **DEW LINE CLEAN UP**


2006-09-15

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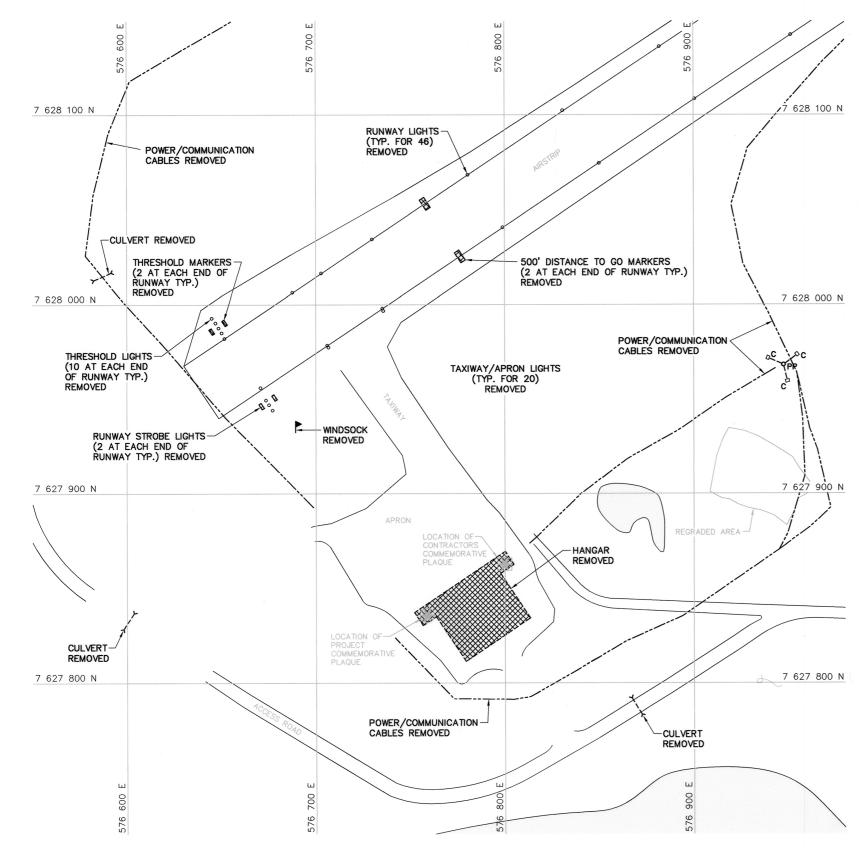
TRADE - METIER SITING SUBJECT - SUJET

#### MISCELLANEOUS DETAILS SHEET 1


PRODU	CTION	CONCURRENCE - ASSENTIMENT	
DESIGNED TO	ME/BWF		DES OFF AGENT CONCEPT
DRAWN DESSINE	CAE		SECT HD CHEF SECT
CHECKED VERIFIE	RRM		DES MGR GEST CONCEPT
COORDINA	TION SMS	REVIEWED — REVU	
DWG. NO. – DESSIN NO. H-B264/1-9101-121			



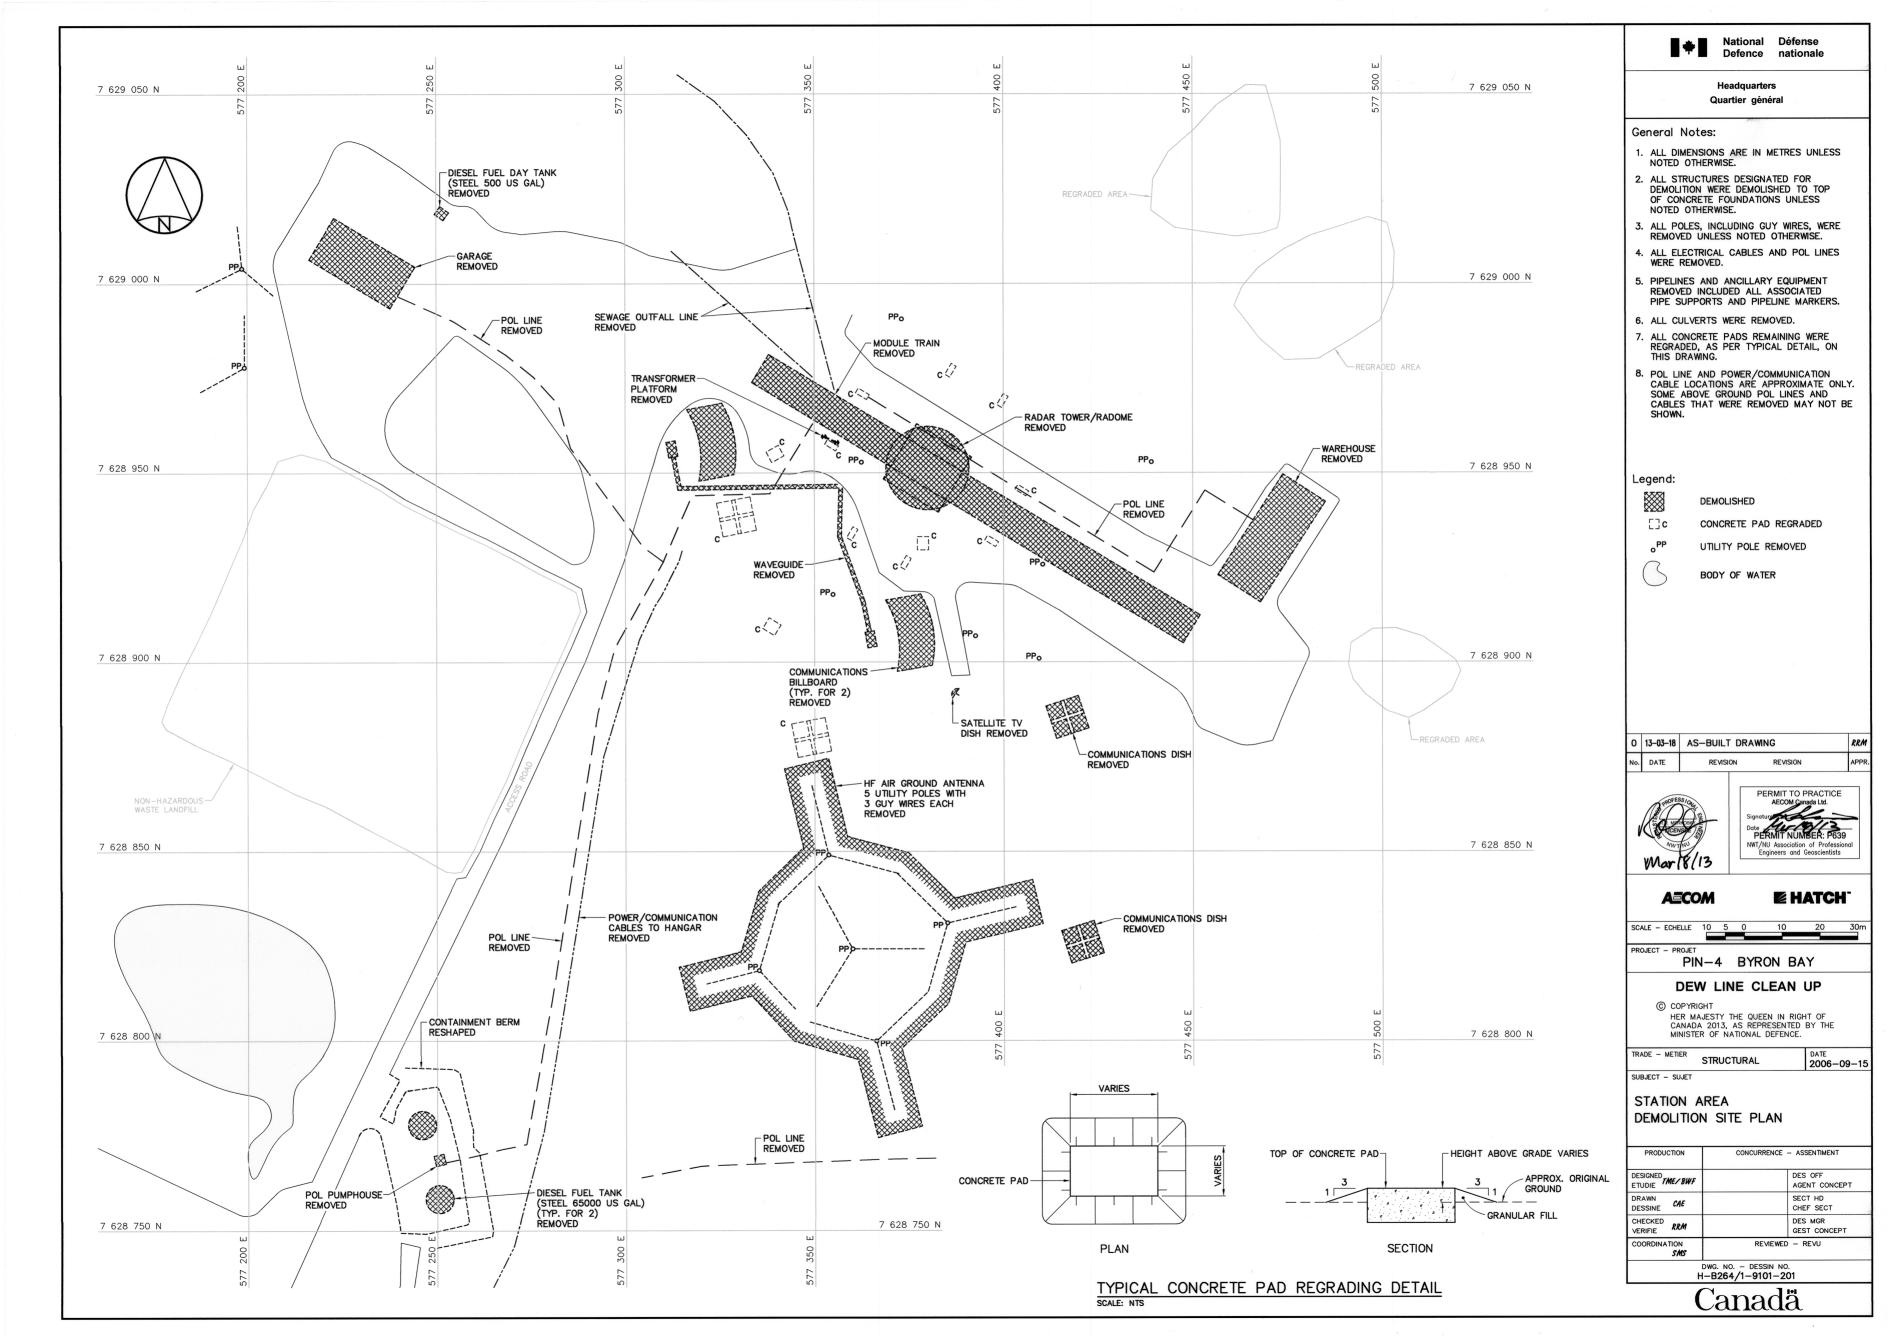



AIRSTRIP AREA

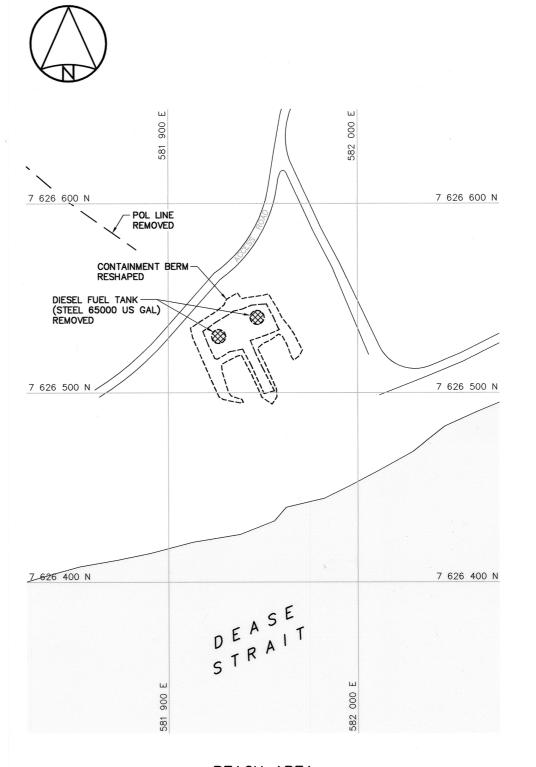

BEACH AREA



National Défense
Defence nationale

#### General Notes:

1. ALL DIMENSIONS ARE IN METRES UNLESS NOTED OTHERWISE.

Quartier général

- 2. ALL STRUCTURES DESIGNATED FOR DEMOLITION WERE DEMOLISHED TO TOP OF CONCRETE FOUNDATIONS UNLESS NOTED OTHERWISE.
- 3. ALL POLES, INCLUDING GUY WIRES, WERE REMOVED UNLESS NOTED OTHERWISE.
- 4. ALL ELECTRICAL CABLES AND POL LINES WERE REMOVED.
- 5. PIPELINES AND ANCILLARY EQUIPMENT REMOVED INCLUDED ALL ASSOCIATED PIPE SUPPORTS AND PIPELINE MARKERS.
- 6. ALL CULVERTS WERE REMOVED.
- 7. ALL CONCRETE PADS REMAINING WERE REGRADED, AS PER TYPICAL DETAIL, ON DWG. H-B264/1-9101-201.
- 8. POL LINE AND POWER/COMMUNICATION CABLE LOCATIONS ARE APPROXIMATE ONLY. SOME ABOVE GROUND POL LINES AND CABLES THAT WERE REMOVED MAY NOT BE SHOWN.

#### Legend:



DEMOLISHED

[]c CONCRETE PAD REGRADED

UTILITY POLE REMOVED



BODY OF WATER

0	13-03-18	AS-BUILT DRAWING		RRM
No.	DATE	REVISION	REVISION	APPR.
	A PO		PERMIT TO PRACT AECOM Canada Ltd.	



**AECOM EHATCH** 

Date PERMIT NUMBER: P639

DATE 2006-09-15

# PIN-4 BYRON BAY **DEW LINE CLEAN UP**

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TRADE - METIER STRUCTURAL SUBJECT - SUJET

#### AIRSTRIP AREA AND BEACH AREA DEMOLITION SITE PLANS

PRODUCTION	CONCURRENCE - ASSENTIMENT	
DESIGNED TME/BWF	DES OFF	
ETUDIE	AGENT CONCEPT	
DRAWN	SECT HD	
DESSINE CAE	CHEF SECT	
CHECKED	DES MGR	
VERIFIE RRM	GEST CONCEPT	
COORDINATION SMS	REVIEWED — REVU	