

RECEIVED***By clerk at 9:45 am, Apr 18, 2011***

March 22, 2011

Phyllis Beaulieu
Licensing Manager
Nunavut Water Board
P.O. Box 119
Gjoa Haven, NU X0B 1J0

Dear Phyllis:

Project No: Water Use License 1BR-DYE0914 2010 Annual Report**Regarding: DYE-M, Cape Dyer DEW Line Site**

AECOM Canada Ltd. is providing the attached annual report form as per Section B.1 of the above-noted water use license. The report is being submitted on behalf of Defence Construction Canada and the Department of National Defence.

In addition to the annual report form, we are providing a summary of the work completed to date at the site. The following is a summary of the work completed and of the samples collected as part of the wastewater monitoring and sewage effluent monitoring:

Work Completed

The contractor for the DYE-M site left at the end of 2009, and notified DCC they would not be returning to the site. As a result, a new tender package and a new contractor would be required for the completion of the work. Therefore, during the 2010 season, the work completed at the DYE-M site was comprised of care and maintenance work, which was carried out by the Canadian Military and a separate contractor. The following is a summary of the work items completed during the 2010 summer construction season:

- Snow clearing and road maintenance.
- Dewatering of existing facilities.
- Demolition of two billboards at the Upper Site
- Construction of a temporary storage area at the beach to be used for storage of materials to be shipped off-site.

Work planned for the 2011 construction season includes:

- Continuation of the contaminated soil excavation and disposal.
- Landfarming/treatment of hydrocarbon impacted areas.
- Excavation of two small buried debris areas.

- Wastewater treatment.
- Barrel processing.
- Surface debris removal.
- Demolition of remaining structures not required by NWSO.

It is anticipated that final closure and capping of the Non-Hazardous Waste Landfills and Tier II Soil Disposal Facilities, reshaping of the borrow areas and closure of the sewage lagoon will be completed in 2012.


Community Consultations: The results of the community meetings held by DCC were submitted with the Project Description. The contractor typically holds a project start up meeting prior to each season.

Spill Incidences: See attached spill report.

Monitoring Results: See attached monitoring reports.

We trust the information provided is sufficient. Please feel free to contact the undersigned if you require any additional information.

Sincerely,
AECOM Canada Ltd.

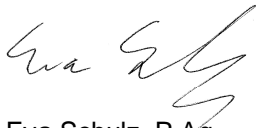

Eva Schulz, P.Ag.
Eva.Schulz@aecom.com

EMS
Encl. Annual Report Form, Updated Site Figures, Selected Site Photos, Spill Report, Monitoring Reports
cc: Tamara Van Dyck, DCC

NWB Annual Report

Year being reported: 2010 ▼

License No: 1BR-DYE0914

Issued Date: June 9, 2009

Expiry Date: May 31, 2014

Project Name: DYE-M, Cape Dyer DEW Line Site Clean Up

Licensee: Defence Construction Canada

Mailing Address: Defence Construction Canada
 DGME
 101 Colonel By Drive,
 Ottawa, Ontario, Canada. K1A 0K2

Name of Company filing Annual Report (if different from Name of Licensee
 please clarify relationship between the two entities, if applicable):

AECOM
 Design Engineering and Regulatory Support

General Background Information on the Project (*optional):

Licence Requirements: the licensee must provide the following information in
 accordance with

Part B ▼ Item 1 ▼

**A summary report of water use and waste disposal activities, including, but not limited to:
 methods of obtaining water; sewage and greywater management; drill waste management;
 solid and hazardous waste management.**

Water Source(s):	Water supply lakes	
Water Quantity:	150/day	Quantity Allowable Domestic (cu.m)
	1189/70 days	Actual Quantity Used Domestic (cu.m)
	n/a	Quantity Allowable Drilling (cu.m)
	n/a	Total Quantity Used Drilling (cu.m)

Waste Management and/or Disposal

- ☒ Solid Waste Disposal
☒ Sewage 951 cu.m of sewage effluent and greywater deposited into sewage
☒ Drill Waste lagoon
☒ Greywater
☒ Hazardous
☒ Other:

Additional Details:

Details regarding waste management were provided in the supporting documents
 included with the application.

A list of unauthorized discharges and a summary of follow-up actions taken.

Spill No.: 1 (as reported to the Spill Hot-line)

Date of Spill: June 11, 2010

Date of Notification to an Inspector: June 14, 2010

Additional Details: (impacts to water, mitigation measures, short/long term monitoring, etc)

See attached spill report.

Revisions to the Spill Contingency Plan

SCP submitted and approved - no revision required or proposed



Additional Details:

Revisions to the Abandonment and Restoration Plan

AR plan submitted and approved - no revision required or proposed



Additional Details:

The project is an abandonment and restoration plan.

Progressive Reclamation Work Undertaken

Additional Details (i.e., work completed and future works proposed)

Results of the Monitoring Program including:

The GPS Co-ordinates (in degrees, minutes and seconds of latitude and longitude) of each location where sources of water are utilized;

Details attached



Additional Details:

The GPS Co-ordinates (in degrees, minutes and seconds of latitude and longitude) of each location where wastes associated with the licence are deposited;

Details attached



Additional Details:

Results of any additional sampling and/or analysis that was requested by an Inspector

No additional sampling requested by an Inspector or the Board



Additional Details: (date of request, analysis of results, data attached, etc)

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Any other details on water use or waste disposal requested by the Board by November 1 of the year being reported.

No additional sampling requested by an Inspector or the Board	▼
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Additional Details: (Attached or provided below)

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Any responses or follow-up actions on inspection/compliance reports

No inspection and/or compliance report issued by INAC	▼
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Additional Details: (Dates of Report, Follow-up by the Licensee)

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Any additional comments or information for the Board to consider

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Date Submitted:

March 31, 2011

Submitted/Prepared by:

Eva Schulz

Contact Information:

Tel:	403-270-9200
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Fax:	403-270-0399
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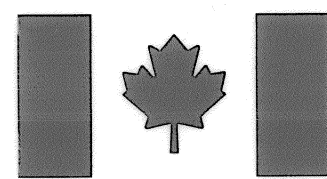
email:	eva.schulz@aecom.com
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GPS Coordinates for water sources utilized

Source Description	UTM Zone 20N, NAD83	
	Northing	Easting
Lower Site Water Supply Lake	7390039	559775
Summer Water Supply Lake	7389802	565916
Winter Water Supply Lake	7395600	570250

GPS Locations of areas of waste disposal

	UTM Zone 20N, NAD83	
	Northing	Easting
Landfarm (E01)	7387924.9	562601.4
Landfarm (E01)	7387931.4	562624.8
Landfarm (E01)	7387004.7	562765
Landfarm (E01)	7387922	562808.3
Landfarm (E01)	7387725.6	562911.1
Landfarm (E01)	7387645.4	562757.8
Landfarm (E01)	7387718.1	562525.6
Landfarm (E01)	7387759.3	562496.2
Landfarm (E01)	7387843.9	562454.5
Lower Site Tier II (H01)	7388272.5	561782.6
Lower Site Tier II (H01)	7388345.3	561925.1
Lower Site Tier II (H01)	7388242.9	561977.4
Lower Site Tier II (H01)	7388170.1	561835
Lower Site Non-Haz (F01)	7387025.5	562989.6
Lower Site Non-Haz (F02)	7387070.4	563061.8
Lower Site Non-Haz (F03)	7387943.1	563141.1
Lower Site Non-Haz (F04)	7387953.3	563034.6
Upper Site Tier II (X01)	7394628.6	571043.9
Upper Site Tier II (X02)	7394676.6	571117.6
Upper Site Tier II (X03)	7394599.5	571167.8
Upper Site Tier II (X04)	7394551.5	571094
Upper Site Non-Haz (V01)	7395184.3	572155.5
Upper Site Non-Haz (V02)	7395144	572311.4
Upper Site Non-Haz (V03)	7395090.7	572297.6
Upper Site Non-Haz (V04)	7395105.9	572239.1
Upper Site Non-Haz (V05)	7395070	572178.1
Upper Site Non-Haz (V06)	7395075	572158.8
Upper Site Non-Haz (V07)	7395112.2	572136.9
Sewage Lagoon Cell #1	7386890	563376
Sewage Lagoon Cell #2	7386916	563362



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Defence

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nationale

DEW LINE CLEAN UP PROJECT





DYE-M CAPE DYER TENDER DRAWINGS

AECOM

HATCH™


DECEMBER, 2010

DRAWING INDEX					
DRAWING No.	TITLE	DRAWING No.	TITLE	DRAWING No.	TITLE
SITING		SITING		STRUCTURAL	
H-C75/3-9101-101	OVERALL SITE PLAN	H-C75/3-9101-160	UPPER SITE PROJECT LAYOUT	H-C75/3-9101-202	UPPER SITE DEW DROP AREA DEMOLITION SITE PLAN
H-C75/3-9101-102	LOWER SITE BEACH AREA PROJECT LAYOUT	H-C75/3-9101-161	UPPER SITE DEW DROP AREA PLAN	H-C75/3-9101-203	UPPER SITE STATION AREA DEMOLITION SITE PLAN
H-C75/3-9101-103	LOWER SITE STATION AREA PROJECT LAYOUT	H-C75/3-9101-162	UPPER SITE STATION AREA PLAN SHEET 1	H-C75/3-9101-204	GARAGE PLAN AND SECTION
H-C75/3-9101-104	LOWER SITE BEACH LANDFILL-NORTH AREA PLAN	H-C75/3-9101-163	UPPER SITE STATION AREA PLAN SHEET 2	H-C75/3-9101-205	HEATED VEHICLE STORAGE PLAN, SECTION AND ELEVATIONS
H-C75/3-9101-105	LOWER SITE BEACH LANDFILL-SOUTH AREA PLAN	H-C75/3-9101-164	UPPER SITE SOUTH LANDFILL AREA PLAN	H-C75/3-9101-206	AIR TERMINAL BUILDING PLAN, SECTION AND ELEVATION
H-C75/3-9101-106	LOWER SITE LANDFARM AREA PLAN	H-C75/3-9101-165	UPPER SITE WEST OF STATION AREA PLAN SHEET 1	H-C75/3-9101-207	ATWELL DORMITORY PLAN, SECTION AND ELEVATION
H-C75/3-9101-107	LOWER SITE STATION AREA-NORTH PLAN	H-C75/3-9101-166	UPPER SITE WEST OF STATION AREA PLAN SHEET 2	H-C75/3-9101-208	WAREHOUSE-B13A PLAN AND SECTION
H-C75/3-9101-108	LOWER SITE STATION AREA PLAN	H-C75/3-9101-167	UPPER SITE WEST OF STATION AREA PLAN SHEET 3	H-C75/3-9101-209	WAREHOUSE-B13B PLAN AND SECTION
H-C75/3-9101-109	LOWER SITE LOWER CAMP LANDFILL AREA PLAN	H-C75/3-9101-168	UPPER SITE NON-HAZARDOUS WASTE LANDFILL CROSS SECTION	H-C75/3-9101-210	WAREHOUSE-B13F PLAN AND SECTION
H-C75/3-9101-110	LOWER SITE TIER II DISPOSAL FACILITY AREA PLAN	H-C75/3-9101-169	UPPER SITE TIER II DISPOSAL FACILITY GRADING/INSTRUMENTATION PLAN	H-C75/3-9101-211	WAREHOUSE-B13E PLAN AND SECTION
H-C75/3-9101-111	LOWER SITE LANDFARM CROSS SECTION AND CLOSURE DETAIL	H-C75/3-9101-170	UPPER SITE TIER II DISPOSAL FACILITY CROSS SECTION	H-C75/3-9101-212	FUEL TANKS ELEVATIONS
H-C75/3-9101-112	LOWER SITE NON-HAZARDOUS WASTE LANDFILL CROSS SECTION			H-C75/3-9101-213	BUILDING LINK SECTION AND ELEVATION
H-C75/3-9101-113	LOWER SITE TIER II DISPOSAL FACILITY CROSS SECTION SHEET 1	H-C75/3-9101-190	MISCELLANEOUS DETAILS SHEET 1	H-C75/3-9101-214	SMALL COMMUNICATION BILLBOARD, FEEDHORN FOUNDATION PLAN, SECTION AND ELEVATIONS
H-C75/3-9101-114	LOWER SITE TIER II DISPOSAL FACILITY CROSS SECTION SHEET 2	H-C75/3-9101-191	MISCELLANEOUS DETAILS SHEET 2	H-C75/3-9101-215	LARGE COMMUNICATION BILLBOARD PLAN, SECTION AND ELEVATION
				H-C75/3-9101-216	SWITCHING CENTRE AND COMMUNICATION BUILDING PLAN AND SECTION
H-C75/3-9101-150	MIDDLE SITE SITE PLAN	STRUCTURAL		H-C75/3-9101-217	POWER AND EQUIPMENT BUILDING PLAN AND SECTION
		H-C75/3-9101-201	LOWER SITE STATION AREA DEMOLITION SITE PLAN	H-C75/3-9101-218	POWERHOUSE PLAN, SECTIONS AND ELEVATION
				© COPYRIGHT HER MAJESTY THE QUEEN IN RIGHT OF CANADA 2010, AS REPRESENTED BY THE MINISTER OF NATIONAL DEFENCE.	

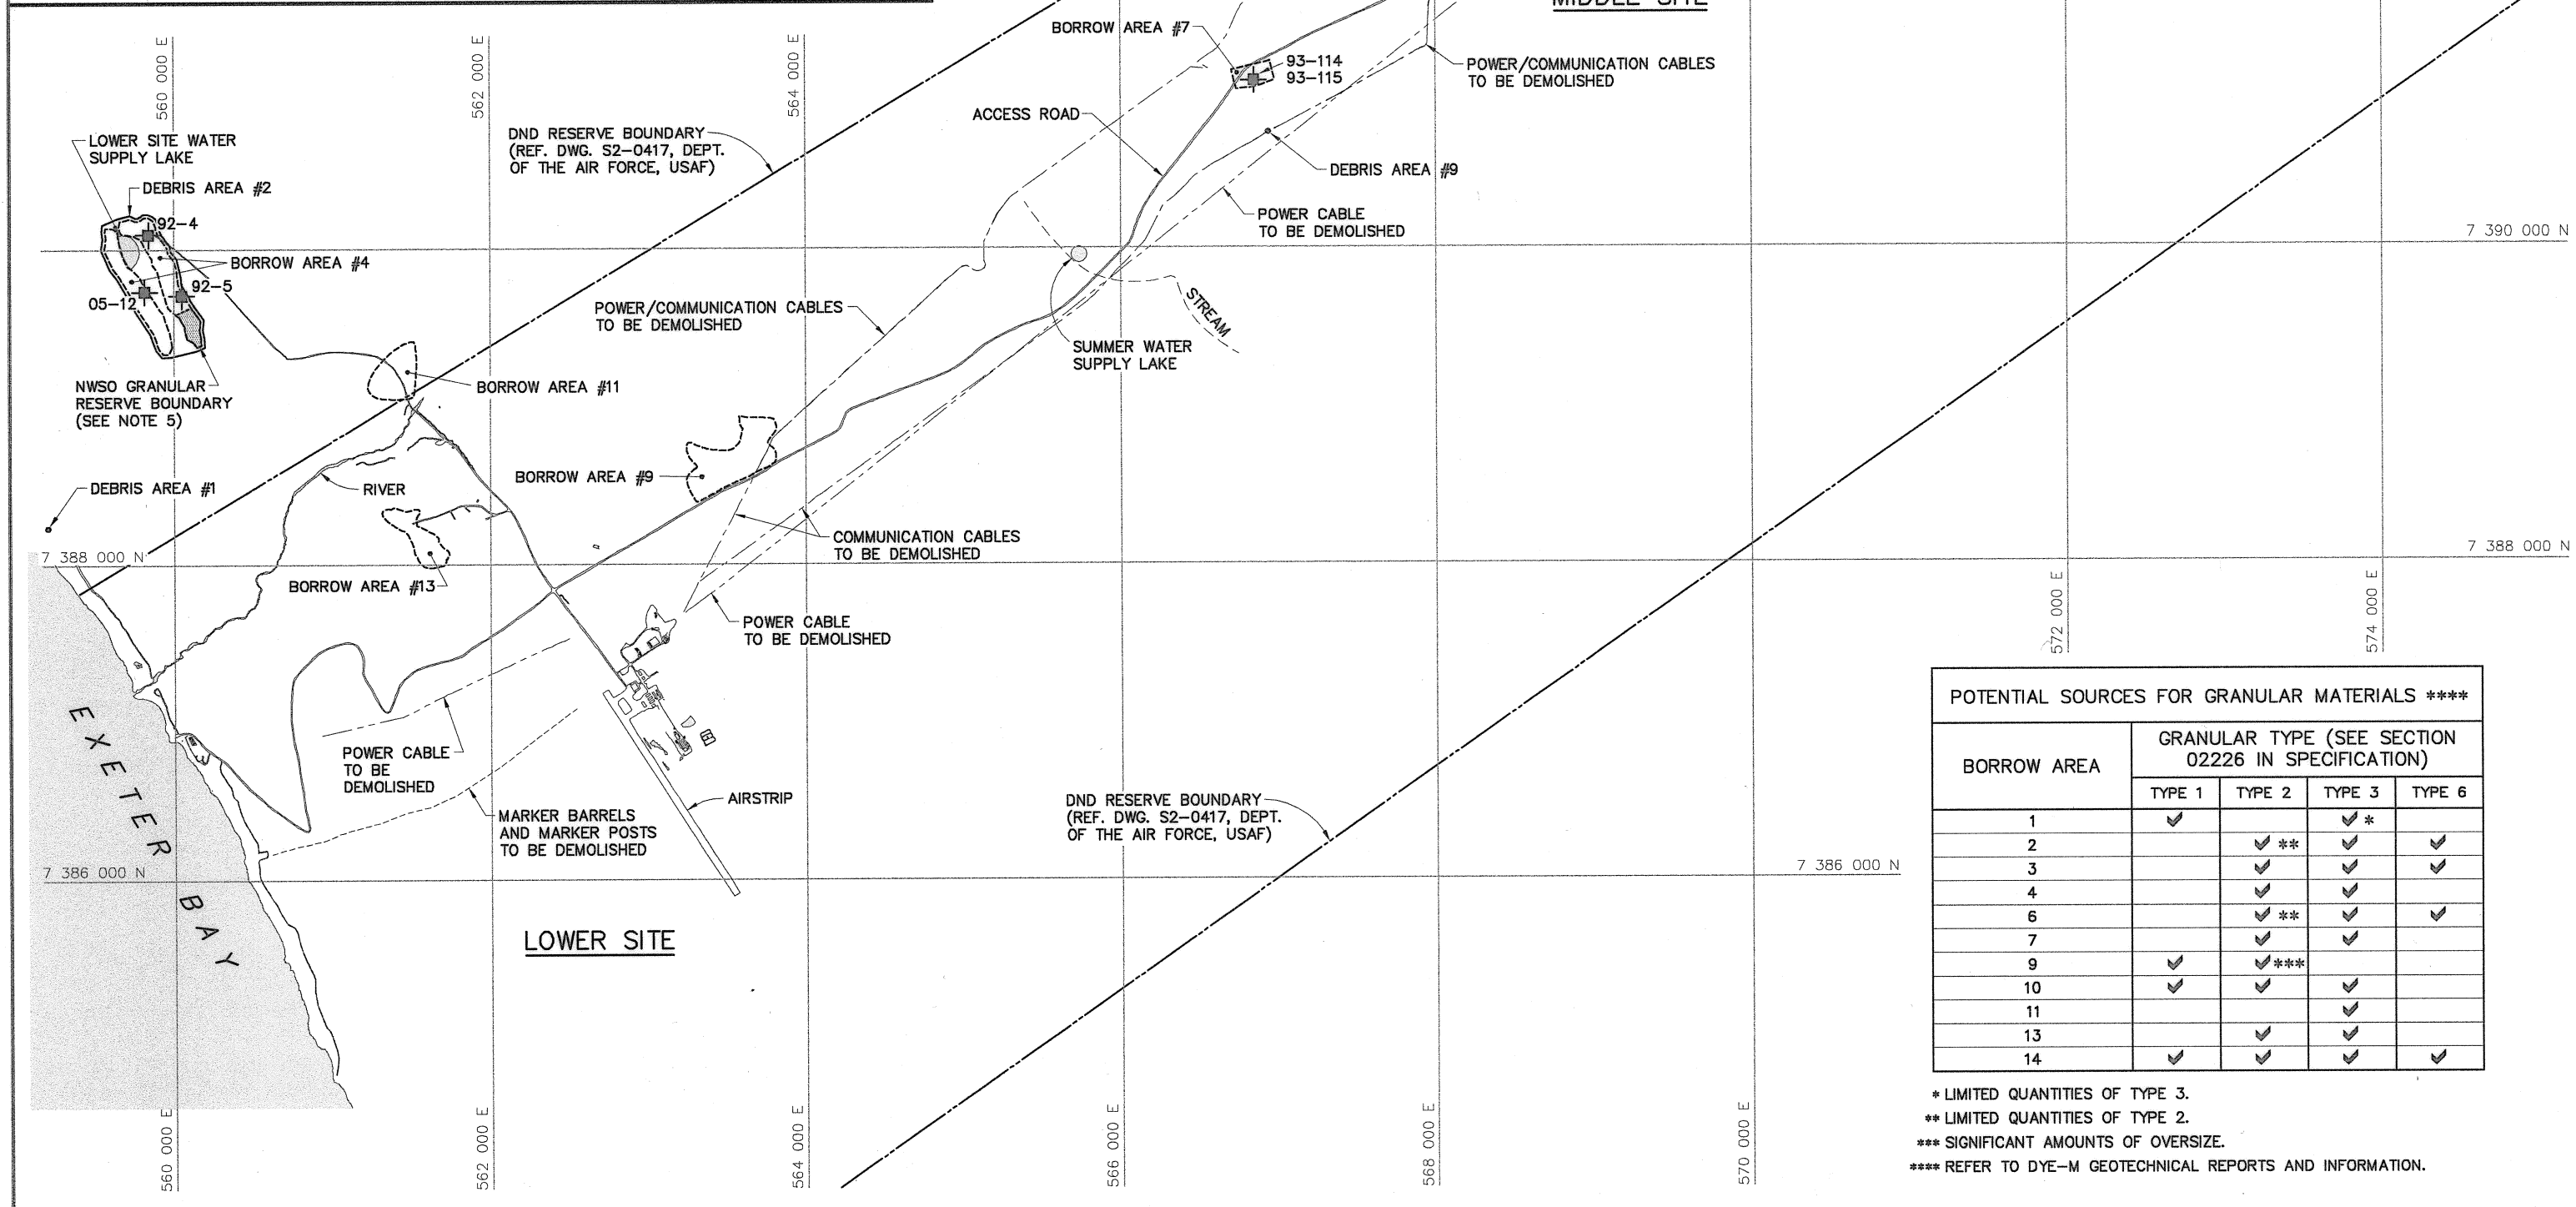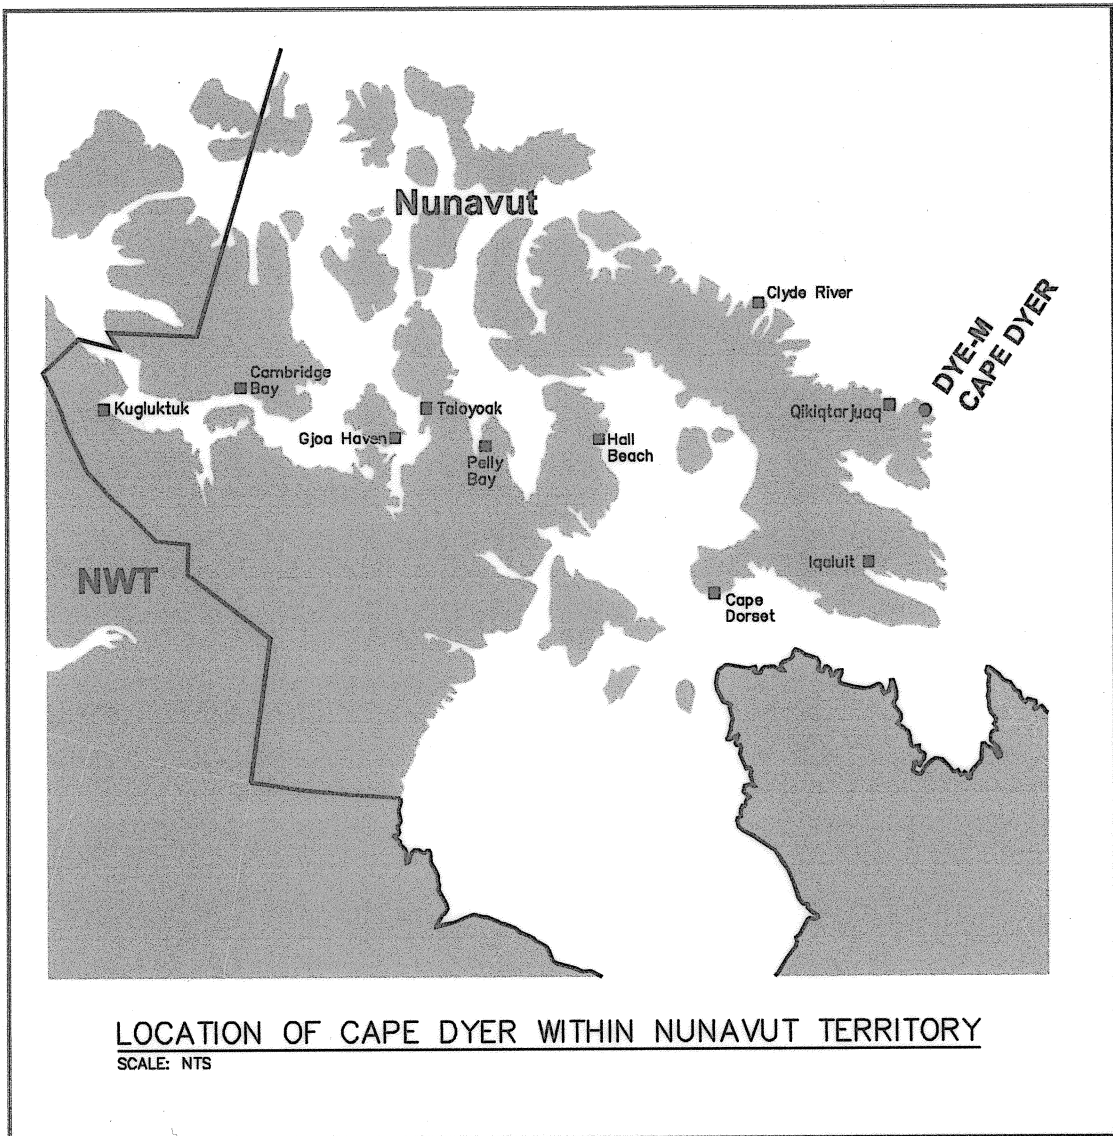


POTENTIAL SOURCES FOR GRANULAR MATERIALS ****					
BORROW AREA	GRANULAR TYPE (SEE SECTION 02226 IN SPECIFICATION)				
	TYPE 1	TYPE 2	TYPE 3	TYPE 6	
1	✓		✓ *		
2		✓ **	✓	✓	
3		✓	✓	✓	
4		✓	✓	✓	
6		✓ **	✓	✓	
7		✓	✓	✓	
9	✓	✓ ***	✓		
10	✓	✓	✓		
11		✓	✓	✓	
13		✓	✓	✓	
14	✓	✓	✓	✓	

* LIMITED QUANTITIES OF TYPE 3.
** LIMITED QUANTITIES OF TYPE 2.
*** SIGNIFICANT AMOUNTS OF OVERSIZE.
**** REFER TO DYE-M GEOTECHNICAL REPORTS AND INFORMATION.

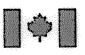

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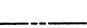
Désense
nationale

Headquarters
Quartier général


General Notes:

- ALL COORDINATES ARE REFERENCED TO UTM ZONE 20N, NAD83. ELEVATIONS ARE REFERENCED TO MEAN SEA LEVEL RELATIVE TO GEOID MODEL CANADIAN HT2.0.
- REMOVE ALL SURFICIAL DEBRIS FROM ENTIRE PLAN AREA. ALL NON-HAZARDOUS DEBRIS FROM SOURCES WEST OF BORROW AREA #7 TO BE PLACED IN LOWER SITE NON-HAZARDOUS WASTE LANDFILL. ALL NON-HAZARDOUS DEBRIS FROM SOURCES EAST OF BORROW AREA #7 TO BE PLACED IN UPPER SITE NON-HAZARDOUS WASTE LANDFILL.
- REFER TO TABLE 02219-1 IN SPECIFICATIONS FOR DESCRIPTION OF DEBRIS AREAS.
- REMOVE AND DISPOSE OF ALL SURVEY STAKES AND SAMPLE TAGS FROM ALL SITE AREAS.
- NWSO GRANULAR RESERVE IS NOT AVAILABLE FOR USE BY THE CONTRACTOR.


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
APPROXIMATE LOCATION OF PROPERTY BOUNDARIES



APPROXIMATE EXTENT OF BORROW AREAS

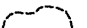




TEST PIT LOCATION




BODY OF WATER


No.	DATE	REVISION	REVISION	APPR.

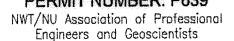

PERMIT TO PRACTICE
AECOM Canada Ltd.
Signature: 
Date: 
PERMIT NUMBER: P639
NWT/NU Association of Professional Engineers and Geoscientists



AECOM



HATCH

SCALE - ECHILLE 400 200 0 400 800 1200m

PROJECT - PROJET
DYE-M CAPE DYER

DEW LINE CLEAN UP

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TRADE - METIER	SITING	DATE
		2010-12-07



SUBJECT - SUJET

OVERALL SITE PLAN

PRODUCTION	CONCURRENCE - ASSENTIMENT
DESIGNED ETUDIE DTM/TME	DES OFF AGENT CONCEPT
DRAWN DESSINE IC/CAE	SECT HD CHIEF SECT
CHECKED VERIFIE BWF	DES MGR GEST CONCEPT
COORDINATION RRM	REVIEWED - REVU

DWG. NO. - DESSIN NO.
H-C75/3-9101-101

Canada

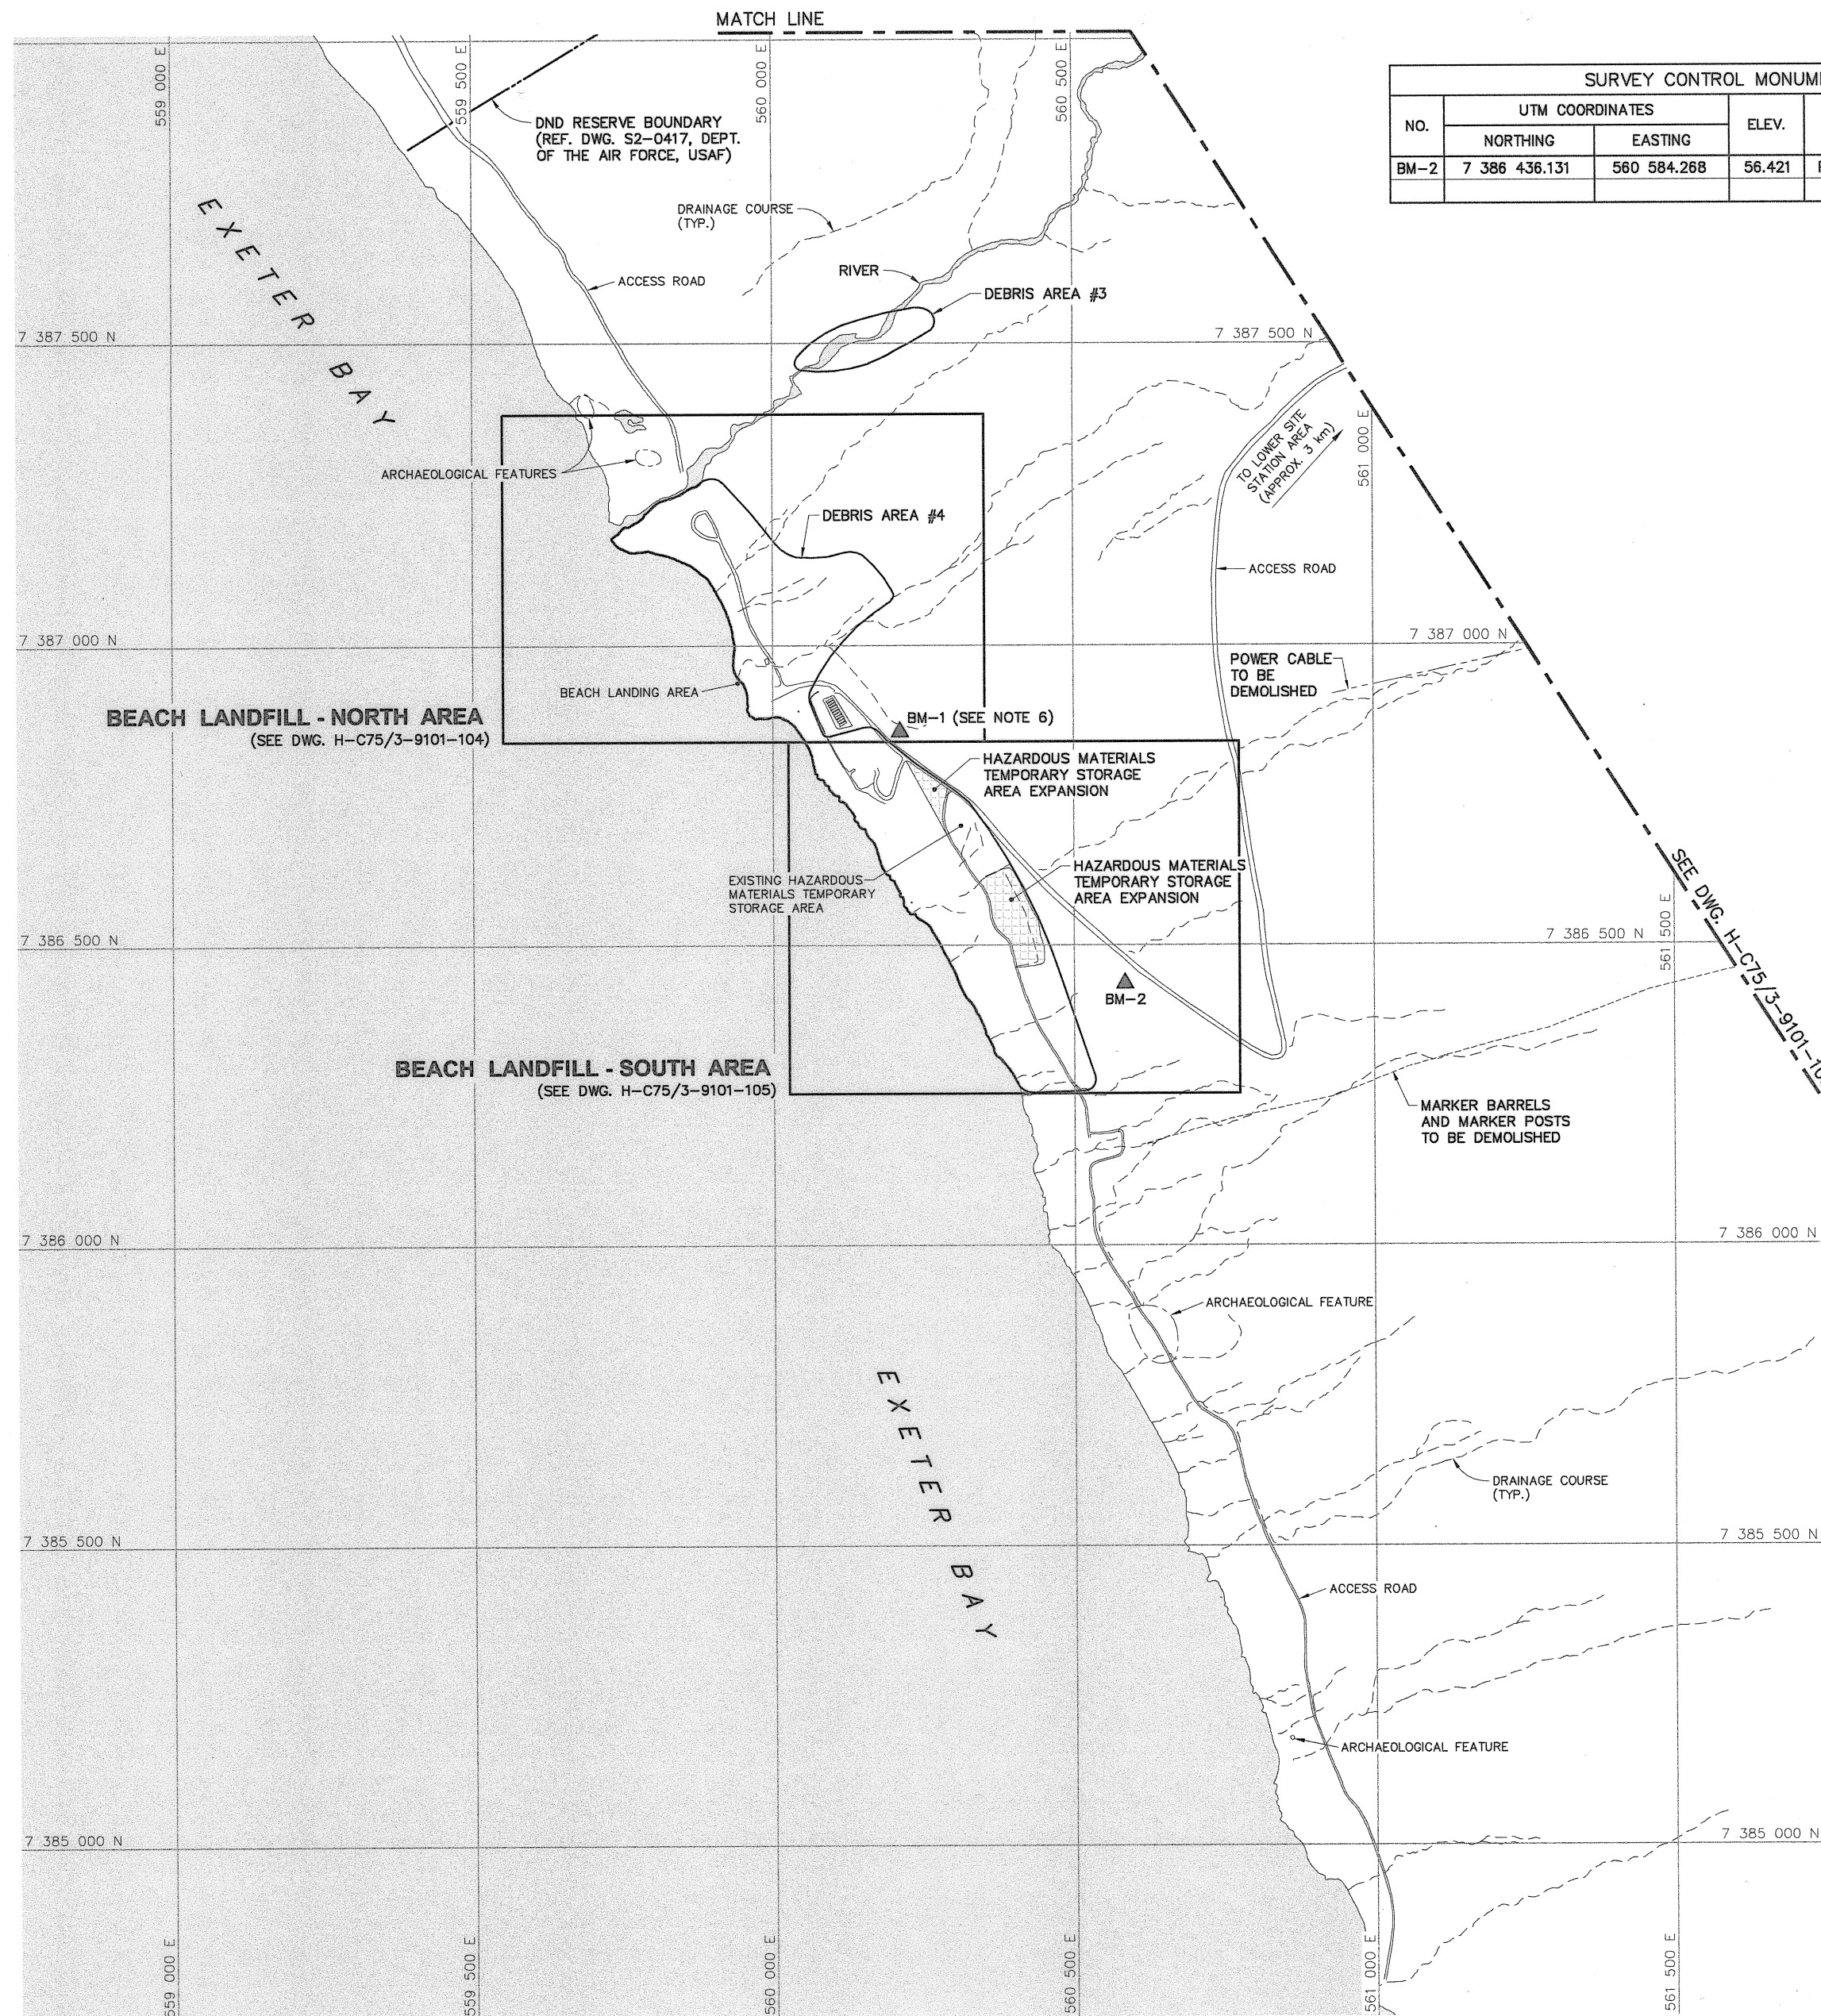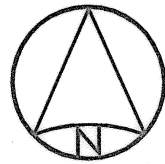

SURVEY CONTROL MONUMENTS				
NO.	UTM COORDINATES		ELEV.	DESCRIPTION
	NORTHING	EASTING		
BM-2	7 386 436.131	560 584.268	56.421	PERMANENT BENCHMARK


General Notes:

1. ALL COORDINATES ARE REFERENCED TO UTM ZONE 20N, NAD83. ELEVATIONS ARE REFERENCED TO MEAN SEA LEVEL RELATIVE TO GEOID MODEL CANADIAN HT2_0.
2. ARCHAEOLOGICAL FEATURES LOCATED AS PER ENVIRONMENTAL CLEAN UP STUDY OF 21 DEW LINE SITES IN CANADA, VOL. 23, UMA 1991.
3. ALL DIMENSIONS ARE IN METRES UNLESS NOTED OTHERWISE.
4. ALL NON-HAZARDOUS DEBRIS WITHIN PLAN AREA TO BE PLACED IN LOWER SITE NON-HAZARDOUS WASTE LANDFILL.
5. REFER TO TABLE 02219-1 IN SPECIFICATIONS FOR DESCRIPTION OF DEBRIS AREAS.
6. BM-1 TO BE TIED INTO SITE SURVEY COORDINATE SYSTEM.

Legend:

- ▲ BM-1 PERMANENT BENCHMARK LOCATION (2)
○ BODY OF WATER

No.	DATE	REVISION	REVISION	APPR.
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AECOM

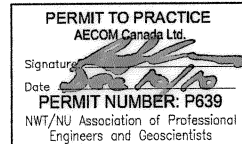HATCH

SCALE - ECHILLE 100 50 0 100 200 300m

PROJECT - PROJET
DYE-M CAPE DYER

DEW LINE CLEAN UP

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MINISTER OF NATIONAL DEFENCE.


TRADE - METIER SITING DATE 2010-12-07

SUBJECT - SUJET
LOWER SITE
BEACH AREA
PROJECT LAYOUT


PRODUCTION		CONCURRENCE - ASSENTMENT	
DESIGNED ETUDIE	DTM/TME	DES OFF AGENT CONCEPT	
DRAWN DESSINE	IC/CAE	SECT HD CHEF SECT	
CHECKED VERIFIE	BWF	DES MGR GEST CONCEPT	
COORDINATION RRM		REVIEWED - REVU	

DWG. NO. - DESSIN NO.
H-C75/3-9101-102


Canada

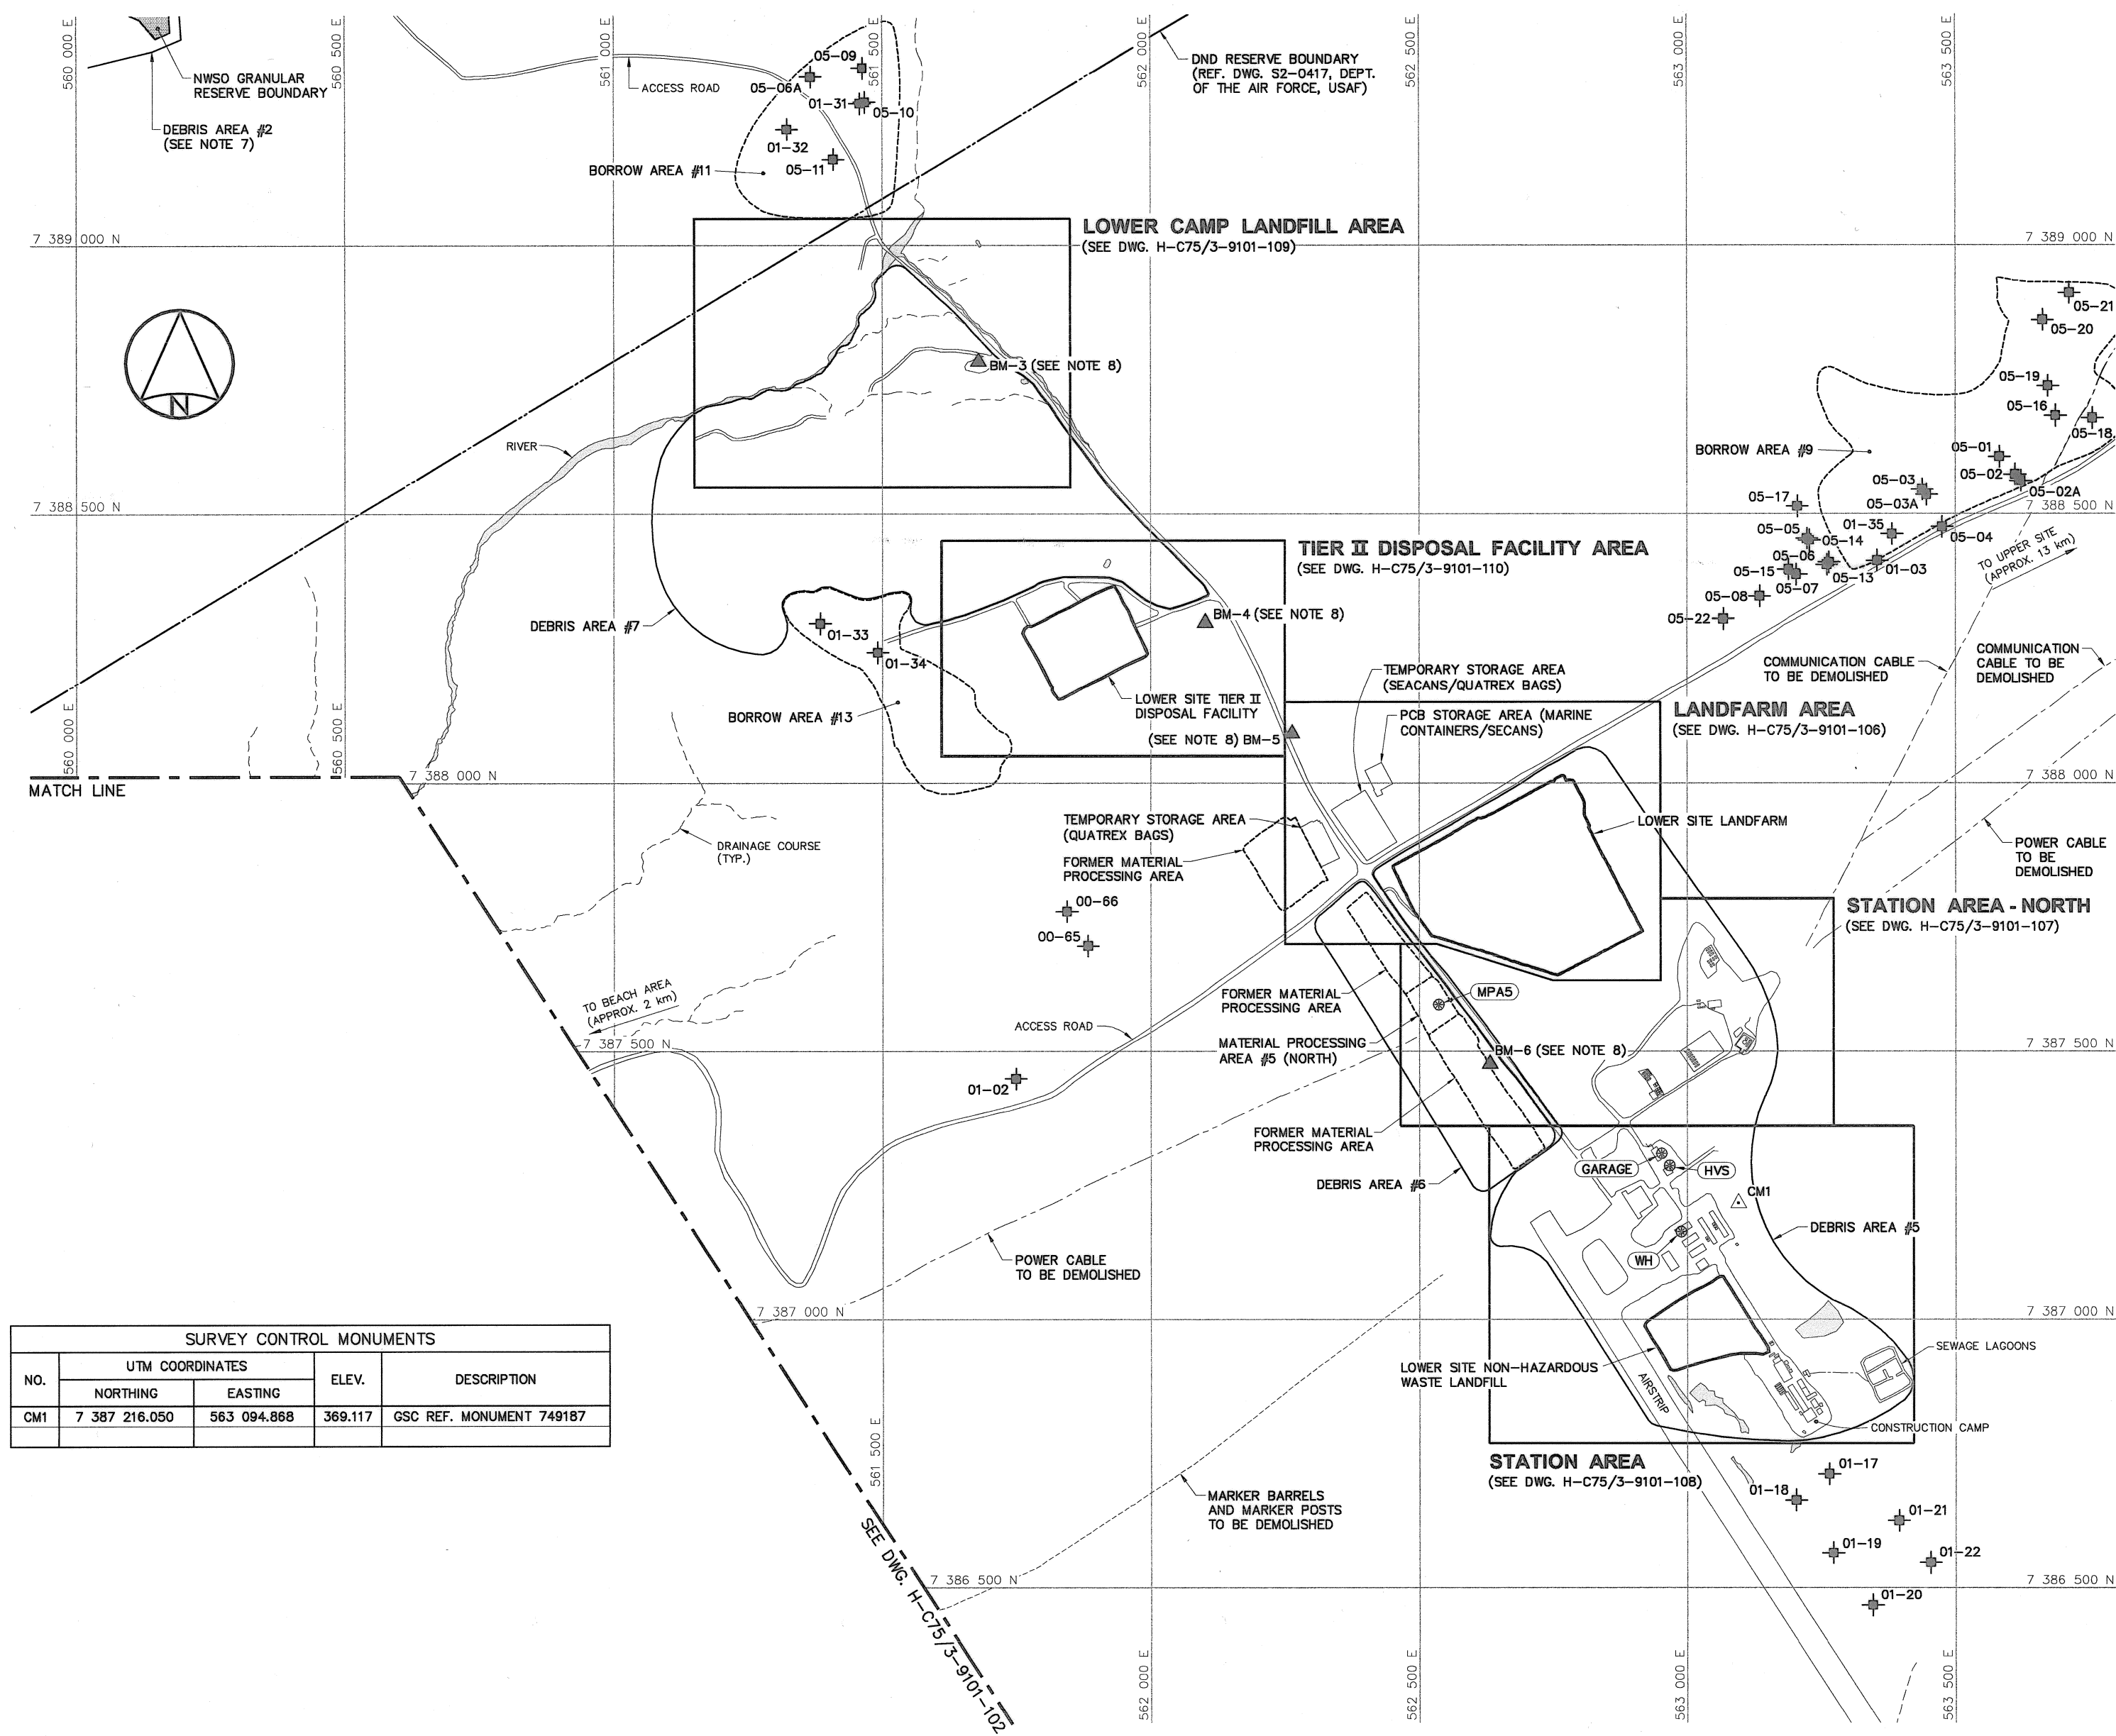

SURVEY CONTROL MONUMENTS				
NO.	UTM COORDINATES		ELEV.	DESCRIPTION
	NORTHING	EASTING		
CM1	7 387 216.050	563 094.868	369.117	GSC REF. MONUMENT 749187



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
Désense
nationale

Headquarters
Quartier général


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- ALL DIMENSIONS ARE IN METRES UNLESS NOTED OTHERWISE.
- ALL NON-HAZARDOUS DEBRIS WITHIN PLAN AREA TO BE PLACED IN LOWER SITE NON-HAZARDOUS WASTE LANDFILL.
- REFER TO TABLE 02219-1 IN SPECIFICATIONS FOR DESCRIPTION OF DEBRIS AREAS.
- ALL SURFACE DEBRIS IS TO BE REMOVED FROM ALL CONTAMINATED SOIL AREAS AND EXISTING LANDFILL AREAS PRIOR TO ANY FILL PLACEMENT OR EXCAVATION TAKING PLACE.
- FOR ENTIRE DEBRIS AREA LIMITS, SEE DWG. H-C75/3-9101-101.
- BM-3, BM-4, BM-5 AND BM-6 TO BE TIED INTO SITE SURVEY COORDINATE SYSTEM.


Legend:

 CM1


SURVEY CONTROL MONUMENT

 BM-3


PERMANENT BENCHMARK LOCATION (4)



CONTAMINATED AREA




TEST PIT LOCATION



BODY OF WATER

No.	DATE	REVISION	REVISION	APPR.



Dec 16/10

PERMIT TO PRACTICE

AECOM Canada Ltd.

Signature: [Signature]

Date: Dec 16/10

PERMIT NUMBER: P639

NWT/NU Association of Professional Engineers and Geoscientists

AECOM

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SCALE - ECHELLE 100 50 0 100 200 300m

PROJECT - PROJET DYE-M CAPE DYER

DEW LINE CLEAN UP

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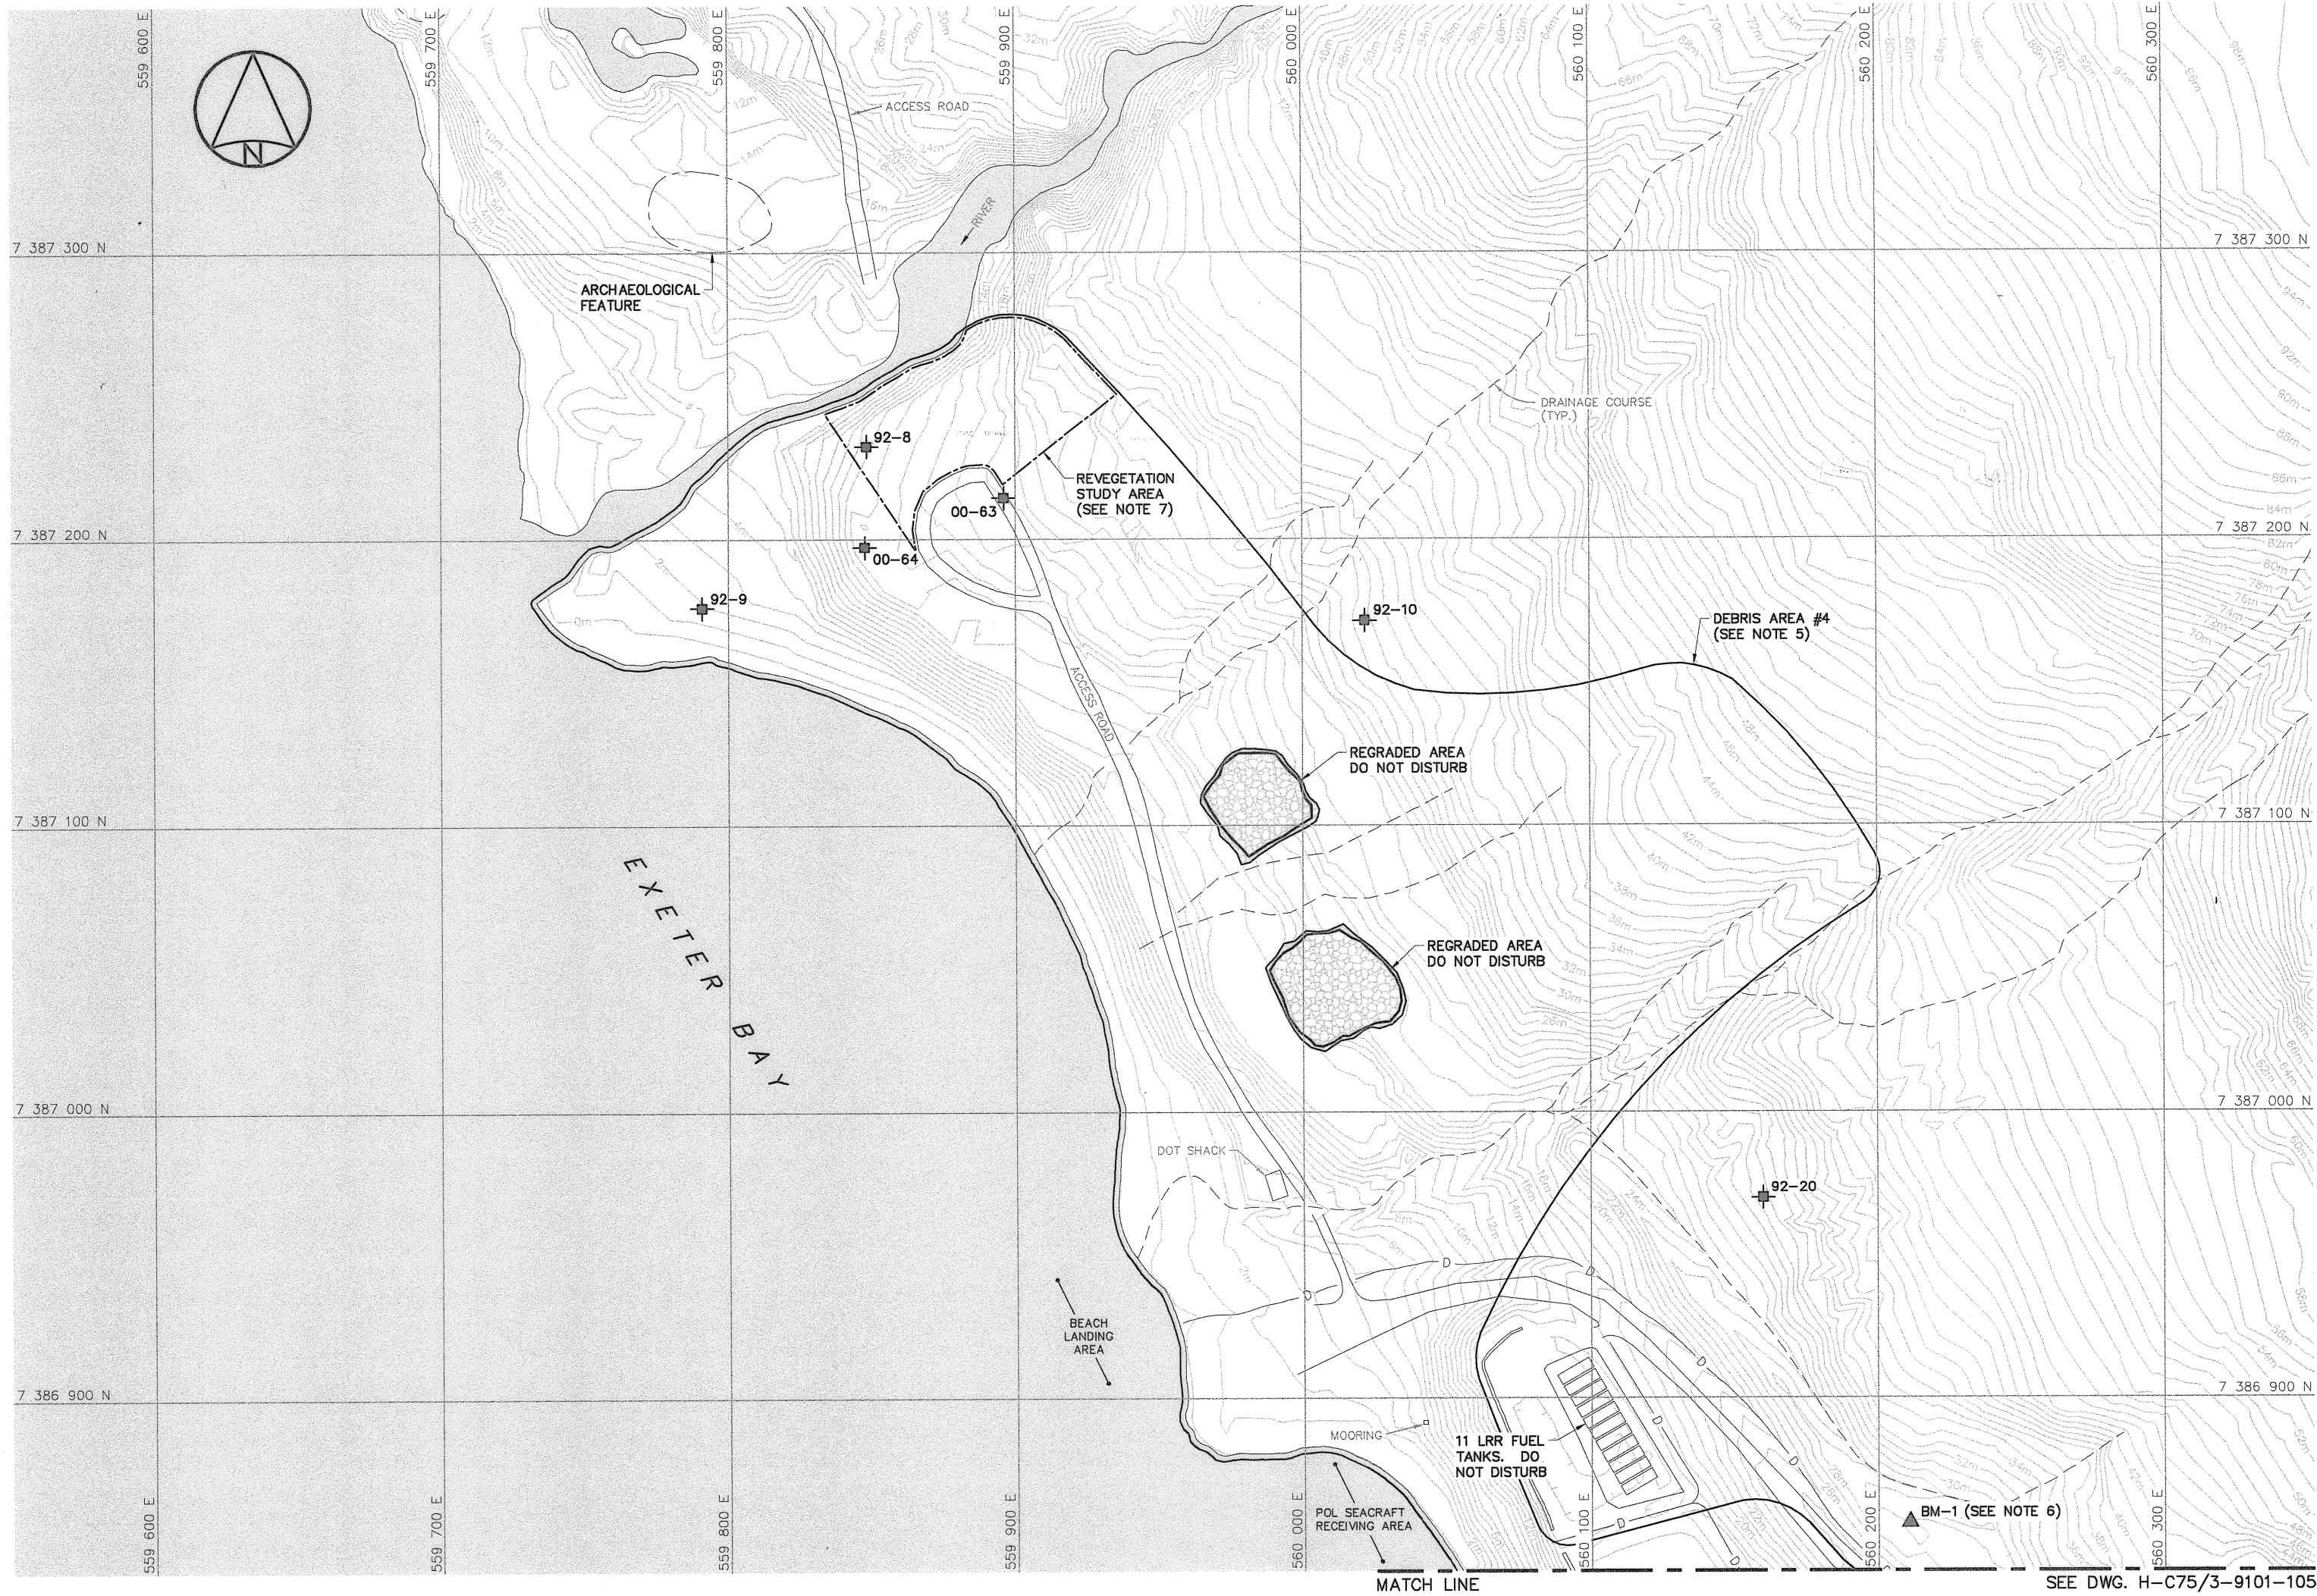
DATE 2010-12-07

SUBJECT - SUJET LOWER SITE STATION AREA PROJECT LAYOUT

PRODUCTION	CONCURRENCE - ASSENTIMENT
DESIGNED ETUDIE DTM/TME	DES OFF AGENT CONCEPT
DRAWN DESSINE IC/CAE	SECT HD CHEF SECT
CHECKED VERIFIE DWF	DES MGR GEST CONCEPT
COORDINATION RRM	REVIEWED - REVU

DWG. NO. - DESSIN NO.
H-C75/3-9101-103

Canada



MATCH LINE

SEE DWG. H-C75/3-9101-105



National Défense nationale

Headquarters
Quartier général


General Notes:

1. ALL COORDINATES ARE REFERENCED TO UTM ZONE 20N, NAD83. ELEVATIONS ARE REFERENCED TO MEAN SEA LEVEL RELATIVE TO GEOID MODEL CANADIAN HT2.0.
2. ALL DIMENSIONS ARE IN METRES UNLESS NOTED OTHERWISE.
3. ALL NON-HAZARDOUS DEBRIS WITHIN PLAN AREA TO BE PLACED IN LOWER SITE NON-HAZARDOUS WASTE LANDFILL.
4. REFER TO TABLE 02219-1 IN SPECIFICATIONS FOR DESCRIPTION OF DEBRIS AREAS.
5. FOR ENTIRE DEBRIS AREA LIMITS, SEE DWG. H-C75/3-9101-102.
6. BM-1 TO BE TIED INTO SITE SURVEY COORDINATE SYSTEM.
7. ACCESS RESTRICTED TO FOOT TRAFFIC ONLY UNLESS AUTHORIZED BY THE ENGINEER.

Legend:

- ▲ BM-1 PERMANENT BENCHMARK LOCATION (1)
- ⊕ TEST PIT LOCATION
- ▨ TYPE 1 GRANULAR FILL
- BODY OF WATER
- D DITCH

No.	DATE	REVISION	REVISION	APPR.
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Date: [Date]
PERMIT NUMBER: P639
NWT/NU Association of Professional Engineers and Geoscientists

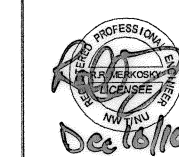AECOM

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SCALE - ECHELLE 20 10 0 20 40 60m

PROJECT - PROJET
DYE-M CAPE DYER

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TRADE - METIER SITING DATE 2010-12-07


SUBJECT - SUJET
LOWER SITE
BEACH LANDFILL-NORTH AREA
PLAN

PRODUCTION	CONCURRENCE - ASSENTIMENT
DESIGNED ETUDIE DTM/TME	DES OFF AGENT CONCEPT
DRAWN DESSINE IC/CAE	SECT HD CHEF SECT
CHECKED VERIFIE DMF	DES NGR GEST CONCEPT
COORDINATION RRM	REVIEWED - REVU

DWG. NO. - DESSIN NO.
H-C75/3-9101-104

Canada

MATCH LINE SEE DWG. H-C75/3-9101-104

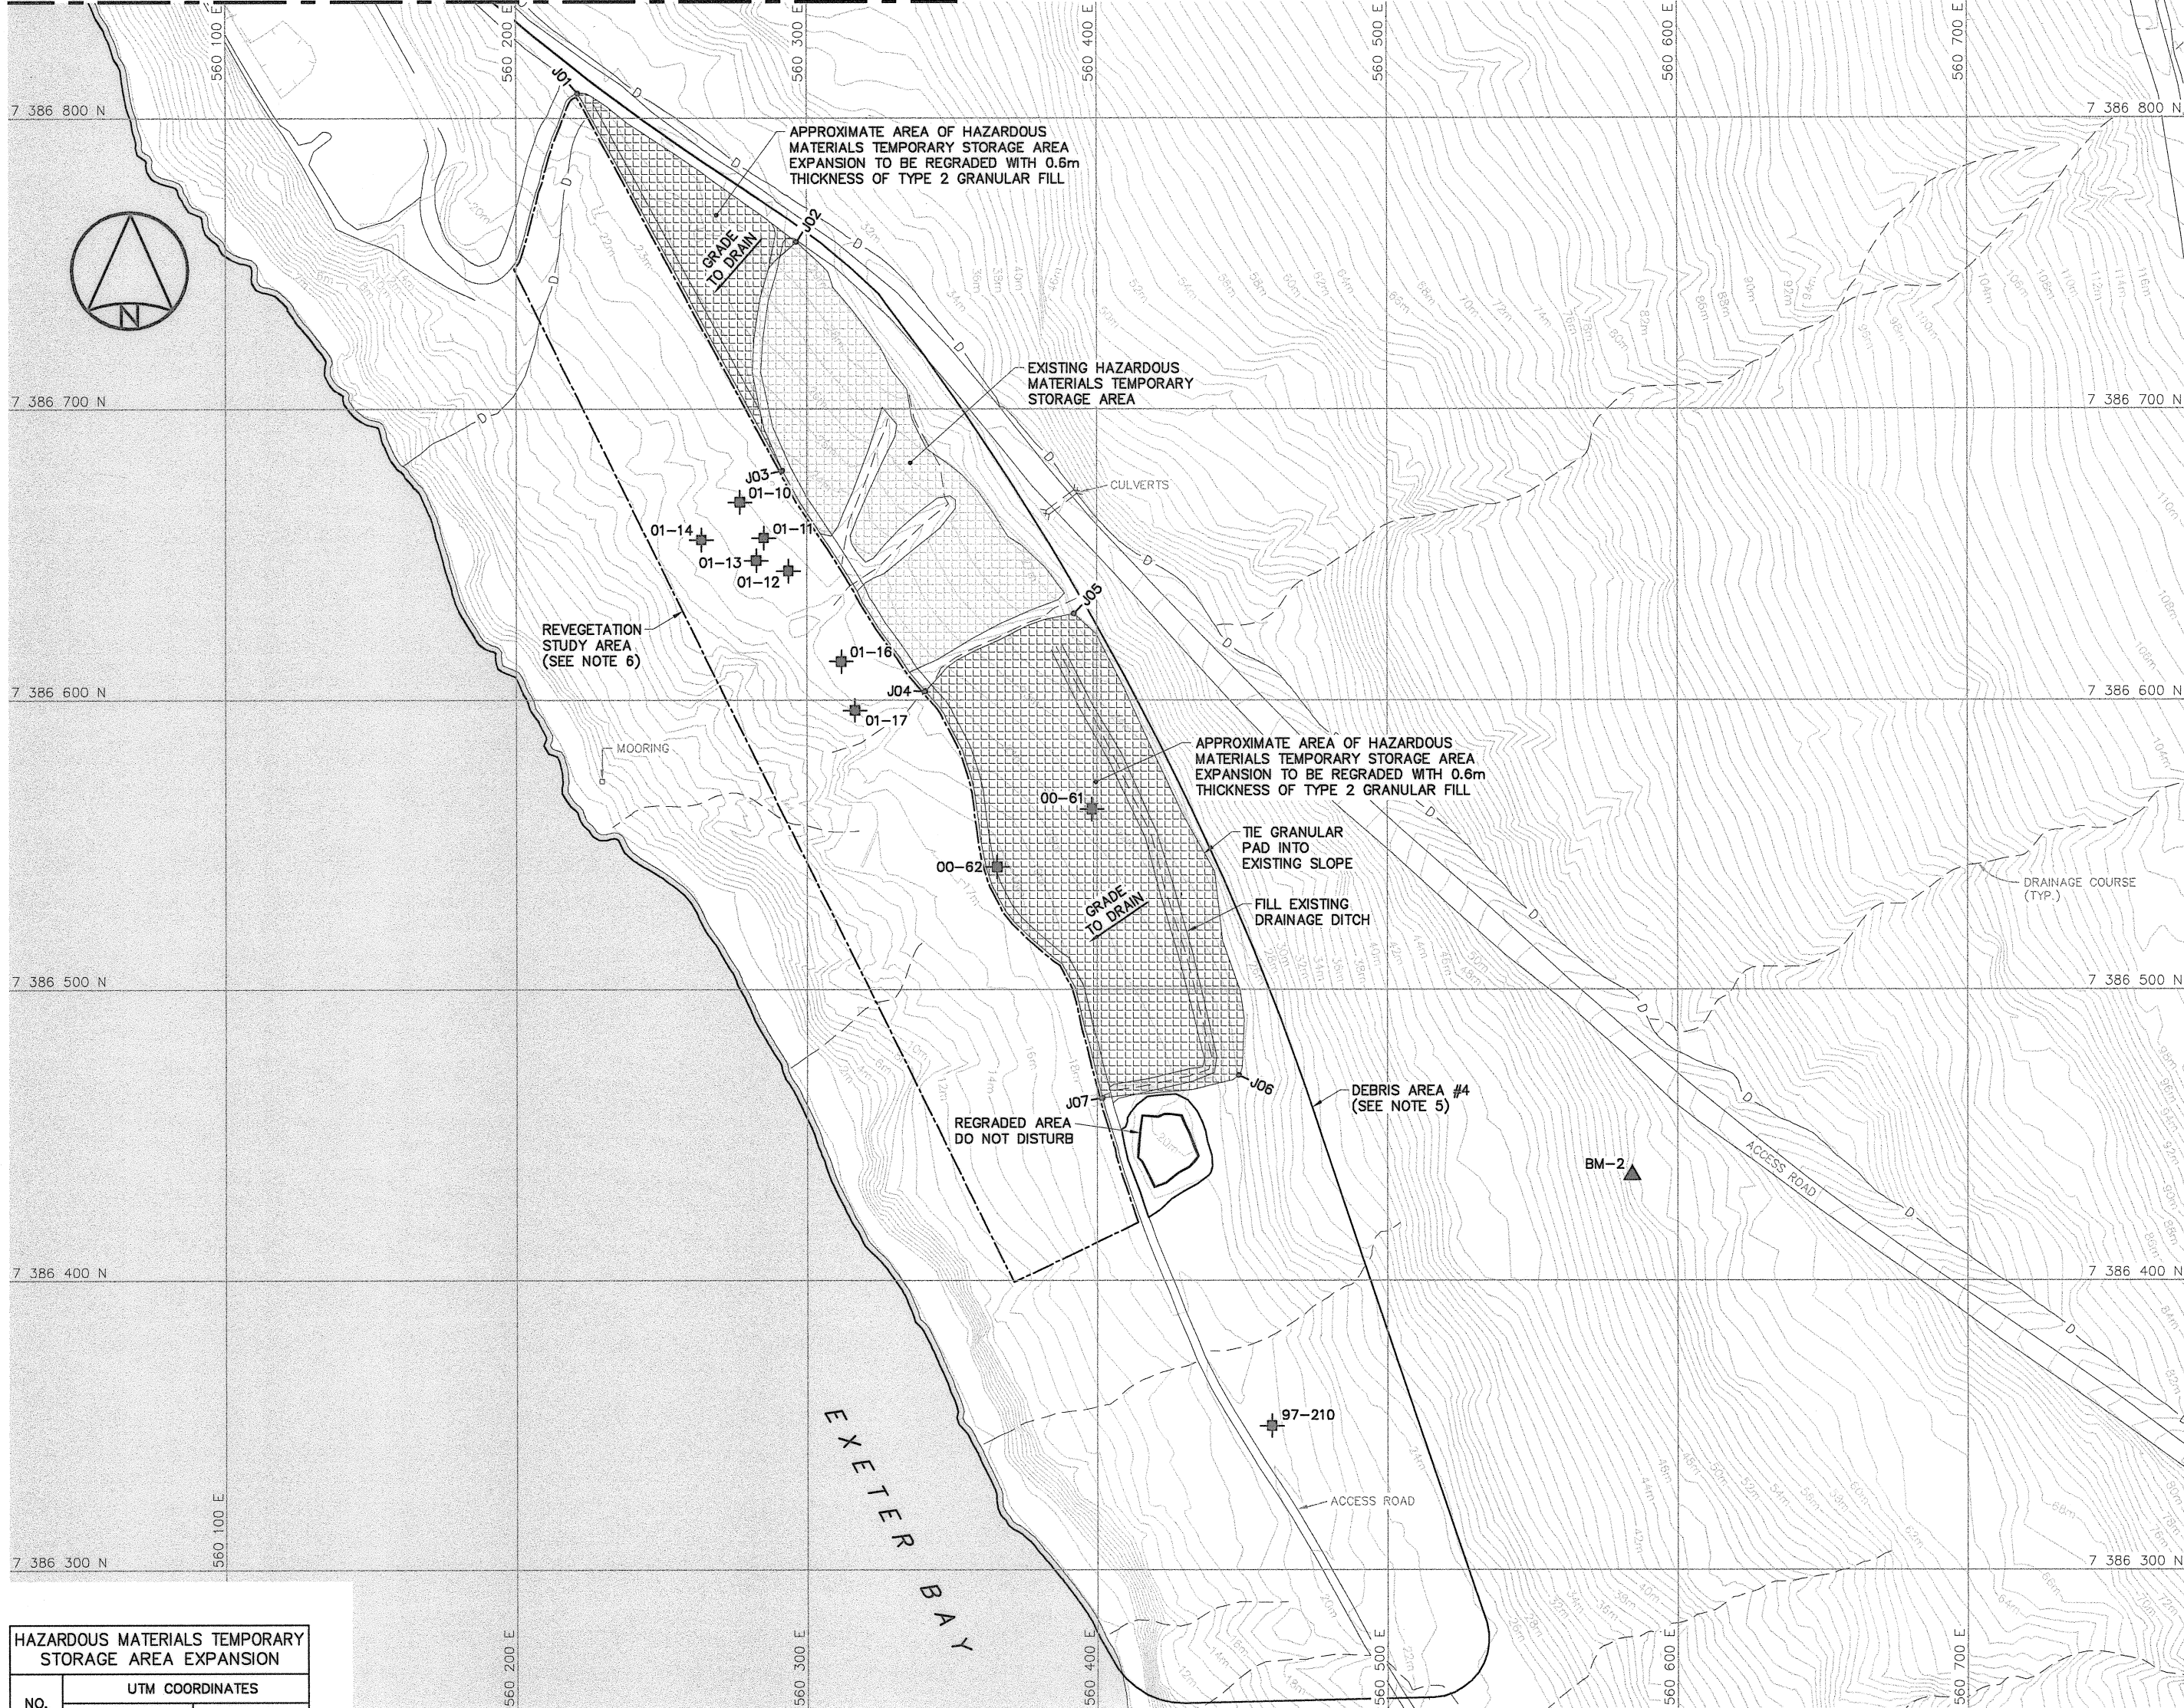

HAZARDOUS MATERIALS TEMPORARY STORAGE AREA EXPANSION			
NO.	UTM COORDINATES		
	NORTHING	EASTING	
J01	7 386 808.6	560 221.1	
J02	7 386 757.5	560 296.4	
J03	7 386 678.9	560 291.5	
J04	7 386 603.1	560 340.7	
J05	7 386 629.8	560 392.0	
J06	7 386 470.5	560 448.6	
J07	7 386 462.6	560 401.8	

SURVEY CONTROL MONUMENTS			
NO.	UTM COORDINATES		DESCRIPTION
	NORTHING	EASTING	
BM-2	7 386 436.131	560 584.268	56.421 PERMANENT BENCHMARK

Headquarters
Quartier général

General Notes:


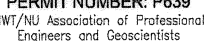
1. ALL COORDINATES ARE REFERENCED TO UTM ZONE 20N, NAD83. ELEVATIONS ARE REFERENCED TO MEAN SEA LEVEL RELATIVE TO GEOID MODEL CANADIAN HT2_0.
2. ALL DIMENSIONS ARE IN METRES UNLESS NOTED OTHERWISE.
3. ALL NON-HAZARDOUS DEBRIS WITHIN PLAN AREA TO BE PLACED IN LOWER SITE NON-HAZARDOUS WASTE LANDFILL.
4. REFER TO TABLE 02219-1 IN SPECIFICATIONS FOR DESCRIPTION OF DEBRIS AREAS.
5. FOR ENTIRE DEBRIS AREA LIMITS, SEE DWG. H-C75/3-9101-102.
6. ACCESS RESTRICTED TO FOOT TRAFFIC ONLY UNLESS AUTHORIZED BY THE ENGINEER.

Legend:

- ▲ BM-2 PERMANENT BENCHMARK LOCATION (1)
- ⊕ COORDINATE POINT
- ⊕ TEST PIT LOCATION
- BODY OF WATER
- D DITCH

No.	DATE	REVISION	REVISION	APPR.
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SCALE - ECHELLE 20 10 0 20 40 60m

PROJECT - PROJET
DYE-M CAPE DYER

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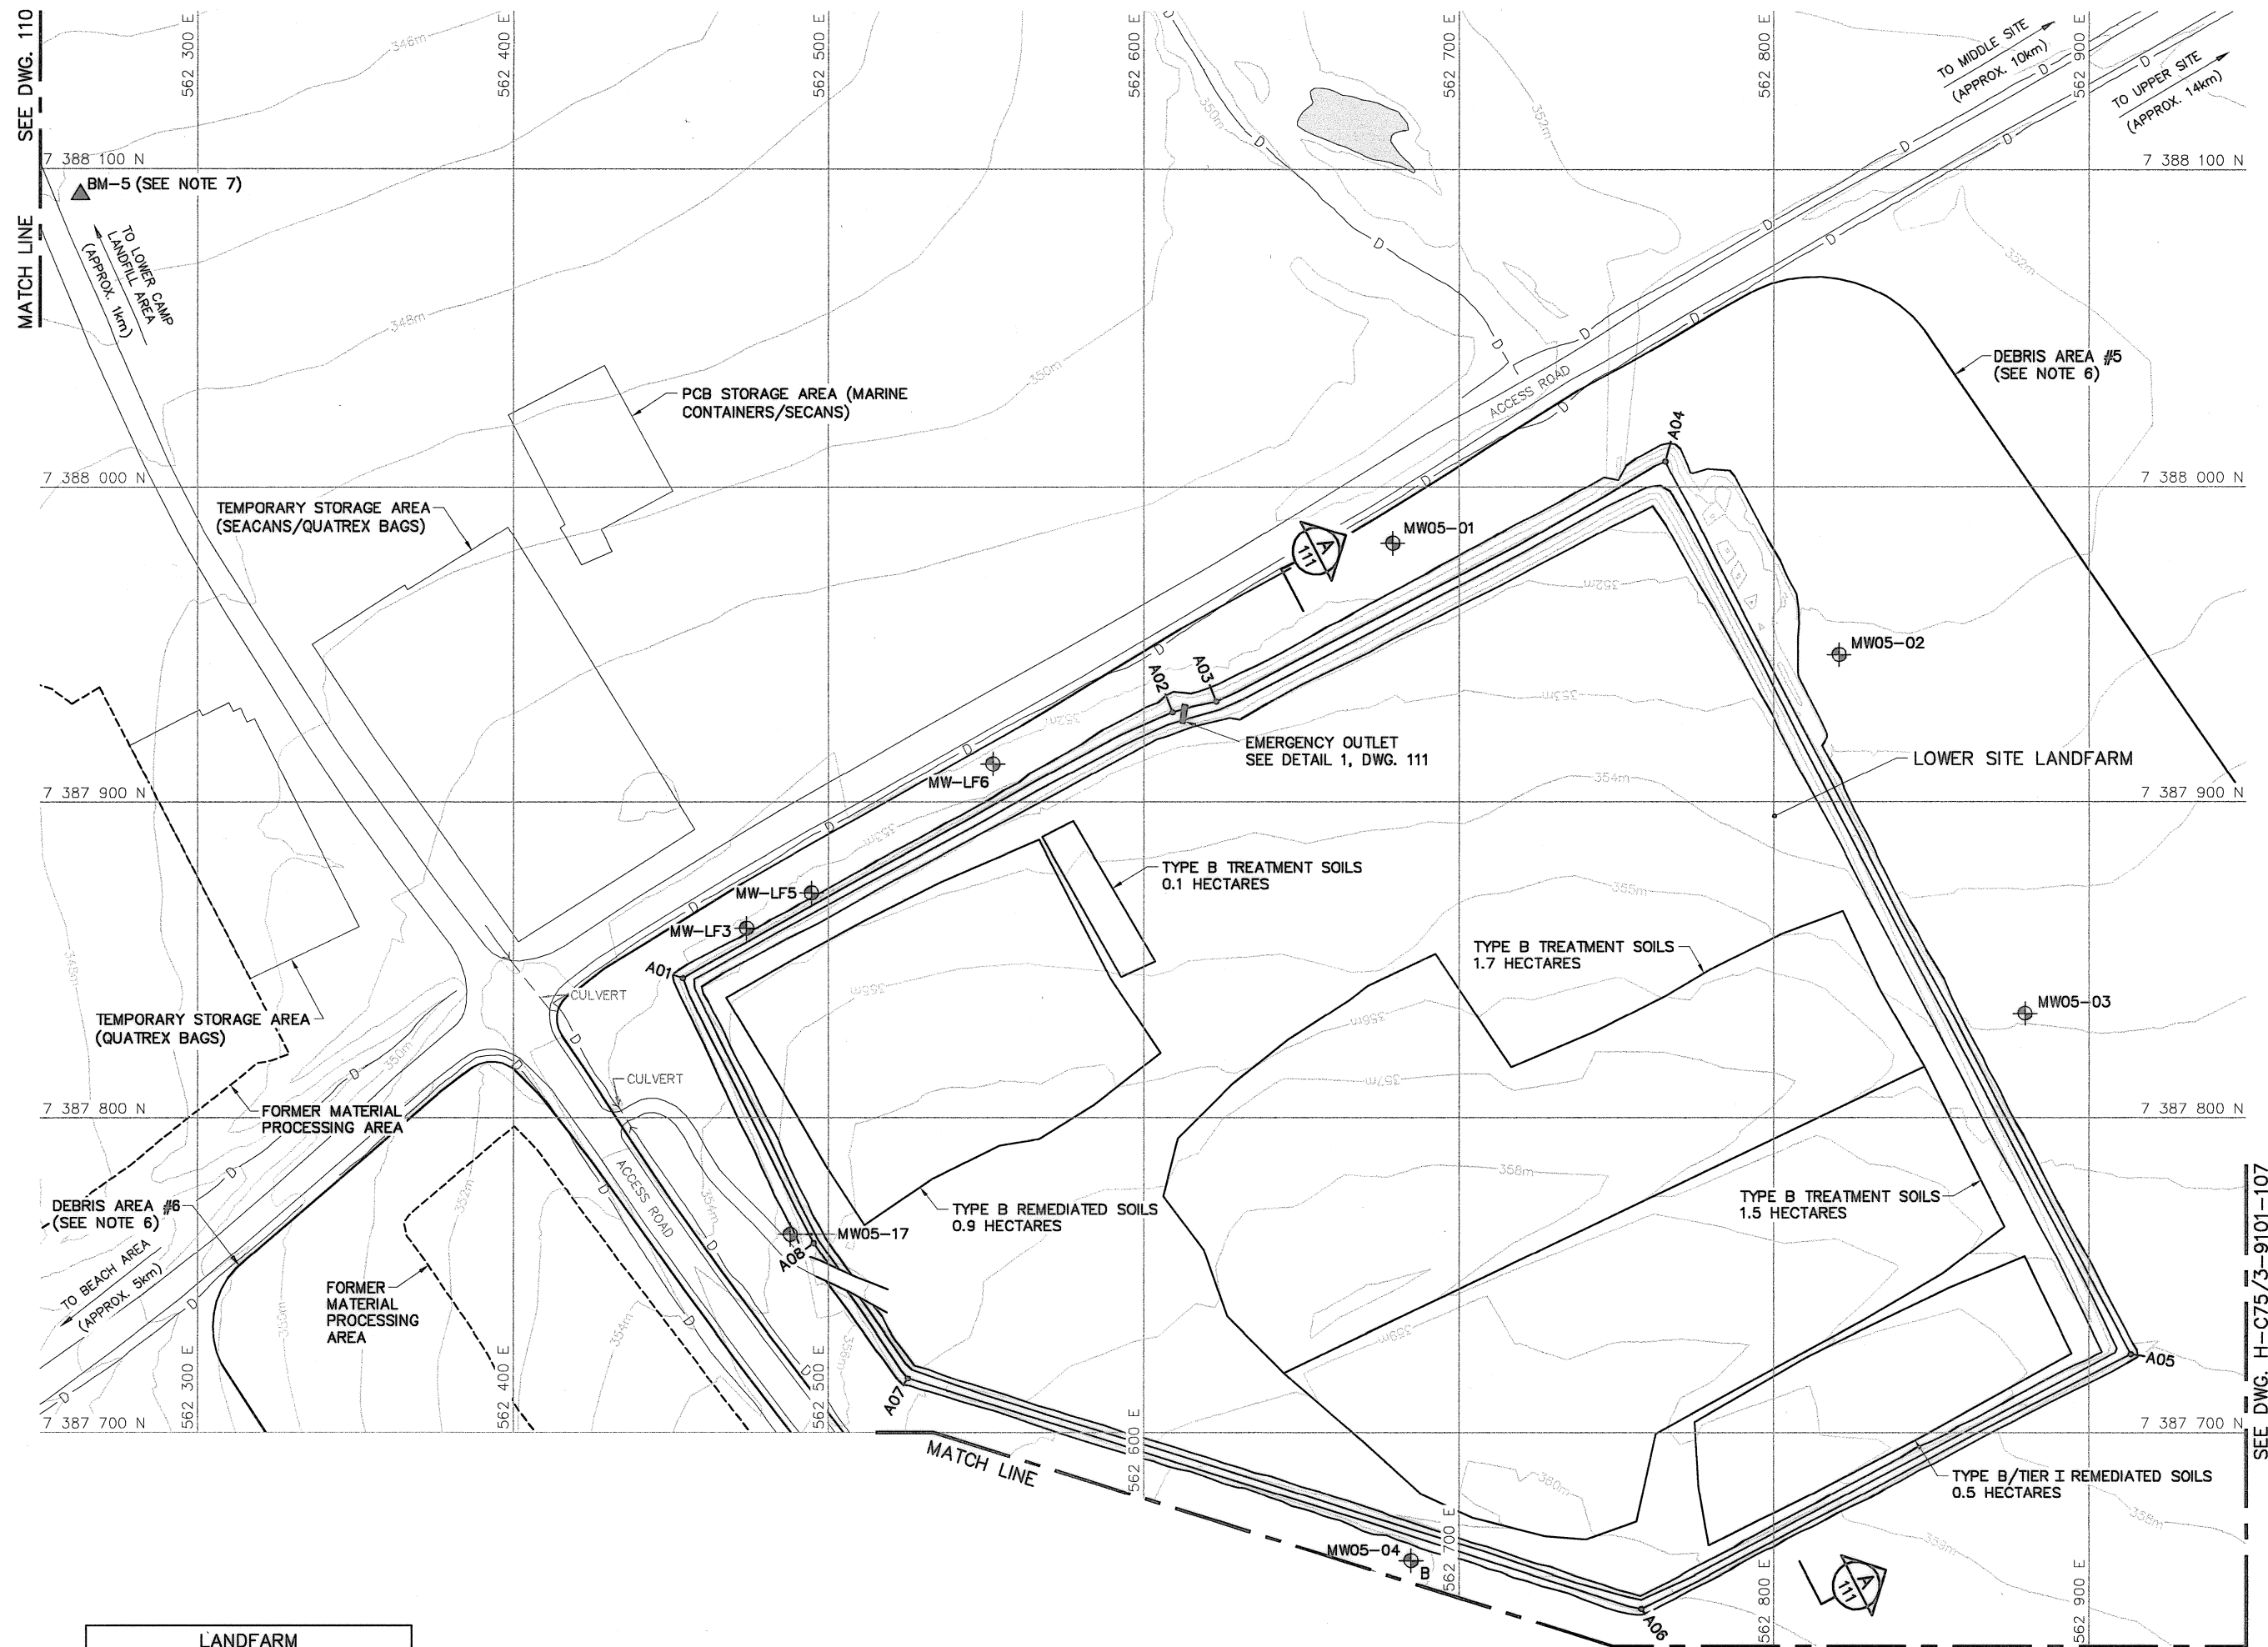
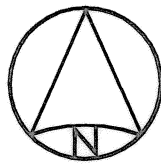
TRADE - METIER SITING DATE 2010-12-07

SUBJECT - SUJET
LOWER SITE
BEACH LANDFILL-SOUTH AREA
PLAN

PRODUCTION		CONCURRENCE - ASSENTMENT	
DESIGNED ETUDIE	DTM/TME	DES OFF AGENT CONCEPT	
DRAWN DESSINE	IC/CAE	SECT HD CHEF SECT	
CHECKED VERIFIE	DWF	DES MGR GEST CONCEPT	
COORDINATION RRM		REVIEWED - REVU	

DWG. NO. - DESSIN NO.
H-C75/3-9101-105

Canada



LANDFARM BERM (EXISTING)		
NO.	UTM COORDINATES	
	NORTHING	EASTING
A01	7 387 844.5	562 453.8
A02	7 387 928.5	562 609.1
A03	7 387 931.9	562 623.1
A04	7 388 008.1	562 765.6
A05	7 387 724.9	562 913.4
A06	7 387 644.4	562 757.9
A07	7 387 717.2	562 525.2
A08	7 387 760.1	562 495.3

General Notes:

1. ALL COORDINATES ARE REFERENCED TO UTM ZONE 20N, NAD83. ELEVATIONS ARE REFERENCED TO MEAN SEA LEVEL RELATIVE TO GEOID MODEL CANADIAN HT2_0.
2. ALL DIMENSIONS ARE IN METRES UNLESS NOTED OTHERWISE.
3. ALL NON-HAZARDOUS DEBRIS WITHIN PLAN AREA TO BE PLACED IN LOWER SITE NON-HAZARDOUS WASTE LANDFILL.
4. REFER TO TABLE 02219-1 IN SPECIFICATIONS FOR DESCRIPTION OF DEBRIS AREAS.
5. ALL SURFACE DEBRIS IS TO BE REMOVED FROM ALL CONTAMINATED SOIL AREAS AND EXISTING LANDFILL AREAS PRIOR TO ANY FILL PLACEMENT OR EXCAVATION TAKING PLACE.
6. FOR ENTIRE DEBRIS AREA LIMITS, SEE DWG. H-C75/3-9101-103.
7. BM-5 TO BE TIED INTO SITE SURVEY COORDINATE SYSTEM.

Legend:

- ▲ BM-5 PERMANENT BENCHMARK LOCATION (1)
- A01 COORDINATE POINT
- ⊕ MONITORING WELL LOCATION (7)
- ⊕ B BACKGROUND MONITORING WELL LOCATION (1)
- BODY OF WATER
- D DITCH

No.	DATE	REVISION	REVISION	APPR.
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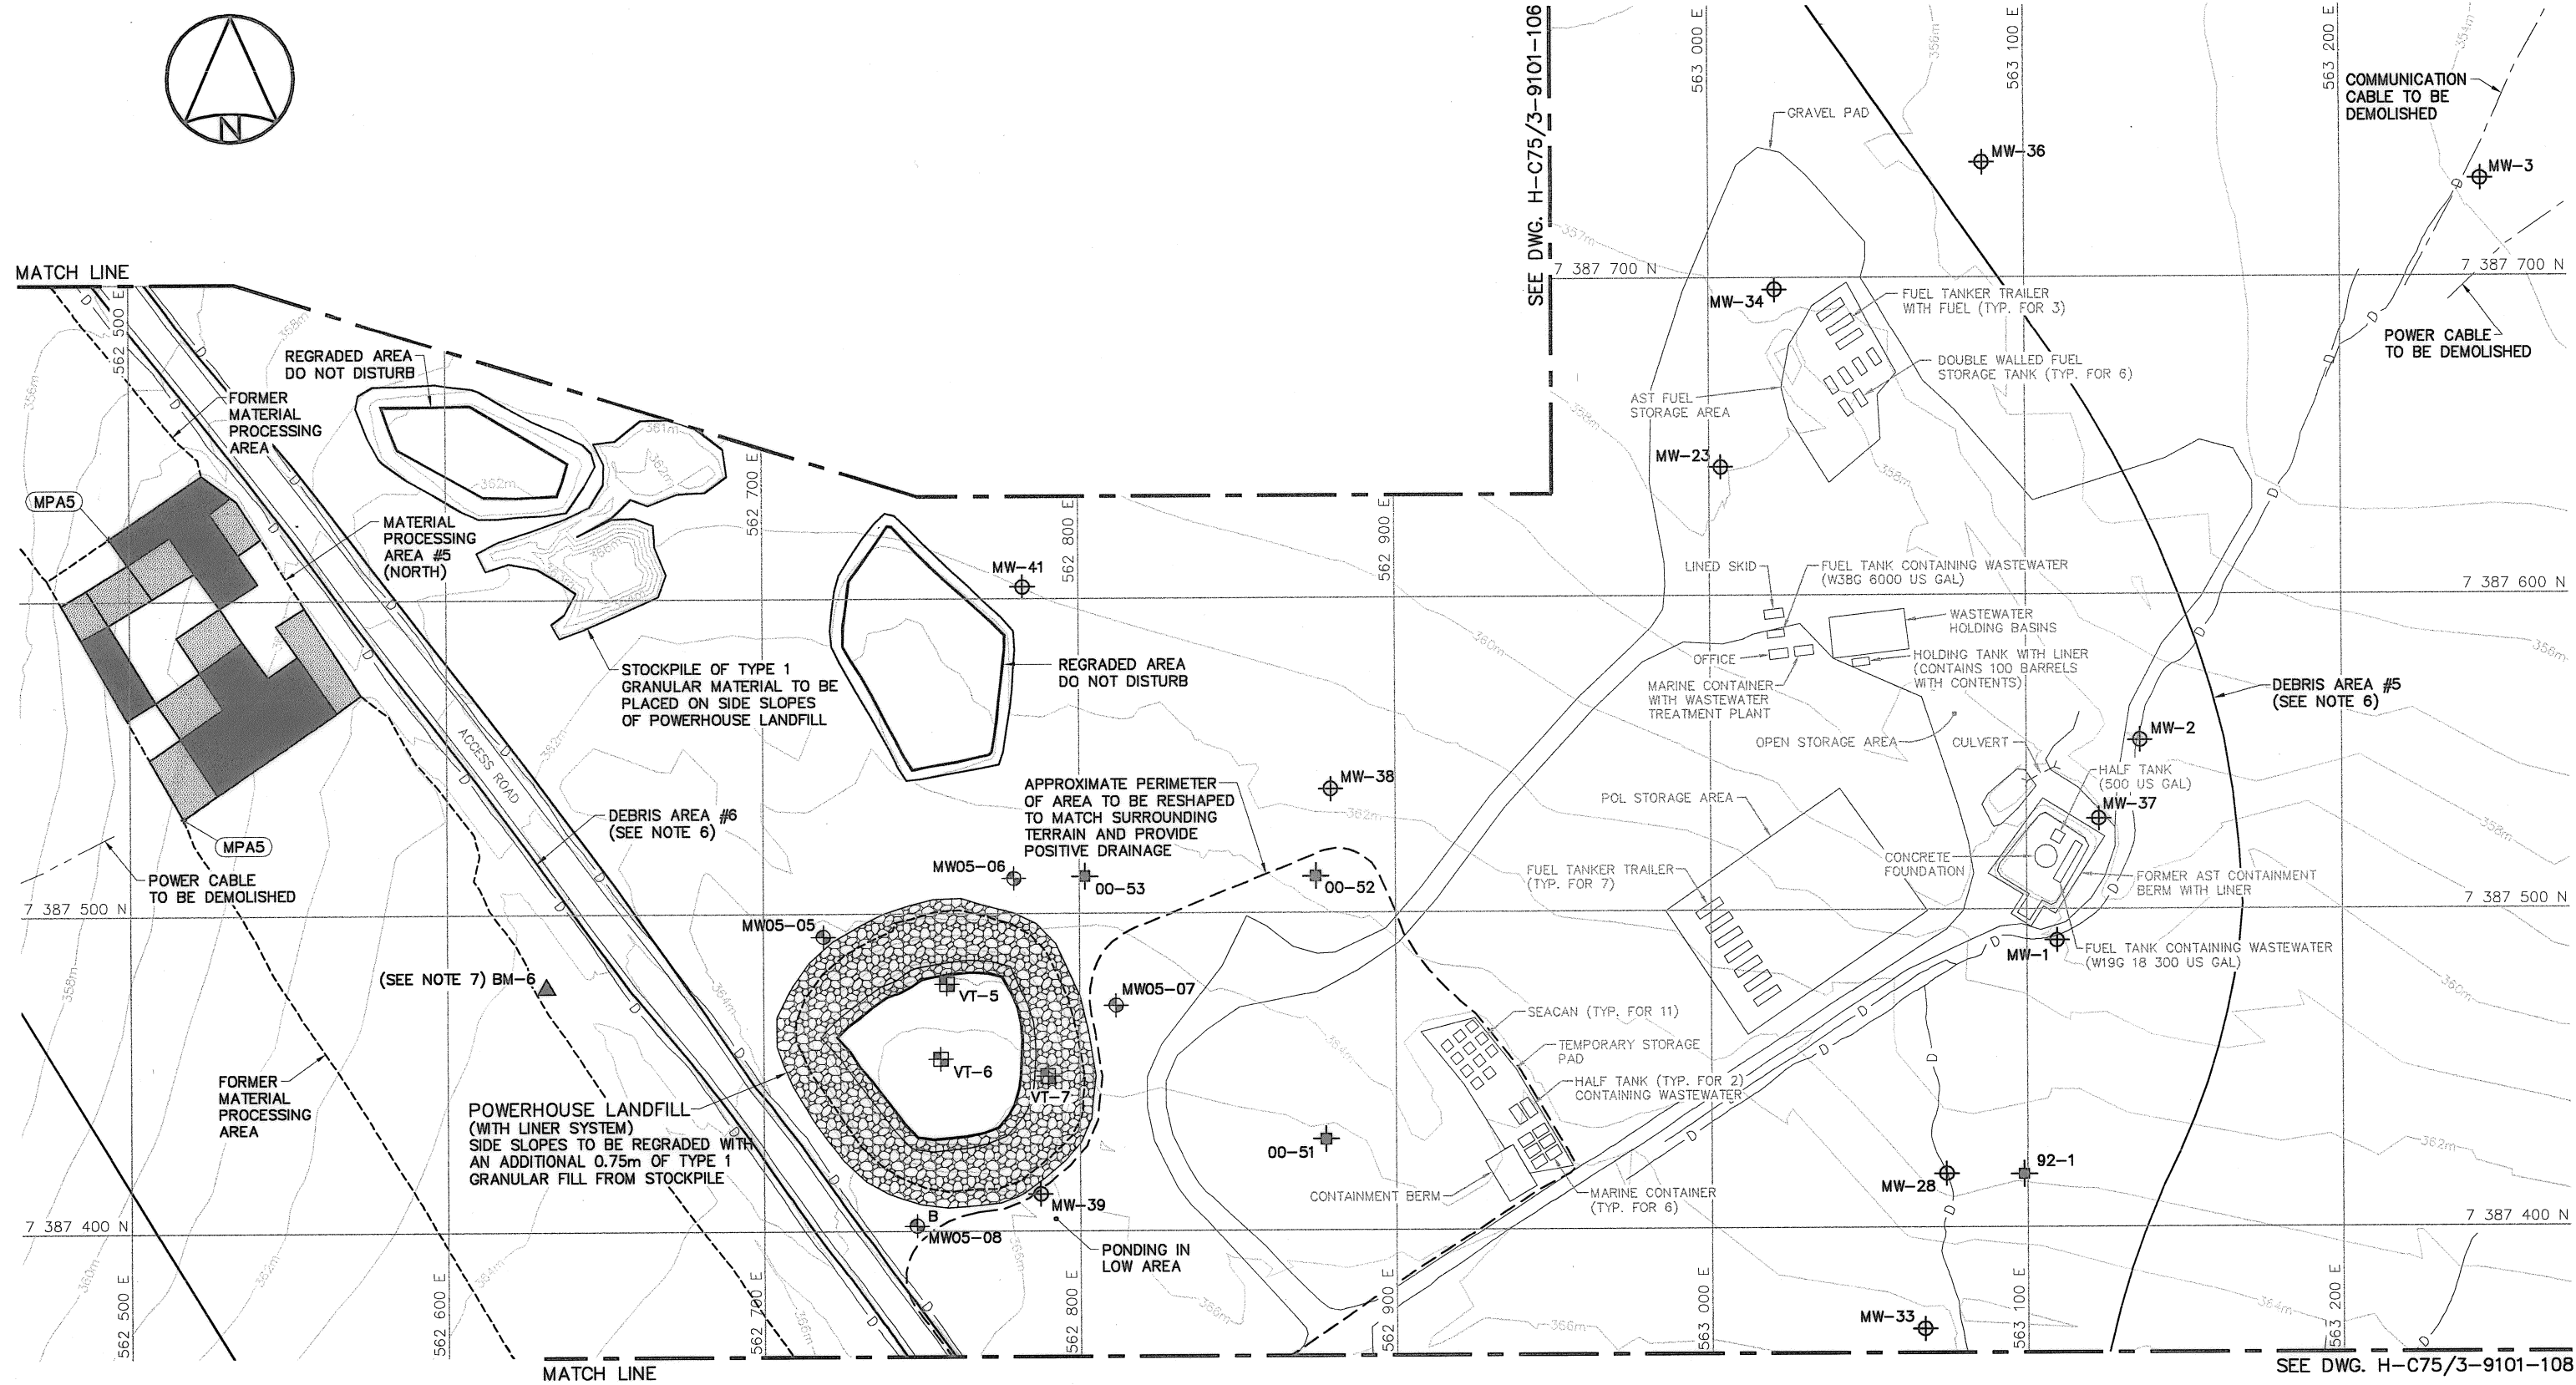
TRADE - METIER SITING DATE 2010-12-07

SUBJECT - SUJET
LOWER SITE
LANDFARM AREA
PLAN

PRODUCTION		CONCURRENCE - ASSENTIMENT	
DESIGNED ETUDIE	DTH/THE	DES OFF AGENT CONCEPT	
DRAWN DESSINE	IC/CAE	SECT HD CHEF SECT	
CHECKED VERIFIE	DIUF	DES MGR GEST CONCEPT	
COORDINATION RRM		REVIEWED - REVU	

DWG. NO. - DESSIN NO.
H-C75/3-9101-106

Canada



CONTAMINATED SOIL TO BE EXCAVATED				
AREA NO.	APPROX. AREA (m ²)	ESTIMATED IN PLACE VOLUME (m ³)	REFERENCE POINT	
			NORTHING	EASTING
DCC TIER I				
MPA5	1747	350	7 387 530.8	562 516.8
DCC TIER II				
MPA5	2303	981	7 387 620.1	562 493.5

NOTE:
DETAILS OF CONTAMINATED SOIL AREAS,
INCLUDING COORDINATE POINTS, WILL BE
PROVIDED PRIOR TO CONSTRUCTION.

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Headquarters
Quartier général

General Notes:

- ALL COORDINATES ARE REFERENCED TO UTM ZONE 20N, NAD83. ELEVATIONS ARE REFERENCED TO MEAN SEA LEVEL RELATIVE TO GEOID MODEL CANADIAN HT2_0.
- ALL DIMENSIONS ARE IN METRES UNLESS NOTED OTHERWISE.
- ALL NON-HAZARDOUS DEBRIS WITHIN PLAN AREA TO BE PLACED IN LOWER SITE NON-HAZARDOUS WASTE LANDFILL.
- REFER TO TABLE 02219-1 IN SPECIFICATIONS FOR DESCRIPTION OF DEBRIS AREAS.
- ALL SURFACE DEBRIS IS TO BE REMOVED FROM ALL CONTAMINATED SOIL AREAS AND EXISTING LANDFILL AREAS PRIOR TO ANY FILL PLACEMENT OR EXCAVATION TAKING PLACE.
- FOR ENTIRE DEBRIS AREA LIMITS, SEE DWG. H-C75/3-9101-103.
- BM-6 TO BE TIED INTO SITE SURVEY COORDINATE SYSTEM.

Legend:

▲ BM-6

PERMANENT BENCHMARK LOCATION (1)

■

DCC TIER I CONTAMINATED SOIL

■

DCC TIER II CONTAMINATED SOIL

+

TEST PIT LOCATION

⊕

SITE INVESTIGATION MONITORING WELL LOCATION

⊕

MONITORING WELL LOCATION (3)

⊕_B

BACKGROUND MONITORING WELL LOCATION (1)

⊕_T

VERTICAL GROUND TEMPERATURE CABLE LOCATION (3)

— D

DITCH

No.	DATE	REVISION	REVISION	APPR.

PROFESSIONAL ENGINEER

Geotechnical Engineering

Dec 16/10

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PROJECT - PROJET DYE-M CAPE DYER

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TRADE - MÉTIER SITING

DATE 2010-12-07

SUBJECT - SUJET











LOWER SITE
STATION AREA-NORTH
PLAN

PRODUCTION	CONCURRENCE - ASSENTIMENT
DESIGNED ETUDIE DTR/THE	DES OFF AGENT CONCEPT
DRAWN DESSINE IC/CAE	SECT HD CHEF SECT
CHECKED VERIFIÉ DWF	DES MGR GEST CONCEPT
COORDINATION RHM	REVIEWED - REVU



DWG. NO. - DESSIN NO.
H-C75/3-9101-107

Canada

1. ALL COORDINATES ARE REFERENCED TO UTM ZONE 20N, NAD83. ELEVATIONS ARE REFERENCED TO MEAN SEA LEVEL RELATIVE TO GEOID MODEL CANADIAN HT2_0.
2. ALL DIMENSIONS ARE IN METRES UNLESS NOTED OTHERWISE.
3. ALL NON-HAZARDOUS DEBRIS WITHIN PLAN AREA TO BE PLACED IN LOWER SITE NON-HAZARDOUS WASTE LANDFILL.
4. REFER TO TABLE 02219-1 IN SPECIFICATIONS FOR DESCRIPTION OF DEBRIS AREAS.
5. ALL SURFACE DEBRIS IS TO BE REMOVED FROM ALL CONTAMINATED SOIL AREAS AND EXISTING LANDFILL AREAS PRIOR TO ANY FILL PLACEMENT OR EXCAVATION TAKING PLACE.
6. FOR ENTIRE DEBRIS AREA LIMITS, SEE DWG. H-C75/3-9101-103.

	SURVEY CONTROL MONUMENT
	DCC TIER I CONTAMINATED SOIL
	DCC TIER II CONTAMINATED SOIL
	HYDROCARBON - TYPE B CONTAMINATED SOIL
	COORDINATE POINT
	TEST PIT LOCATION
	SITE INVESTIGATION MONITORING WELL LOCATION
	MONITORING WELL LOCATION (4)
	BACKGROUND MONITORING WELL LOCATION (1)
	DITCH



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Date: 
PERMIT NUMBER: P639
NWT/NU Association of Professional
Engineers and Geoscientists

SCALE - ECHELLE 20 10 0 20 40 60m

PROJECT - PROJECT
DYE-M CAPE DYER

DEW LINE CLEAN UP

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TRADE - METIER	SITING	DATE 2010-12-07
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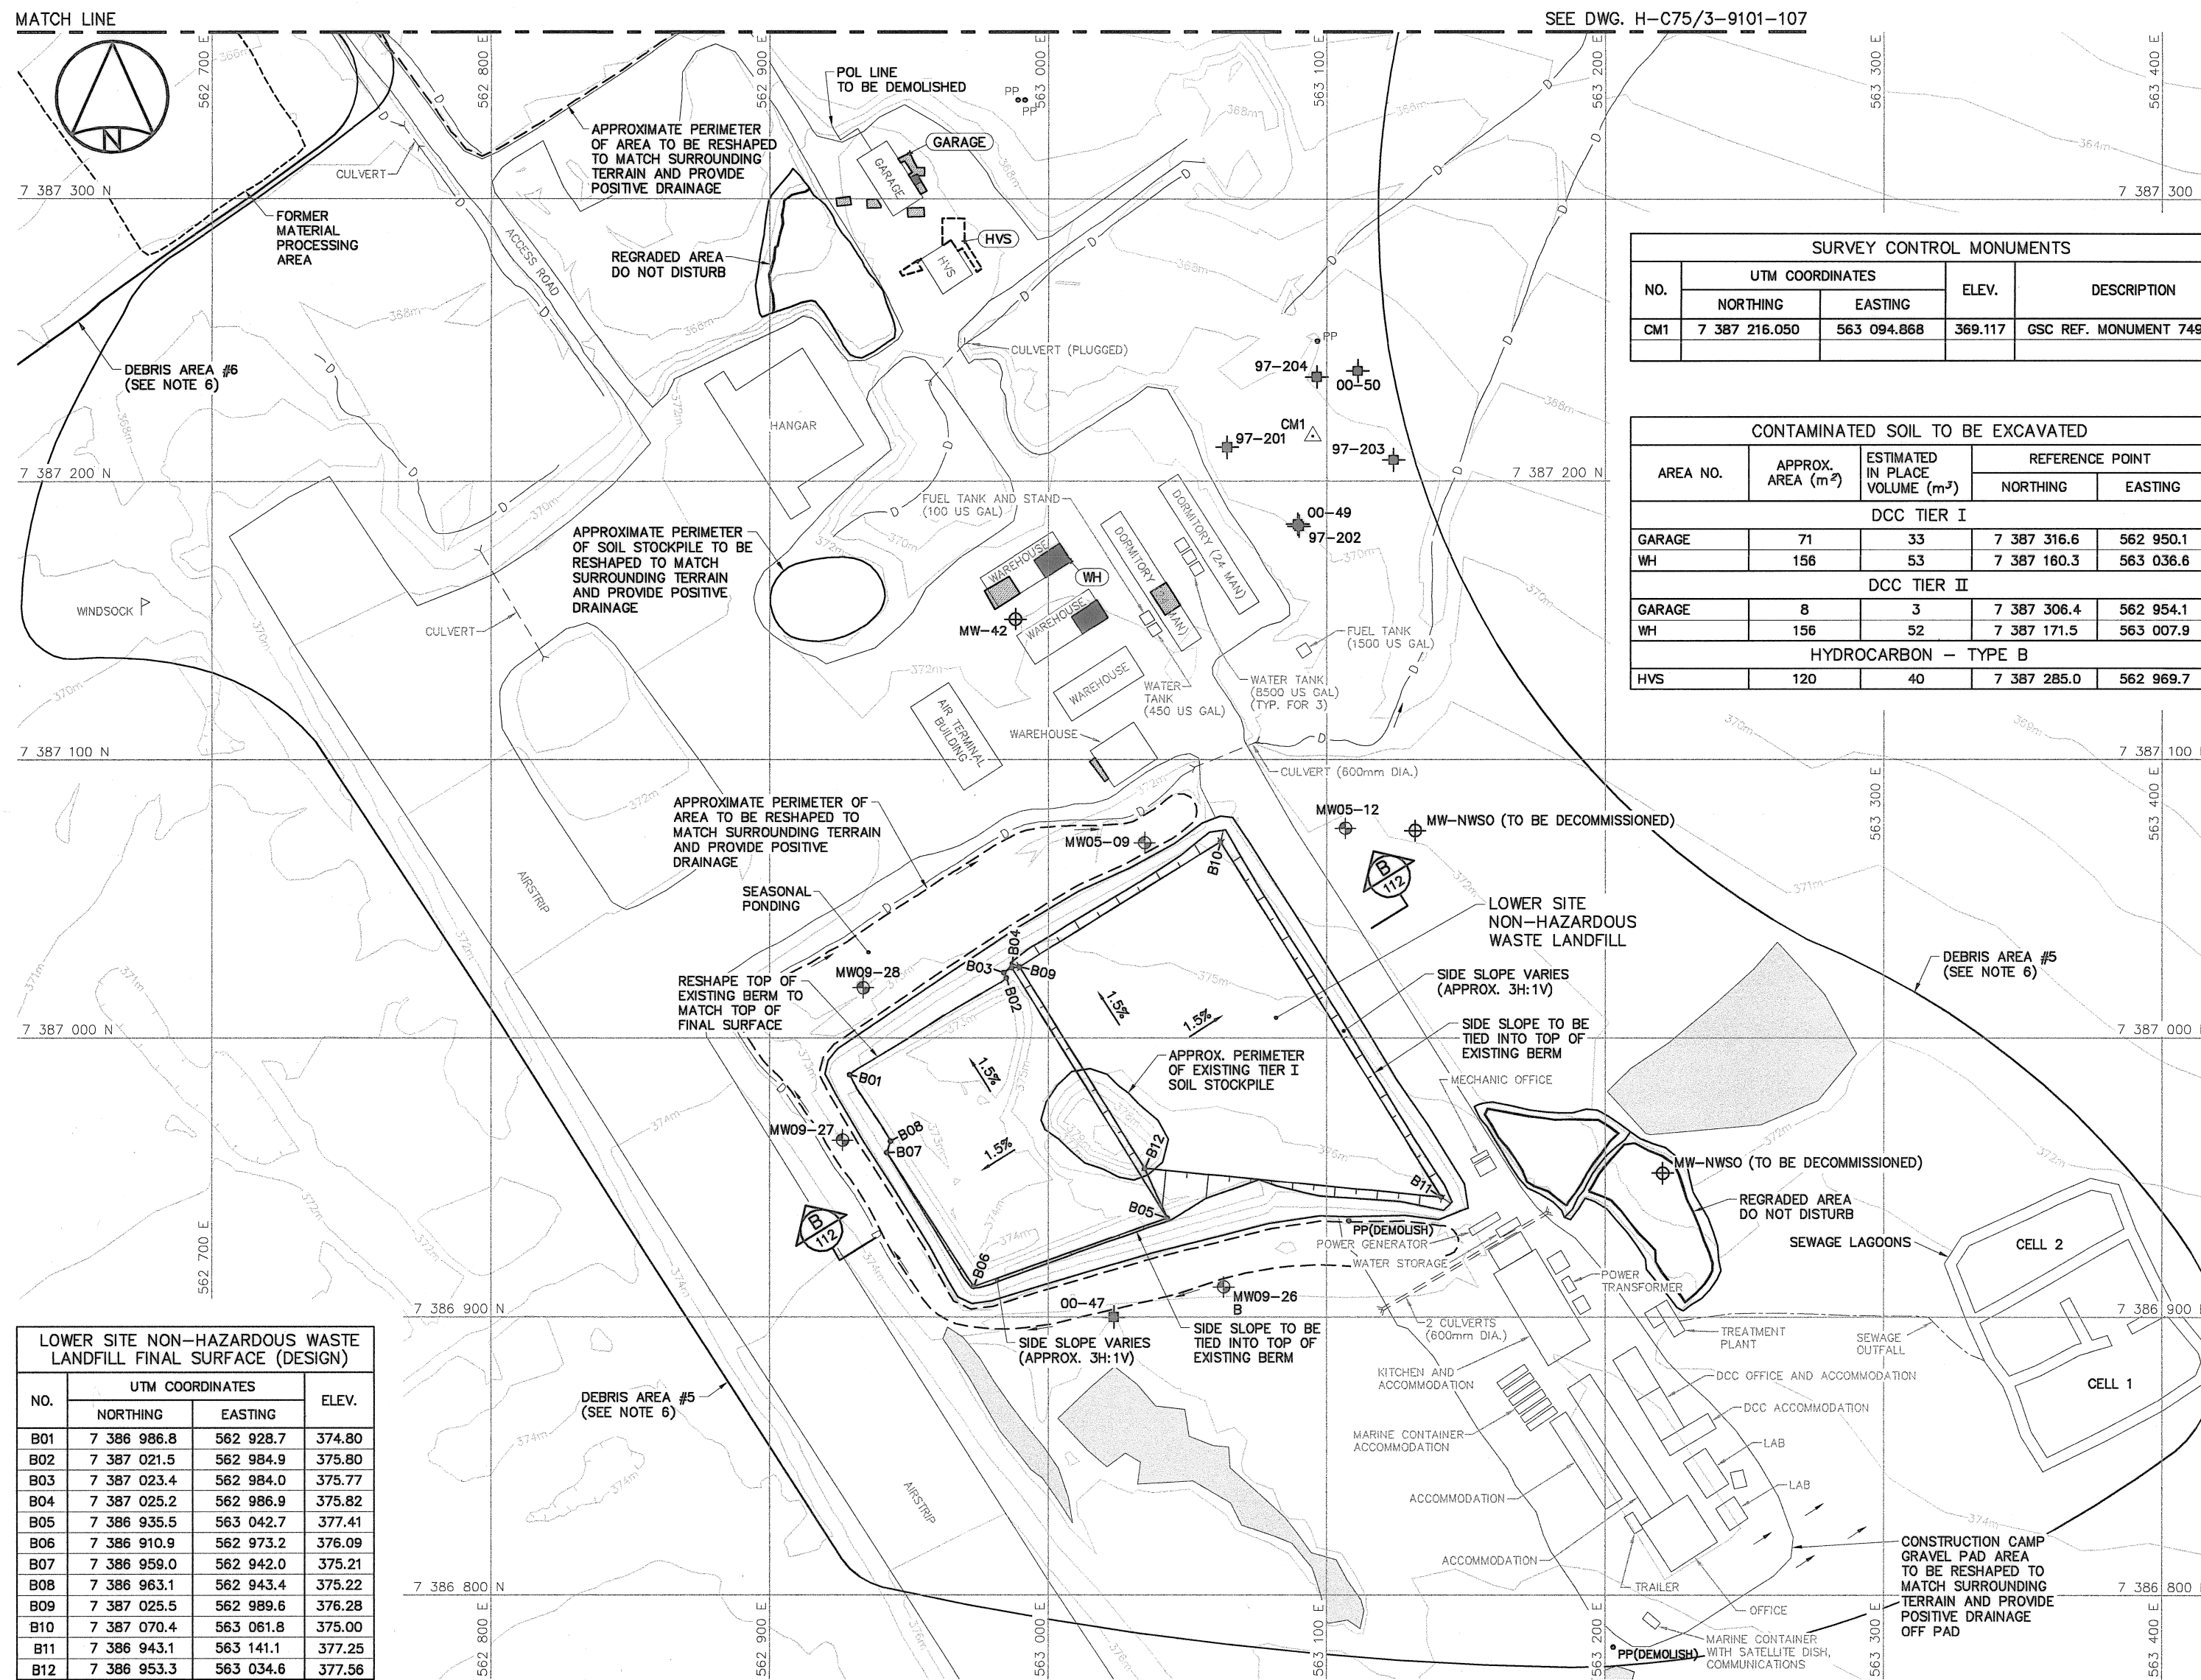
SUBJECT - SUJET

LOWER SITE
STATION AREA
PLAN


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DESIGNED ETUDIE <i>DTM/ THE</i>		DES OFF AGENT CONCEPT
DRAWN DESSINE <i>IC/ CAE</i>		SECT HD CHEF SECT
CHECKED VERIFIE <i>DIUF</i>		DES MGR GEST CONCEPT
COORDINATION	REVIEWED - REVU	


DWG. NO. — DESSIN NO.
H-C75/3-9101-108

Canadă




NOTE:
DETAILS OF CONTAMINATED SOIL AREAS,
INCLUDING COORDINATE POINTS, WILL BE
PROVIDED PRIOR TO CONSTRUCTION.

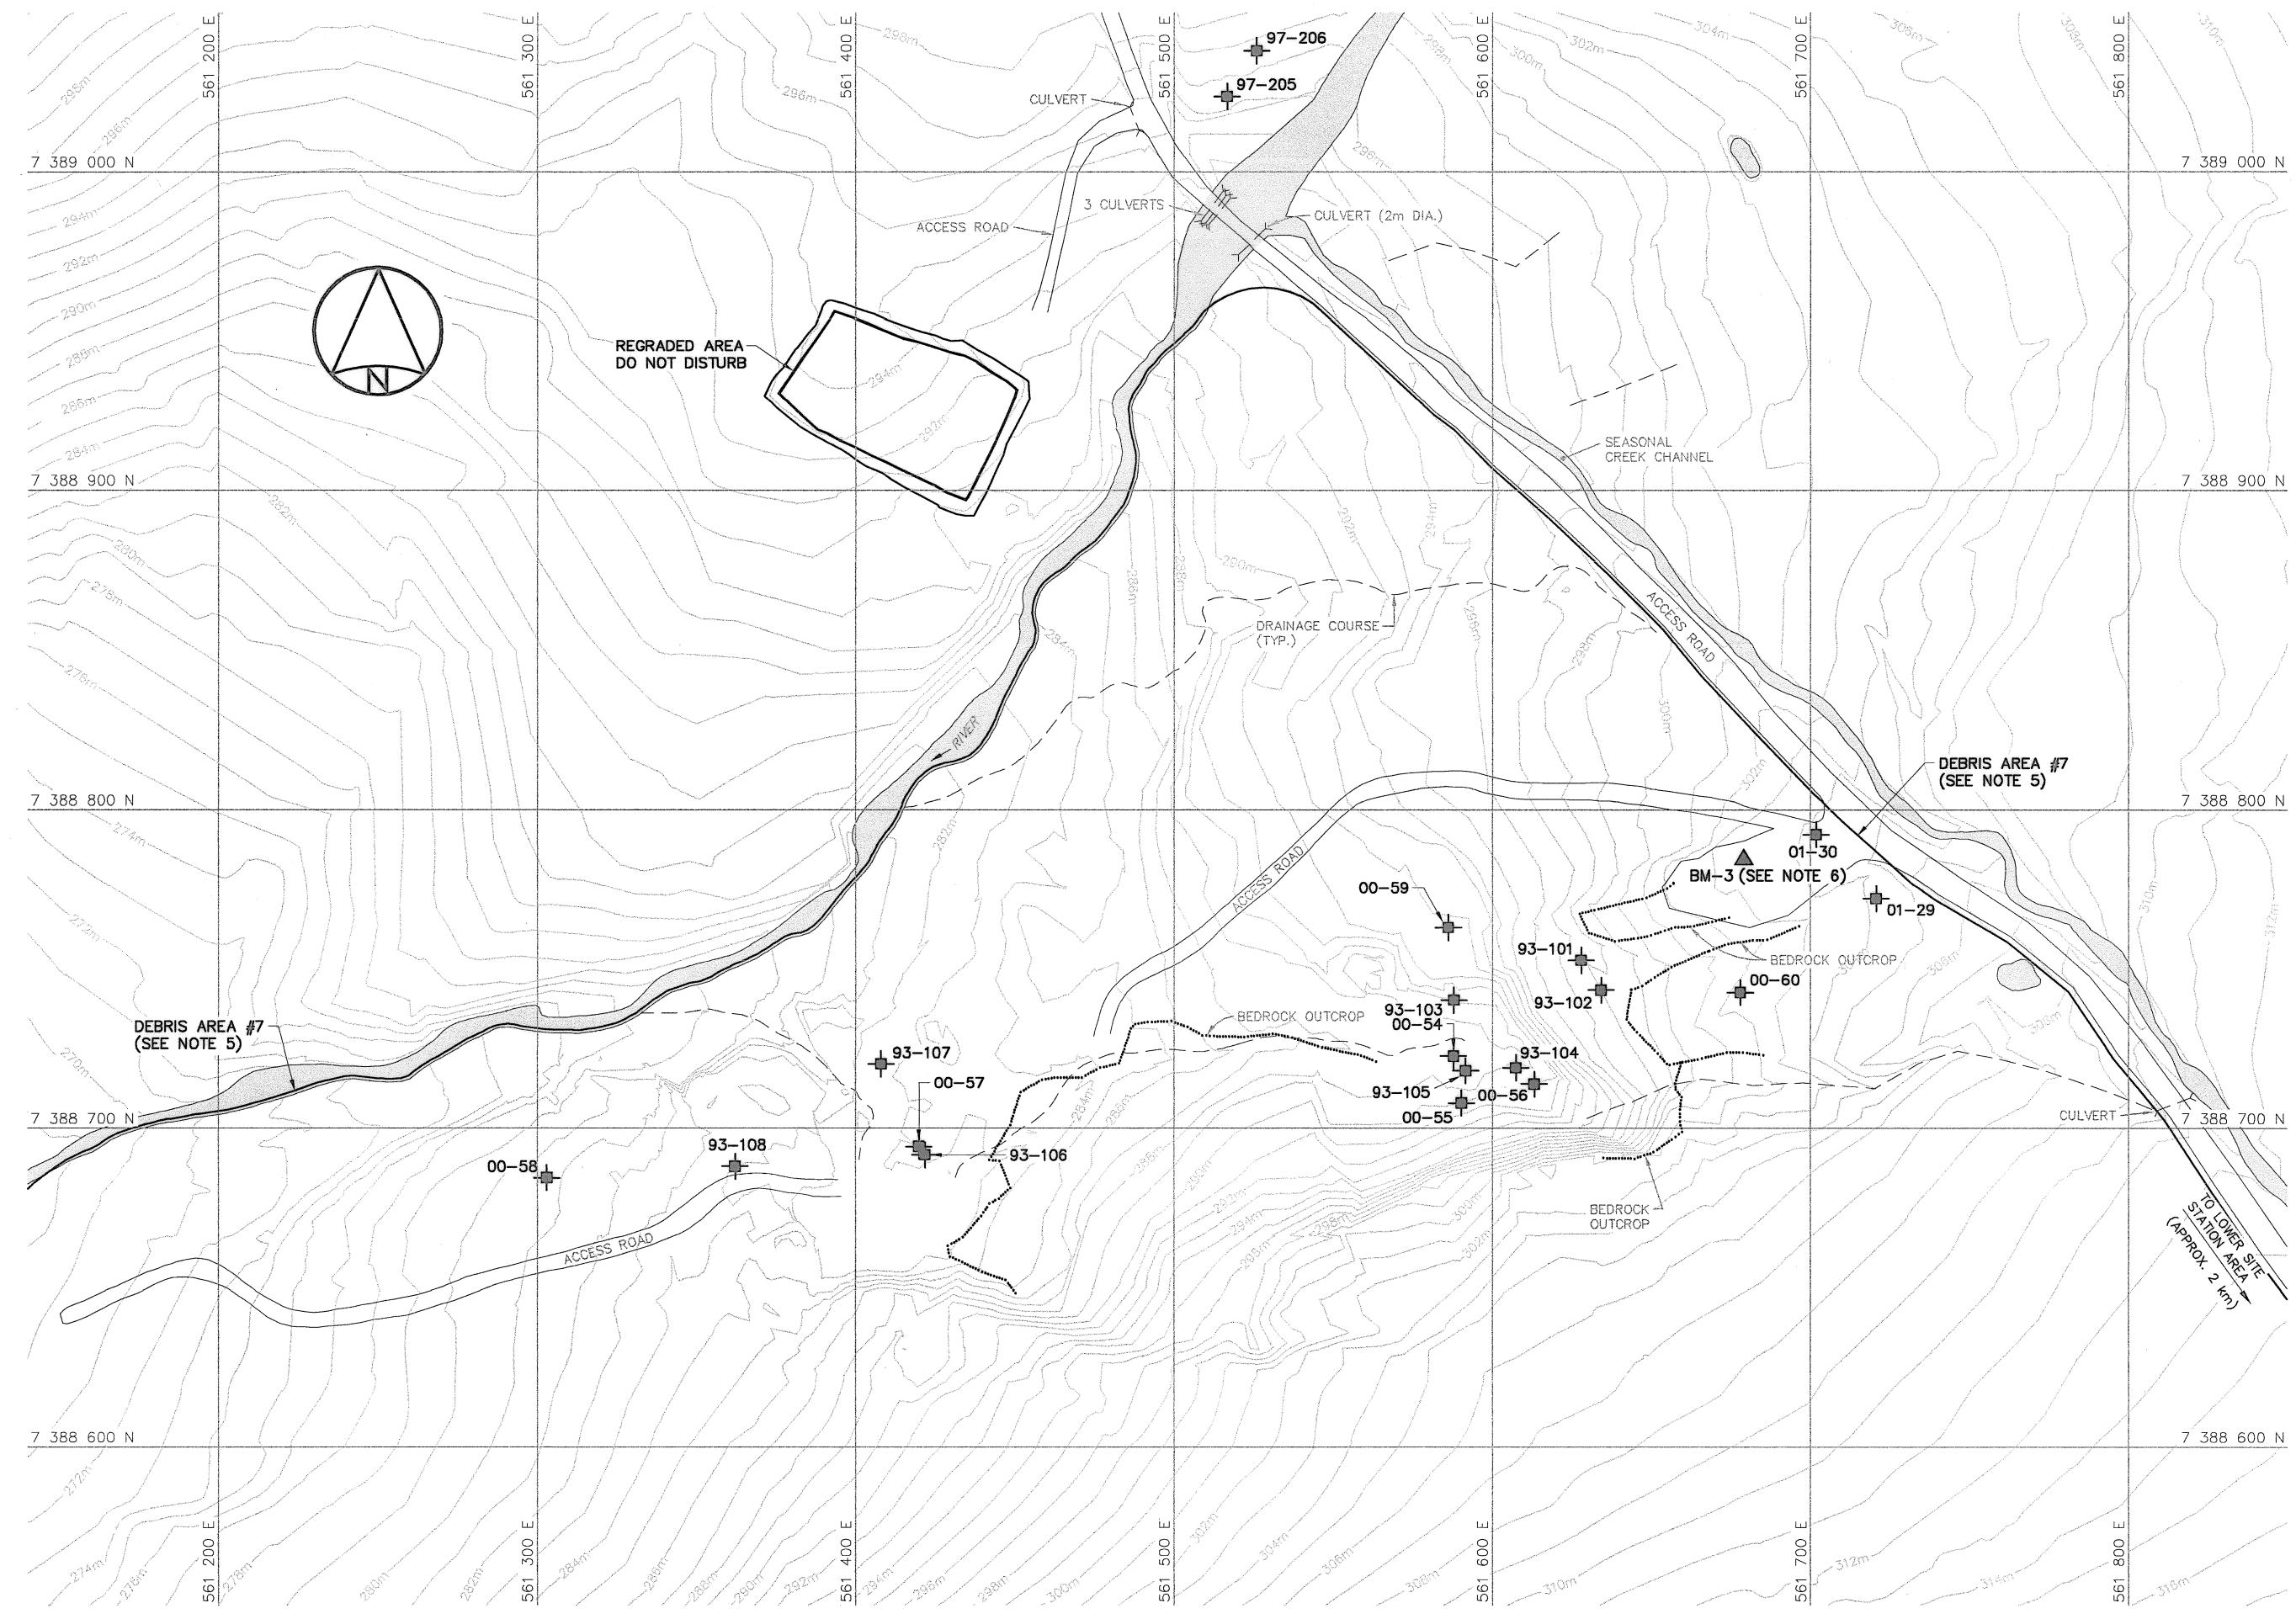

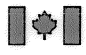

National
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
Défense
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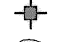
General Notes:

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2. ALL DIMENSIONS ARE IN METRES UNLESS NOTED OTHERWISE.
3. ALL NON-HAZARDOUS DEBRIS WITHIN PLAN AREA TO BE PLACED IN LOWER SITE NON-HAZARDOUS WASTE LANDFILL.
4. REFER TO TABLE 02219-1 IN SPECIFICATIONS FOR DESCRIPTION OF DEBRIS AREAS.
5. FOR ENTIRE DEBRIS AREA LIMITS, SEE DWG. H-C75/3-9101-103.
6. BM-3 TO BE TIED INTO SITE SURVEY COORDINATE SYSTEM.


Legend:



BM-3



TEST PIT LOCATION




BODY OF WATER

PERMANENT BENCHMARK
LOCATION (1)

TEST PIT LOCATION


BODY OF WATER


No.	DATE	REVISION	REVISION	APPR.



PROFESSIONAL
ENGINEER
NWT/NU

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Date: 

PERMIT NUMBER: P639
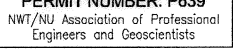
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SCALE - ÉCHELLE 20 10 0 20 40 60m

PROJECT - PROJET
DYE-M CAPE DYER

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SITING

DATE
2010-12-07

SUBJECT - SUJET
LOWER SITE
LOWER CAMP LANDFILL AREA
PLAN

PRODUCTION	CONCURRENCE - ASSENTIMENT
DESIGNED ETUDIE <i>DTM/THE</i>	DES OFF AGENT CONCEPT
DRAWN DESSINE <i>IC/CNE</i>	SECT HD CHEF SECT
CHECKED VÉRIFIÉ <i>DWF</i>	DES MGR GEST CONCEPT
COORDINATION <i>RRM</i>	REVIEWED - REVU

DWG. NO. - DESSIN NO.
H-C75/3-9101-109

Canada


General Notes:

1. ALL COORDINATES ARE REFERENCED TO UTM ZONE 20N, NAD83. ELEVATIONS ARE REFERENCED TO MEAN SEA LEVEL RELATIVE TO GEOID MODEL CANADIAN HTZ_0.
2. ALL DIMENSIONS ARE IN METRES UNLESS NOTED OTHERWISE.
3. ALL NON-HAZARDOUS DEBRIS WITHIN PLAN AREA TO BE PLACED IN LOWER SITE NON-HAZARDOUS WASTE LANDFILL.
4. REFER TO TABLE 02219-1 IN SPECIFICATIONS FOR DESCRIPTION OF DEBRIS AREAS.
5. ALL SURFACE DEBRIS IS TO BE REMOVED FROM ALL CONTAMINATED SOIL AREAS AND EXISTING LANDFILL AREAS PRIOR TO ANY FILL PLACEMENT OR EXCAVATION TAKING PLACE.
6. FOR MONITORING WELL INSTALLATION DETAILS, SEE DWG. H-C75/3-9101-191.
7. FOR VERTICAL GROUND TEMPERATURE CABLE INSTALLATION DETAILS, SEE DWG. H-C75/3-9101-190. EXACT LOCATIONS TO BE FIELD DETERMINED BY THE ENGINEER.
8. FOR ENTIRE DEBRIS AREA LIMITS, SEE DWG. H-C75/3-9101-103.
9. BM-4 TO BE TIED INTO SITE SURVEY COORDINATE SYSTEM.

Legend:

- ▲ BM-4 PERMANENT BENCHMARK LOCATION (1)
- COORDINATE POINT
- ⊕ TEST PIT LOCATION
- ⊕ MONITORING WELL LOCATION (3)
- ⊕ BACKGROUND MONITORING WELL LOCATION (1)
- ⊕ VERTICAL GROUND TEMPERATURE CABLE LOCATION (5)
- BODY OF WATER

No.	DATE	REVISION	REVISION	APPR.
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Date: *[Date]*

PERMIT NUMBER: P639

NWT/NJ Association of Professional Engineers and Geoscientists

AECOM HATCH

SCALE - ECHELLE 20 10 0 20 40 60m

PROJECT - PROJET
DYE-M CAPE DYER

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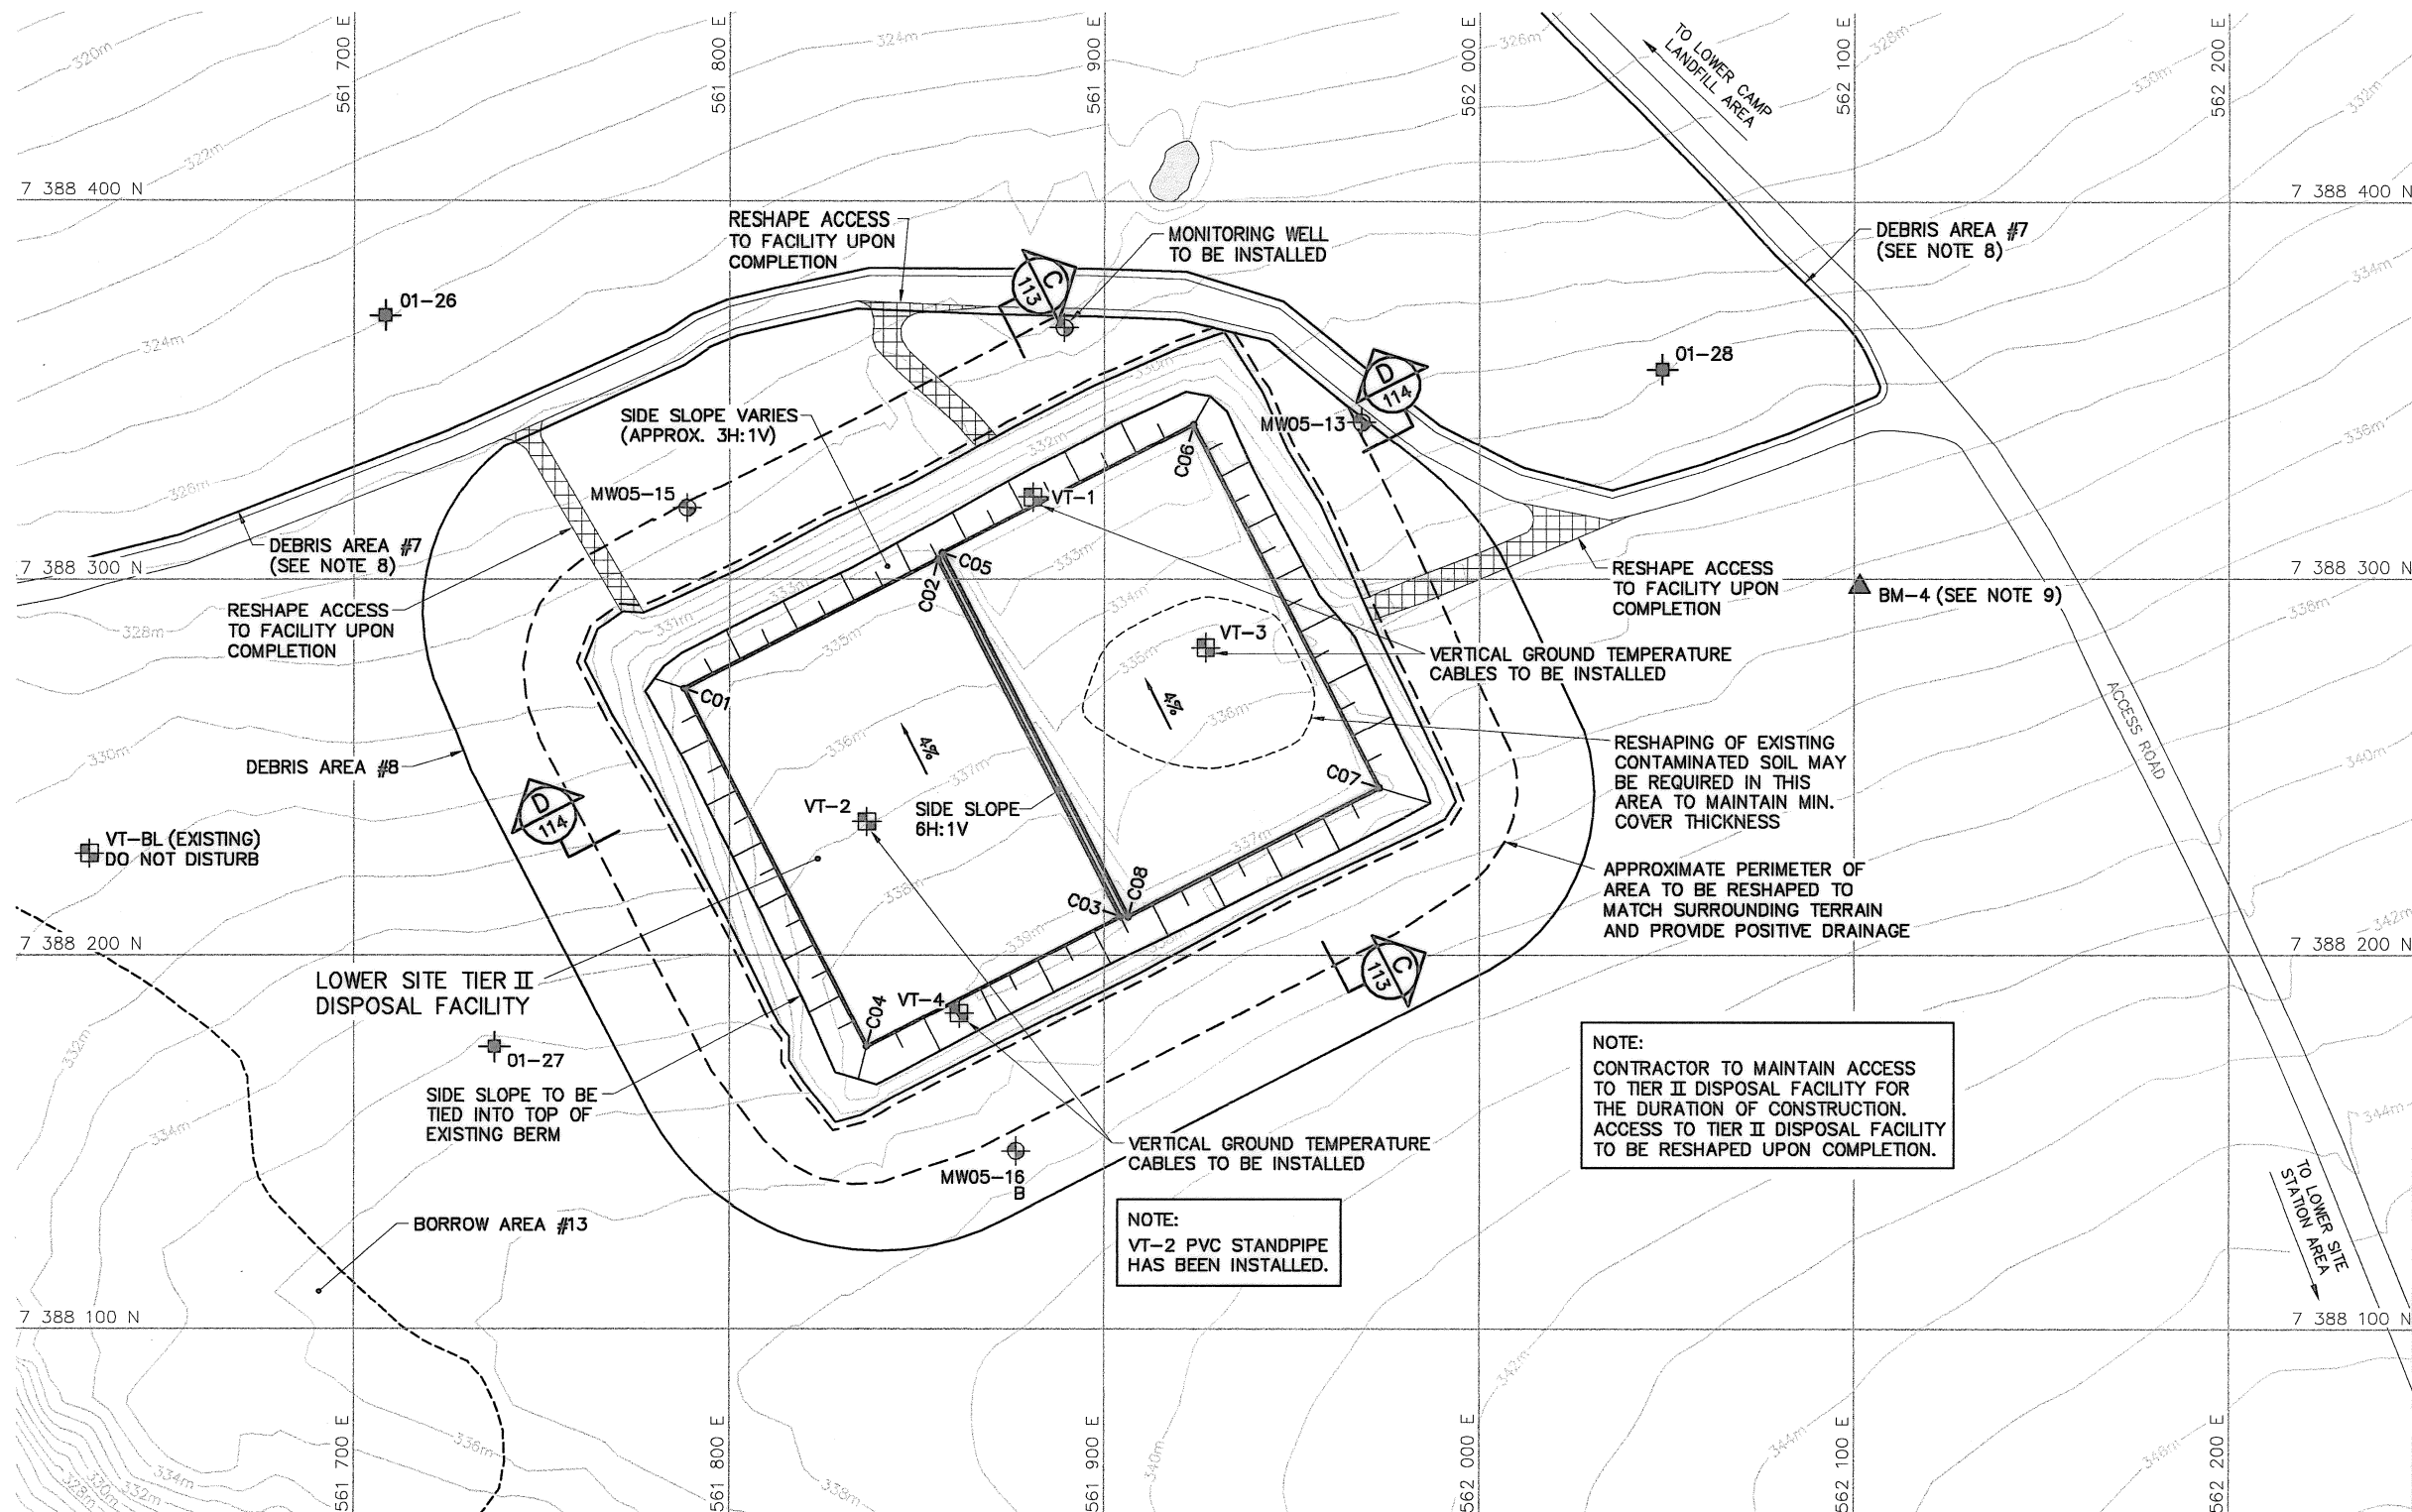
TRADE - METIER SITING DATE 2010-12-07

SUBJECT - SUJET
LOWER SITE
TIER II DISPOSAL FACILITY AREA
PLAN


PRODUCTION	CONCURRENCE - ASSENTIMENT
DESIGNED ETUDIE DTM/THE	DES OFF AGENT CONCEPT
DRAWN DESSINE IC/CAE	SECT HD CHEF SECT
CHECKED VERIFIE DWF	DES MGR GEST CONCEPT
COORDINATION RRM	REVIEWED - REVU

DWG. NO. - DESSIN NO.
H-C75/3-9101-110


Canada




LOWER SITE TIER II DISPOSAL FACILITY FINAL SURFACE (DESIGN)			
NO.	UTM COORDINATES		ELEV.
	NORTHING	EASTING	
C01	7 388 270.8	561 788.0	337.16
C02	7 388 305.4	561 855.7	337.16
C03	7 388 210.1	561 904.4	341.44
C04	7 388 175.5	561 836.7	341.44
C05	7 388 307.1	561 856.8	336.82
C06	7 388 341.3	561 923.8	336.82
C07	7 388 244.2	561 973.4	341.18
C08	7 388 210.0	561 906.4	341.18

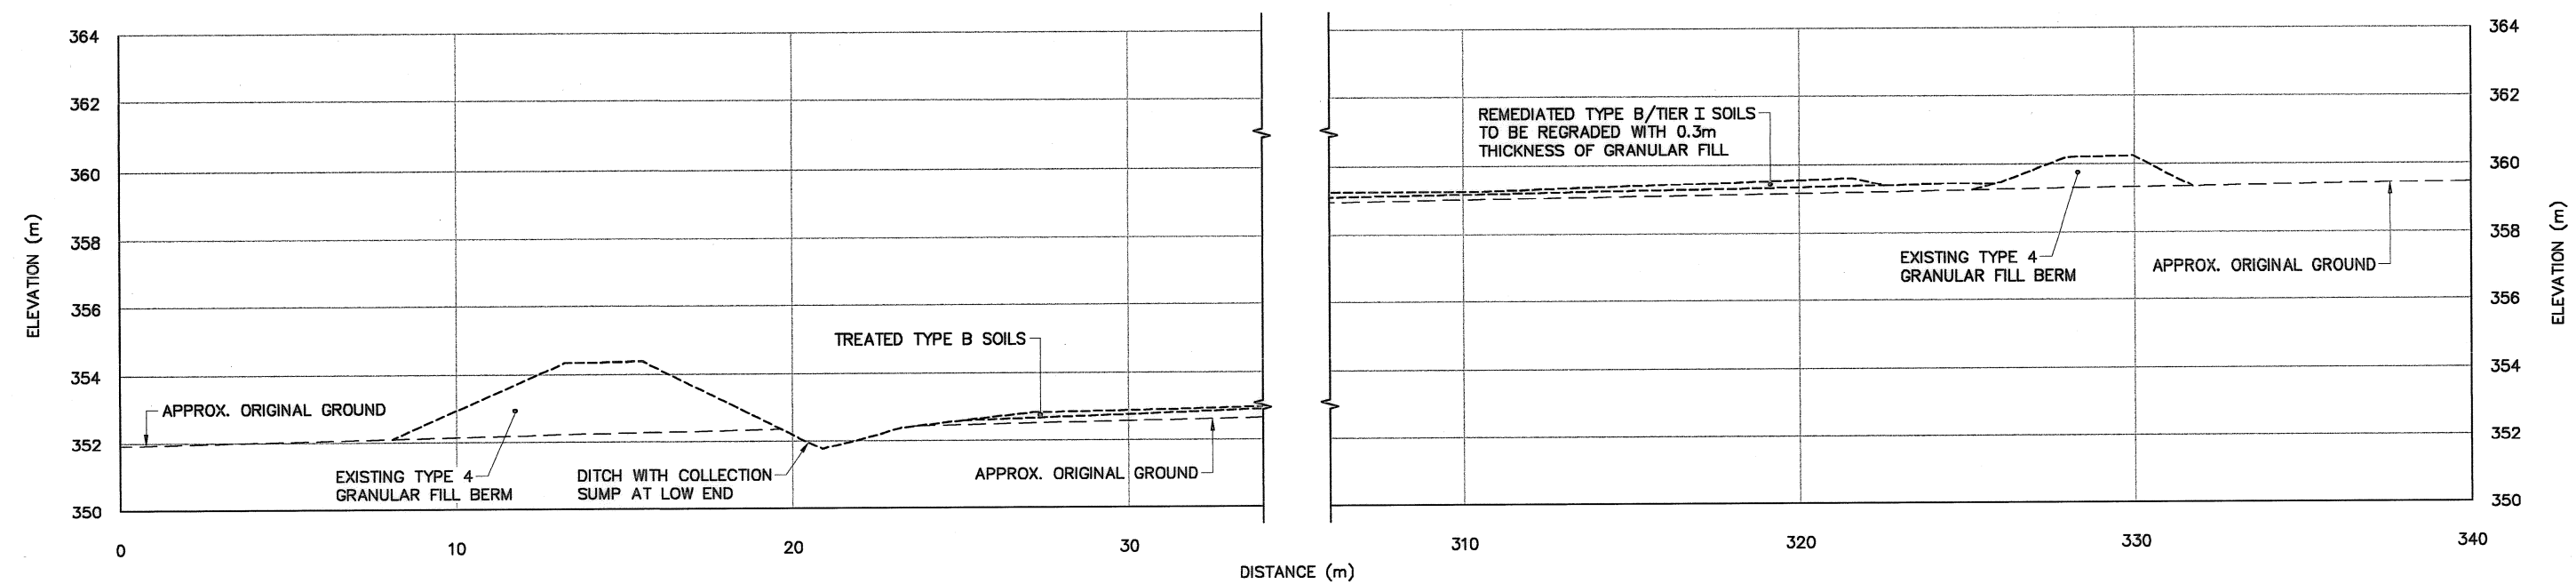

SECTION A
106

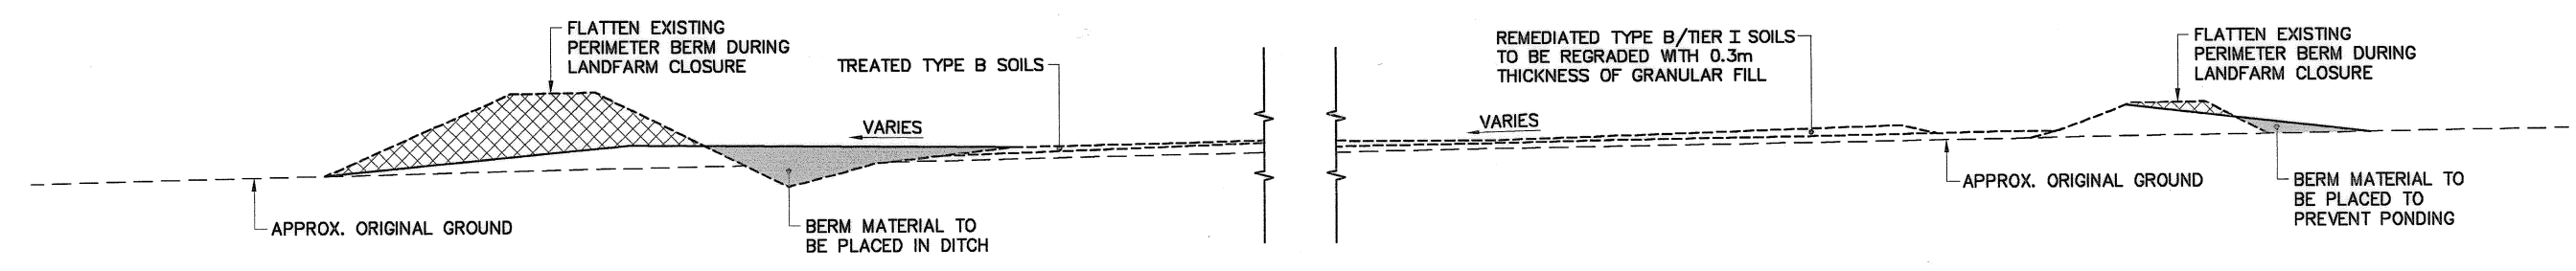

TYPICAL LANDFARM CLOSURE DETAIL
SCALE: NTS

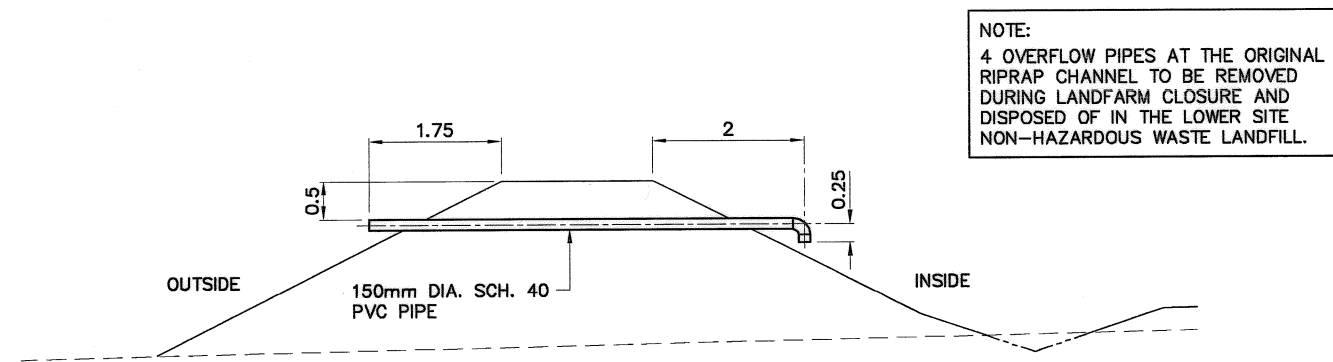

SECTION
DETAIL
SCALE: NTS
EMERGENCY OUTLET
1
106

General Notes:

1. ALL COORDINATES ARE REFERENCED TO UTM ZONE 20N, NAD83. ELEVATIONS ARE REFERENCED TO MEAN SEA LEVEL RELATIVE TO GEOID MODEL CANADIAN HT2_0.
2. ALL DIMENSIONS ARE IN METRES UNLESS NOTED OTHERWISE.

Legend:

- DESIGN REQUIREMENTS TO BE CONSTRUCTED
- GENERATED BASED ON EXISTING SURVEY INFORMATION
- GENERATED BASED ON ORIGINAL SURVEY INFORMATION

No.	DATE	REVISION	REVISION	APPR.

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NW/NU Association of Professional Engineers and Geoscientists

SCALE - ÉCHELLE
2
1
0
2
4
6m

PROJECT - PROJET
DYE-M CAPE DYER

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TRADE - MÉTIER **SITING** DATE **2010-12-07**

SUBJECT - SUJET
**LOWER SITE
LANDFARM CROSS SECTION
AND CLOSURE DETAIL**

PRODUCTION	CONCURRENCE - ASSENTIMENT	
DESIGNED ETUDIE <i>DTM/ THE</i>		DES OFF AGENT CONCEPT
DRAWN DESSINE <i>IC/ CAE</i>		SECT HD CHEF SECT
CHECKED VERIFIÉ <i>BWF</i>		DES MGR GEST CONCEPT
COORDINATION <i>RRM</i>	REVIEWED - REVU	
DWG. NO. - DESSIN NO. H-C75/3-9101-111		


General Notes:

1. ALL COORDINATES ARE REFERENCED TO UTM ZONE 20N, NAD83. ELEVATIONS ARE REFERENCED TO MEAN SEA LEVEL RELATIVE TO GEOID MODEL CANADIAN HT2_0.
2. ALL DIMENSIONS ARE IN METRES UNLESS NOTED OTHERWISE.
3. USE STOCKPILED TIER I SOIL FOR INTERMEDIATE COVER AS REQUIRED.
4. DURING THE COURSE OF WASTE PLACEMENT, UTILIZE ENTIRE FLOOR OF LANDFILL AND MAINTAIN A LEVEL WASTE LAYER. PLACE WASTE LAYERS IN PROGRESSIVE HORIZONTAL LIFTS THAT EXTEND ACROSS THE ENTIRE LANDFILL FLOOR.

Legend:

- DESIGN REQUIREMENTS TO BE CONSTRUCTED
- GENERATED BASED ON EXISTING SURVEY INFORMATION
- GENERATED BASED ON ORIGINAL SURVEY INFORMATION

No.	DATE	REVISION	REVISION	APPR.
-----	------	----------	----------	-------

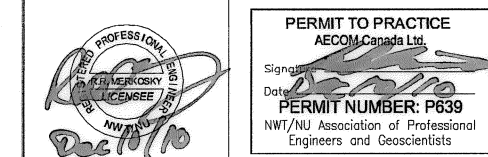

AECOM

HATCH

SCALE - ECHELLE 2 1 0 2 4 6m

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DYE-M CAPE DYER

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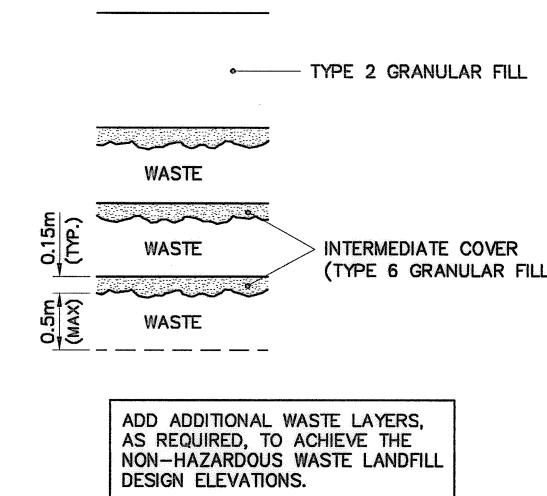
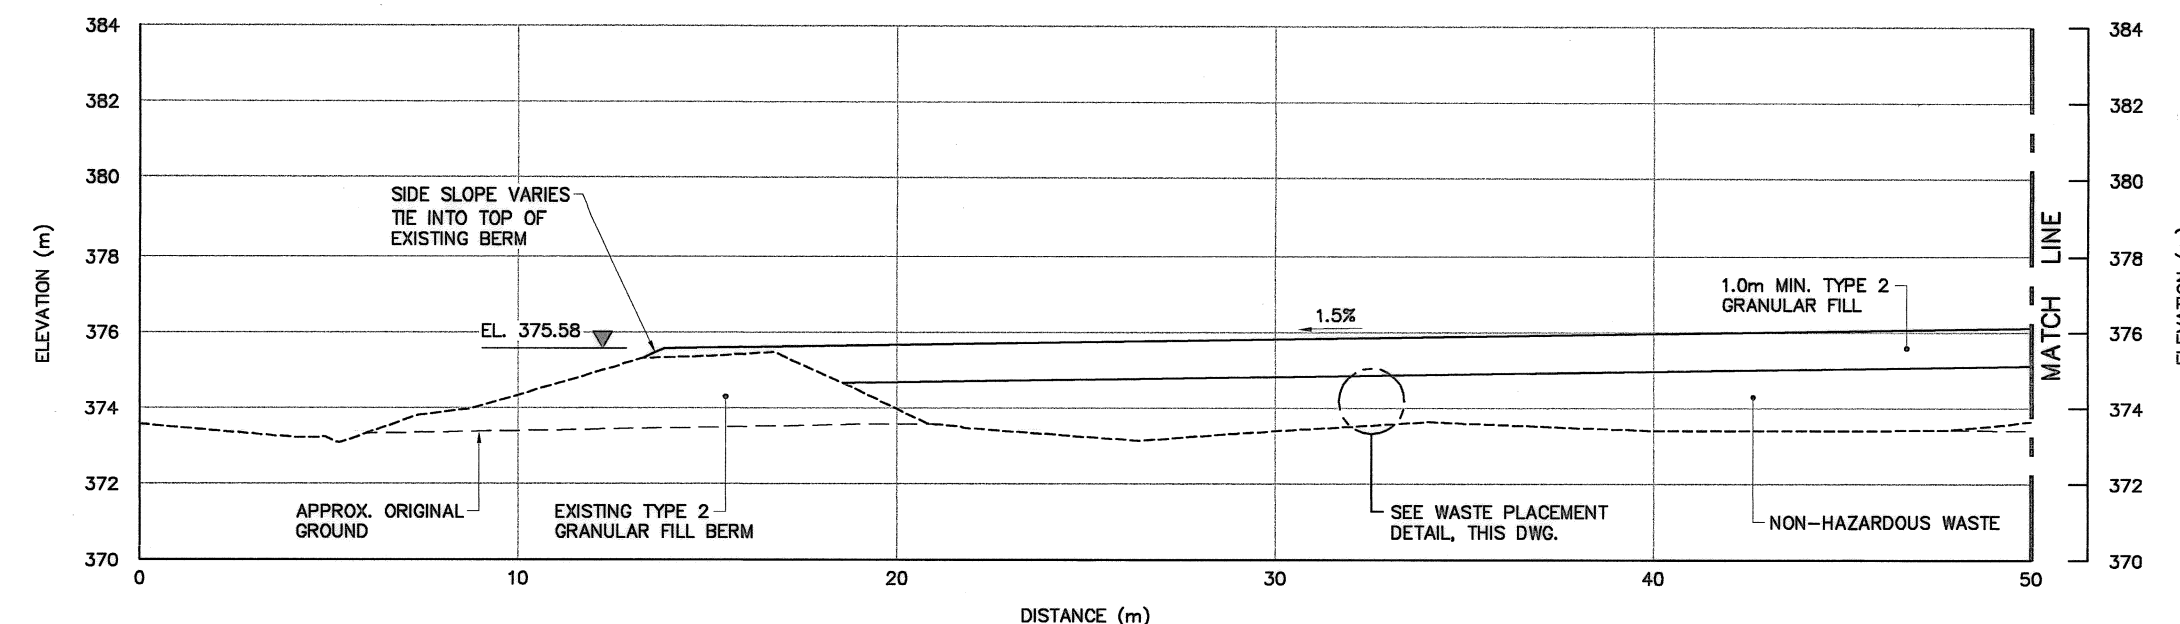
TRADE - METIER SITING DATE 2010-12-07

SUBJECT - SUJET
LOWER SITE
NON-HAZARDOUS WASTE LANDFILL
CROSS SECTION

PRODUCTION	CONCURRENCE - ASSENTIMENT
DESIGNED ETUDIE DTH/THE	DES OFF AGENT CONCEPT
DRAWN DESSINE IC/CAE	SECT HD CHEF SECT
CHECKED VERIFIE DWF	DES MGR GEST CONCEPT
COORDINATION RRM	REVIEWED - REVU



DWG. NO. - DESSIN NO.
H-C75/3-9101-112

Canada




WASTE PLACEMENT DETAIL


SCALE: NTS

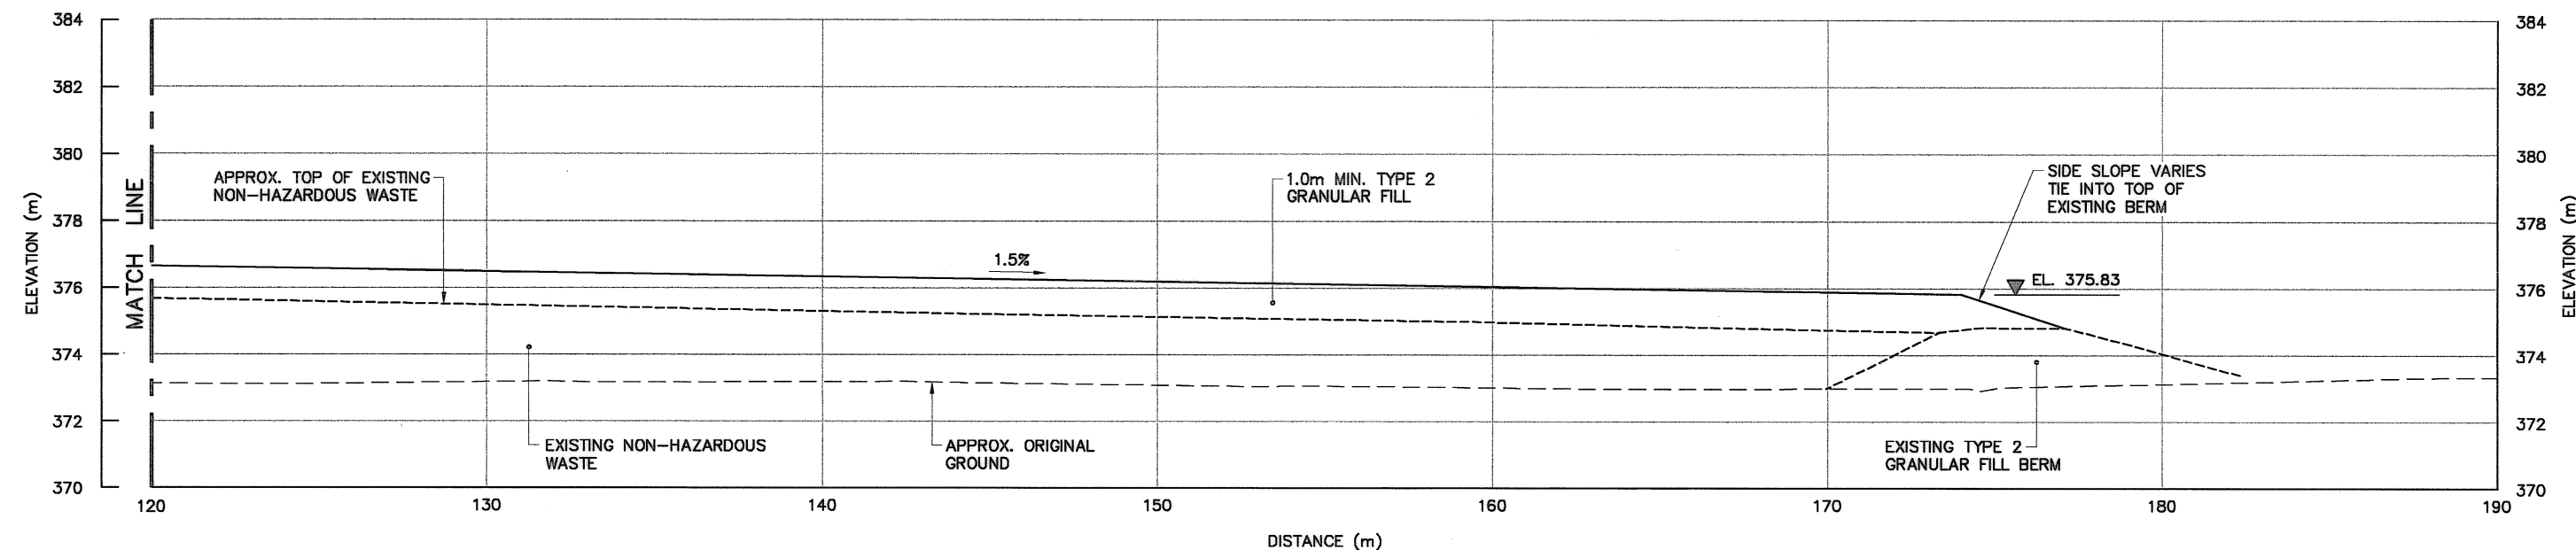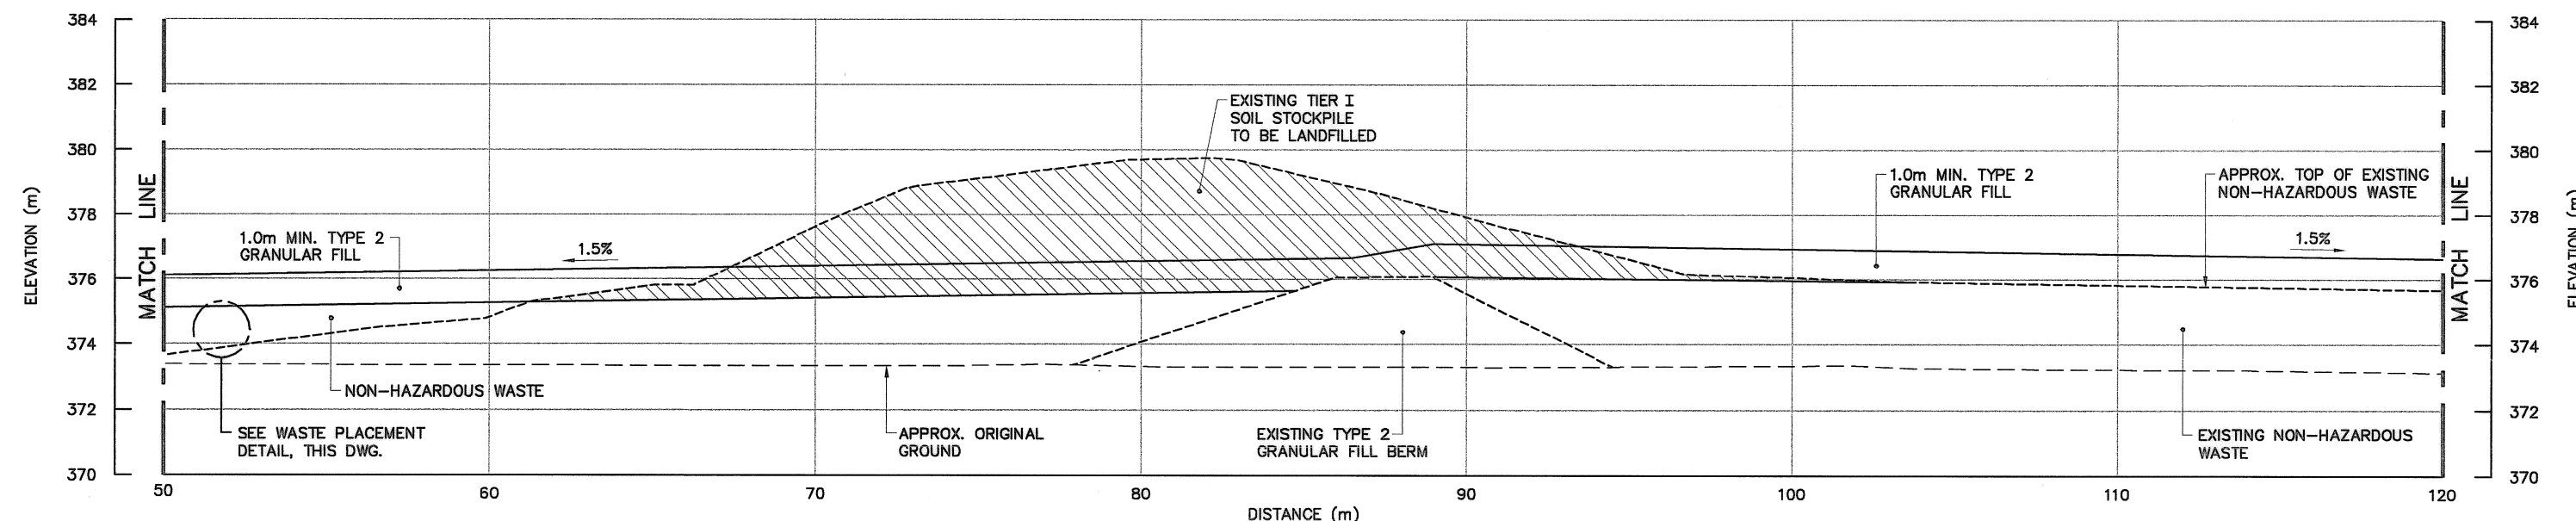


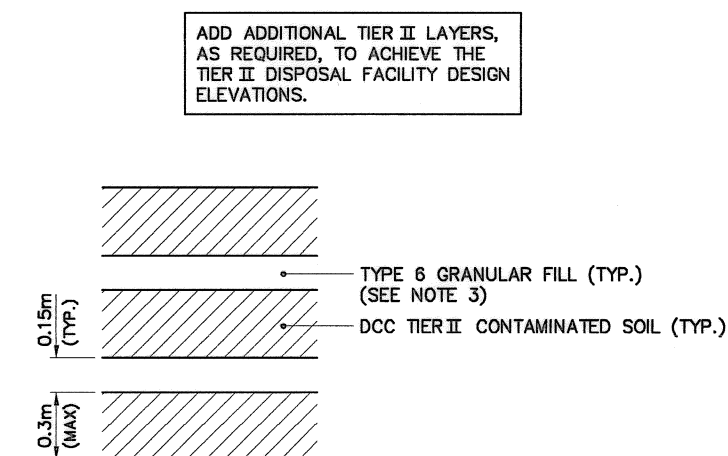
SECTION B
108

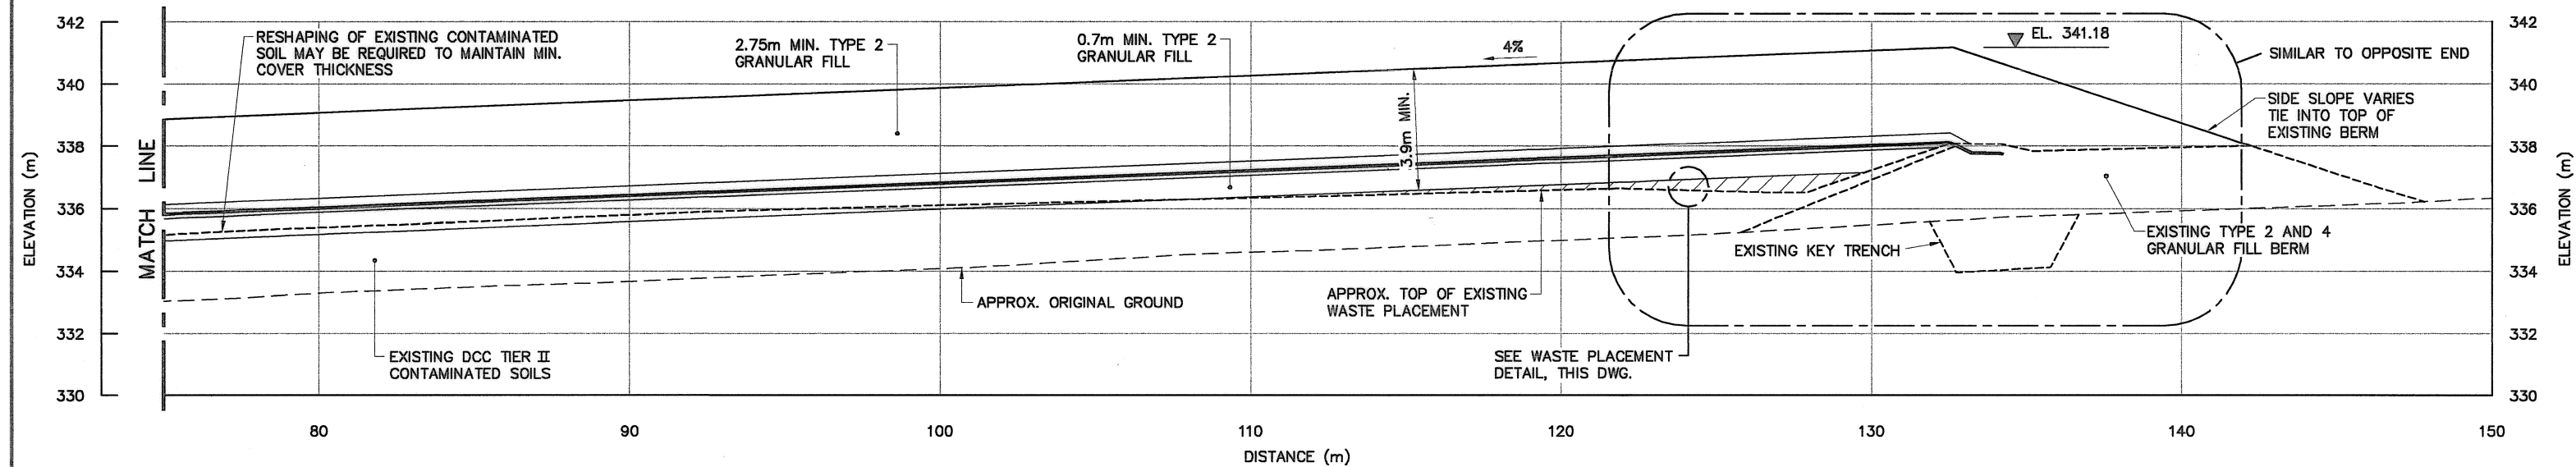

SECTION C
110

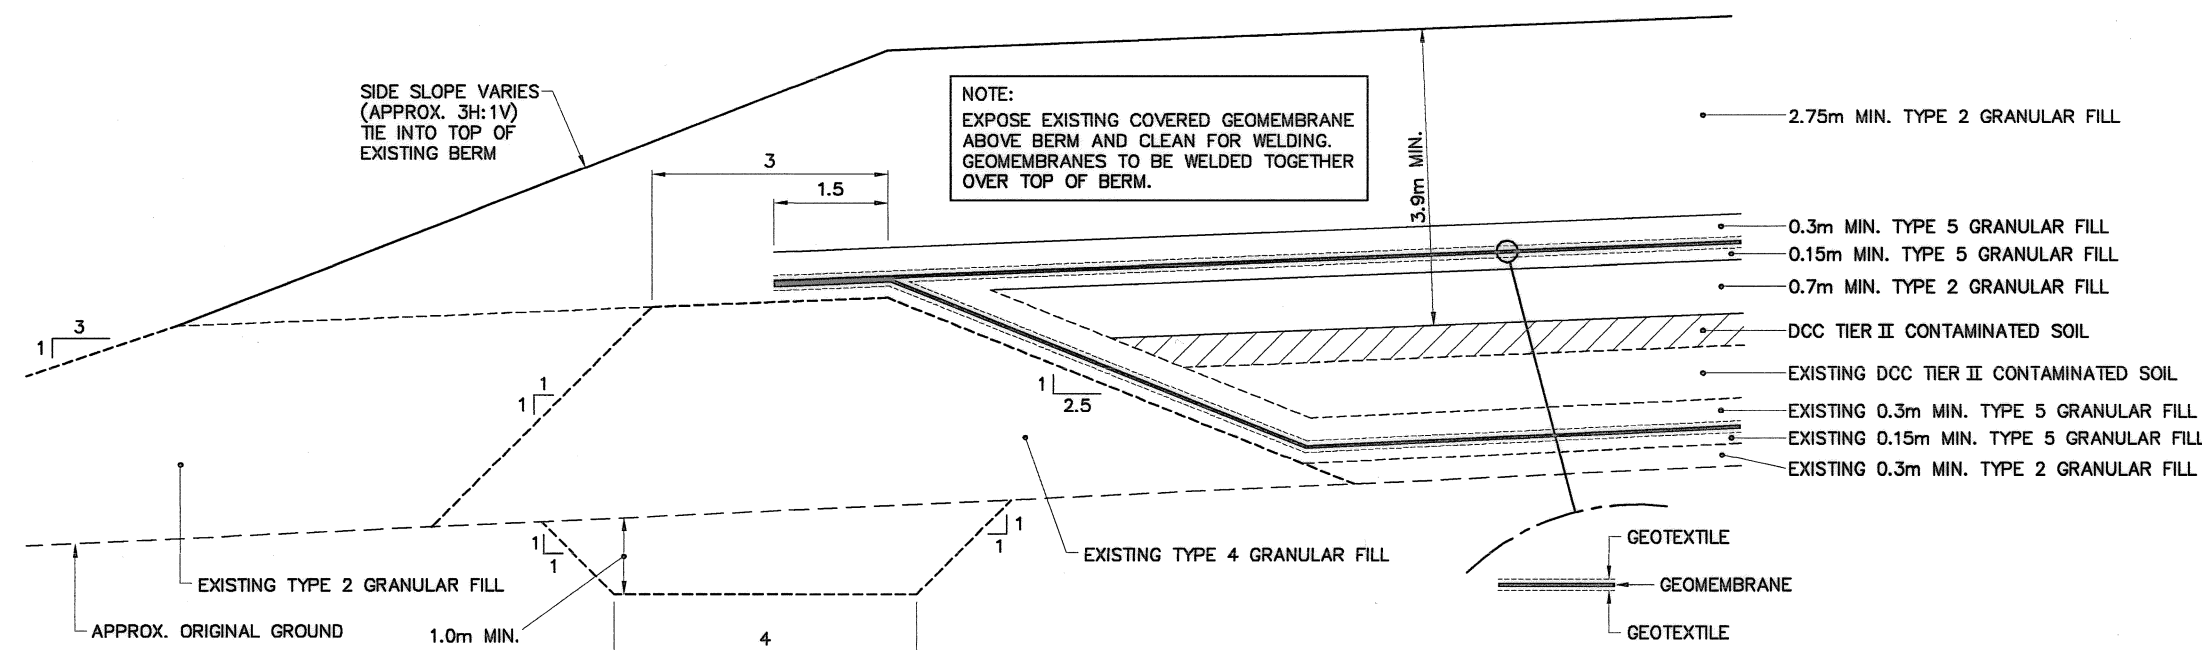

DETAIL  2
SCALE: NTS 113,114



WASTE PLACEMENT DETAIL

Headquarters
Quartier général



General Notes:

1. ALL COORDINATES ARE REFERENCED TO UTM ZONE 20N, NAD83. ELEVATIONS ARE REFERENCED TO MEAN SEA LEVEL RELATIVE TO GEOID MODEL CANADIAN HT2_0.
2. ALL DIMENSIONS ARE IN METRES UNLESS NOTED OTHERWISE.
3. TYPE 6 INTERMEDIATE FILL ONLY REQUIRED FOR LANDFILLING OF ORGANIC OR WET SOILS, AS DIRECTED BY THE ENGINEER.

Legend:

- | | |
|-----------|---|
| _____ | DESIGN REQUIREMENTS
TO BE CONSTRUCTED |
| ----- | GENERATED BASED ON EXISTING
SURVEY INFORMATION |
| - - - - - | GENERATED BASED ON ORIGINAL
SURVEY INFORMATION |

No.	DATE	REVISION	REVISION	APPR.
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DYE-M CAPE DYER
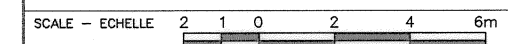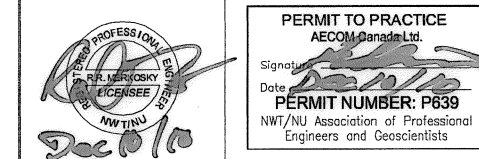
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TRADE - METIER	SITING	DATE
		2010-12-07

SUBJECT - SUJET




LOWER SITE
TIER II DISPOSAL FACILITY
CROSS SECTION S

SHEET 1

PRODUCTION	CONCURRENCE - ASSENTIMENT	
DESIGNED ETUDE <i>DTM/TIME</i>		DES OFF AGENT CONCEPT
DRAWN DESSINE <i>IC/CAE</i>		SECT HD CHEF SECT
CHECKED VERIFIE <i>BWF</i>		DES MGR GEST CONCEPT
COORDINATION <i>RRM</i>	REVIEWED - REVU	

DWG. NO. - DESSIN NO.
H-C75/3-9101-113

Canada

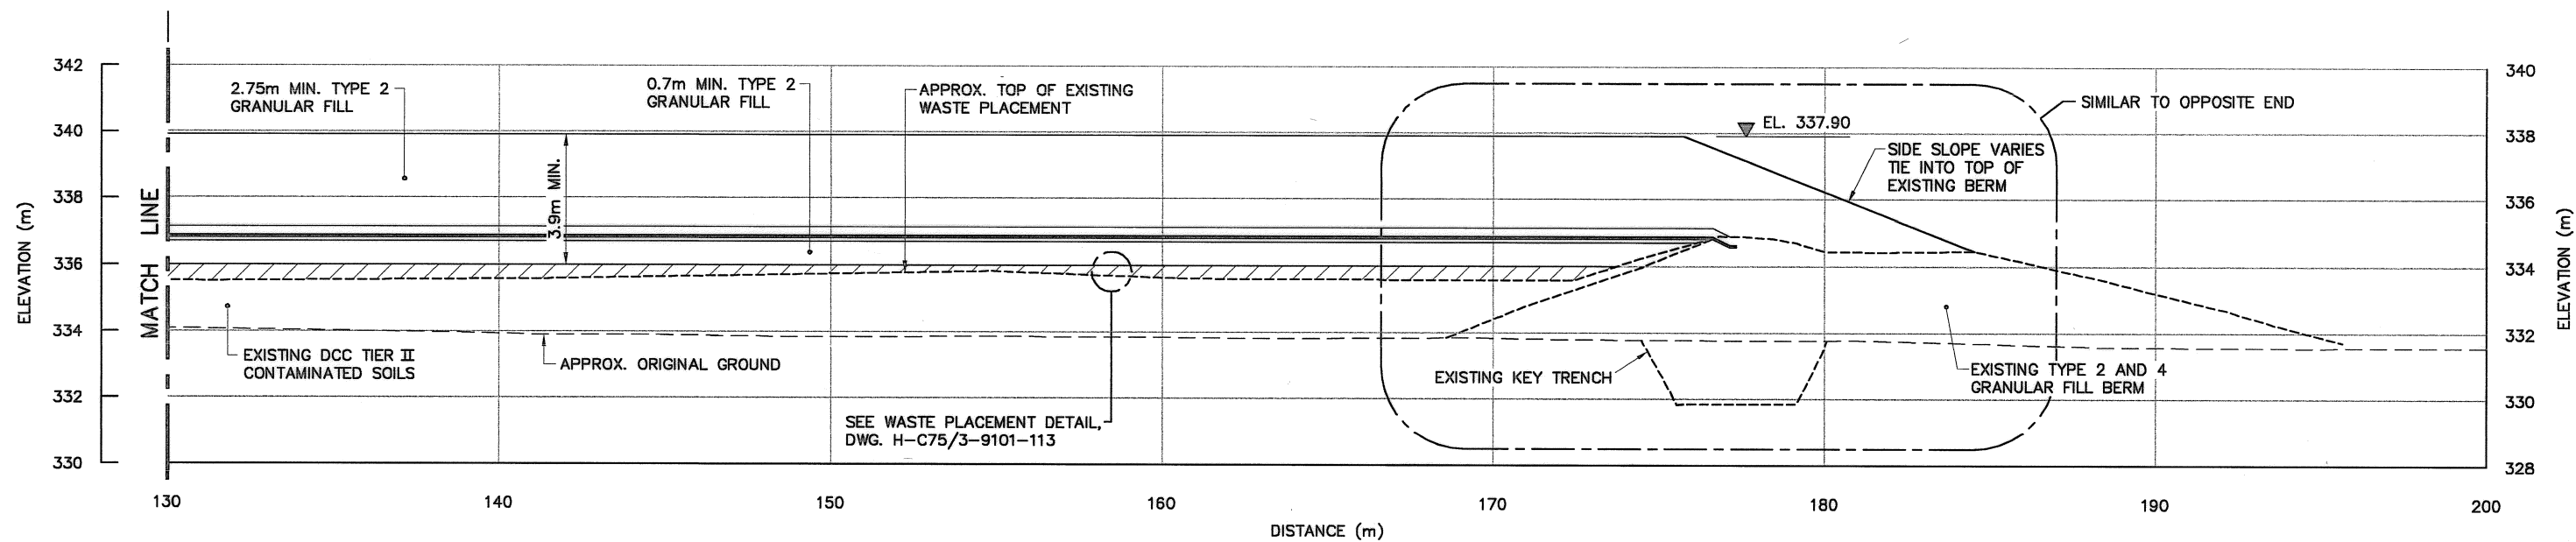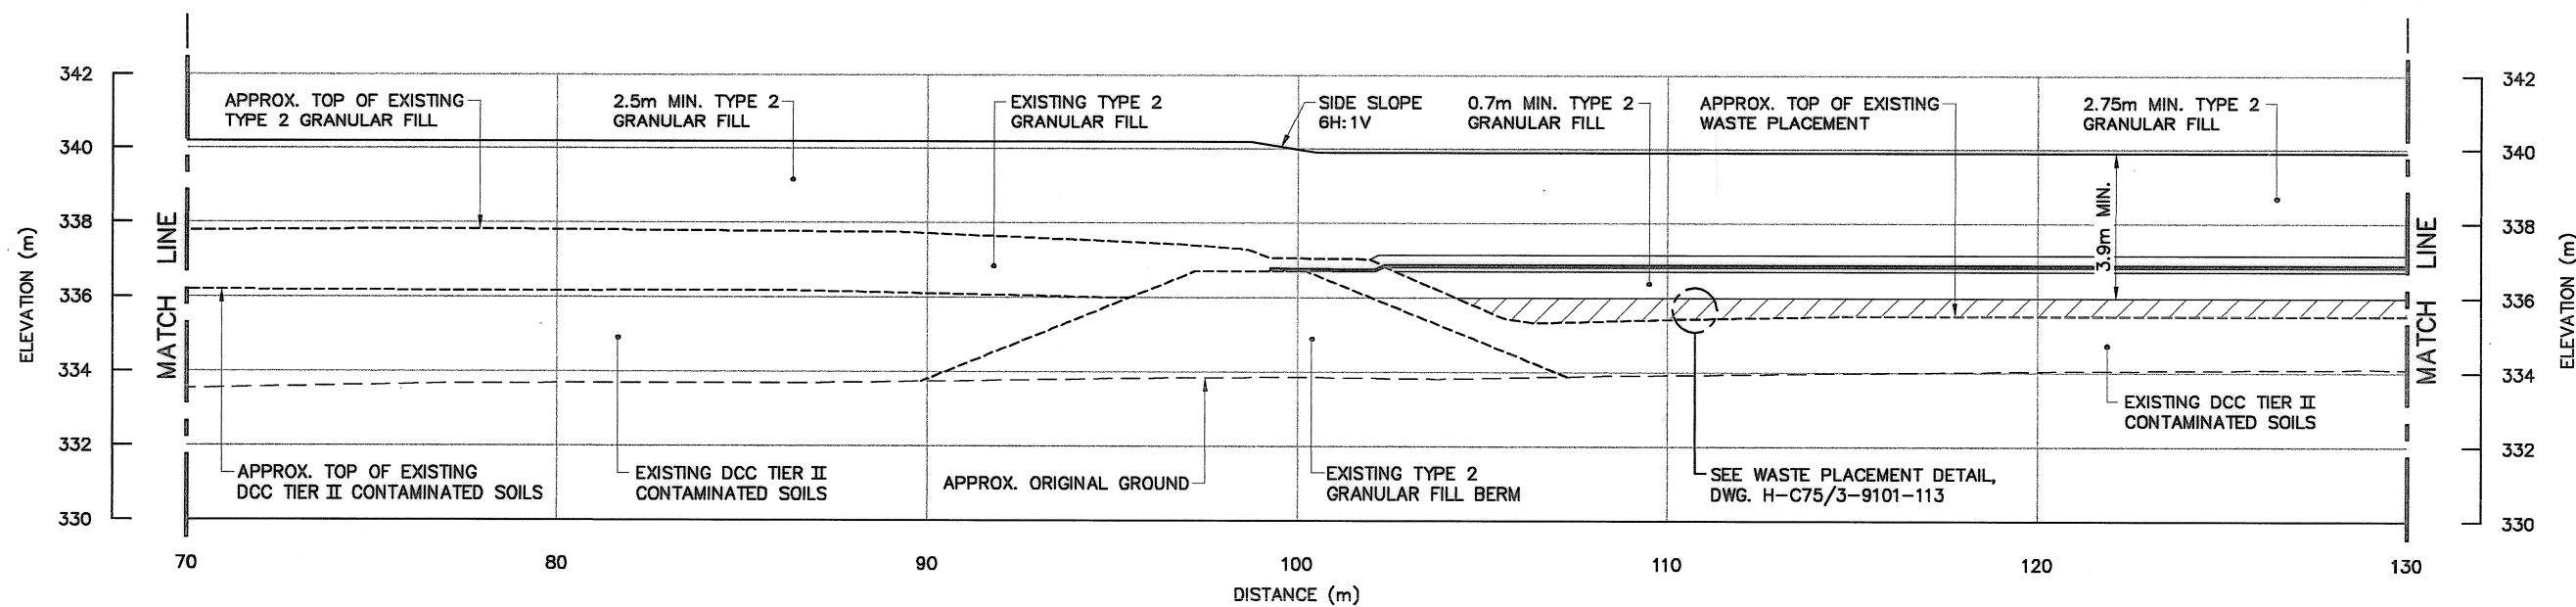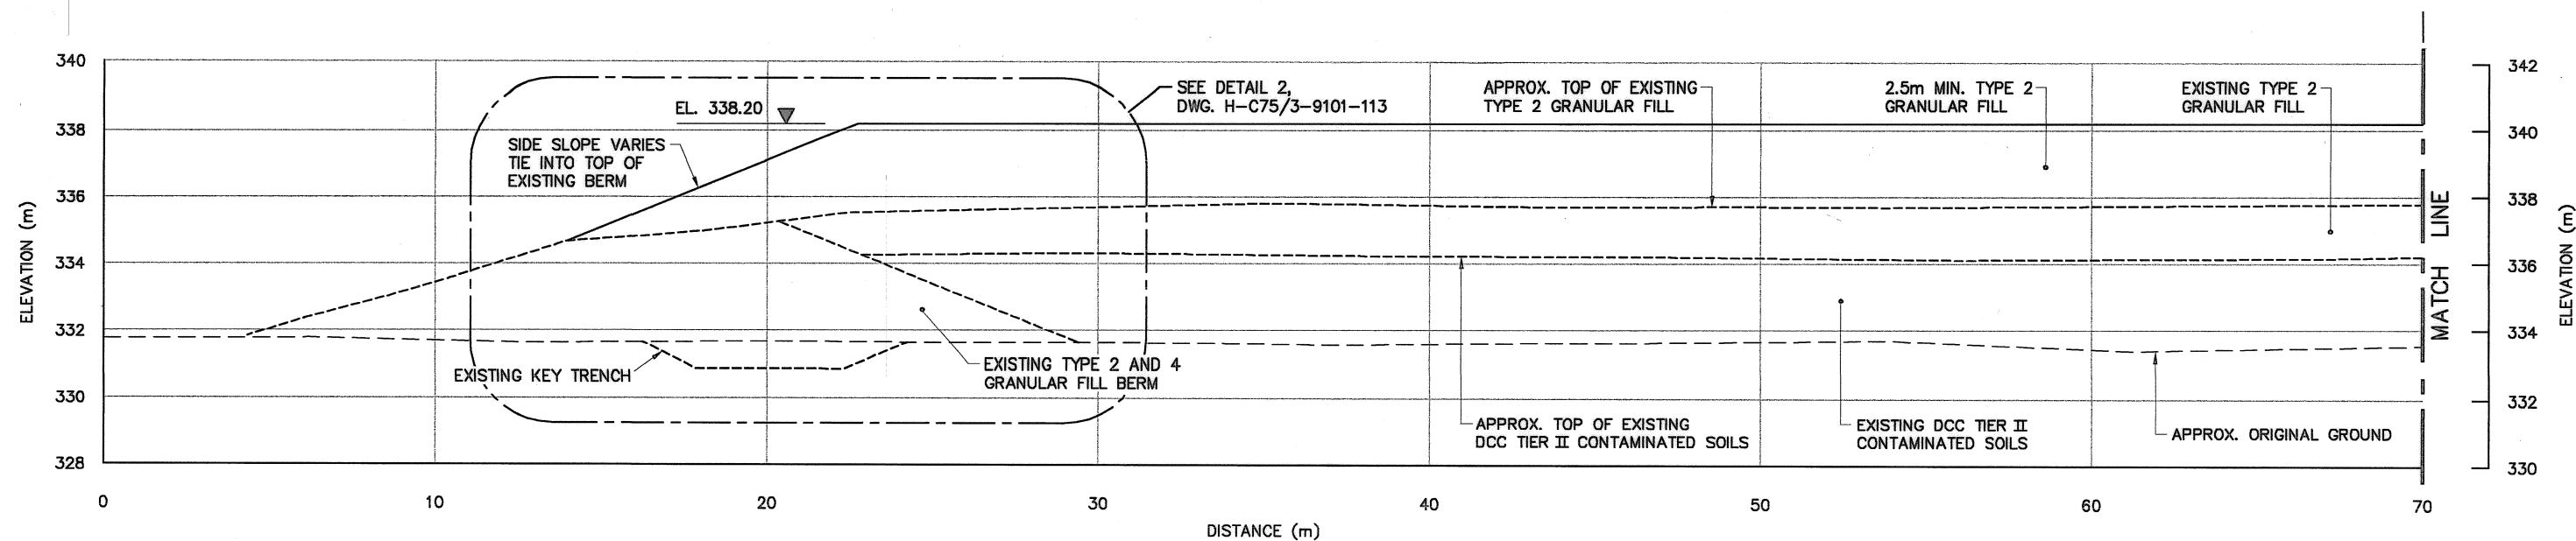

SECTION D
110


General Notes:

1. ALL COORDINATES ARE REFERENCED TO UTM ZONE 20N, NAD83. ELEVATIONS ARE REFERENCED TO MEAN SEA LEVEL RELATIVE TO GEOID MODEL CANADIAN HT2_0.
2. ALL DIMENSIONS ARE IN METRES UNLESS NOTED OTHERWISE.
3. PROTECT GEOMEMBRANE LINERS DURING CONSTRUCTION.

Legend:

- DESIGN REQUIREMENTS TO BE CONSTRUCTED
- - - - - GENERATED BASED ON EXISTING SURVEY INFORMATION
- - - - - GENERATED BASED ON ORIGINAL SURVEY INFORMATION

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PERMIT NUMBER: P639
NWT/NJ Association of Professional Engineers and Geoscientists

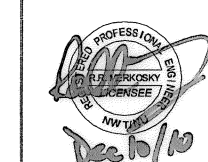AECOM

HATCH

SCALE - ECHELLE 2 1 0 2 4 6m

PROJECT - PROJET
DYE-M CAPE DYER

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TRADE - METIER SITING DATE 2010-12-07

SUBJECT - SUJET
LOWER SITE
TIER II DISPOSAL FACILITY
CROSS SECTION SHEET 2

PRODUCTION	CONCURRENCE - ASSENTMENT
DESIGNED ETUDIE DTH/TME	DES OFF AGENT CONCEPT
DRAWN DESSINE IC/CNE	SECT HD CHEF SECT
CHECKED VERIFIE DUFF	DES MGR GEST CONCEPT
COORDINATION RRM	REVIEWED - REVU

DWG. NO. - DESSIN NO.
H-C75/3-9101-114

Canada


General Notes:

1. ALL COORDINATES ARE REFERENCED TO UTM ZONE 20N, NAD83. ELEVATIONS ARE REFERENCED TO MEAN SEA LEVEL RELATIVE TO GEOID MODEL CANADIAN HT2_0.
2. ALL DIMENSIONS ARE IN METRES UNLESS NOTED OTHERWISE.
3. ALL NON-HAZARDOUS DEBRIS WITHIN PLAN AREA TO BE PLACED IN UPPER SITE NON-HAZARDOUS WASTE LANDFILL.
4. REFER TO TABLE 02219-1 IN SPECIFICATIONS FOR DESCRIPTION OF DEBRIS AREAS.
5. FOR PERMANENT SURVEY CONTROL (BENCHMARK) INSTALLATION DETAILS, SEE DWG. H-C75/3-9101-191.

Legend:

- ▲ BM-7 PERMANENT BENCHMARK LOCATION (1)
- ⊕ TEST PIT LOCATION
- ⊕ SITE INVESTIGATION MONITORING WELL LOCATION
- BODY OF WATER
- DITCH

No.	DATE	REVISION	REVISION	APPR.
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SCALE - ECHELLE 40 20 0 40 80 120m
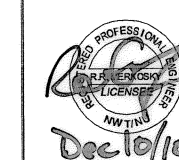
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DYE-M CAPE DYER

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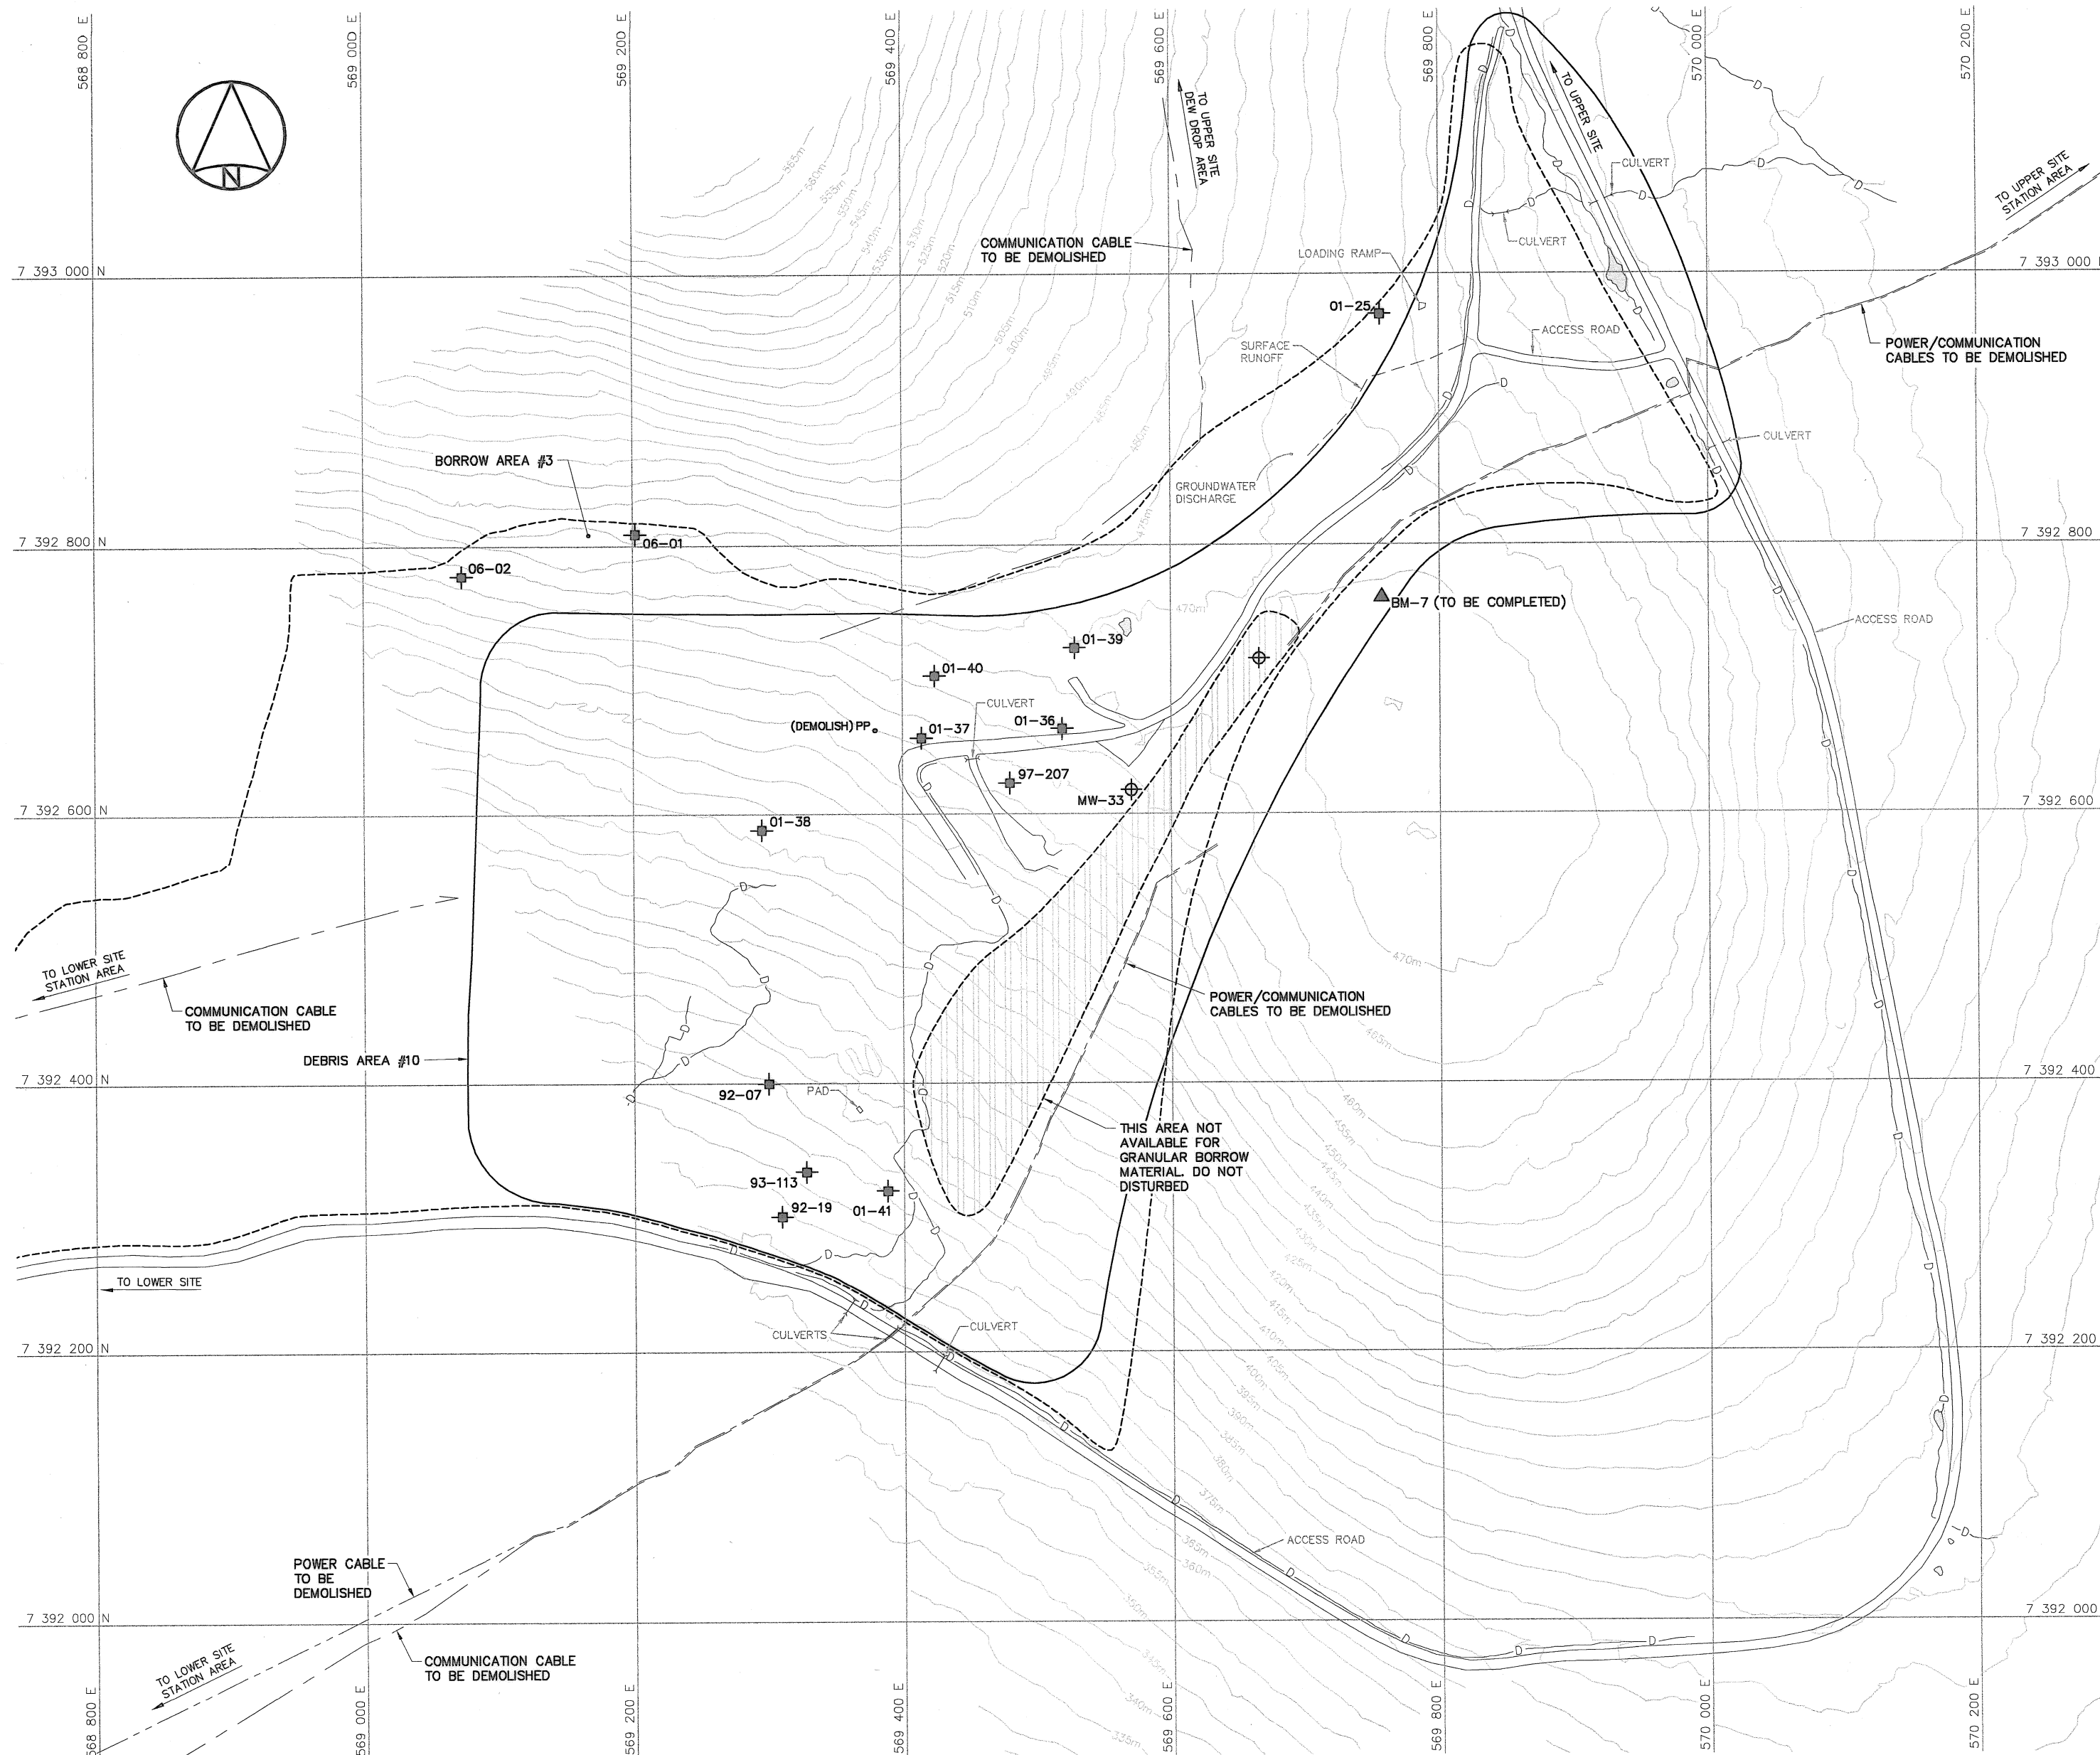
SUBJECT - SUJET


MIDDLE SITE
SITE PLAN

PRODUCTION	CONCURRENCE - ASSENTIMENT
DESIGNED ETUDIE DTH/THE	DES OFF AGENT CONCEPT
DRAWN DESSINE IC/CAE	SECT HD CHEF SECT
CHECKED VERIFIE BWF	DES MGR GEST CONCEPT
COORDINATION RRM	REVIEWED - REVU

DWG. NO. - DESSIN NO.
H-C75/3-9101-150

Canada

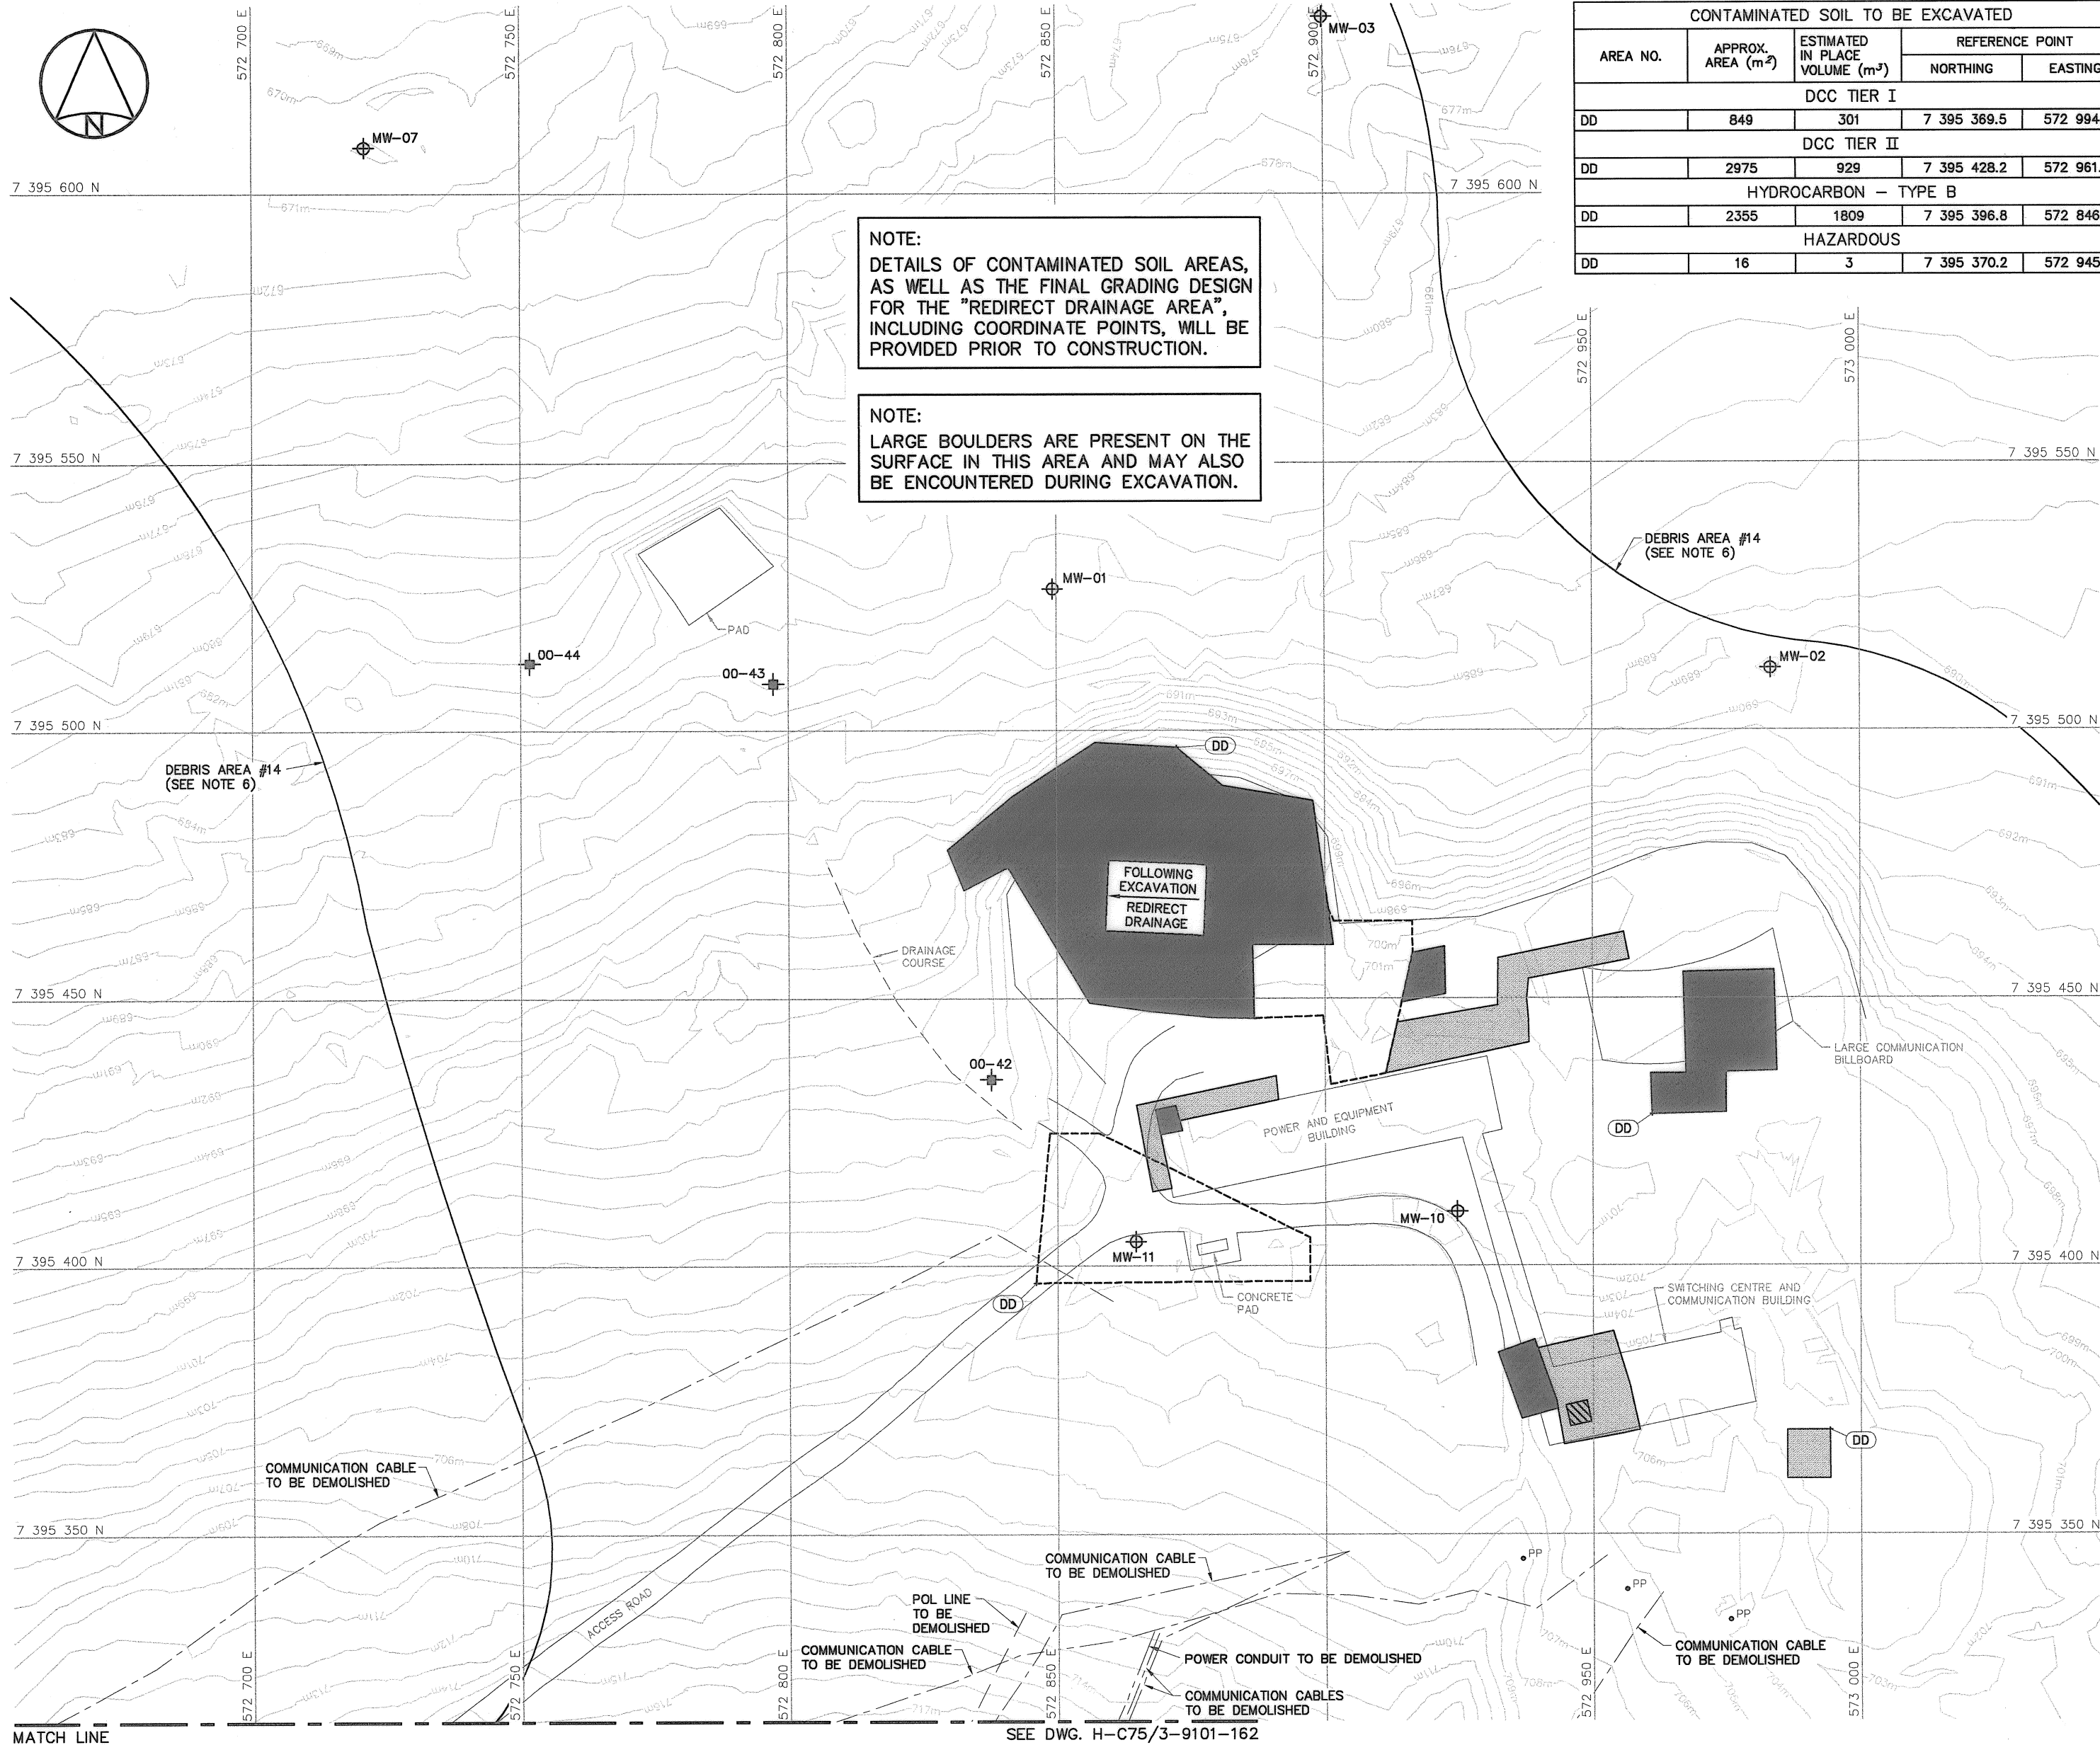



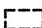





CONTAMINATED SOIL TO BE EXCAVATED				
AREA NO.	APPROX. AREA (m ²)	ESTIMATED IN PLACE VOLUME (m ³)	REFERENCE POINT	
			NORTHING	EASTING
DCC TIER I				
DD	849	301	7 395 369.5	572 994.3
DCC TIER II				
DD	2975	929	7 395 428.2	572 961.2
HYDROCARBON – TYPE B				
DD	2355	1809	7 395 396.8	572 846.0
HAZARDOUS				
DD	16	3	7 395 370.2	572 945.8

General Notes:

1. ALL COORDINATES ARE REFERENCED TO UTM ZONE 20N, NAD83. ELEVATIONS ARE REFERENCED TO MEAN SEA LEVEL RELATIVE TO GEOID MODEL CANADIAN HT2_0.
2. ALL DIMENSIONS ARE IN METRES UNLESS NOTED OTHERWISE.
3. ALL NON-HAZARDOUS DEBRIS WITHIN PLAN AREA TO BE PLACED IN UPPER SITE NON-HAZARDOUS WASTE LANDFILL.
4. REFER TO TABLE 02219-1 IN SPECIFICATIONS FOR DESCRIPTION OF DEBRIS AREAS.
5. ALL SURFACE DEBRIS IS TO BE REMOVED FROM ALL CONTAMINATED SOIL AREAS AND EXISTING LANDFILL AREAS PRIOR TO ANY FILL PLACEMENT OR EXCAVATION TAKING PLACE.
6. FOR ENTIRE DEBRIS AREA LIMITS, SEE DWG. H-C75/3-9101-160.

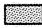Legend:

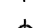-  DCC TIER I CONTAMINATED SOIL
-  DCC TIER II CONTAMINATED SOIL
-  HYDROCARBON - TYPE B CONTAMINATED SOIL
-  HAZARDOUS CONTAMINATED SOIL
-  TEST PIT LOCATION
-  SITE INVESTIGATION MONITORING WELL LOCATION

No.	DATE	REVISION	REVISION	APPR.
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Date: [Date]
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AECOM HATCH

SCALE - ECHELLE 10 5 0 10 20 30m

PROJECT - PROJET
DYE-M CAPE DYER

DEW LINE CLEAN UP

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TRADE - METIER SITING DATE 2010-12-07

SUBJECT - SUJET
UPPER SITE
DEW DROP AREA
PLAN

PRODUCTION		CONCURRENCE - ASSENTMENT	
DESIGNED ETUDIE	DTM/TME	DES OFF AGENT CONCEPT	
DRAWN DESSINE	IC/CAE	SECT HD CHEF SECT	
CHECKED VERIFIE	DWF	DES MGR GEST CONCEPT	
COORDINATION RRM		REVIEWED - REVU	

DWG. NO. - DESSIN NO.
H-C75/3-9101-161

SURVEY CONTROL MONUMENTS				
NO.	UTM COORDINATES		ELEV.	DESCRIPTION
	NORTHING	EASTING		
CM31	7 395 089.583	572 596.681	738.753	DYE-M BASELINE STA. 0+00

NOTE: BASELINE STATIONS SHOWN ARE IN IMPERIAL UNITS.



National
Défence

Défense
nationale

Headquarters
Quartier général

General Notes:

1. ALL COORDINATES ARE REFERENCED TO UTM ZONE 20N, NAD83. ELEVATIONS ARE REFERENCED TO MEAN SEA LEVEL RELATIVE TO GEOID MODEL CANADIAN HT2.0.

2. ALL DIMENSIONS ARE IN METRES UNLESS NOTED OTHERWISE.

3. ALL NON-HAZARDOUS DEBRIS WITHIN PLAN AREA TO BE PLACED IN UPPER SITE NON-HAZARDOUS WASTE LANDFILL.

4. REFER TO TABLE 02219-1 IN SPECIFICATIONS FOR DESCRIPTION OF DEBRIS AREAS.

5. ALL LONG RANGE RADAR (LRR) FACILITIES ARE CURRENTLY OPERATIONAL AND ARE NOT TO BE DISTURBED. SEE DWGS. H-C75/3-9101-202 AND 203 FOR ADDITIONAL DETAILS.

6. FOR ENTIRE DEBRIS AREA LIMITS, SEE DWG. H-C75/3-9101-160.

Legend:

CM31

SURVEY CONTROL MONUMENT

TEST PIT LOCATION

SITE INVESTIGATION MONITORING WELL LOCATION

BODY OF WATER

No.	DATE	REVISION	REVISION	APPR.

PROFESSIONAL ENGINEER

DEPT. OF DEFENCE

NEW BRUNSWICK

PERMIT TO PRACTICE

AECOM Canada Ltd.

Signature: *[Signature]*

Date: *[Date]*

PERMIT NUMBER: P639

NWT/NJ Association of Professional Engineers and Geoscientists

AECOM

HATCH

SCALE - ECHELLE 10 5 0 10 20 30m

PROJECT - PROJET DYE-M CAPE DYER

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TRADE - METIER SITING

DATE 2010-12-07

SUBJECT - SUJET

UPPER SITE STATION AREA PLAN

SHEET 1

PRODUCTION	CONCURRENCE - ASSENTMENT
DESIGNED ETUDIE DTM/THE	DES OFF AGENT CONCEPT
DRAWN DESSINE IC/CAE	SECT HD CHEF SECT
CHECKED VERIFIE BWF	DES MGR GEST CONCEPT
COORDINATION RRM	REVIEWED - REVU

DWG. NO. - DESSIN NO. H-C75/3-9101-162

Canada


General Notes:



1. ALL COORDINATES ARE REFERENCED TO UTM ZONE 20N, NAD83. ELEVATIONS ARE REFERENCED TO MEAN SEA LEVEL RELATIVE TO GEOID MODEL CANADIAN HTZ_0.
2. ALL DIMENSIONS ARE IN METRES UNLESS NOTED OTHERWISE.
3. ALL NON-HAZARDOUS DEBRIS WITHIN PLAN AREA TO BE PLACED IN UPPER SITE NON-HAZARDOUS WASTE LANDFILL.
4. REFER TO TABLE 02219-1 IN SPECIFICATIONS FOR DESCRIPTION OF DEBRIS AREAS.
5. ALL LONG RANGE RADAR (LRR) FACILITIES ARE CURRENTLY OPERATIONAL AND ARE NOT TO BE DISTURBED. SEE DWGS. H-C75/3-9101-202 AND 203 FOR ADDITIONAL DETAILS.
6. FOR ENTIRE DEBRIS AREA LIMITS, SEE DWG. H-C75/3-9101-160.

Legend:

 SITE INVESTIGATION MONITORING WELL LOCATION

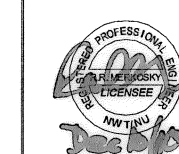No.	DATE	REVISION	REVISION	APPR.
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Date: 
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HATCH

SCALE - ECHELLE 10 5 0 10 20 30m

PROJECT - PROJET
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TRADE - METIER SITING DATE 2010-12-07

SUBJECT - SUJET



UPPER SITE
STATION AREA
PLAN

SHEET 2

PRODUCTION	CONCURRENCE - ASSENTIMENT
DESIGNED ETUDIE DTM/TME	DES OFF AGENT CONCEPT
DRAWN DESSINE IC/CDE	SECT HD CHEF SECT
CHECKED VERIFIE BWF	DES MGR GEST CONCEPT
COORDINATION RRM	REVIEWED - REVU

DWG. NO. - DESSIN NO.
H-C75/3-9101-163

Canada

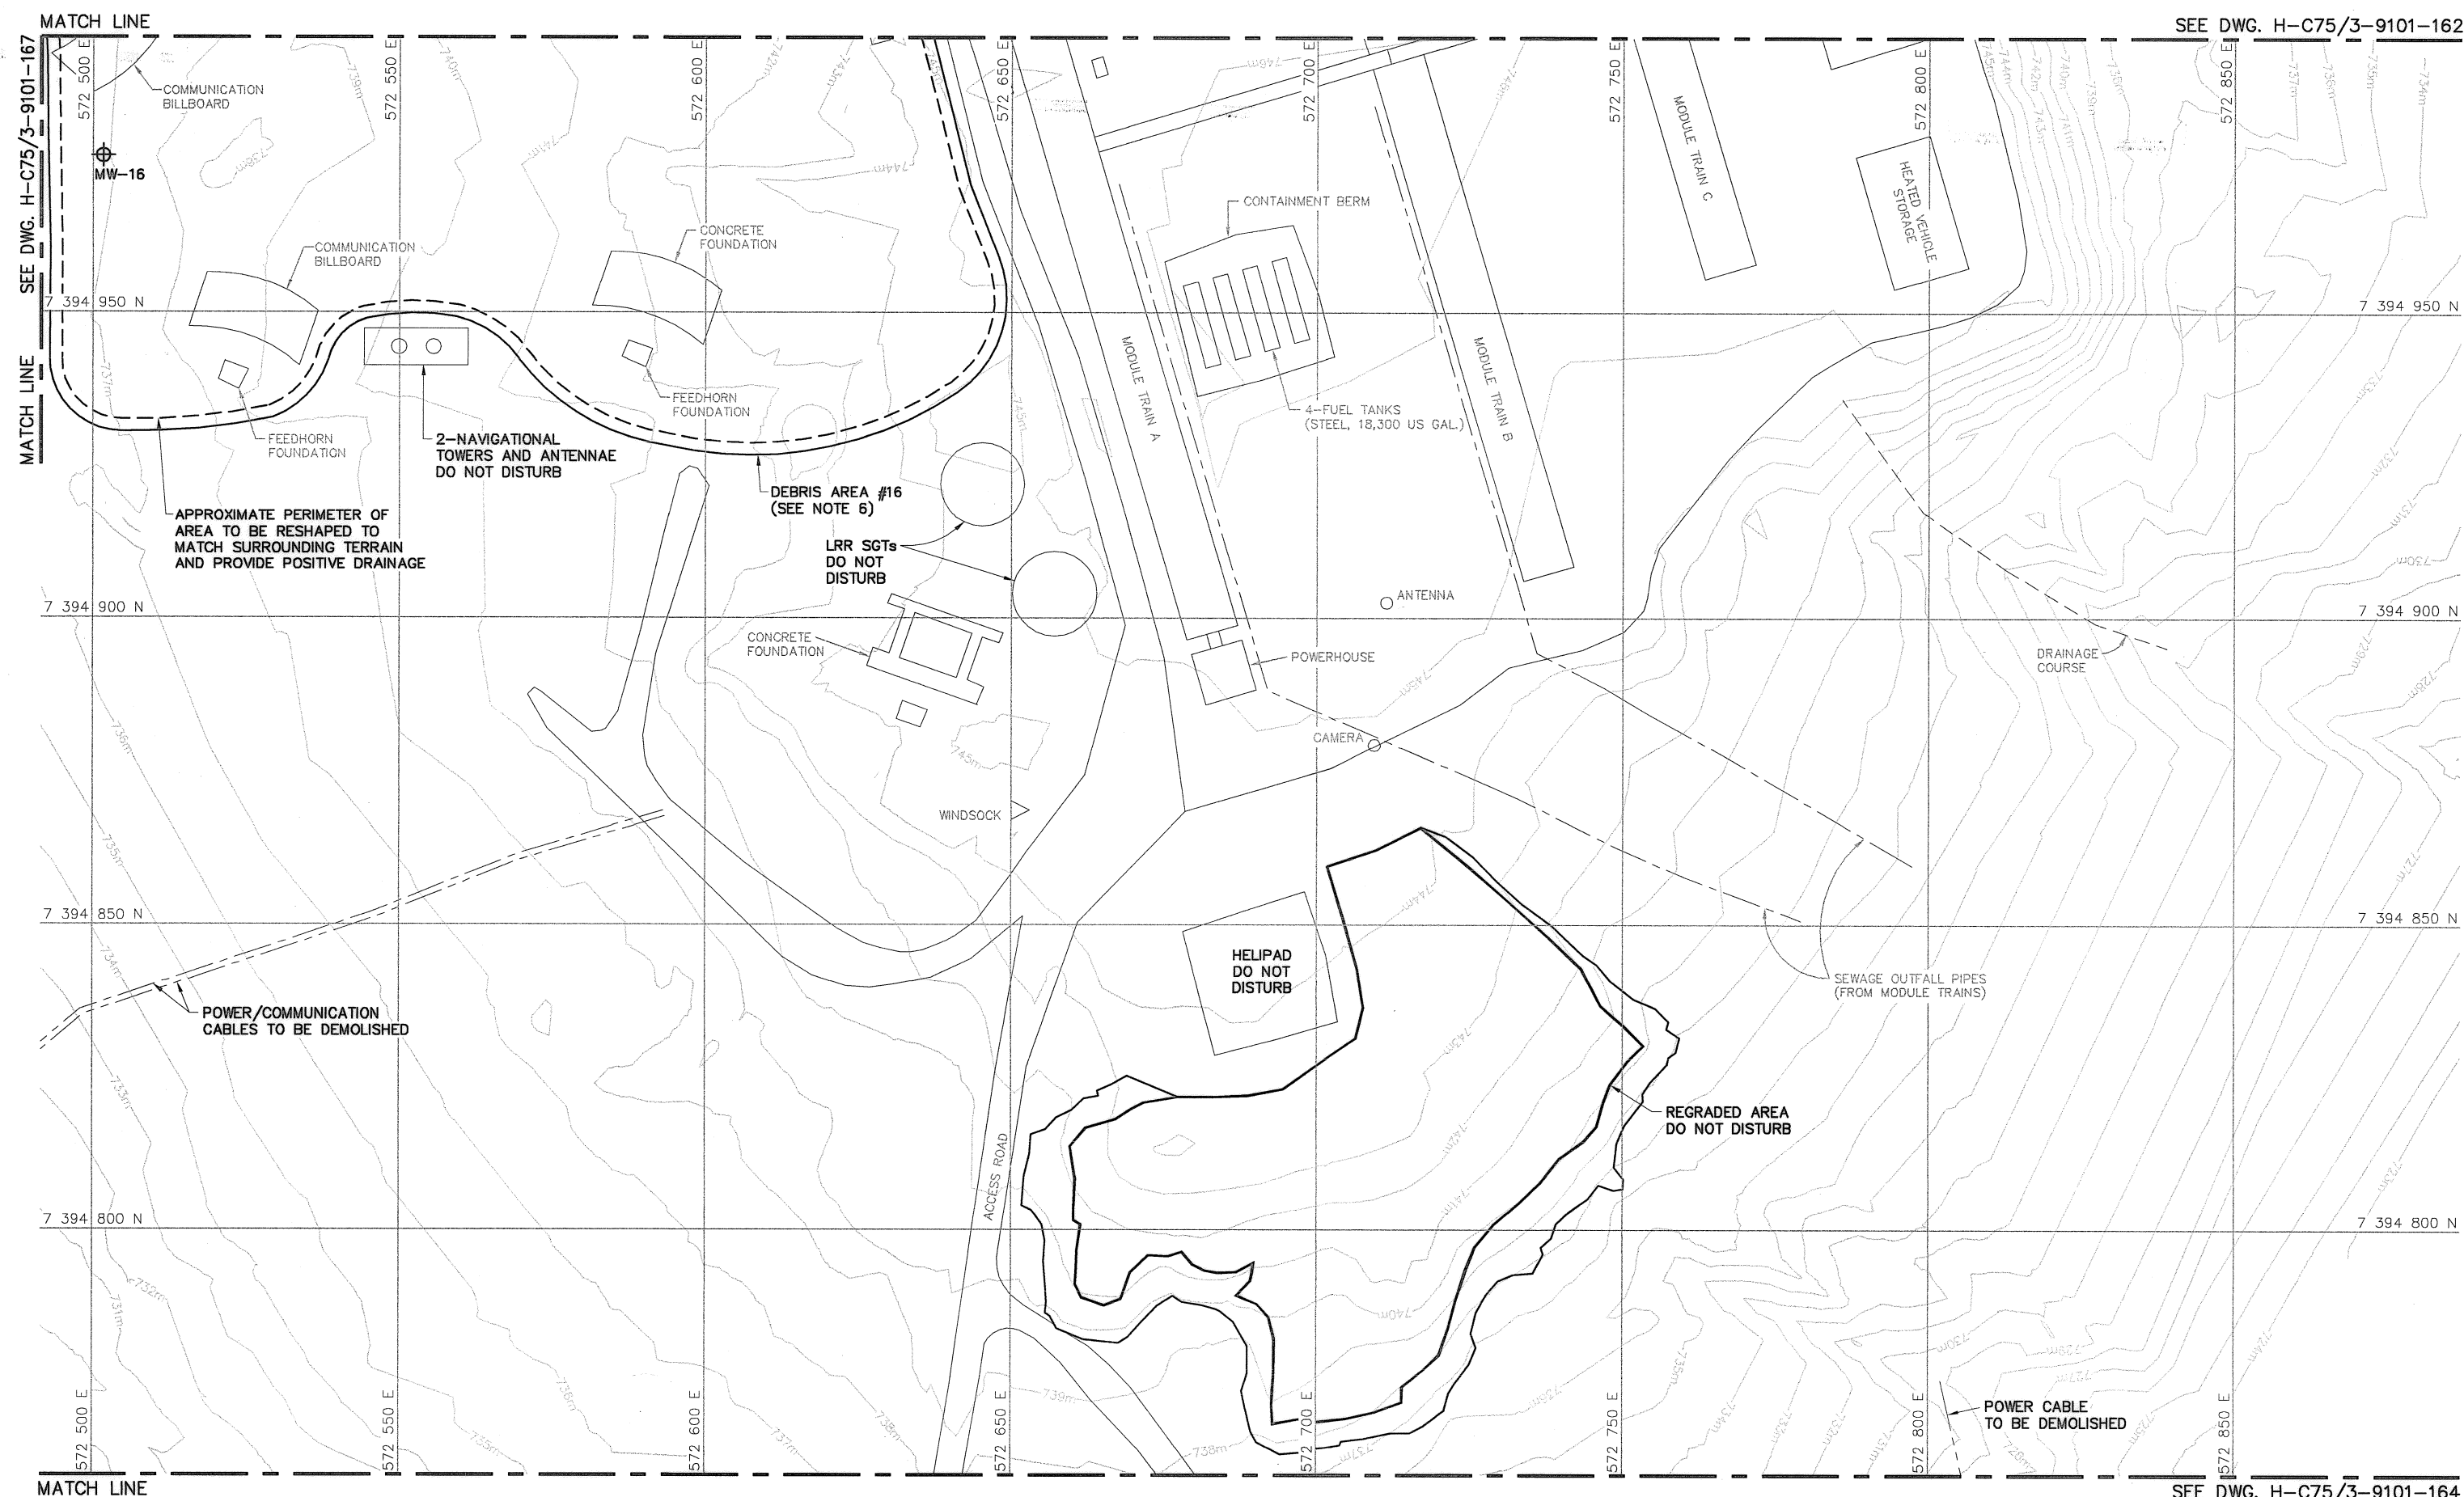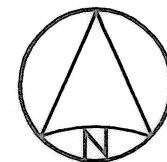

SEE DWG. H-C75/3-9101-162

SEE DWG. H-C75/3-9101-164

General Notes:

1. ALL COORDINATES ARE REFERENCED TO UTM ZONE 20N, NAD83. ELEVATIONS ARE REFERENCED TO MEAN SEA LEVEL RELATIVE TO GEOID MODEL CANADIAN HT2.0.
2. ALL DIMENSIONS ARE IN METRES UNLESS NOTED OTHERWISE.
3. ALL NON-HAZARDOUS DEBRIS WITHIN PLAN AREA TO BE PLACED IN UPPER SITE NON-HAZARDOUS WASTE LANDFILL.
4. REFER TO TABLE 02219-1 IN SPECIFICATIONS FOR DESCRIPTION OF DEBRIS AREAS.
5. ALL SURFACE DEBRIS IS TO BE REMOVED FROM ALL CONTAMINATED SOIL AREAS AND EXISTING LANDFILL AREAS PRIOR TO ANY FILL PLACEMENT OR EXCAVATION TAKING PLACE.
6. DEPTH OF BURIED DEBRIS EXCAVATION TO EXTEND TO THE BASE OF THE DEBRIS. LIMIT AND DEPTH OF BURIED DEBRIS EXCAVATION TO BE FIELD VERIFIED BY CONFIRMATORY TESTING AND EXCAVATION OF TESTPITS.
7. FOR PERMANENT SURVEY CONTROL (BENCHMARK) INSTALLATION DETAILS, SEE DWG. H-C75/3-9101-191.
8. FOR ENTIRE DEBRIS AREA LIMITS, SEE DWG. H-C75/3-9101-160.

Legend:

- BM-11 PERMANENT BENCHMARK LOCATION (1)
- 001 COORDINATE POINT
- TEST PIT LOCATION
- SITE INVESTIGATION MONITORING WELL LOCATION
- BURIED DEBRIS EXCAVATION AREA
- TYPE 1 GRANULAR FILL
- BODY OF WATER

No.	DATE	REVISION	REVISION	APPR.
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Date: [Date]
PERMIT NUMBER: P639
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HATCH

SCALE - ECHELLE 20 10 0 20 40 60m

PROJECT - PROJET
DYE-M CAPE DYER

DEW LINE CLEAN UP

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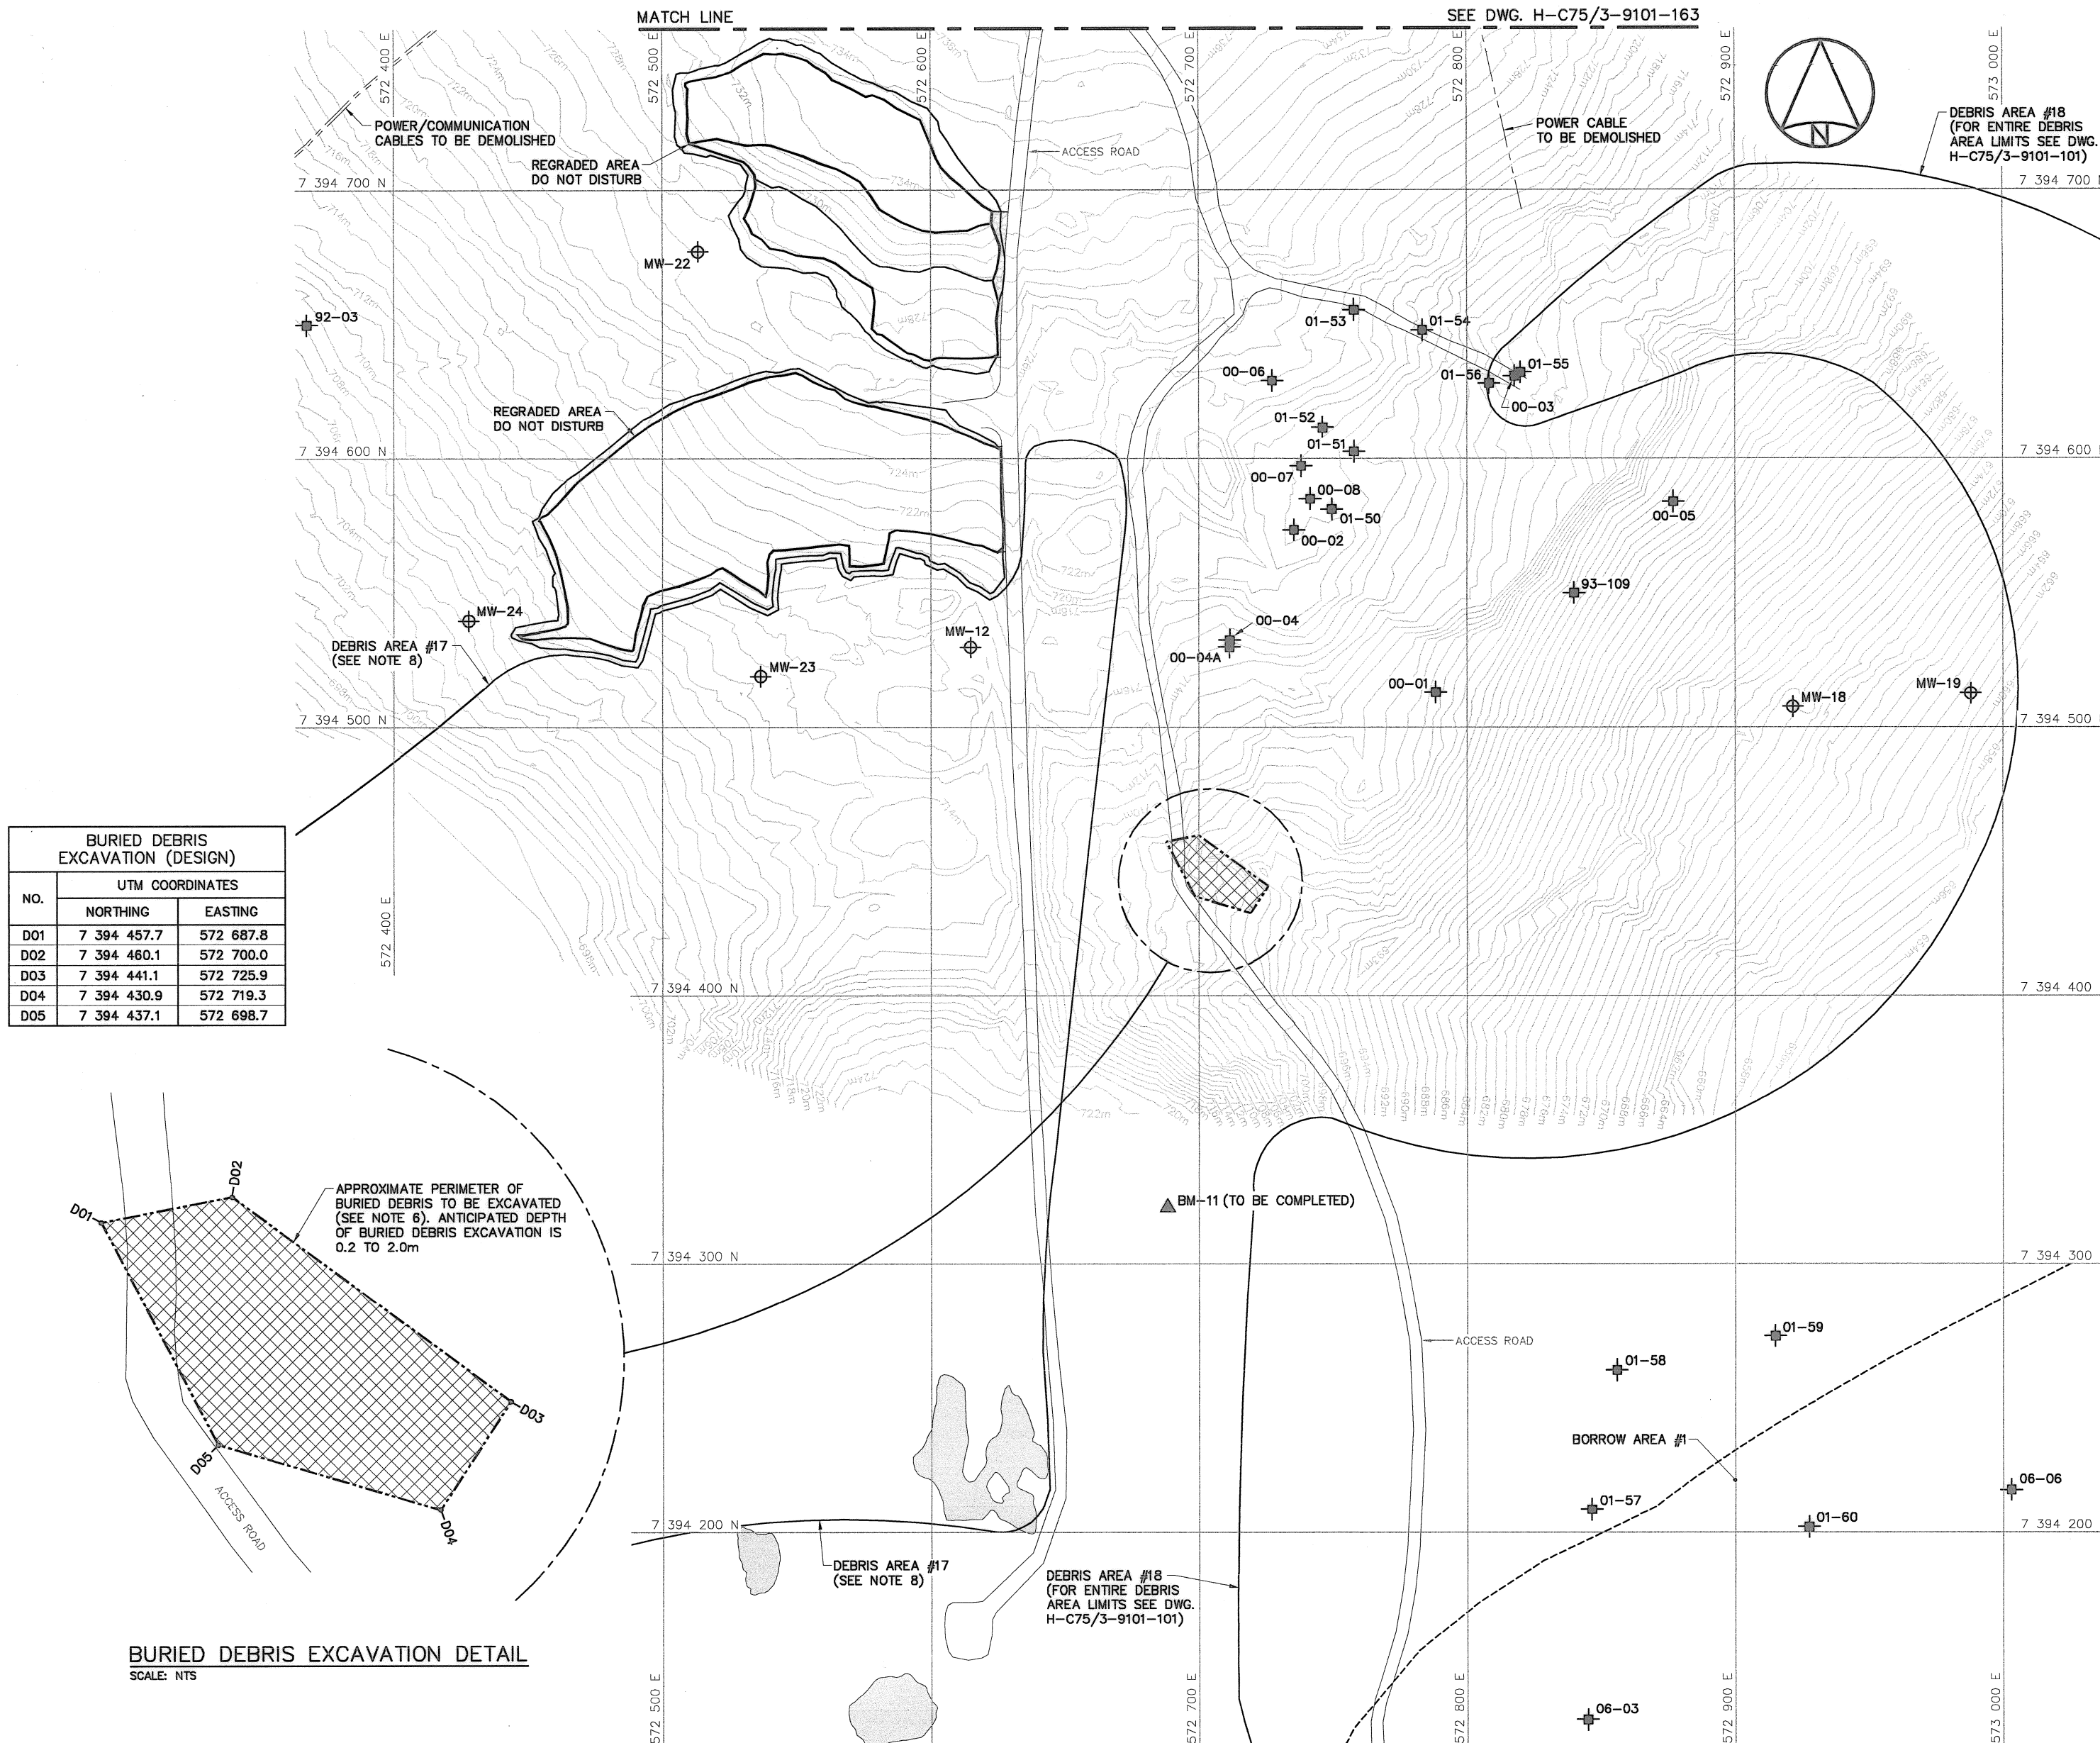
TRADE - METIER SITING DATE 2010-12-07

SUBJECT - SUJET
UPPER SITE
SOUTH LANDFILL AREA
PLAN


PRODUCTION	CONCURRENCE - ASSENTIMENT
DESIGNED ETUDIE DTH/THE	DES OFF AGENT CONCEPT
DRAWN DESSINE IC/CAE	SECT HD CHEF SECT
CHECKED VERIFIE DWF	DES MGR GEST CONCEPT
COORDINATION RRM	REVISED - REVU




DWG. NO. - DESSIN NO.
H-C75/3-9101-164

Canada



BURIED DEBRIS EXCAVATION DETAIL
SCALE: NTS

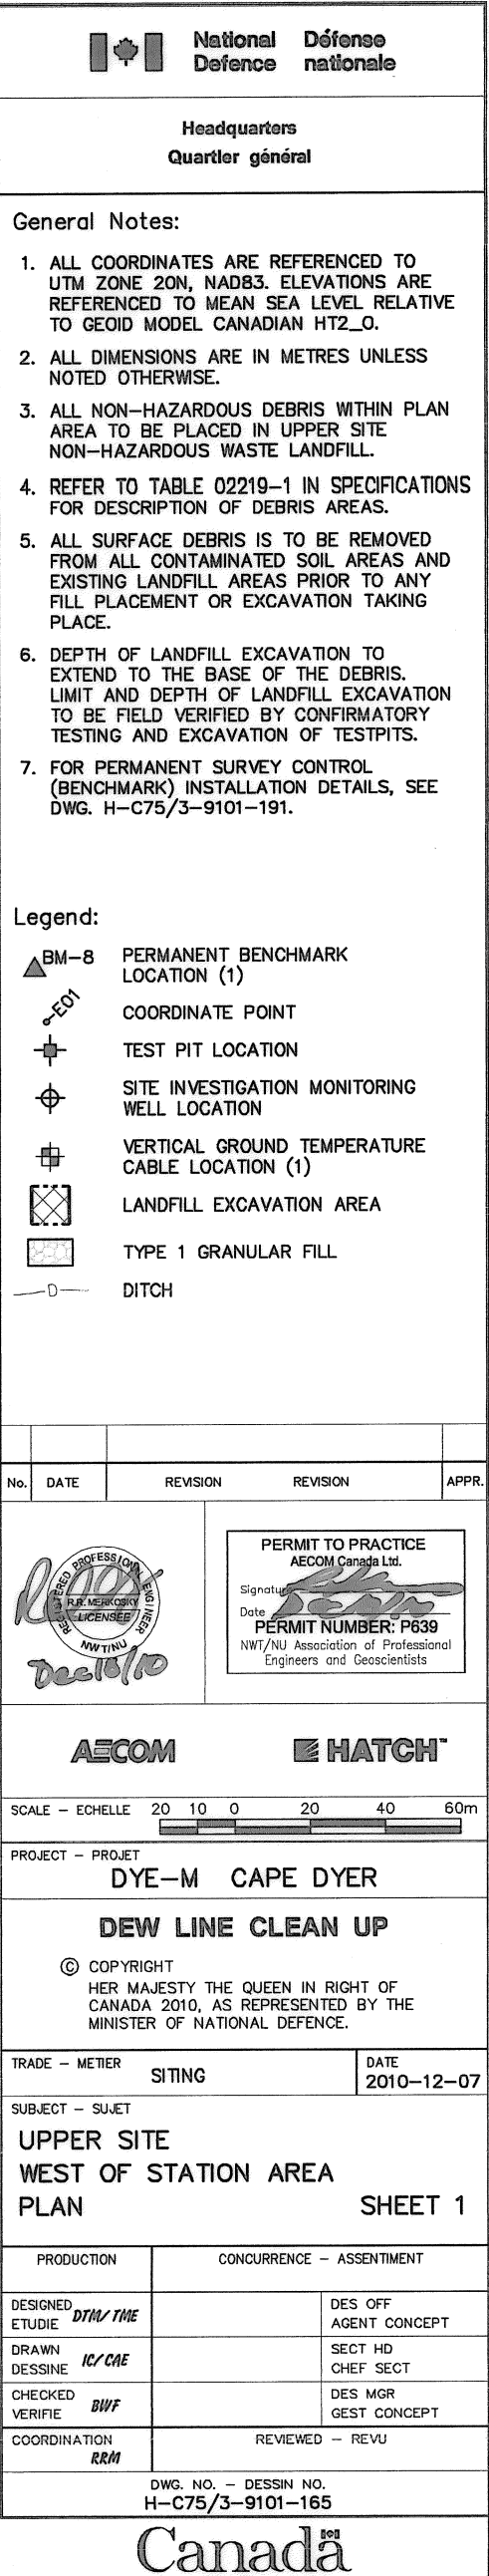

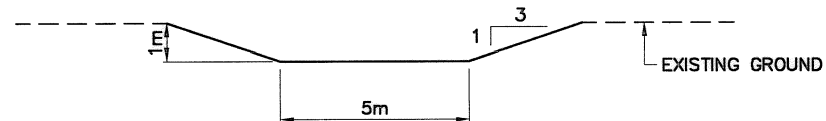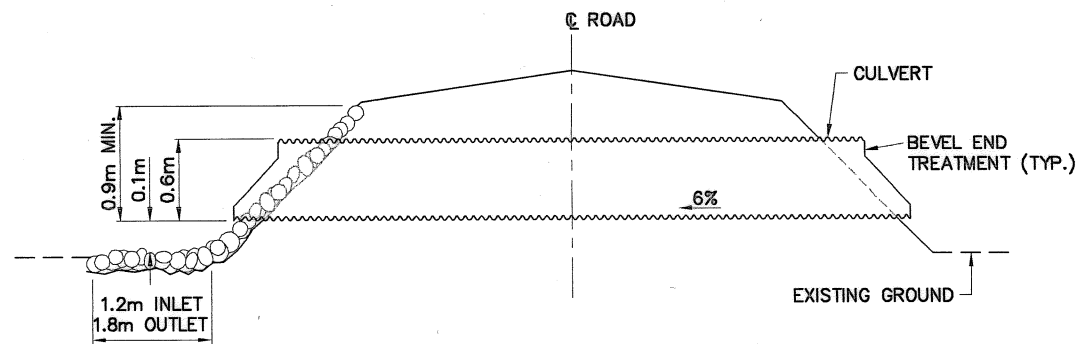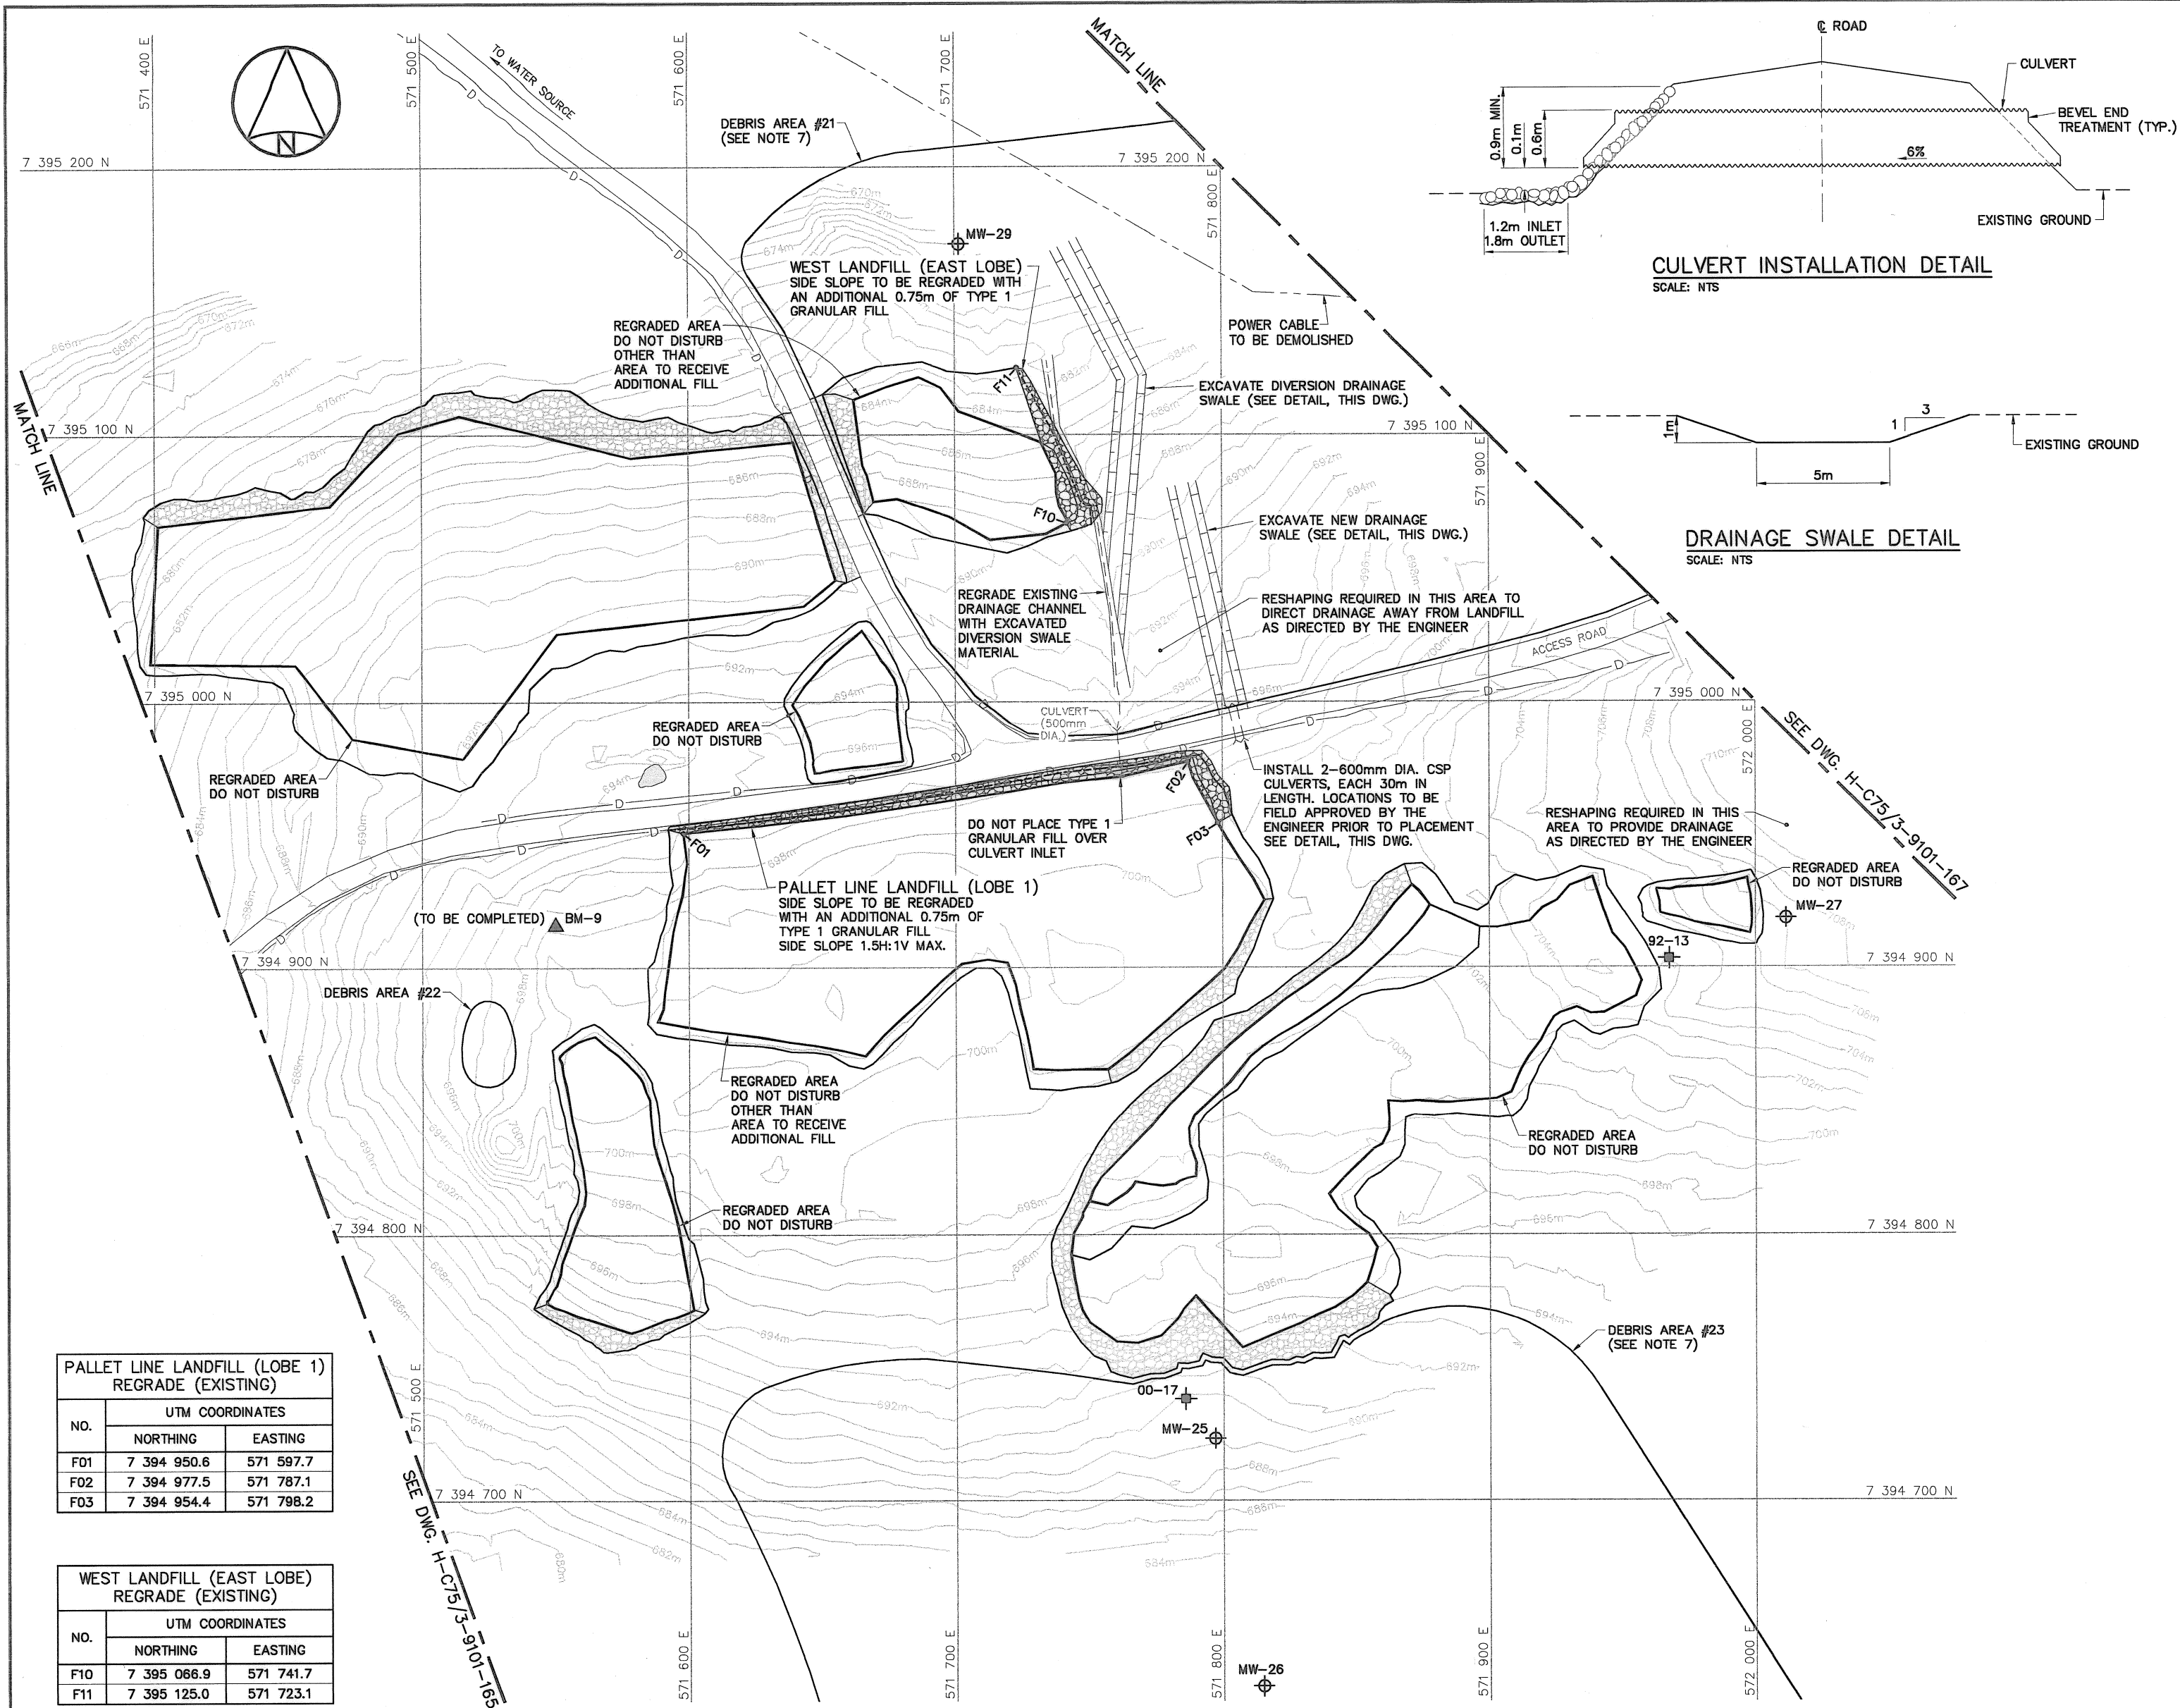

General Notes:

1. ALL COORDINATES ARE REFERENCED TO UTM ZONE 20N, NAD83. ELEVATIONS ARE REFERENCED TO MEAN SEA LEVEL RELATIVE TO GEOID MODEL CANADIAN HT2_0.
2. ALL DIMENSIONS ARE IN METRES UNLESS NOTED OTHERWISE.
3. ALL NON-HAZARDOUS DEBRIS WITHIN PLAN AREA TO BE PLACED IN UPPER SITE NON-HAZARDOUS WASTE LANDFILL.
4. REFER TO TABLE 02219-1 IN SPECIFICATIONS FOR DESCRIPTION OF DEBRIS AREAS.
5. ALL SURFACE DEBRIS IS TO BE REMOVED FROM ALL CONTAMINATED SOIL AREAS AND EXISTING LANDFILL AREAS PRIOR TO ANY FILL PLACEMENT OR EXCAVATION TAKING PLACE.
6. FOR PERMANENT SURVEY CONTROL (BENCHMARK) INSTALLATION DETAILS, SEE DWG. H-C75/3-9101-191.
7. FOR ENTIRE DEBRIS AREA LIMITS, SEE DWG. H-C75/3-9101-160.

Legend:

- ▲ BM-9 PERMANENT BENCHMARK LOCATION (1)
- + F01 COORDINATE POINT
- ⊕ TEST PIT LOCATION
- ⊗ SITE INVESTIGATION MONITORING WELL LOCATION
- ▨ TYPE 1 GRANULAR FILL
- D DITCH

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SCALE - ECHELLE 20 10 0 20 40 60m

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SUBJECT - SUJET

UPPER SITE
WEST OF STATION AREA
PLAN SHEET 2

PRODUCTION	CONCURRENCE - ASSENTIMENT
DESIGNED ETUDIE DTH/THE	DES OFF AGENT CONCEPT
DRAWN DESSINE IC/CAE	SECT HD CHEF SECT
CHECKED VERIFIE DWF	DES MGR GEST CONCEPT
COORDINATION RRM	REVIEWED - REVU

DWG. NO. - DESSIN NO.
H-C75/3-9101-166

PALLET LINE LANDFILL (LOBE 1) REGRADE (EXISTING)		
NO.	UTM COORDINATES	
	NORTHING	EASTING
F01	7 394 950.6	571 597.7
F02	7 394 977.5	571 787.1
F03	7 394 954.4	571 798.2

WEST LANDFILL (EAST LOBE) REGRADE (EXISTING)		
NO.	UTM COORDINATES	
	NORTHING	EASTING
F10	7 395 066.9	571 741.7
F11	7 395 125.0	571 723.1

General Notes:

1. ALL COORDINATES ARE REFERENCED TO UTM ZONE 20N, NAD83. ELEVATIONS ARE REFERENCED TO MEAN SEA LEVEL RELATIVE TO GEOID MODEL CANADIAN HT2.0.
2. ALL DIMENSIONS ARE IN METRES UNLESS NOTED OTHERWISE.
3. ALL NON-HAZARDOUS DEBRIS WITHIN PLAN AREA TO BE PLACED IN UPPER SITE NON-HAZARDOUS WASTE LANDFILL.
4. REFER TO TABLE 02219-1 IN SPECIFICATIONS FOR DESCRIPTION OF DEBRIS AREAS.
5. ALL SURFACE DEBRIS IS TO BE REMOVED FROM ALL CONTAMINATED SOIL AREAS AND EXISTING LANDFILL AREAS PRIOR TO ANY FILL PLACEMENT OR EXCAVATION TAKING PLACE.
6. FOR PERMANENT SURVEY CONTROL (BENCHMARK) INSTALLATION DETAILS, SEE DWG. H-C75/3-9101-191.
7. FOR ENTIRE DEBRIS AREA LIMITS, SEE DWG. H-C75/3-9101-160.
8. USE STOCKPILED TIER I SOIL FOR INTERMEDIATE COVER AS REQUIRED.

Legend:

- ▲ BM-10 PERMANENT BENCHMARK LOCATION (1)
- COORDINATE POINT
- ⊕ TEST PIT LOCATION
- ⊕ SITE INVESTIGATION MONITORING WELL LOCATION
- ⊕ MONITORING WELL LOCATION (3)
- ⊕ BACKGROUND MONITORING WELL LOCATION (1)
- TYPE 1 GRANULAR FILL

No.	DATE	REVISION	REVISION	APPR.
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SCALE - ECHELLE 20 10 0 20 40 60m

PROJECT - PROJET
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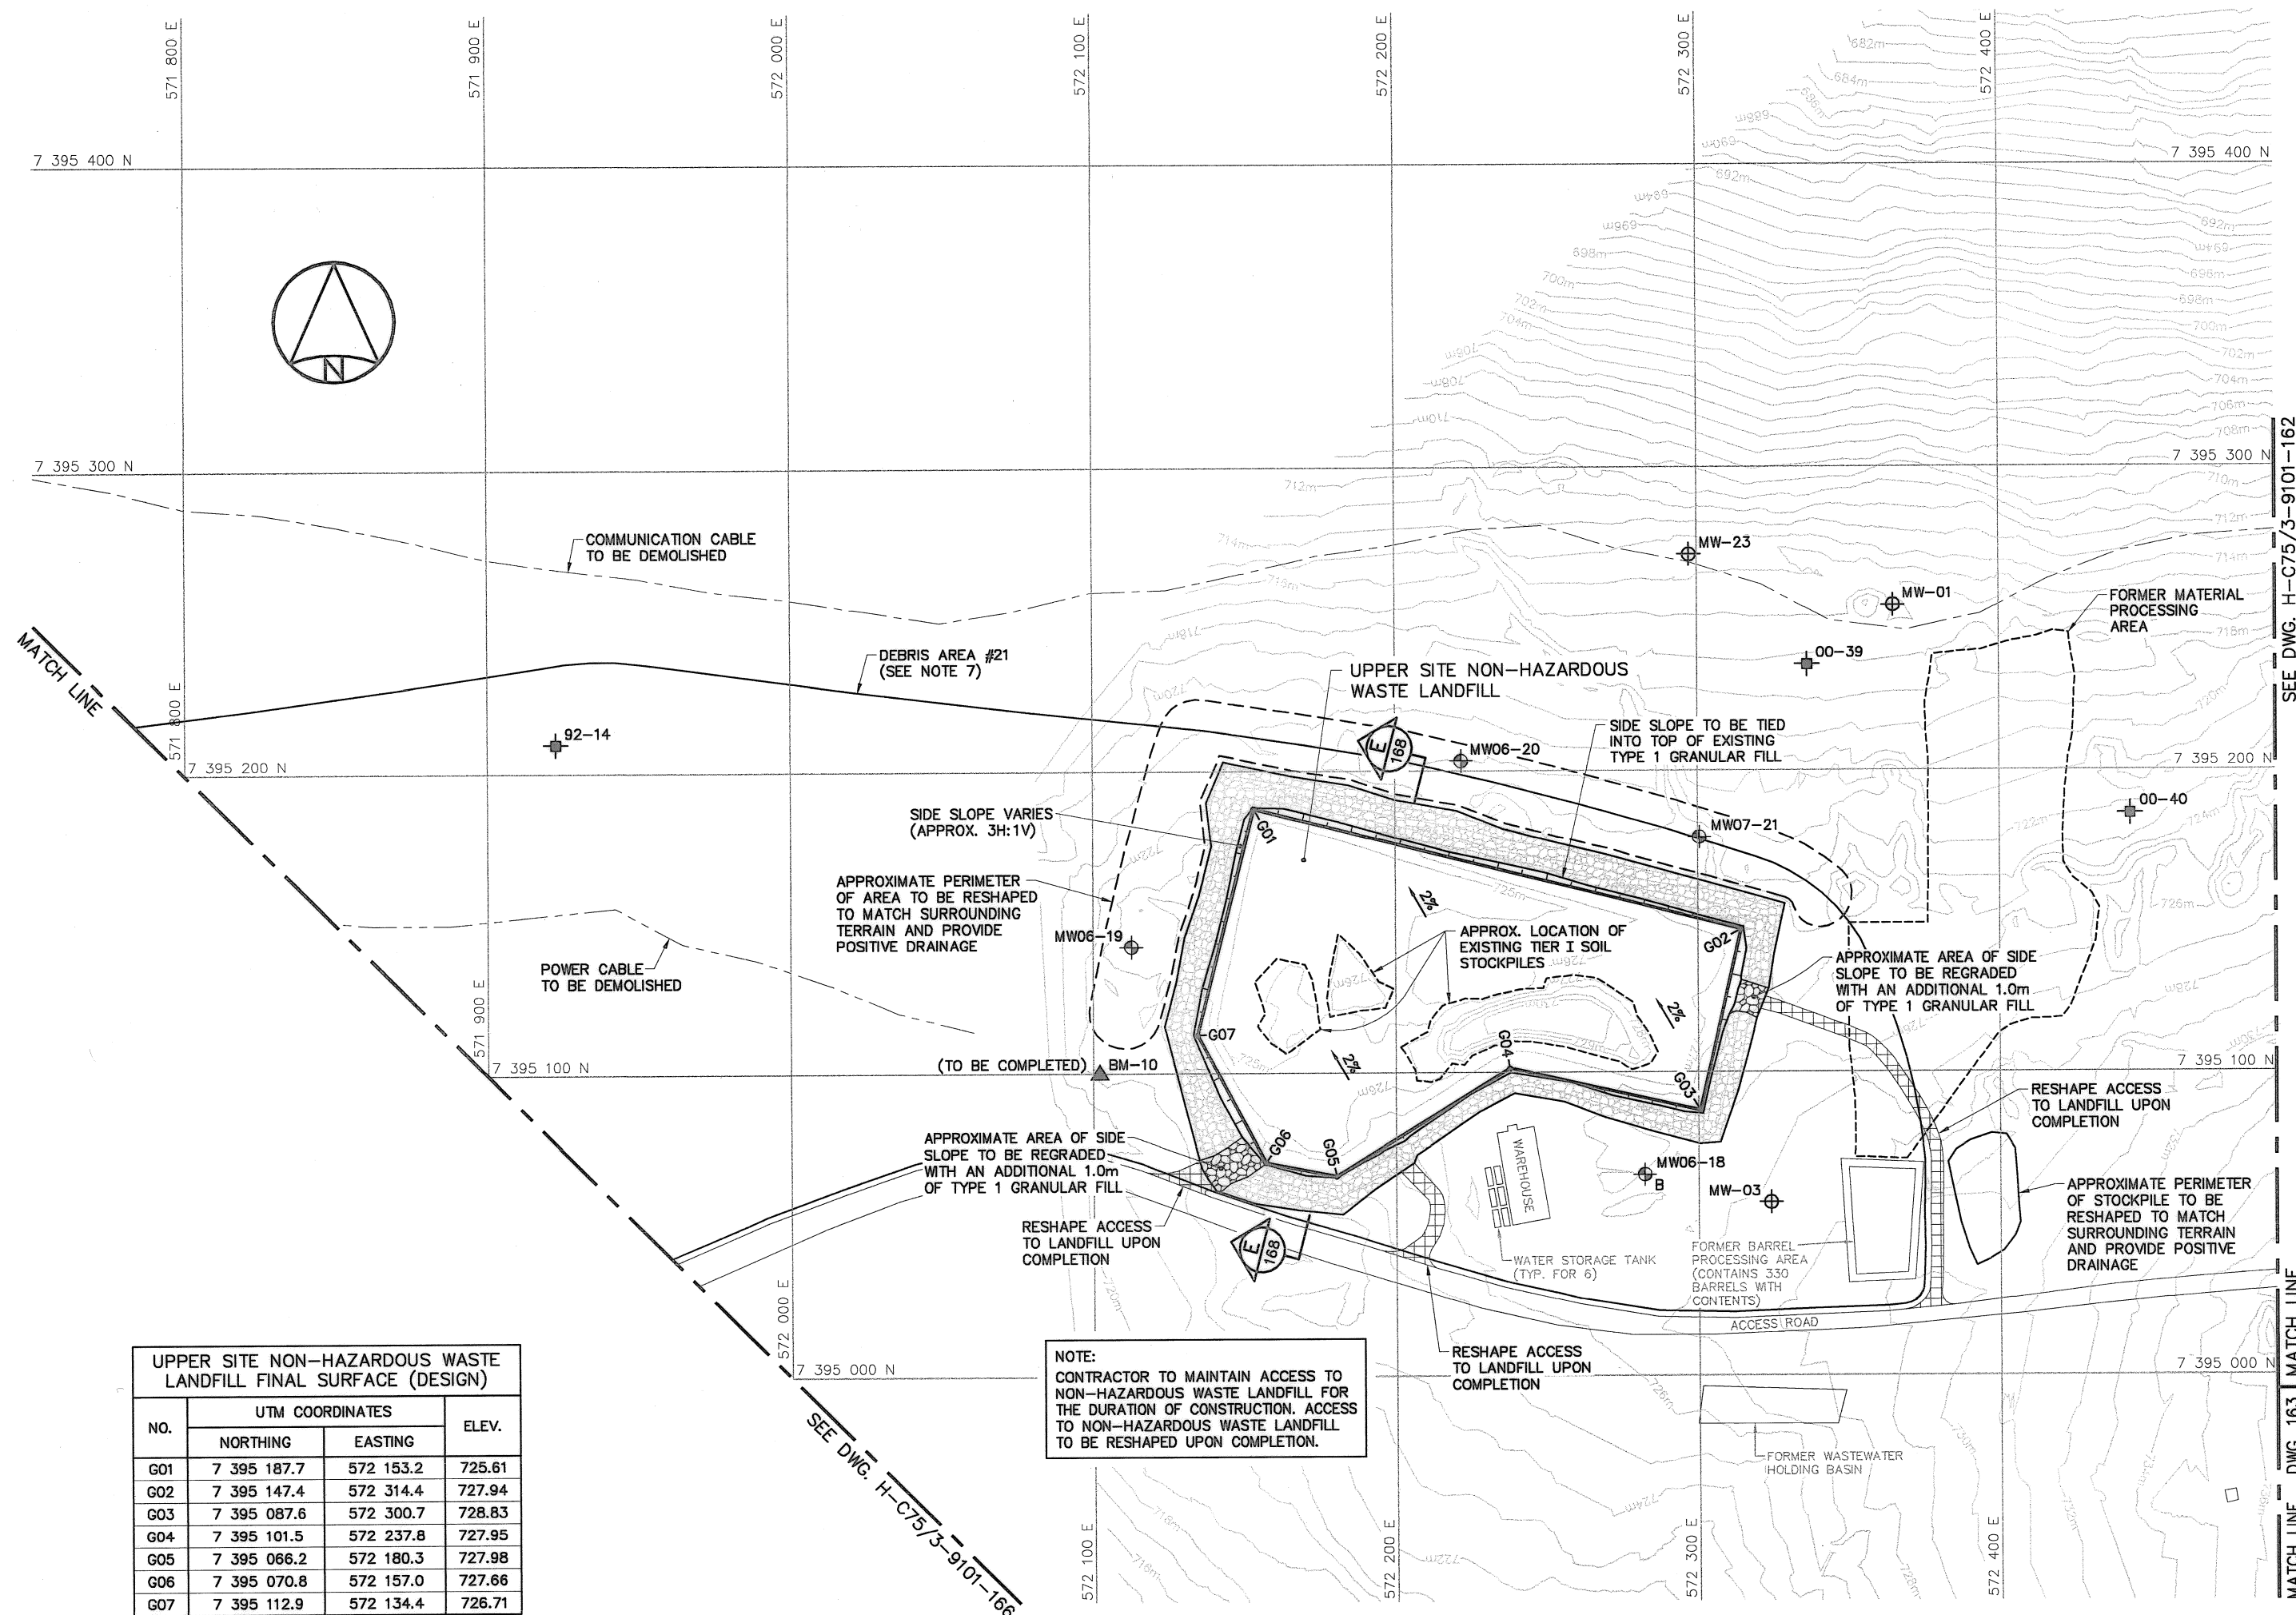
TRADE - METIER SITING DATE 2010-12-07

SUBJECT - SUJET
UPPER SITE
WEST OF STATION AREA
PLAN SHEET 3

PRODUCTION	CONCURRENCE - ASSENTIMENT
DESIGNED ETUDIE DTM/THE	DES OFF AGENT CONCEPT
DRAWN DESSINE IC/CAE	SECT HD CHEF SECT
CHECKED VERIFIE BWF	DES MGR GEST CONCEPT
COORDINATION RRM	REVIEWED - REVU

DWG. NO. - DESSIN NO.
H-C75/3-9101-167

Canada



UPPER SITE NON-HAZARDOUS WASTE LANDFILL FINAL SURFACE (DESIGN)			
NO.	UTM COORDINATES		ELEV.
	NORTHING	EASTING	
G01	7 395 187.7	572 153.2	725.61
G02	7 395 147.4	572 314.4	727.94
G03	7 395 087.6	572 300.7	728.83
G04	7 395 101.5	572 237.8	727.95
G05	7 395 066.2	572 180.3	727.98
G06	7 395 070.8	572 157.0	727.66
G07	7 395 112.9	572 134.4	726.71

NOTE:
CONTRACTOR TO MAINTAIN ACCESS TO
NON-HAZARDOUS WASTE LANDFILL FOR
THE DURATION OF CONSTRUCTION. ACCESS
TO NON-HAZARDOUS WASTE LANDFILL
TO BE RESHAPED UPON COMPLETION.

General Notes:

1. ALL COORDINATES ARE REFERENCED TO UTM ZONE 20N, NAD83. ELEVATIONS ARE REFERENCED TO MEAN SEA LEVEL RELATIVE TO GEOID MODEL CANADIAN HT2_0.
2. ALL DIMENSIONS ARE IN METRES UNLESS NOTED OTHERWISE.
3. VARIABLE SLOPE ON LANDFILL SURFACE PERMITTED. MINIMUM 2% - MAXIMUM 4%.

Legend:

- DESIGN REQUIREMENTS TO BE CONSTRUCTED
- GENERATED BASED ON EXISTING SURVEY INFORMATION
- GENERATED BASED ON ORIGINAL SURVEY INFORMATION

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SCALE - ECHELLE 2 1 0 2 4 6m

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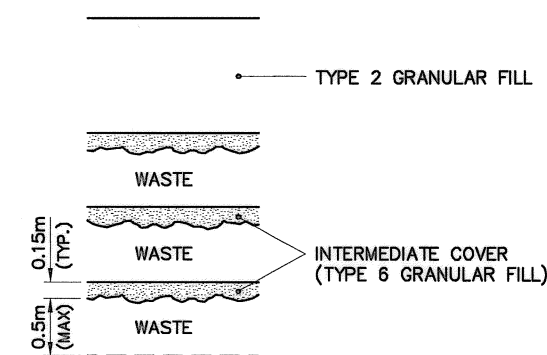
SUBJECT - SUJET
UPPER SITE
NON-HAZARDOUS WASTE LANDFILL
CROSS SECTION

PRODUCTION	CONCURRENCE - ASSENTIMENT
DESIGNED ETUDIE DTH/THE	DES OFF AGENT CONCEPT
DRAWN DESSINE IC/CAE	SECT HD CHEF SECT
CHECKED VERIFIE DWF	DES MGR GEST CONCEPT
COORDINATION RRM	REVIEWED - REVU



DWG. NO. - DESSIN NO.
H-C75/3-9101-168

Canada


ADD ADDITIONAL WASTE LAYERS,
AS REQUIRED, TO ACHIEVE THE
NON-HAZARDOUS WASTE LANDFILL
DESIGN ELEVATIONS.





WASTE PLACEMENT DETAIL
N.T.S.

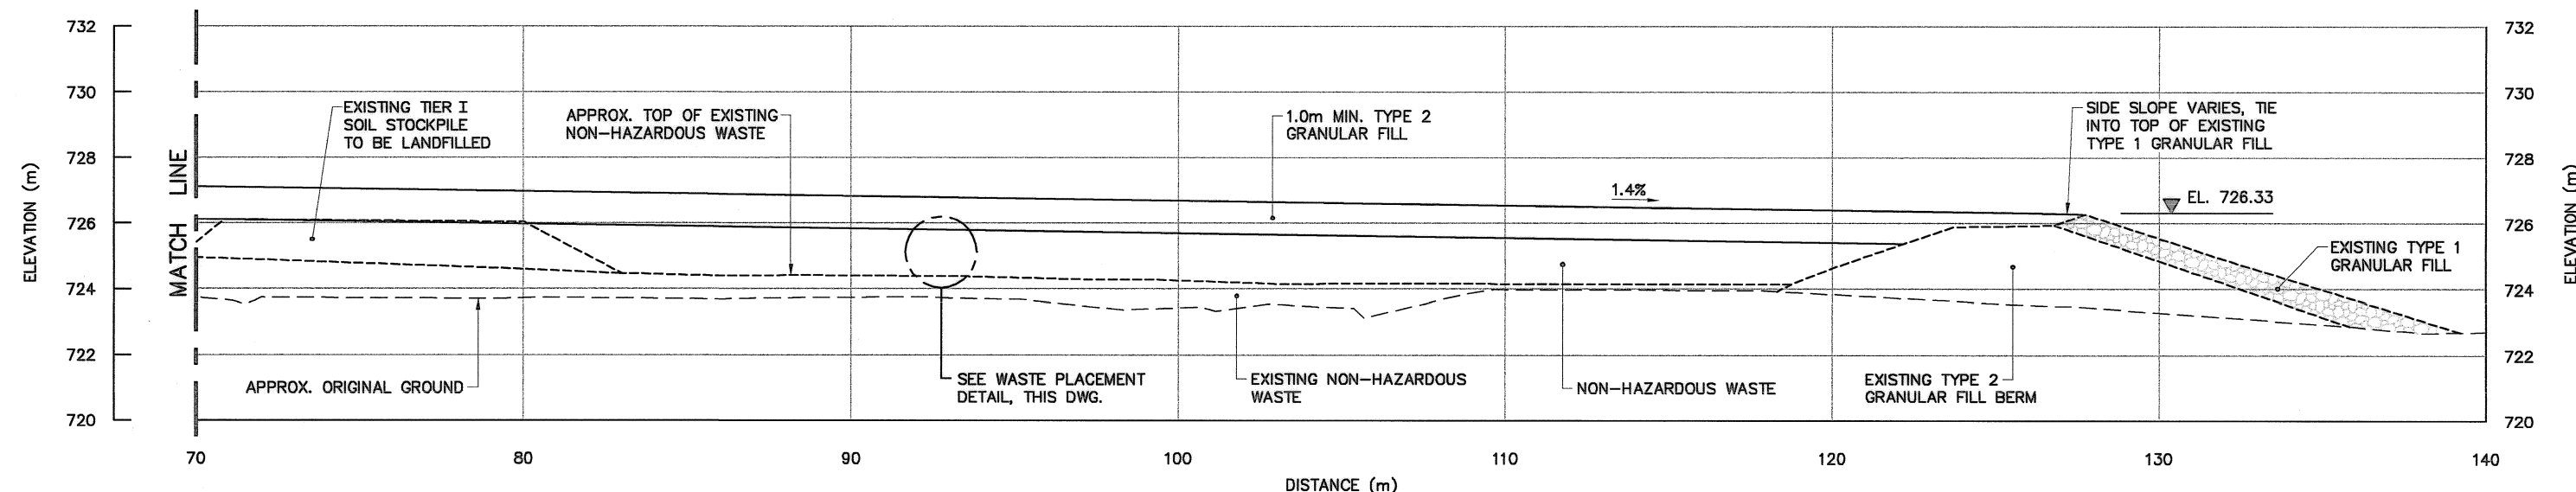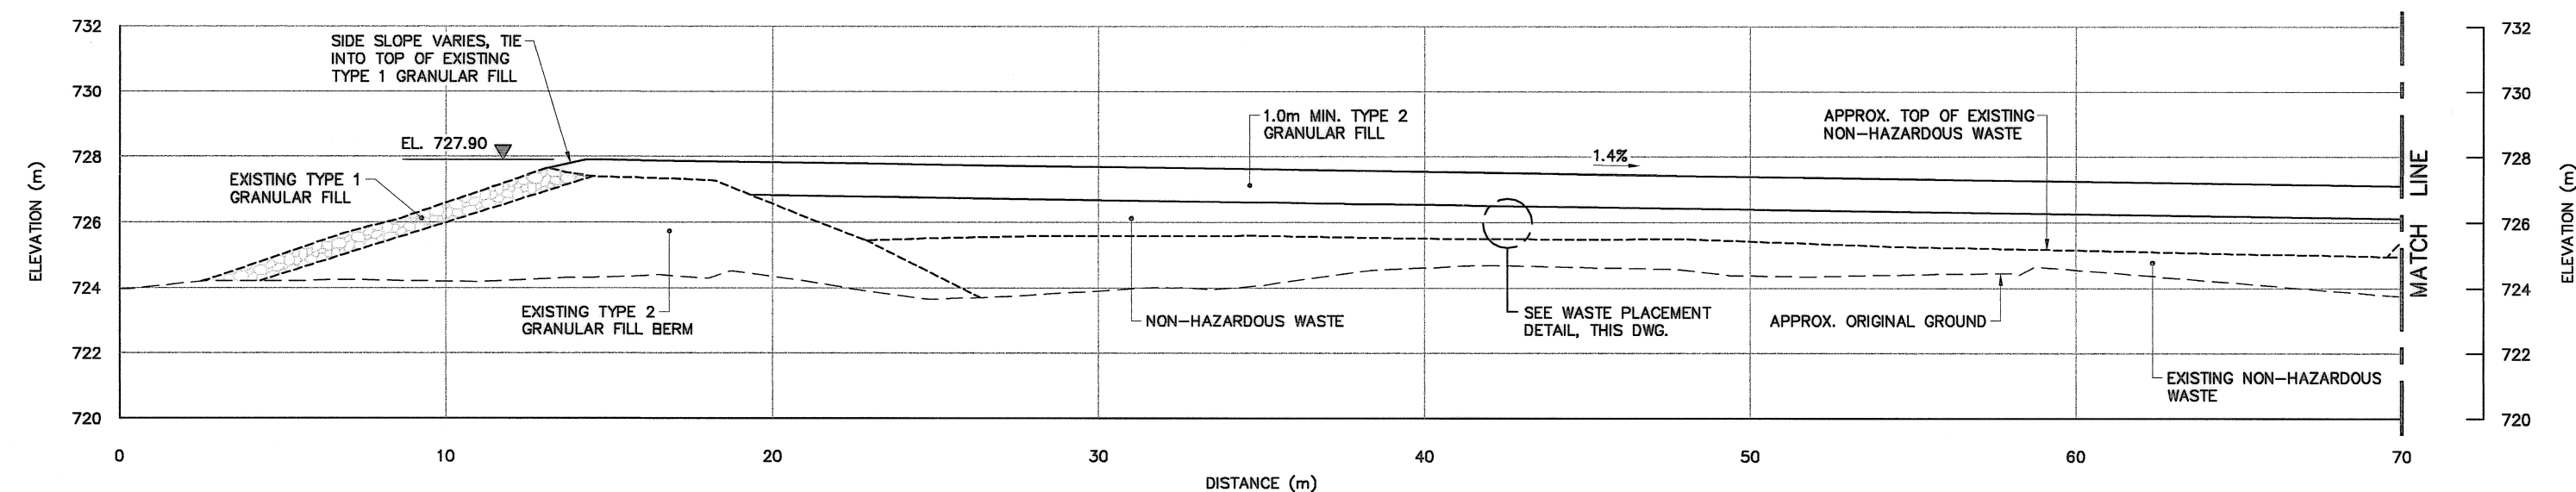


SECTION
E
167

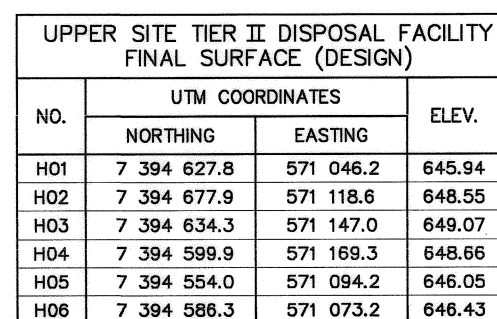

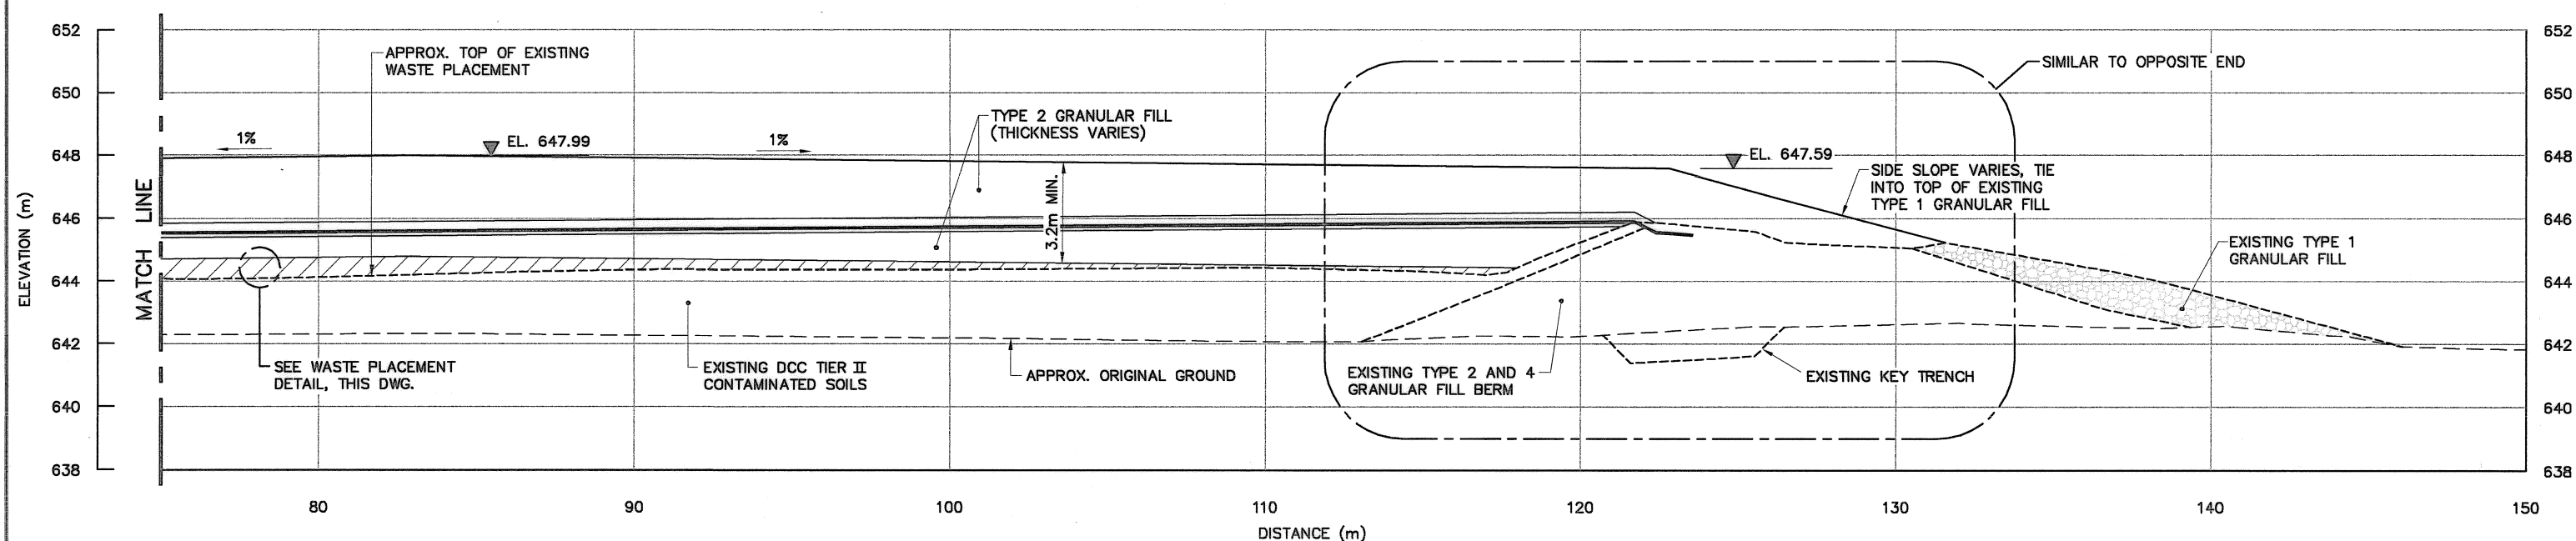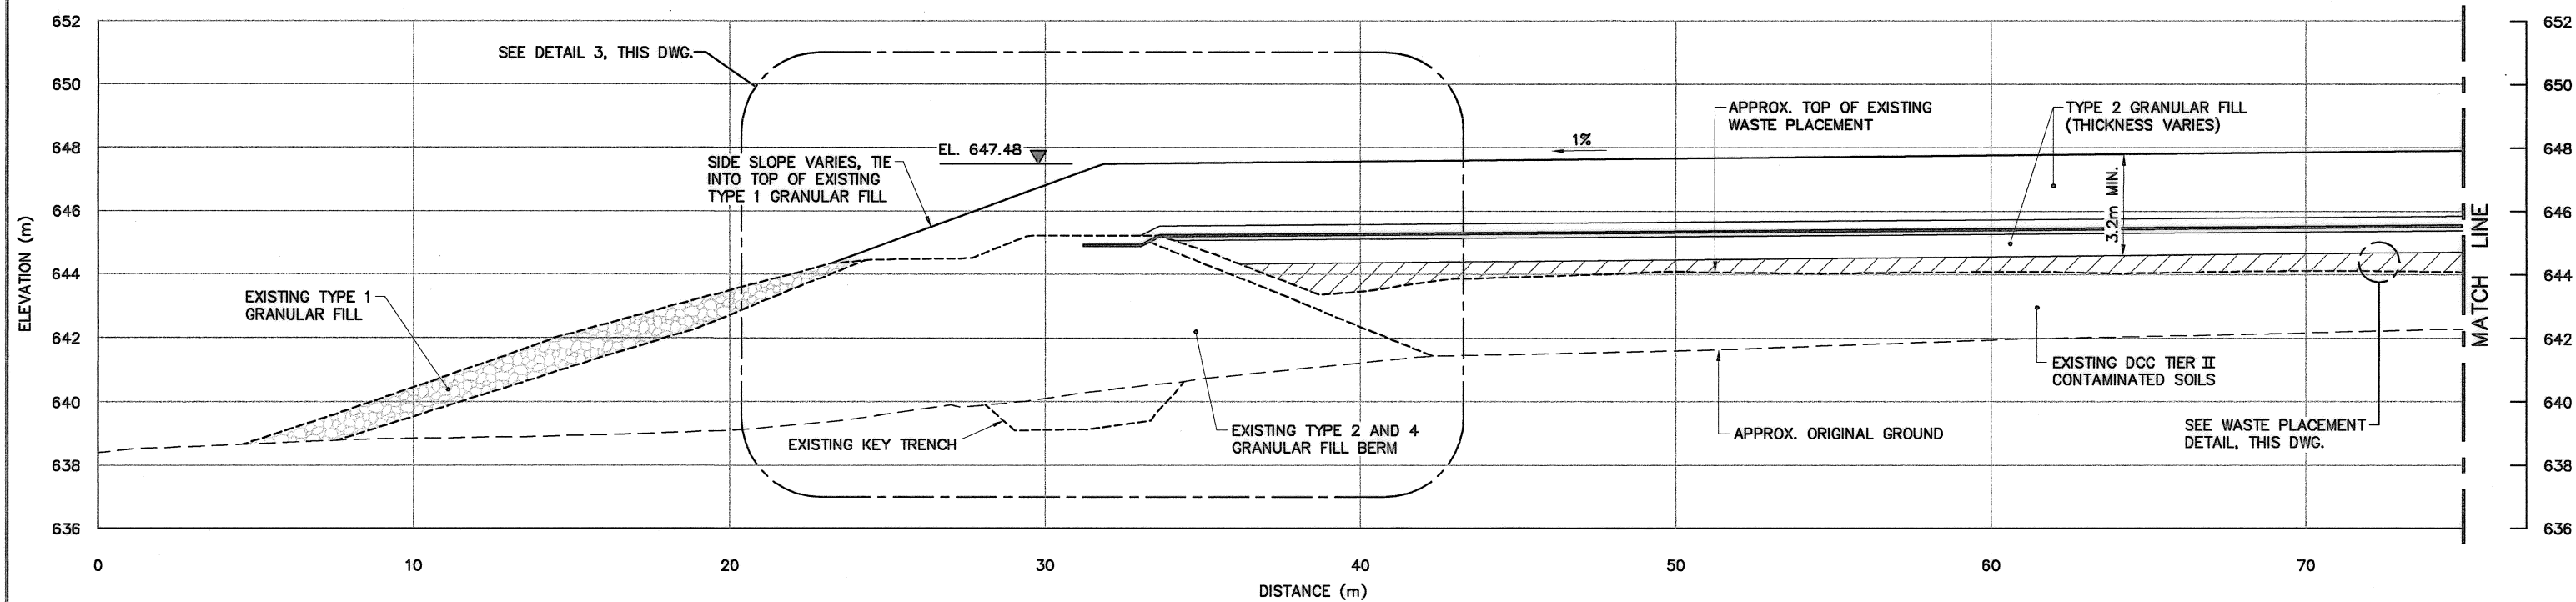


SECTION F 169

NOTE:
EXPOSE EXISTING COVERED GEOMEMBRANE ABOVE BERM AND CLEAN FOR WELDING. GEOMEMBRANES TO BE WELDED TOGETHER OVER TOP OF BERM.

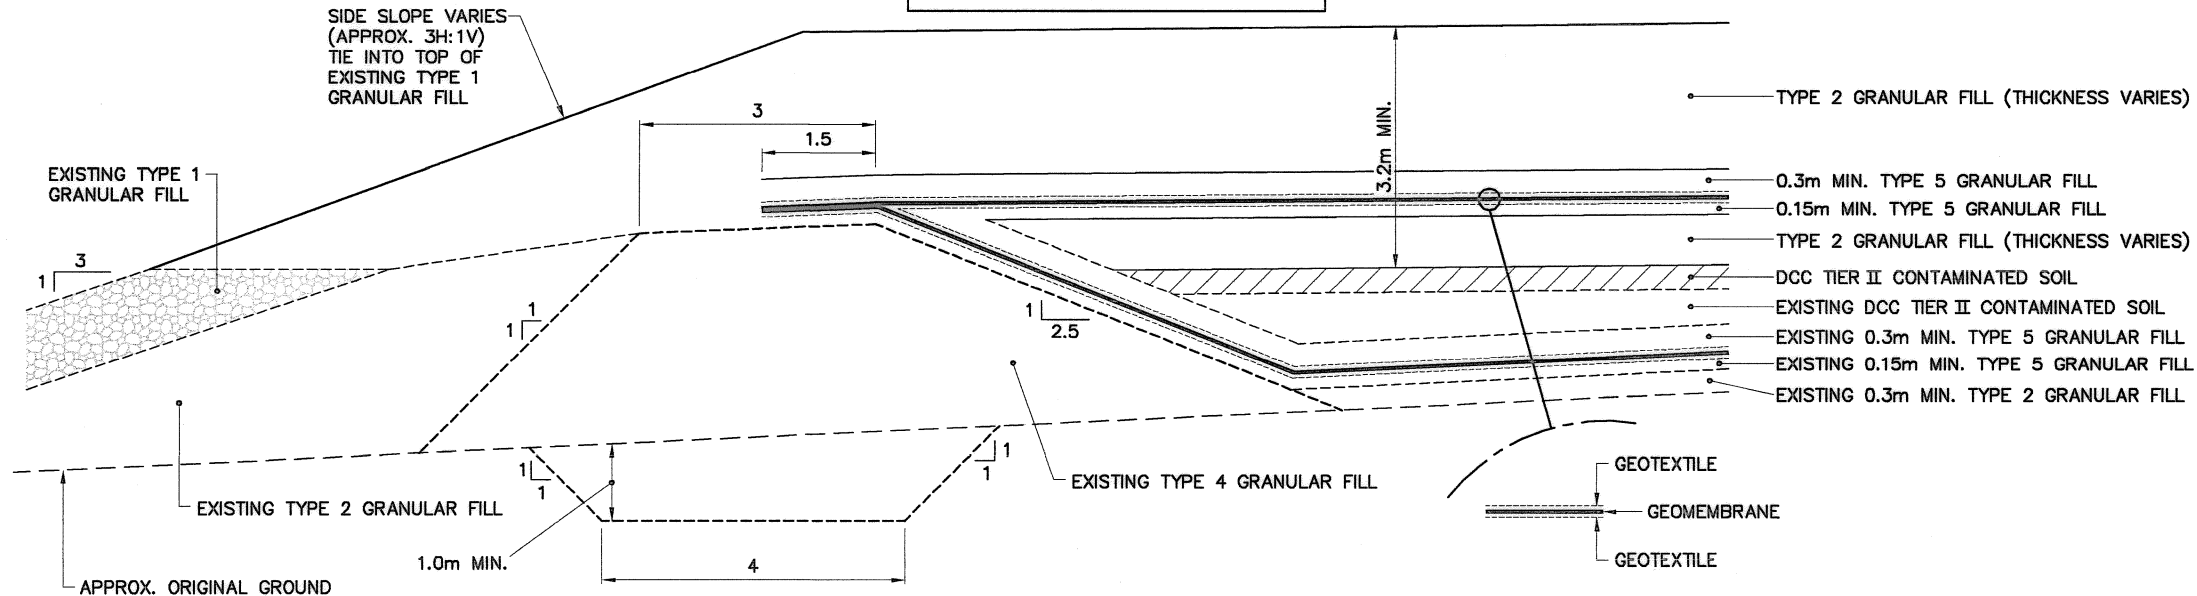

DETAIL 3 170

ADD ADDITIONAL TIER II LAYERS, AS REQUIRED, TO ACHIEVE THE TIER II DISPOSAL FACILITY DESIGN ELEVATIONS.

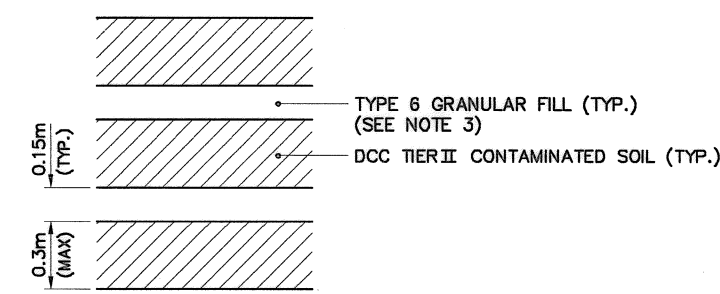

WASTE PLACEMENT DETAIL SCALE: NTS

General Notes:

1. ALL COORDINATES ARE REFERENCED TO UTM ZONE 20N, NAD83. ELEVATIONS ARE REFERENCED TO MEAN SEA LEVEL RELATIVE TO GEOID MODEL CANADIAN HTZ_0.
2. ALL DIMENSIONS ARE IN METRES UNLESS NOTED OTHERWISE.
3. TYPE 6 INTERMEDIATE FILL ONLY REQUIRED FOR LANDFILLING OF ORGANIC OR WET SOILS, AS DIRECTED BY THE ENGINEER.
4. PROTECT GEOMEMBRANE LINERS DURING CONSTRUCTION.

Legend:

- DESIGN REQUIREMENTS TO BE CONSTRUCTED
- GENERATED BASED ON EXISTING SURVEY INFORMATION
- GENERATED BASED ON ORIGINAL SURVEY INFORMATION

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SCALE - ECHELLE 2 1 0 2 4 6m

PROJECT - PROJET DYE-M CAPE DYER

DEW LINE CLEAN UP

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TRADE - METIER SITING DATE 2010-12-07

SUBJECT - SUJET UPPER SITE

TIER II DISPOSAL FACILITY CROSS SECTION

PRODUCTION	CONCURRENCE - ASSENTIMENT
DESIGNED ETUDIE DTH/TME	DES OFF AGENT CONCEPT
DRAWN DESSINE IC/CNE	SECT HD CHEF SECT
CHECKED VERIFIE DWF	DES MGR GEST CONCEPT
COORDINATION RRM	REVIEWED - REVU

DWG. NO. - DESSIN NO.
H-C75/3-9101-170



National
Défense


Headquarters
Quartier général


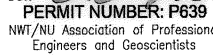
General Notes:

1. ALL DIMENSIONS ARE IN MILLIMETRES UNLESS NOTED OTHERWISE.
2. APPROXIMATE LOCATIONS FOR INSTRUMENTATION TO BE INSTALLED ARE SHOWN ON THE DRAWINGS. INSTALLATION LOCATIONS TO BE FIELD CONFIRMED BY THE ENGINEER.
3. PROVIDE THERMISTOR BEADS AT 0.5m MAXIMUM INTERVALS, INCLUDING ONE AT THE BOTTOM OF THE INSTALLATION.

Legend:

No.	DATE	REVISION	REVISION	APPR.
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Date: 
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SCALE - ECHELLE AS SHOWN

PROJECT - PROJET
DYE-M CAPE DYER

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TRADE - METIER SITING DATE 2010-12-07

SUBJECT - SUJET


MISCELLANEOUS DETAILS
SHEET 1

PRODUCTION	CONCURRENCE - ASSENTIMENT
DESIGNED ETUDIE DTM/THE	DES OFF AGENT CONCEPT
DRAWN DESSINE IC/DAE	SECT HD CHEF SECT
CHECKED VERIFIE DWF	DES MGR GEST CONCEPT
COORDINATION RRM	REVIEWED - REVU

DWG. NO. - DESSIN NO.
H-C75/3-9101-190


Canada

TABLE 1 VERTICAL GROUND TEMPERATURE CABLE INSTALLATION		
INSTRUMENT No.	APPROXIMATE DEPTH BELOW FINAL GRADE (m)	COMMENTS
LOWER SITE - TIER II DISPOSAL FACILITY		
VT-1	7.5	INSTALL THROUGH CENTERLINE BERM TO INVERT OF KEY TRENCH
VT-2	4.7	PVC STANDPIPE PREVIOUSLY INSTALLED TO 1m ABOVE ELEVATION OF BOTTOM LINER
VT-3	4.5	INSTALL TO 1m ABOVE ELEVATION OF BOTTOM LINER
VT-4	6.7	INSTALL THROUGH CENTERLINE BERM TO INVERT OF KEY TRENCH
UPPER SITE - TIER II DISPOSAL FACILITY		
VT-8	7.6	INSTALL THROUGH CENTERLINE BERM TO INVERT OF KEY TRENCH
VT-9	8.8	INSTALL THROUGH CENTERLINE BERM TO INVERT OF KEY TRENCH
VT-10	5.3	INSTALL TO 1m ABOVE ELEVATION OF BOTTOM LINER
VT-11	6.0	INSTALL THROUGH CENTERLINE BERM TO INVERT OF KEY TRENCH

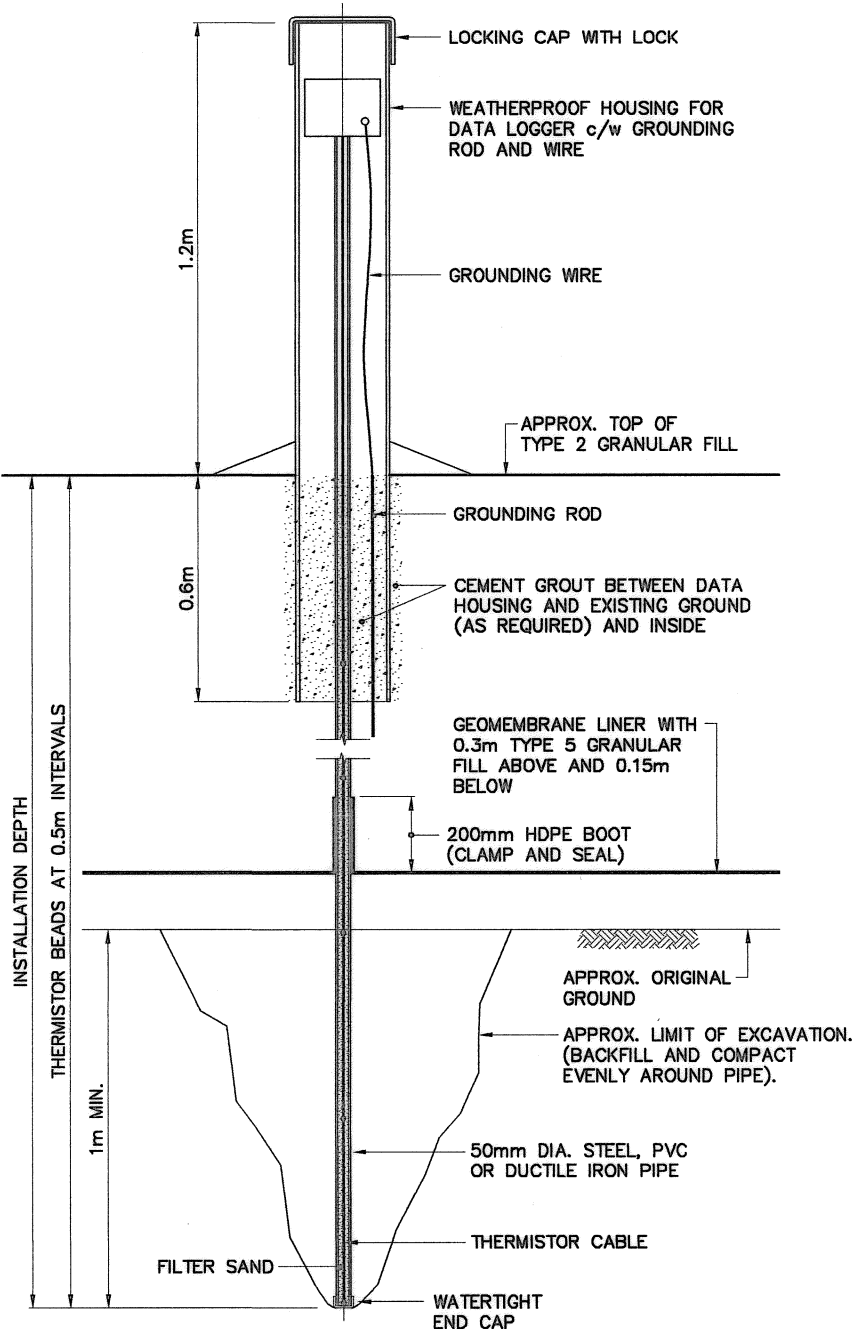

TYPICAL VERTICAL GROUND TEMPERATURE
CABLE INSTALLATION - PLATEAU

SCALE: NTS
VT-2, VT-3 AND VT-10

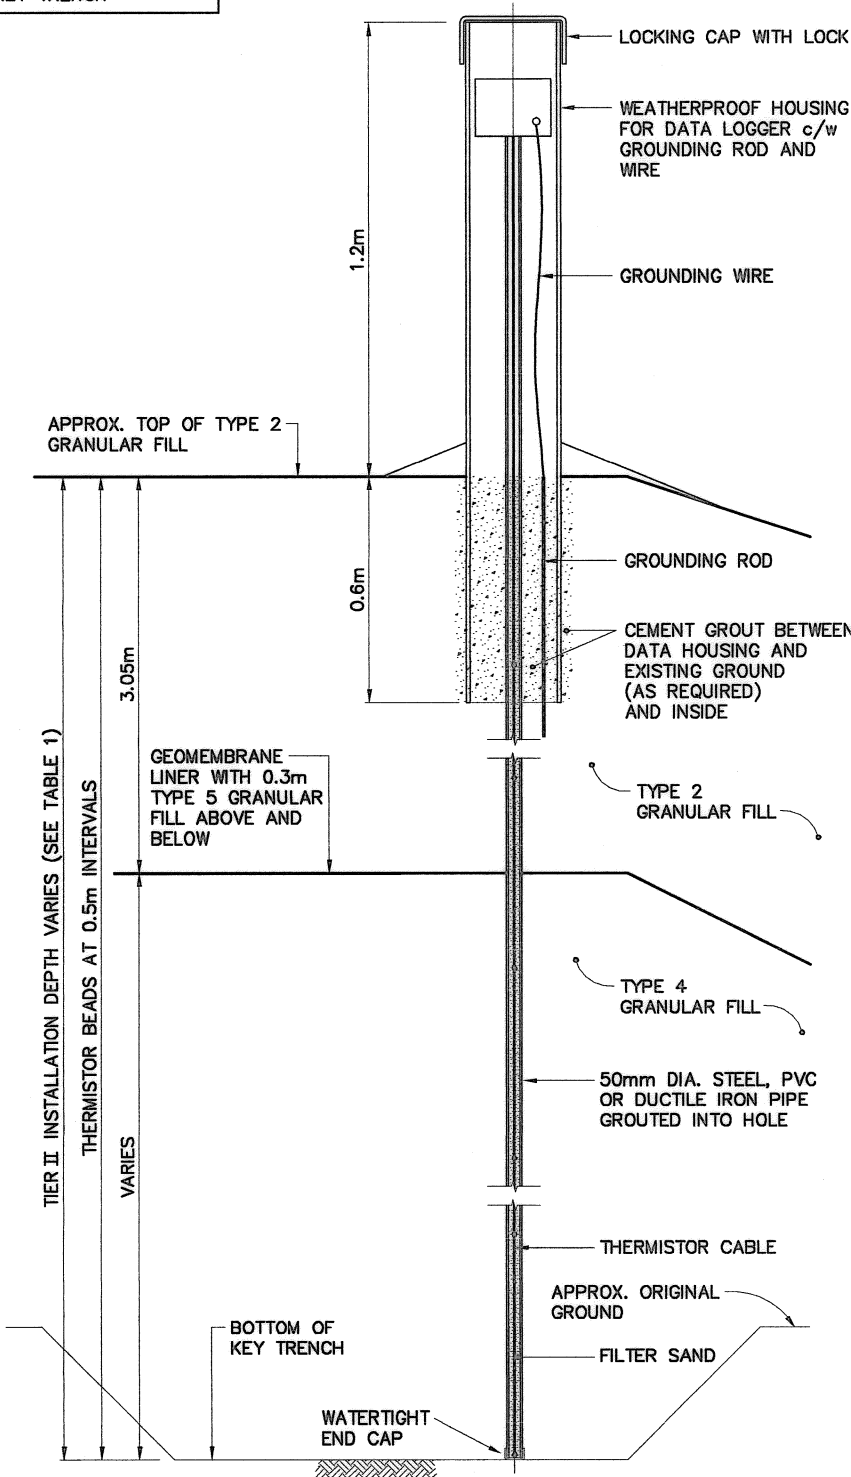

TYPICAL VERTICAL GROUND TEMPERATURE
CABLE INSTALLATION - TIER II


SCALE: NTS
LOWER AND UPPER SITE - TIER II DISPOSAL FACILITIES

General Notes:


1. ALL DIMENSIONS ARE IN MILLIMETRES UNLESS NOTED OTHERWISE.
2. APPROXIMATE LOCATIONS FOR INSTRUMENTATION TO BE INSTALLED ARE SHOWN ON THE DRAWINGS. INSTALLATION LOCATIONS TO BE FIELD CONFIRMED BY THE ENGINEER.


Legend:

No.	DATE	REVISION	REVISION	APPR.
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Date: 
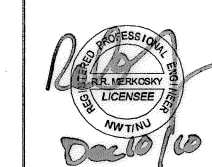
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SCALE - ECHELLE AS SHOWN

PROJECT - PROJET
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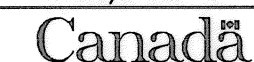
TRADE - METIER **SITING** DATE **2010-12-07**

SUBJECT - SUJET

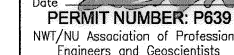
**MISCELLANEOUS DETAILS
SHEET 2**

PRODUCTION	CONCURRENCE - ASSENTIMENT
DESIGNED ETUDIE <i>DTM/TME</i>	DES OFF AGENT CONCEPT
DRAWN DESSINE <i>IC/CAE</i>	SECT HD CHEF SECT
CHECKED VERIFIE <i>BWF</i>	DES MGR GEST CONCEPT
COORDINATION <i>RRM</i>	REVIEWED - REVU


DWG. NO. - DESSIN NO.
H-C75/3-9101-191




NOTE:
6 PERMANENT SURVEY CONTROL
MONUMENTS PREVIOUSLY INSTALLED.
5 PERMANENT SURVEY CONTROL
MONUMENTS TO BE COMPLETED AT
MIDDLE AND UPPER SITES.

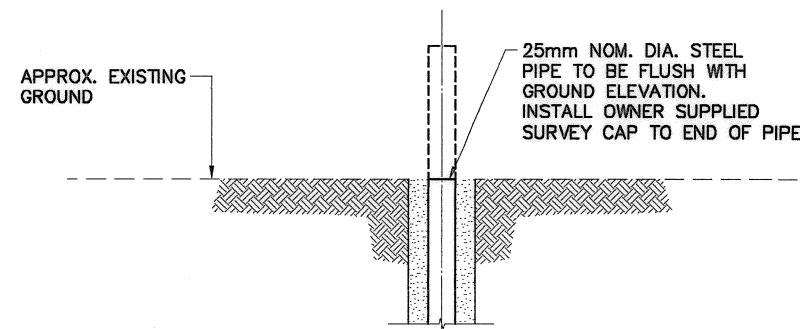

**TYPICAL PERMANENT SURVEY
CONTROL MONUMENT (BENCHMARK)**
SCALE: NTS

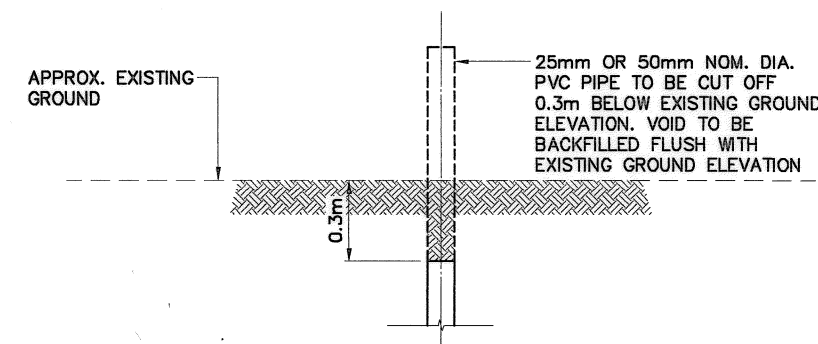


**TYPICAL SITE INVESTIGATION
MONITORING WELL**
SCALE: NTS

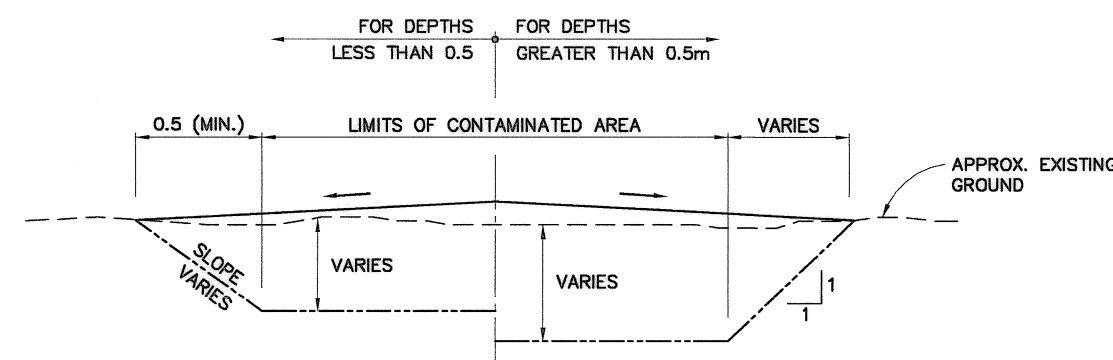


- NOTE:
1. MATERIAL TO BE REMOVED: DCC TIER I SOILS TO BE DISPOSED OF IN THE NON-HAZARDOUS WASTE LANDFILLS. DCC TIER II SOILS TO BE DISPOSED OF IN THE TIER II SOIL DISPOSAL FACILITIES. HYDROCARBON TYPE B SOILS PLACED IN THE LANDFARM AND TREATED.
 2. TYPE 3 GRANULAR MATERIAL TO BE PLACED IN EXCAVATION, COMPACTED AND MOUNDED TO 100mm ABOVE GROUND SURFACE TO PROMOTE DRAINAGE, UNLESS NOTED OTHERWISE.

TYPICAL CONTAMINATED SOIL EXCAVATION SECTION
SCALE: NTS

NOTE:
29 MONITORING WELLS PREVIOUSLY
INSTALLED.
2 MONITORING WELLS TO BE INSTALLED.
SEE NOTE 2.
2 MONITORING WELLS TO BE
DECOMMISSIONED.

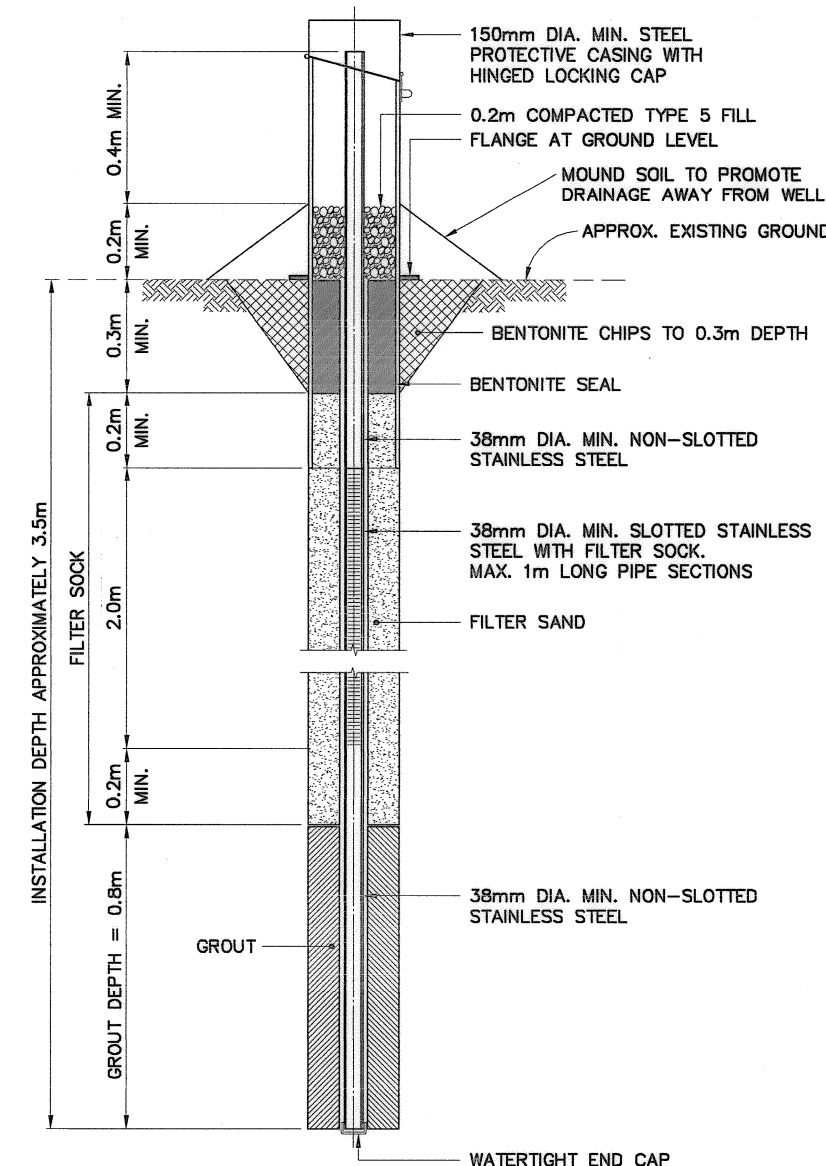

**TYPICAL MONITORING WELL/
BACKGROUND MONITORING WELL**
SCALE: NTS
FOR BEDROCK DEPTH > 0.7m

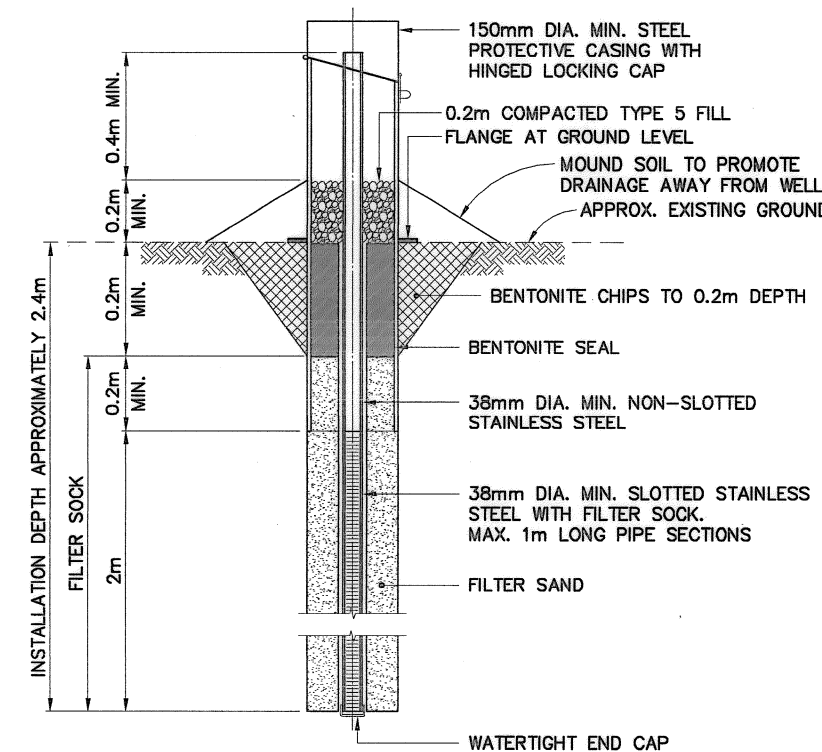

**TYPICAL MONITORING WELL/
BACKGROUND MONITORING WELL**
SCALE: NTS
FOR BEDROCK DEPTH < 0.7m


General Notes:

1. ALL STRUCTURES DESIGNATED FOR DEMOLITION TO BE DEMOLISHED TO TOP OF CONCRETE FOUNDATIONS UNLESS NOTED OTHERWISE.
2. ALL DIMENSIONS ARE IN METRES UNLESS NOTED OTHERWISE.
3. ALL LONG RANGE RADAR (LRR) FACILITIES ARE CURRENTLY OPERATIONAL AND ARE NOT TO BE DISTURBED. THESE INCLUDE ALL BUILDINGS, STRUCTURES, ELECTRICAL POWER CABLES, FUEL STORAGE TANKS AND PIPELINES NOT SCHEDULED FOR DEMOLITION.
4. PIPELINES AND ANCILLARY EQUIPMENT TO BE REMOVED TO INCLUDE ALL ASSOCIATED PIPE SUPPORTS AND PIPELINE MARKERS.
5. PROVIDE REGRADING AROUND ALL CONCRETE THAT IS DESIGNATED TO REMAIN, AS PER TYPICAL DETAIL ON THIS DRAWING, UNLESS NOTED OTHERWISE.

Legend:

- TO BE DEMOLISHED
- UTILITY POLE TO BE DEMOLISHED
- POL LINE TO BE DEMOLISHED

No.	DATE	REVISION	REVISION	APPR.

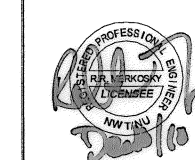

PERMIT TO PRACTICE
AECOM Canada Ltd.
Signature: *[Signature]*
Date: *[Date]*
PERMIT NUMBER: P639
NWT/NU Association of Professional Engineers and Geoscientists

AECOM

HATCH

SCALE - ÉCHELLE 20 10 0 20 40 60m

PROJECT - PROJET
DYE-M CAPE DYER

DEW LINE CLEAN UP

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MINISTER OF NATIONAL DEFENCE.


TRADE - MÉTIER
STRUCTURAL

DATE
2010-12-07


SUBJECT - SUJET
LOWER SITE
STATION AREA
DEMOLITION SITE PLAN

PRODUCTION	CONCURRENCE - ASSENTIMENT
DESIGNED ETUDIE <i>DTH/TME</i>	DES OFF AGENT CONCEPT
DRAWN DESSINE <i>IC/CAE</i>	SECT HD CHEF SECT
CHECKED VÉRIFIÉ <i>DWF</i>	DES MGR GEST CONCEPT
COORDINATION <i>RRM</i>	REVIEWED - REVU
DWG. NO. - DESSIN NO. H-C75/3-9101-201	

Canada

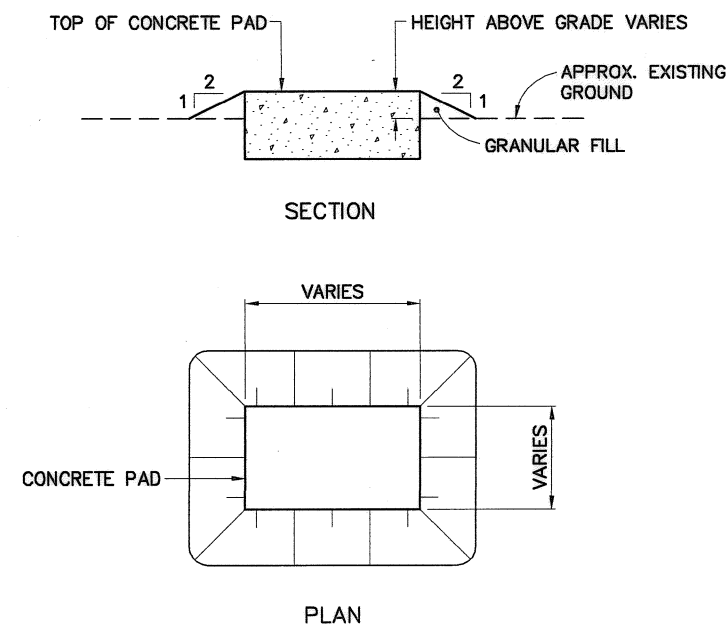

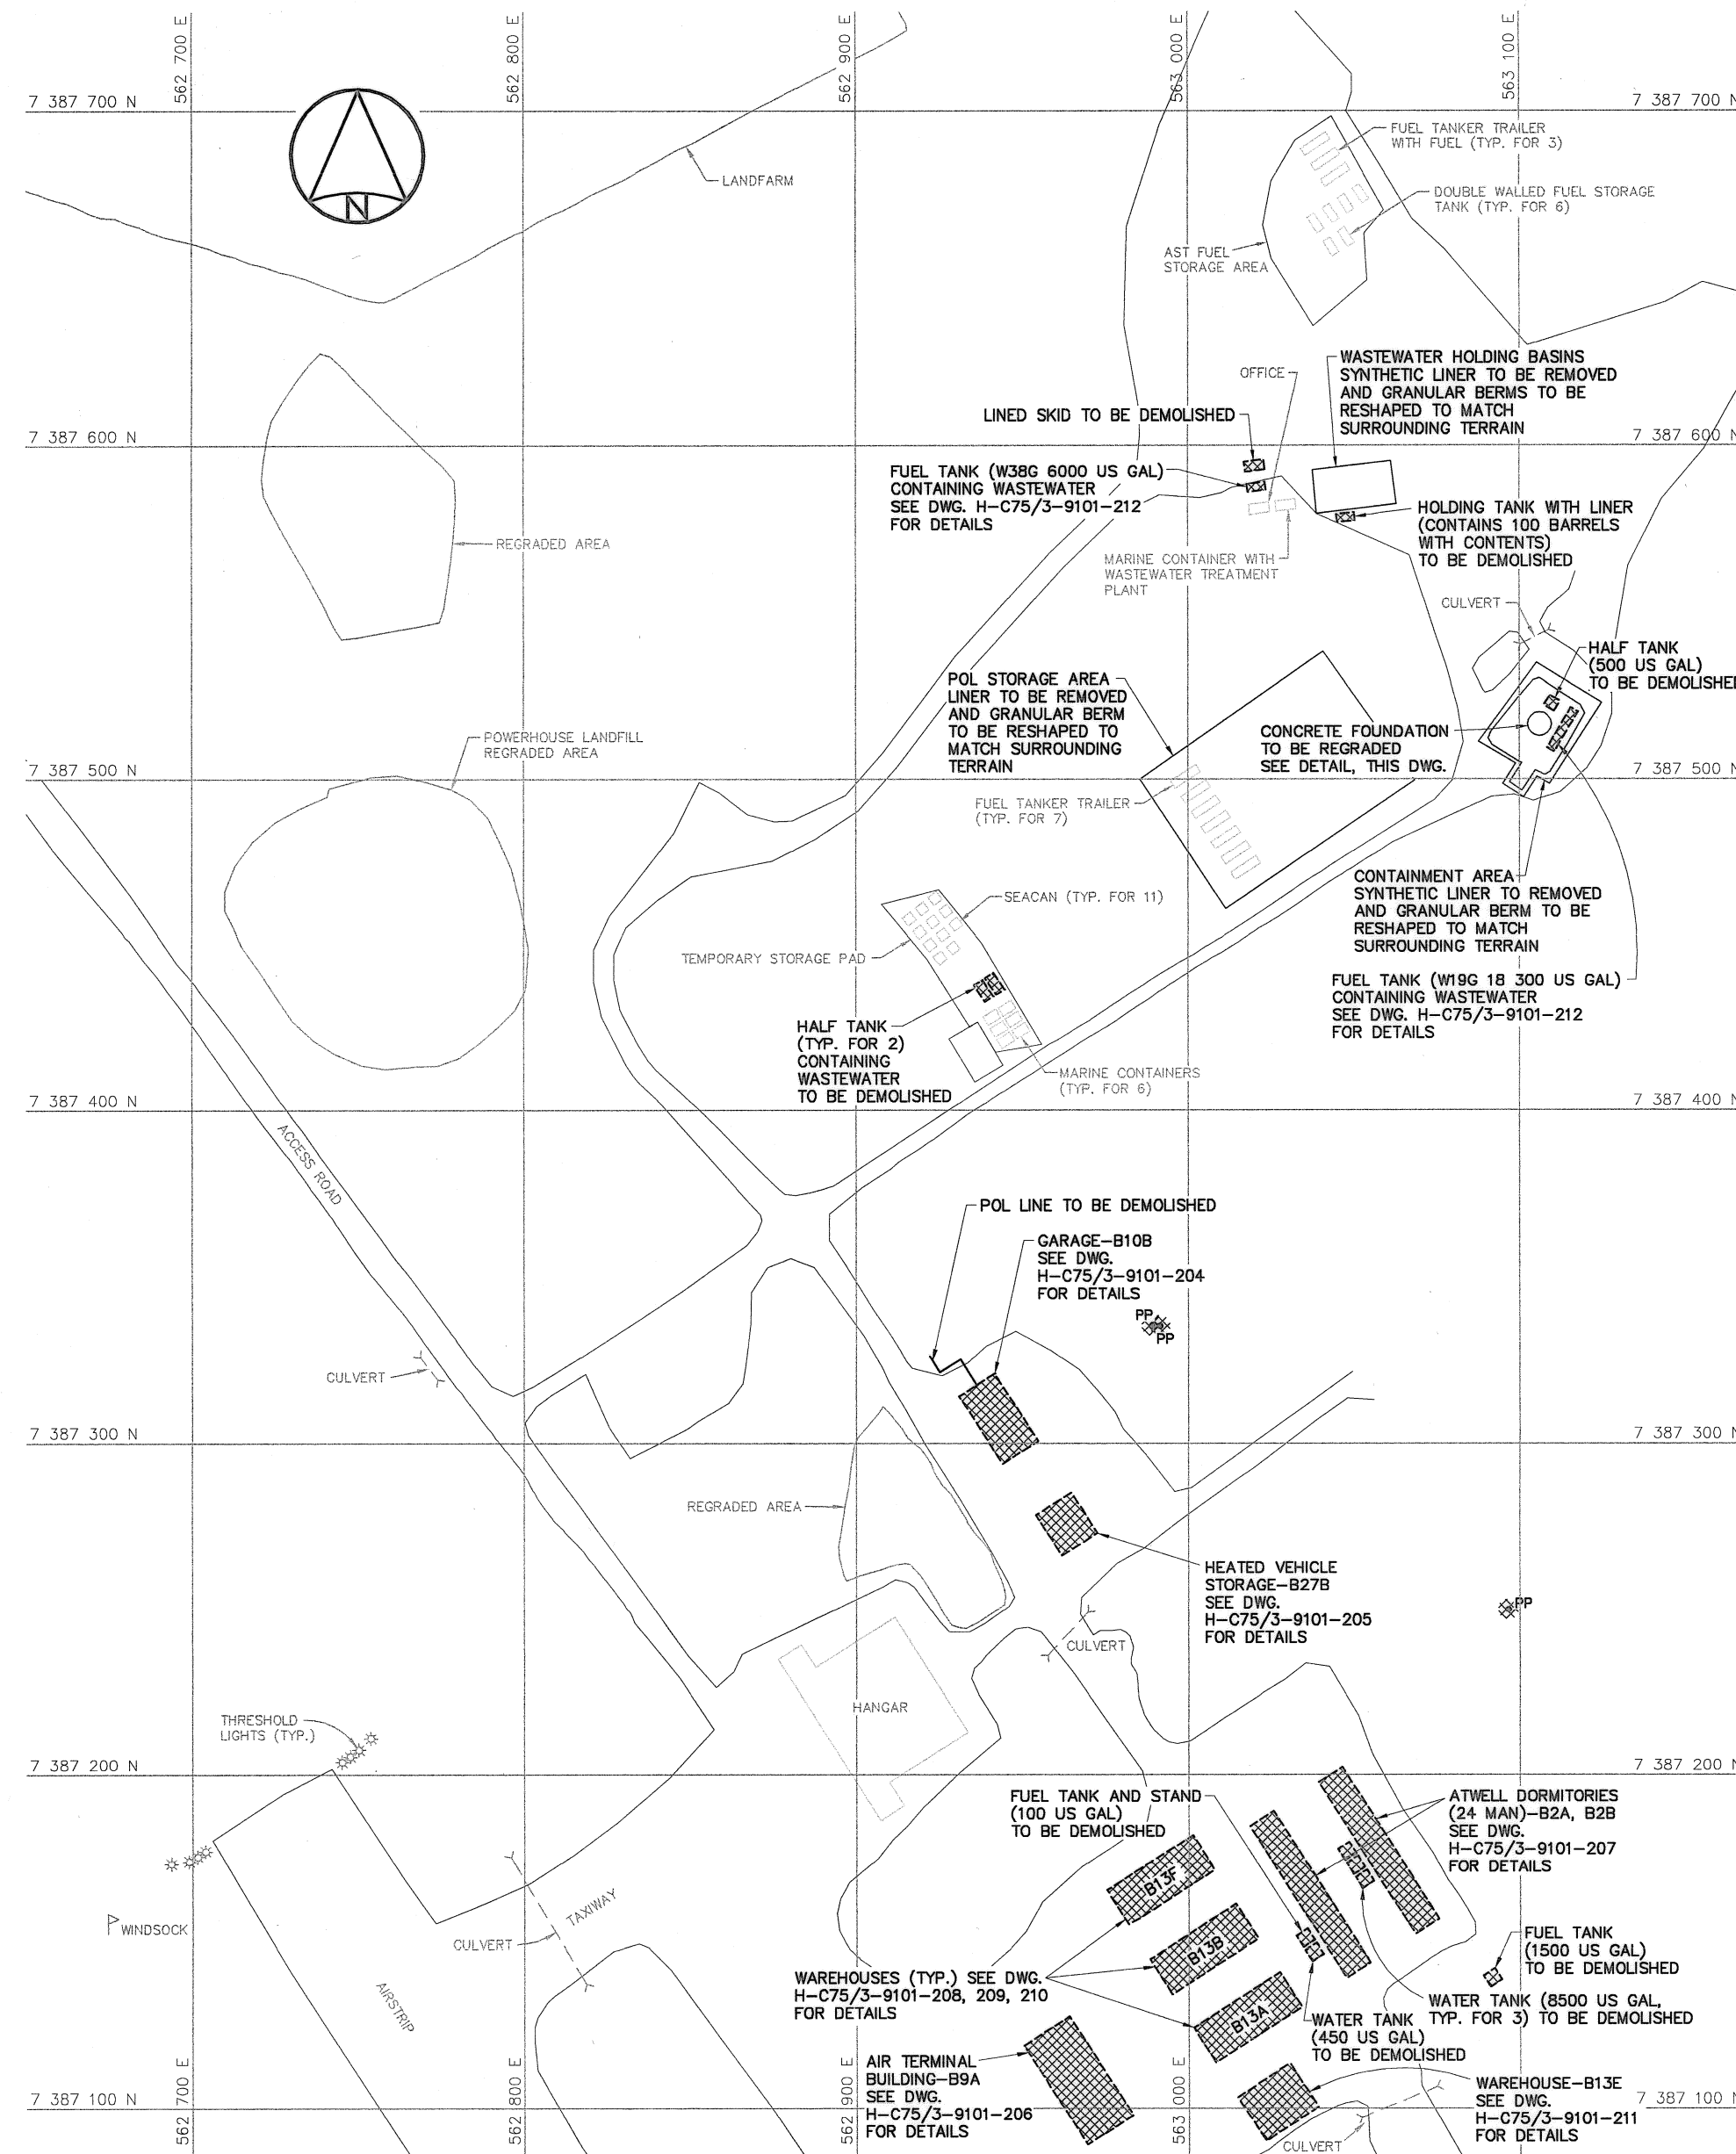




TYPICAL CONCRETE PAD REGRADING DETAIL
SCALE: NTS




General Notes:

1. ALL STRUCTURES DESIGNATED FOR DEMOLITION TO BE DEMOLISHED TO TOP OF CONCRETE FOUNDATIONS UNLESS NOTED OTHERWISE.
2. ALL DIMENSIONS ARE IN METRES UNLESS NOTED OTHERWISE.
3. ALL LONG RANGE RADAR (LRR) FACILITIES ARE CURRENTLY OPERATIONAL AND ARE NOT TO BE DISTURBED. THESE INCLUDE ALL BUILDINGS, STRUCTURES, ELECTRICAL POWER CABLES, FUEL STORAGE TANKS AND PIPELINES NOT SCHEDULED FOR DEMOLITION.
4. PIPELINES AND ANCILLARY EQUIPMENT TO BE REMOVED TO INCLUDE ALL ASSOCIATED PIPE SUPPORTS AND PIPELINE MARKERS.

Legend:

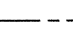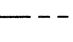-  TO BE DEMOLISHED
-  UTILITY POLE TO BE DEMOLISHED
-  COMMUNICATION CABLE TO BE DEMOLISHED
-  POWER CABLE TO BE DEMOLISHED
-  POL LINE TO BE DEMOLISHED

No.	DATE	REVISION	REVISION	APPR.
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AECOM Canada Ltd.
Signature: *[Signature]*
Date: *[Date]*
PERMIT NUMBER: P639
NWT/NU Association of Professional
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SCALE - ECHELLE 10 5 0 10 20 30m

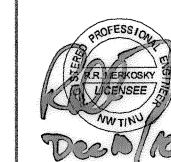PROJECT - PROJET
DYE-M CAPE DYER

DEW LINE CLEAN UP

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TRADE - METIER STRUCTURAL DATE 2010-12-07


SUBJECT - SUJET


UPPER SITE
DEW DROP AREA
DEMOLITION SITE PLAN


PRODUCTION	CONCURRENCE - ASSENTIMENT
DESIGNED ETUDIE <i>DTR/THE</i>	DES OFF AGENT CONCEPT
DRAWN DESSINE <i>IC/CAE</i>	SECT HD CHEF SECT
CHECKED VERIFIE <i>DWF</i>	DES MGR GEST CONCEPT
COORDINATION <i>RRM</i>	REVIEWED - REVU

DWG. NO. - DESSIN NO.
H-C75/3-9101-202


Canada

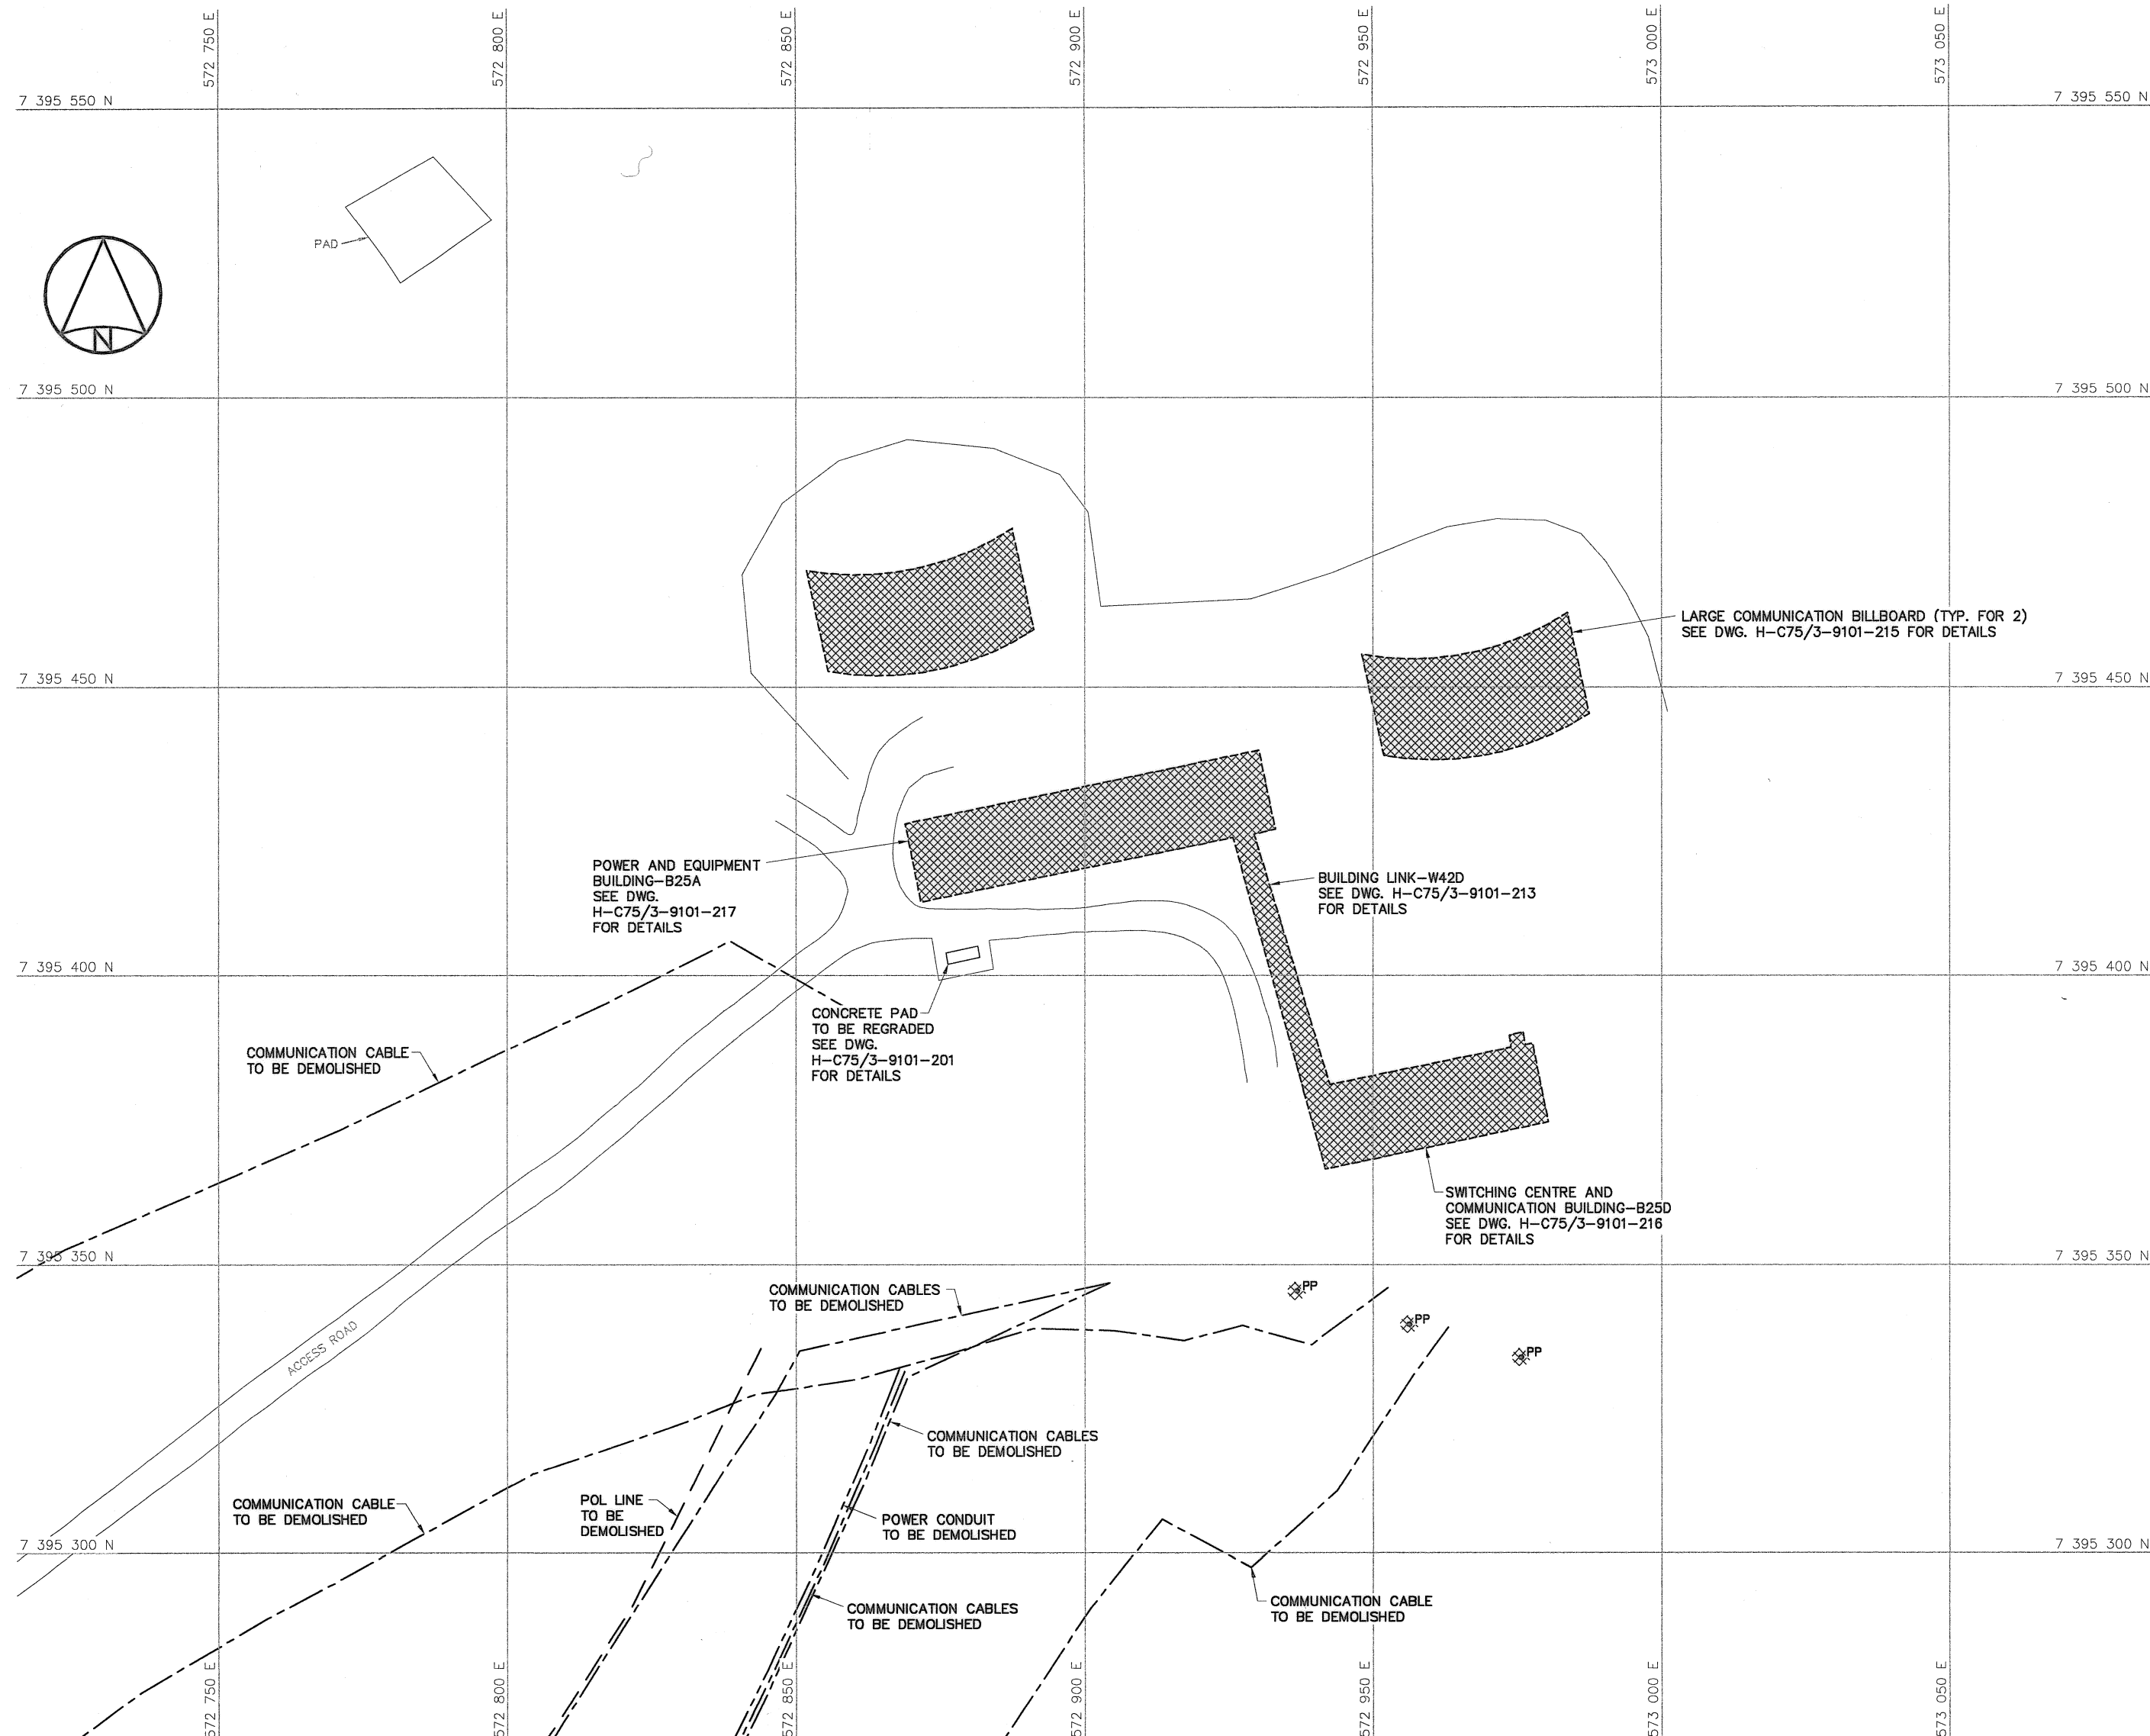

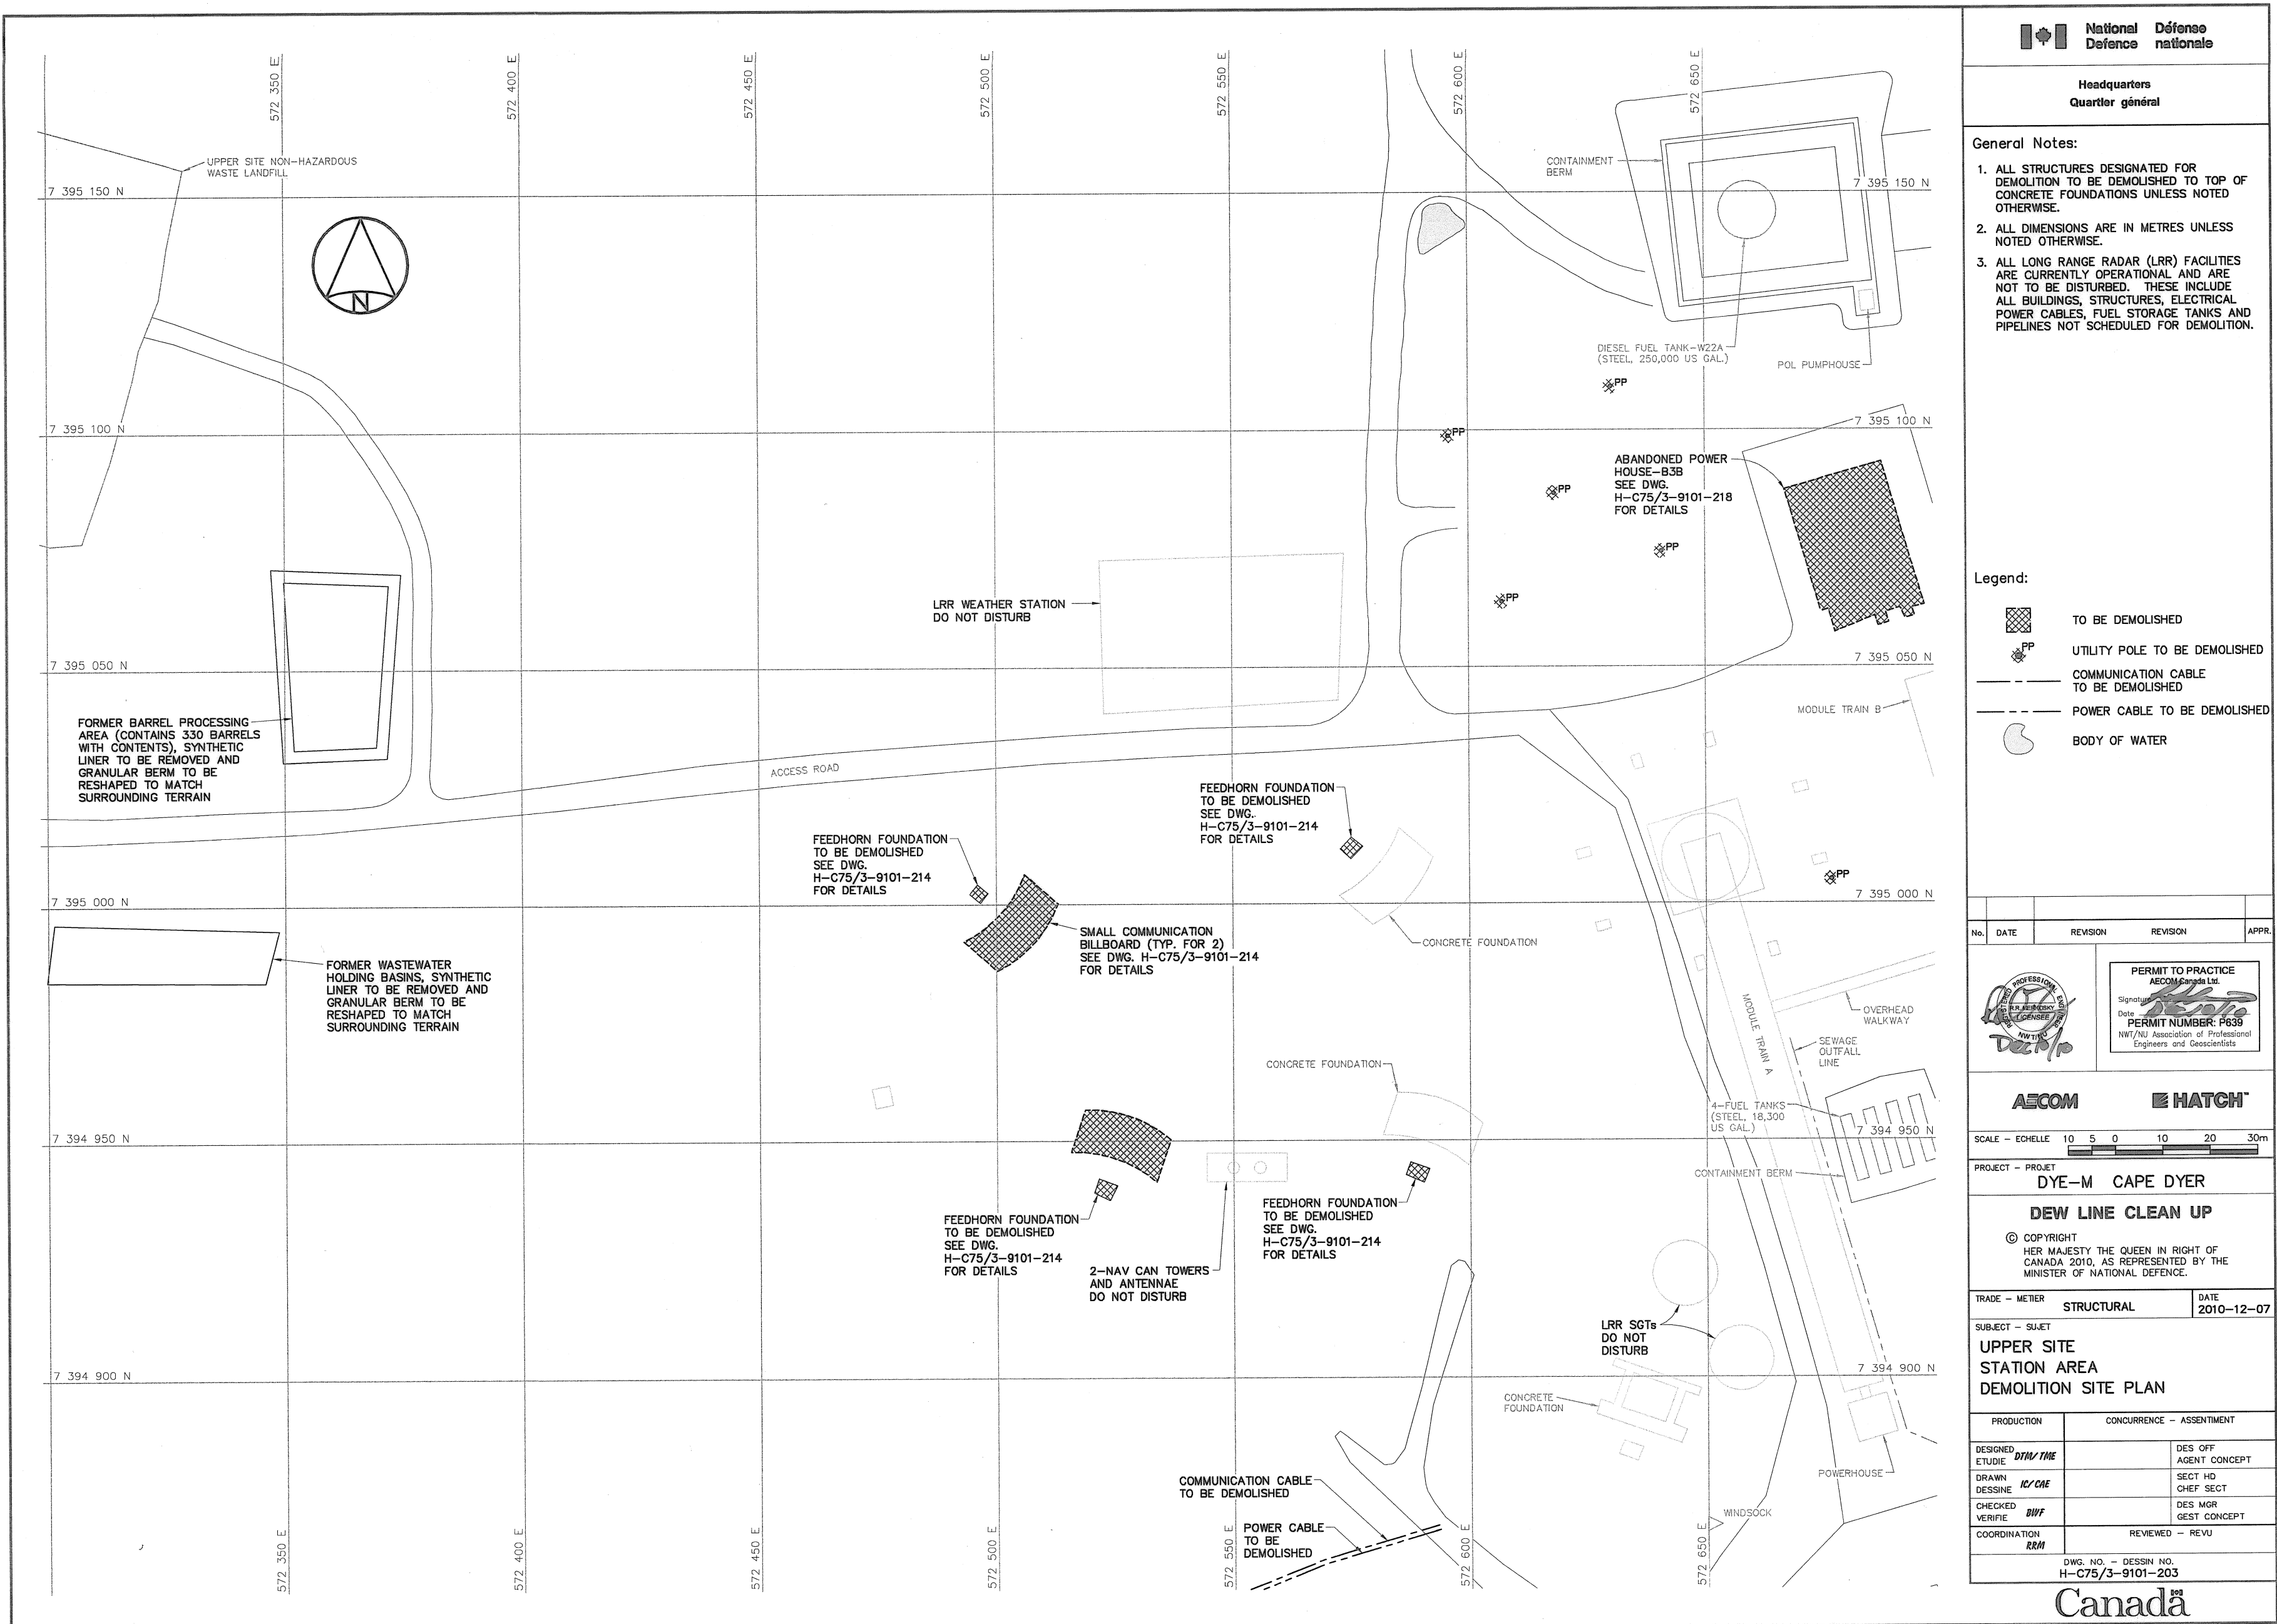

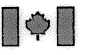

National
Défense



Défense
nationale

Headquarters
Quartier général

General Notes:

- ALL STRUCTURES DESIGNATED FOR DEMOLITION TO BE DEMOLISHED TO TOP OF CONCRETE FOUNDATIONS UNLESS NOTED OTHERWISE.
- ALL DIMENSIONS ARE IN METRES UNLESS NOTED OTHERWISE.
- ALL LONG RANGE RADAR (LRR) FACILITIES ARE CURRENTLY OPERATIONAL AND ARE NOT TO BE DISTURBED. THESE INCLUDE ALL BUILDINGS, STRUCTURES, ELECTRICAL POWER CABLES, FUEL STORAGE TANKS AND PIPELINES NOT SCHEDULED FOR DEMOLITION.

Legend:

 TO BE DEMOLISHED

 UTILITY POLE TO BE DEMOLISHED

 COMMUNICATION CABLE TO BE DEMOLISHED

 POWER CABLE TO BE DEMOLISHED

 BODY OF WATER



PERMIT TO PRACTICE
AECOM Canada Ltd.
Signature: 
Date: 
PERMIT NUMBER: P639
NWT/NL Association of Professional Engineers and Geoscientists

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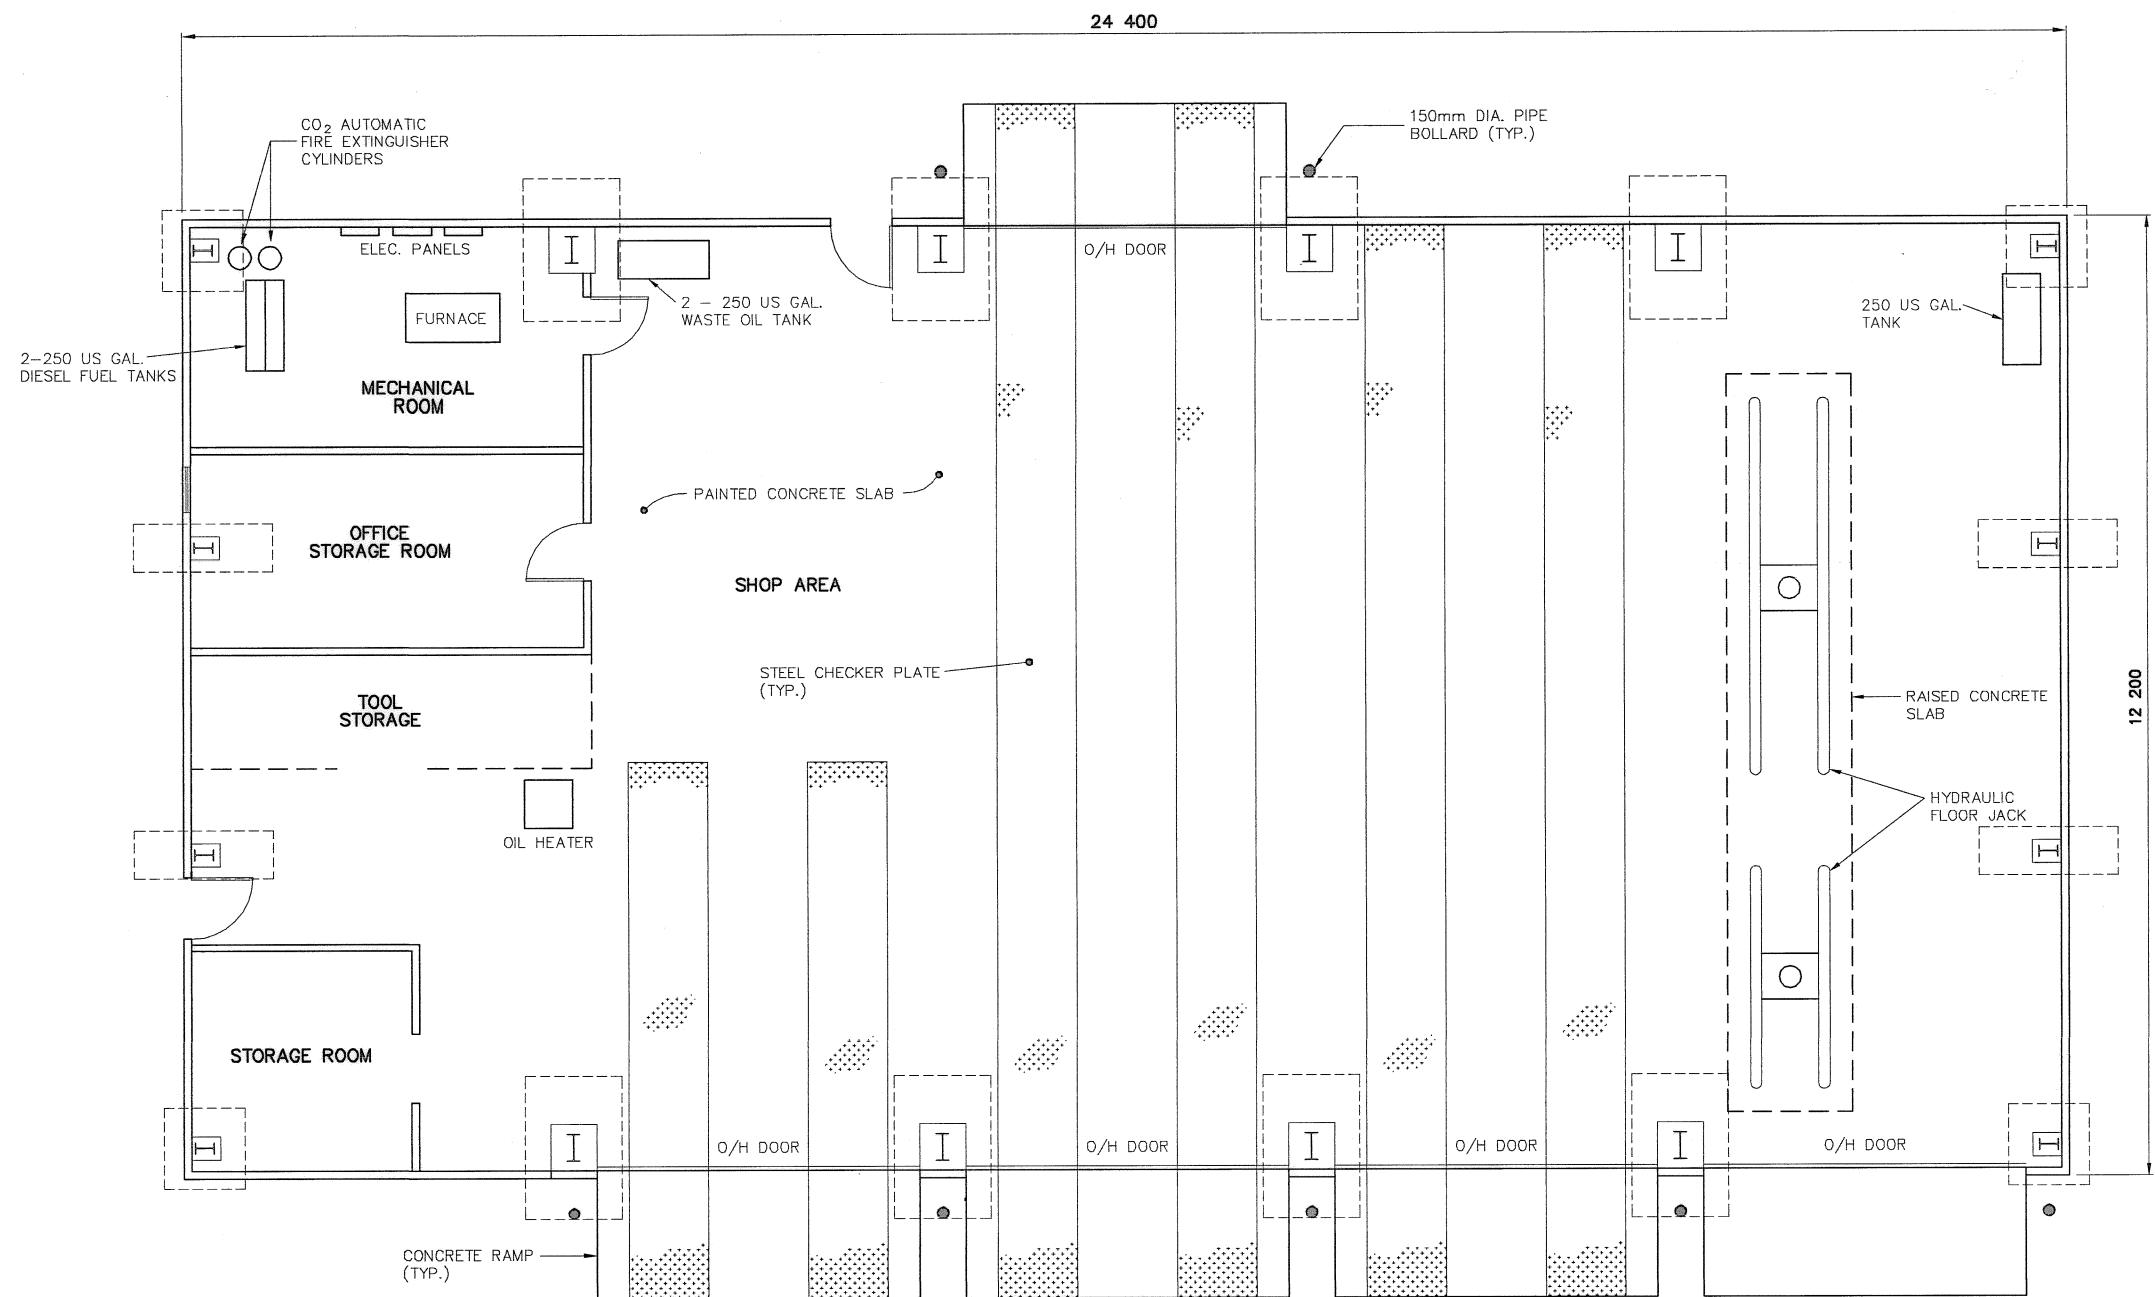
HATCH

SCALE - ÉCHELLE 10 5 0 10 20 30m

PROJECT - PROJET DYE-M CAPE DYER

DEW LINE CLEAN UP


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CANADA 2010, AS REPRESENTED BY THE
MINISTER OF NATIONAL DEFENCE.SUBJECT - SUJET
UPPER SITE
STATION AREA
DEMOLITION SITE PLANDWG. NO. - DESSIN NO.
H-C75/3-9101-203



FLOOR PLAN

NWSO NUMBER	COMMENTS
B10B	ASBESTOS REMOVAL REQUIRED.

NOTE:
CONCRETE PAD AND RAMPS TO REMAIN AND BE REGRADED WITH 300mm TYPE 2 GRANULAR FILL MATERIAL AS CONTINUOUS COVER. REMOVE ALL PAINT FROM CONCRETE SLAB AND RAMPS PRIOR TO REGRAIDING.

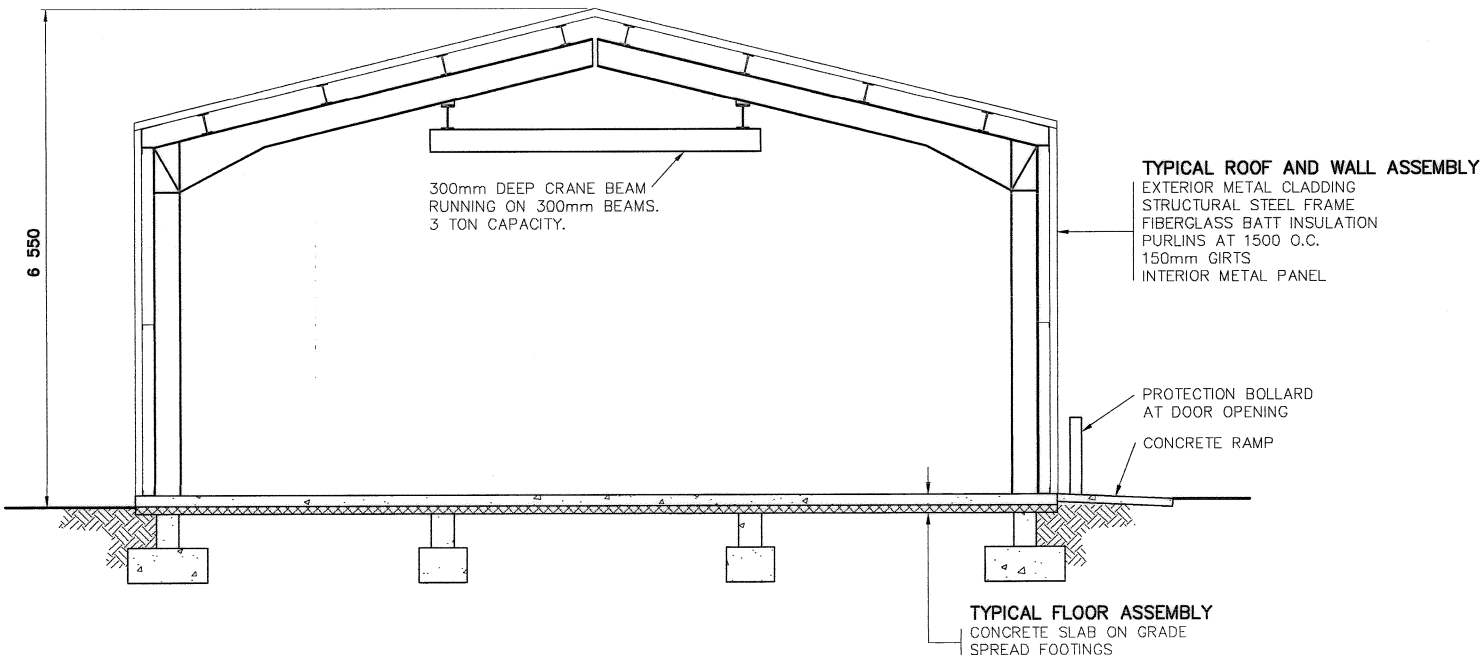

SECTION

- General Notes:
1. ALL DIMENSIONS ARE IN MILLIMETRES UNLESS NOTED OTHERWISE.
 2. FACILITIES TO BE DEMOLISHED MAY CONTAIN PCB AND LEAD CONTAMINATED PAINT. REFER TO SECTION 02080 OF THE SPECIFICATIONS.
 3. REFER TO DEMOLITION TABLES IN SPECIFICATIONS FOR LIST OF MAJOR BUILDING CONTENTS.
 4. MECHANICAL EQUIPMENT/DUCTING NOT SHOWN.

Legend:

No.	DATE	REVISION	REVISION	APPR.
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AECOM Canada Ltd.
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Date: [Date]
PERMIT NUMBER: P639
NWT/NJ Association of Professional Engineers and Geoscientists

AECOM HATCH

SCALE - ECHELLE 1 0.5 0 1 2 3m

PROJECT - PROJET
DYE-M CAPE DYER


DEW LINE CLEAN UP
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TRADE - METIER STRUCTURAL
DATE 2010-12-07



SUBJECT - SUJET

GARAGE
PLAN AND SECTION


PRODUCTION	CONCURRENCE - ASSENTIMENT
DESIGNED ETUDIE DTM/THE	DES OFF AGENT CONCEPT
DRAWN DESSINE IC/CAE	SECT HD CHEF SECT
CHECKED VERIFIE DWF	DES MGR GEST CONCEPT
COORDINATION RRM	REVIEWED - REVU

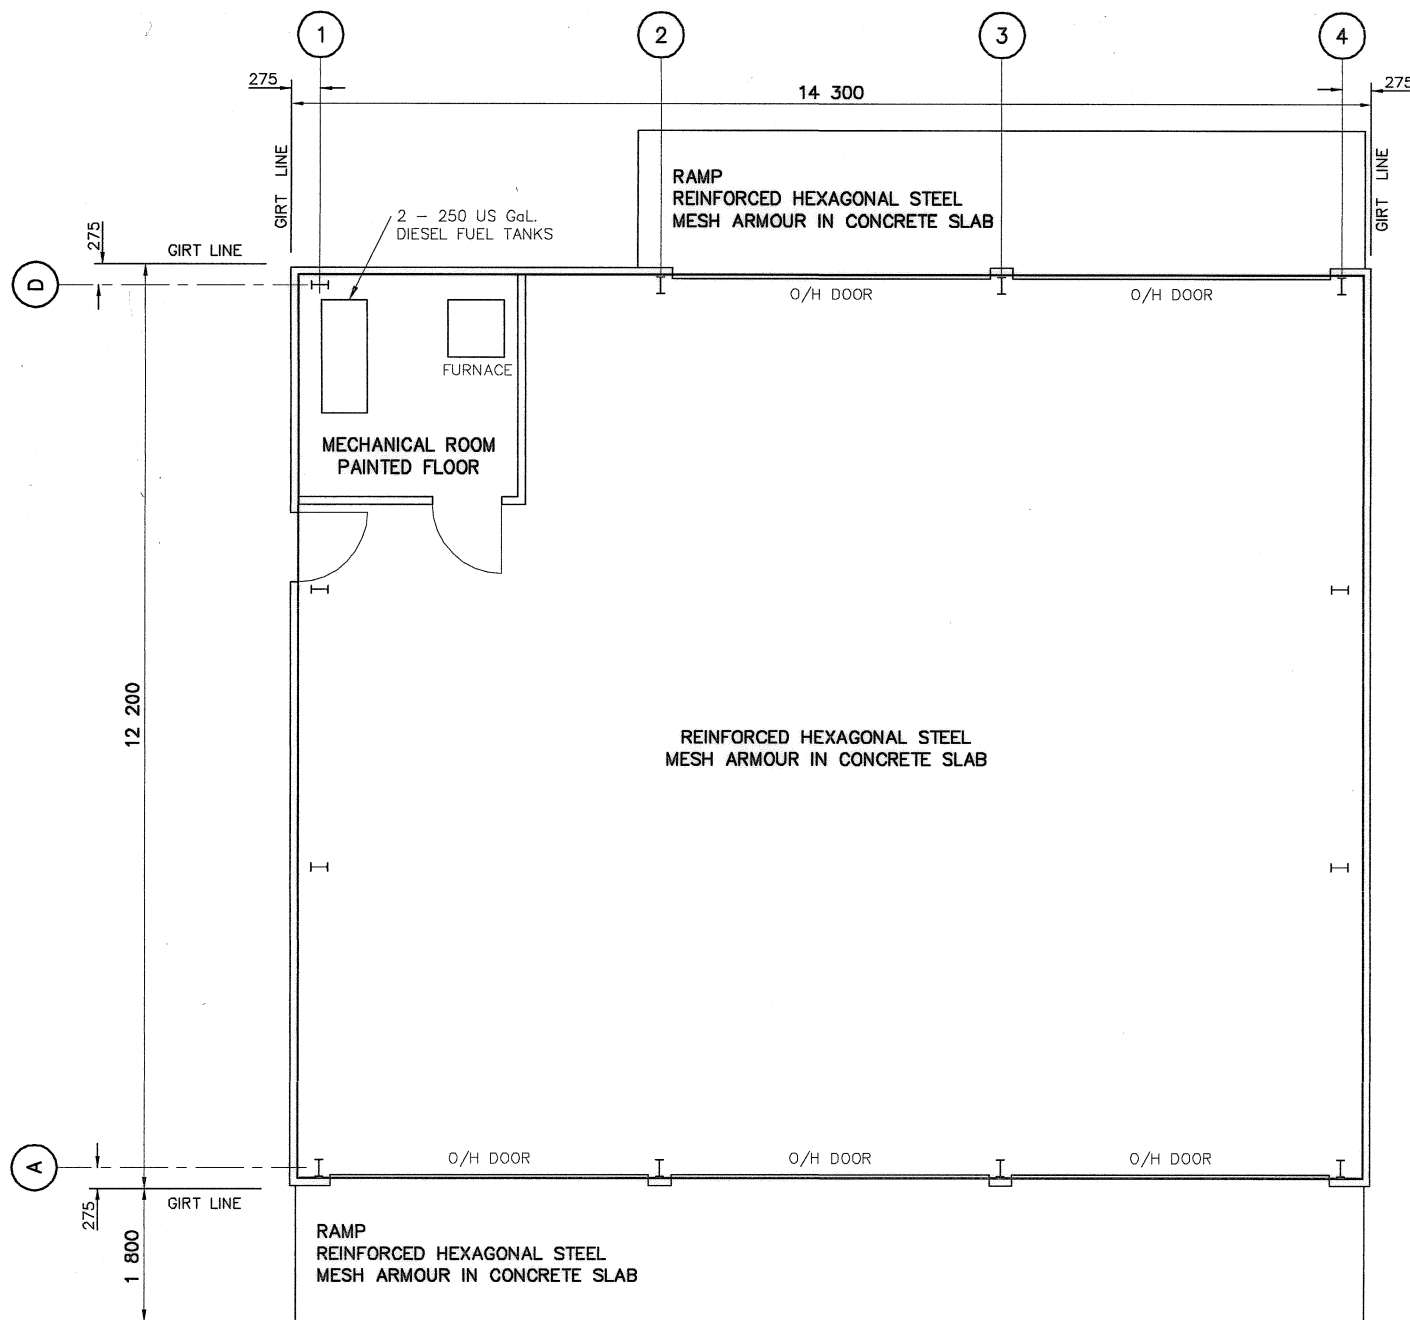

PLAN

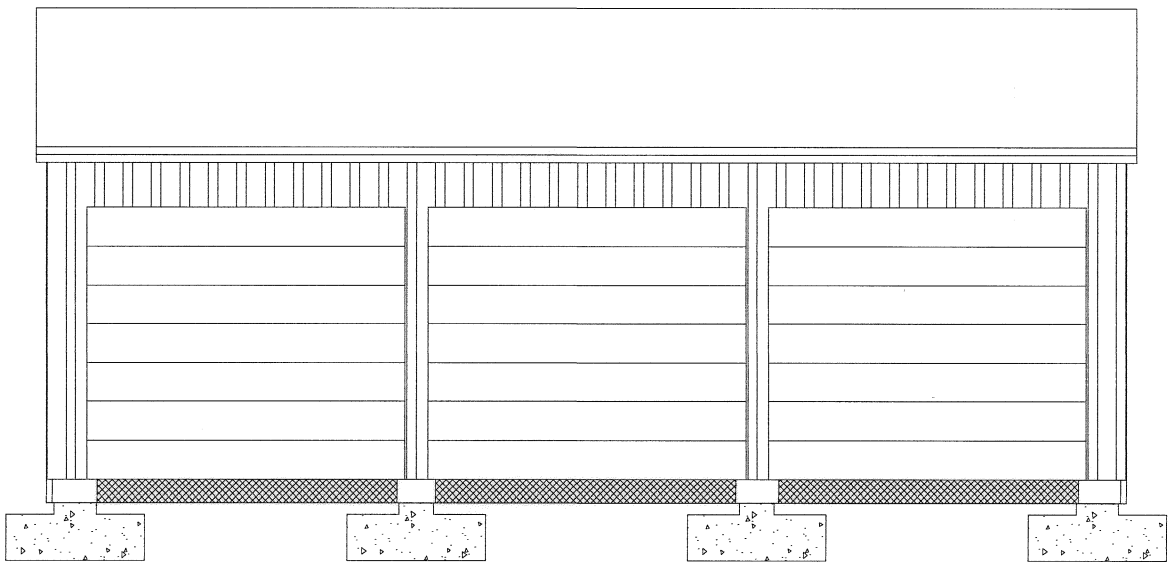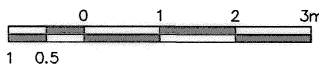


FRONT ELEVATION

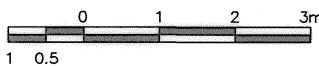



NWSO NUMBER	COMMENTS
B27B	ASBESTOS REMOVAL REQUIRED.

NOTE:
REMOVE 10mm THICKNESS OF PCB CONTAMINATED CONCRETE FROM STAINED AREAS ON CONCRETE SLAB INSIDE NORTHWEST DOOR AND ON CONCRETE PAD NORTHWEST OF BUILDING.


NOTE:
CONCRETE PAD AND RAMPS TO REMAIN AND BE REGRADED WITH 300mm TYPE 2 GRANULAR FILL MATERIAL AS CONTINUOUS COVER. REMOVE ALL PAINT FROM CONCRETE SLAB AND RAMPS PRIOR TO REGRADED.

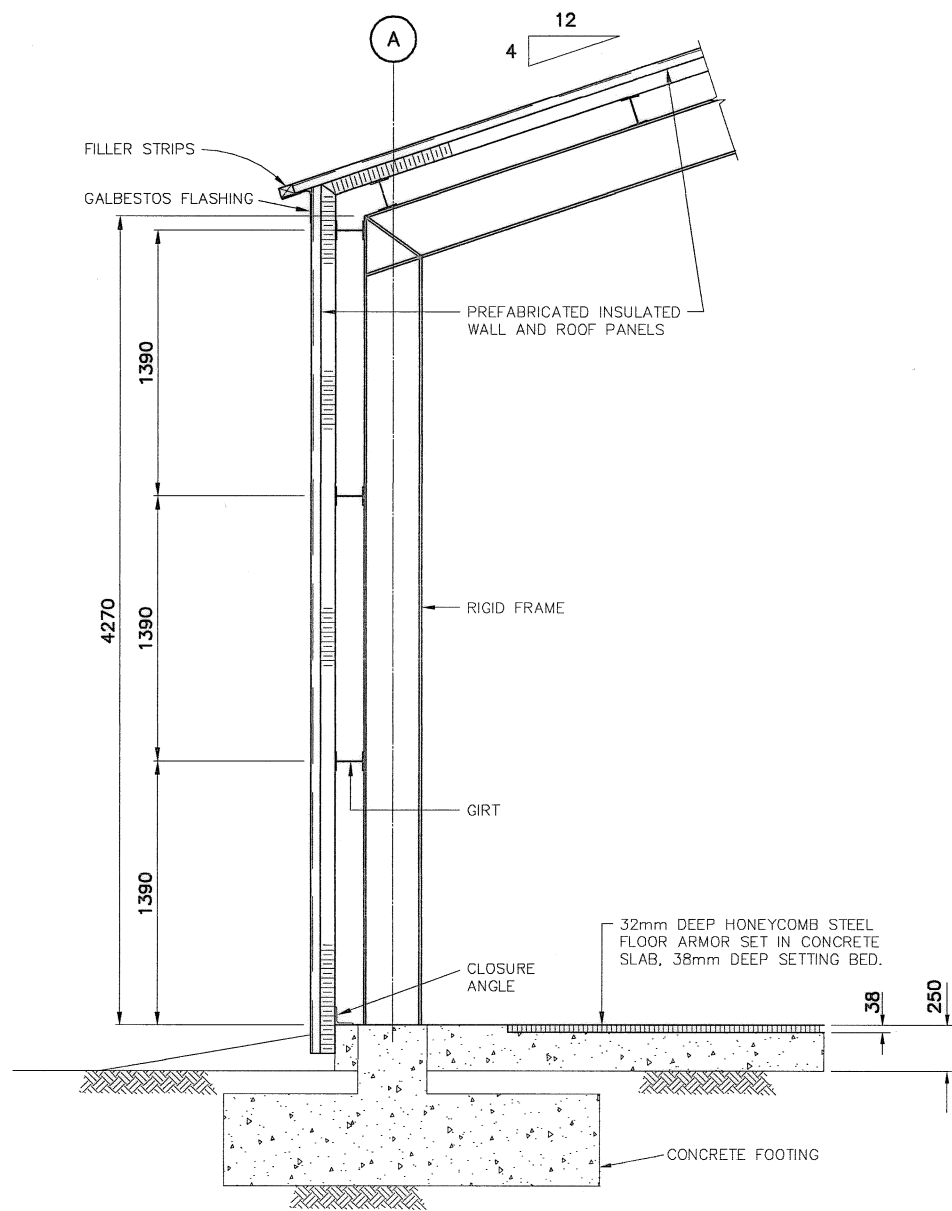

SECTION

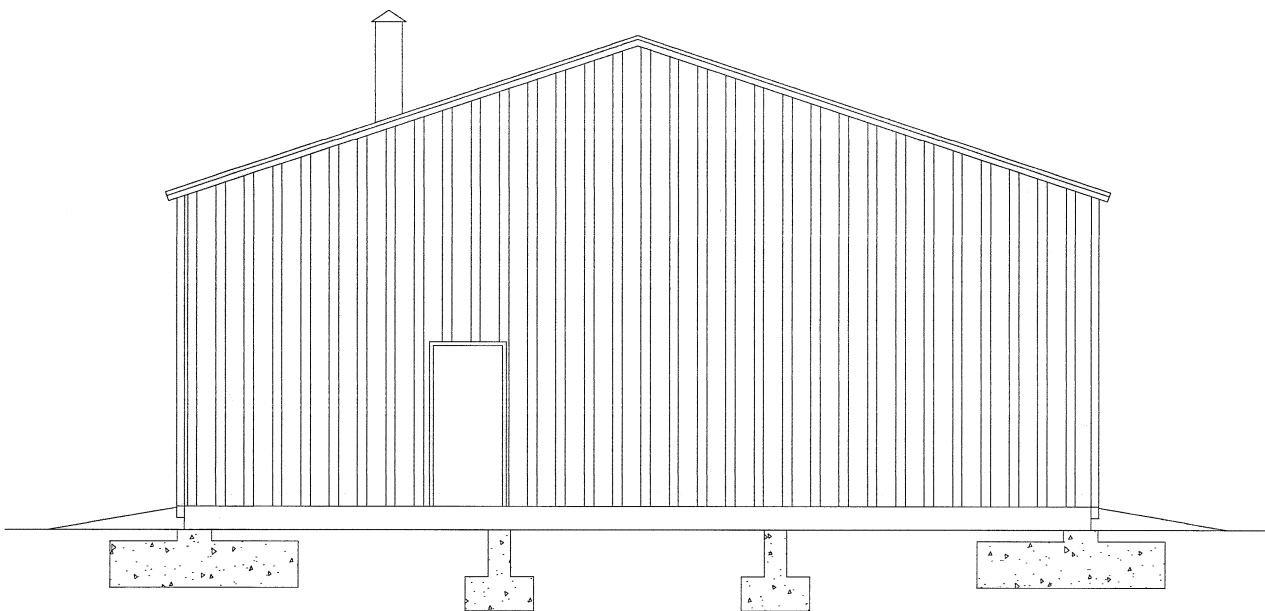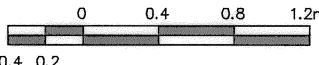

SIDE ELEVATION

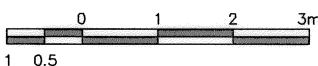

General Notes:

1. ALL DIMENSIONS ARE IN MILLIMETRES UNLESS NOTED OTHERWISE.
2. FACILITIES TO BE DEMOLISHED MAY CONTAIN PCB AND LEAD CONTAMINATED PAINT. REFER TO SECTION 02060 OF THE SPECIFICATIONS.
3. REFER TO DEMOLITION TABLES IN SPECIFICATIONS FOR LIST OF MAJOR BUILDING CONTENTS.
4. MECHANICAL EQUIPMENT/DUCTING NOT SHOWN.

Legend:

No.	DATE	REVISION	REVISION	APPR.
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Signature: [Signature]
Date: [Date]
PERMIT NUMBER: P839
NWT/NJ Association of Professional Engineers and Geoscientists

AECOM

HATCH

SCALE - ECHELLE AS SHOWN

PROJECT - PROJECT DYE-M CAPE DYER

DEW LINE CLEAN UP


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TRADE - METIER STRUCTURAL DATE 2010-12-07


SUBJECT - SUJET HEATED VEHICLE STORAGE PLAN, SECTION AND ELEVATIONS

PRODUCTION	CONCURRENCE - ASSENTIMENT
DESIGNED ETUDIE DTH/TME	DES OFF AGENT CONCEPT
DRAWN DESSINE IC/CME	SECT HD CHEF SECT
CHECKED VERIFIE DWF	DES MGR GEST CONCEPT
COORDINATION RRM	REVIEWED - REVU


DWG. NO. - DESSIN NO.
H-C75/3-9101-205

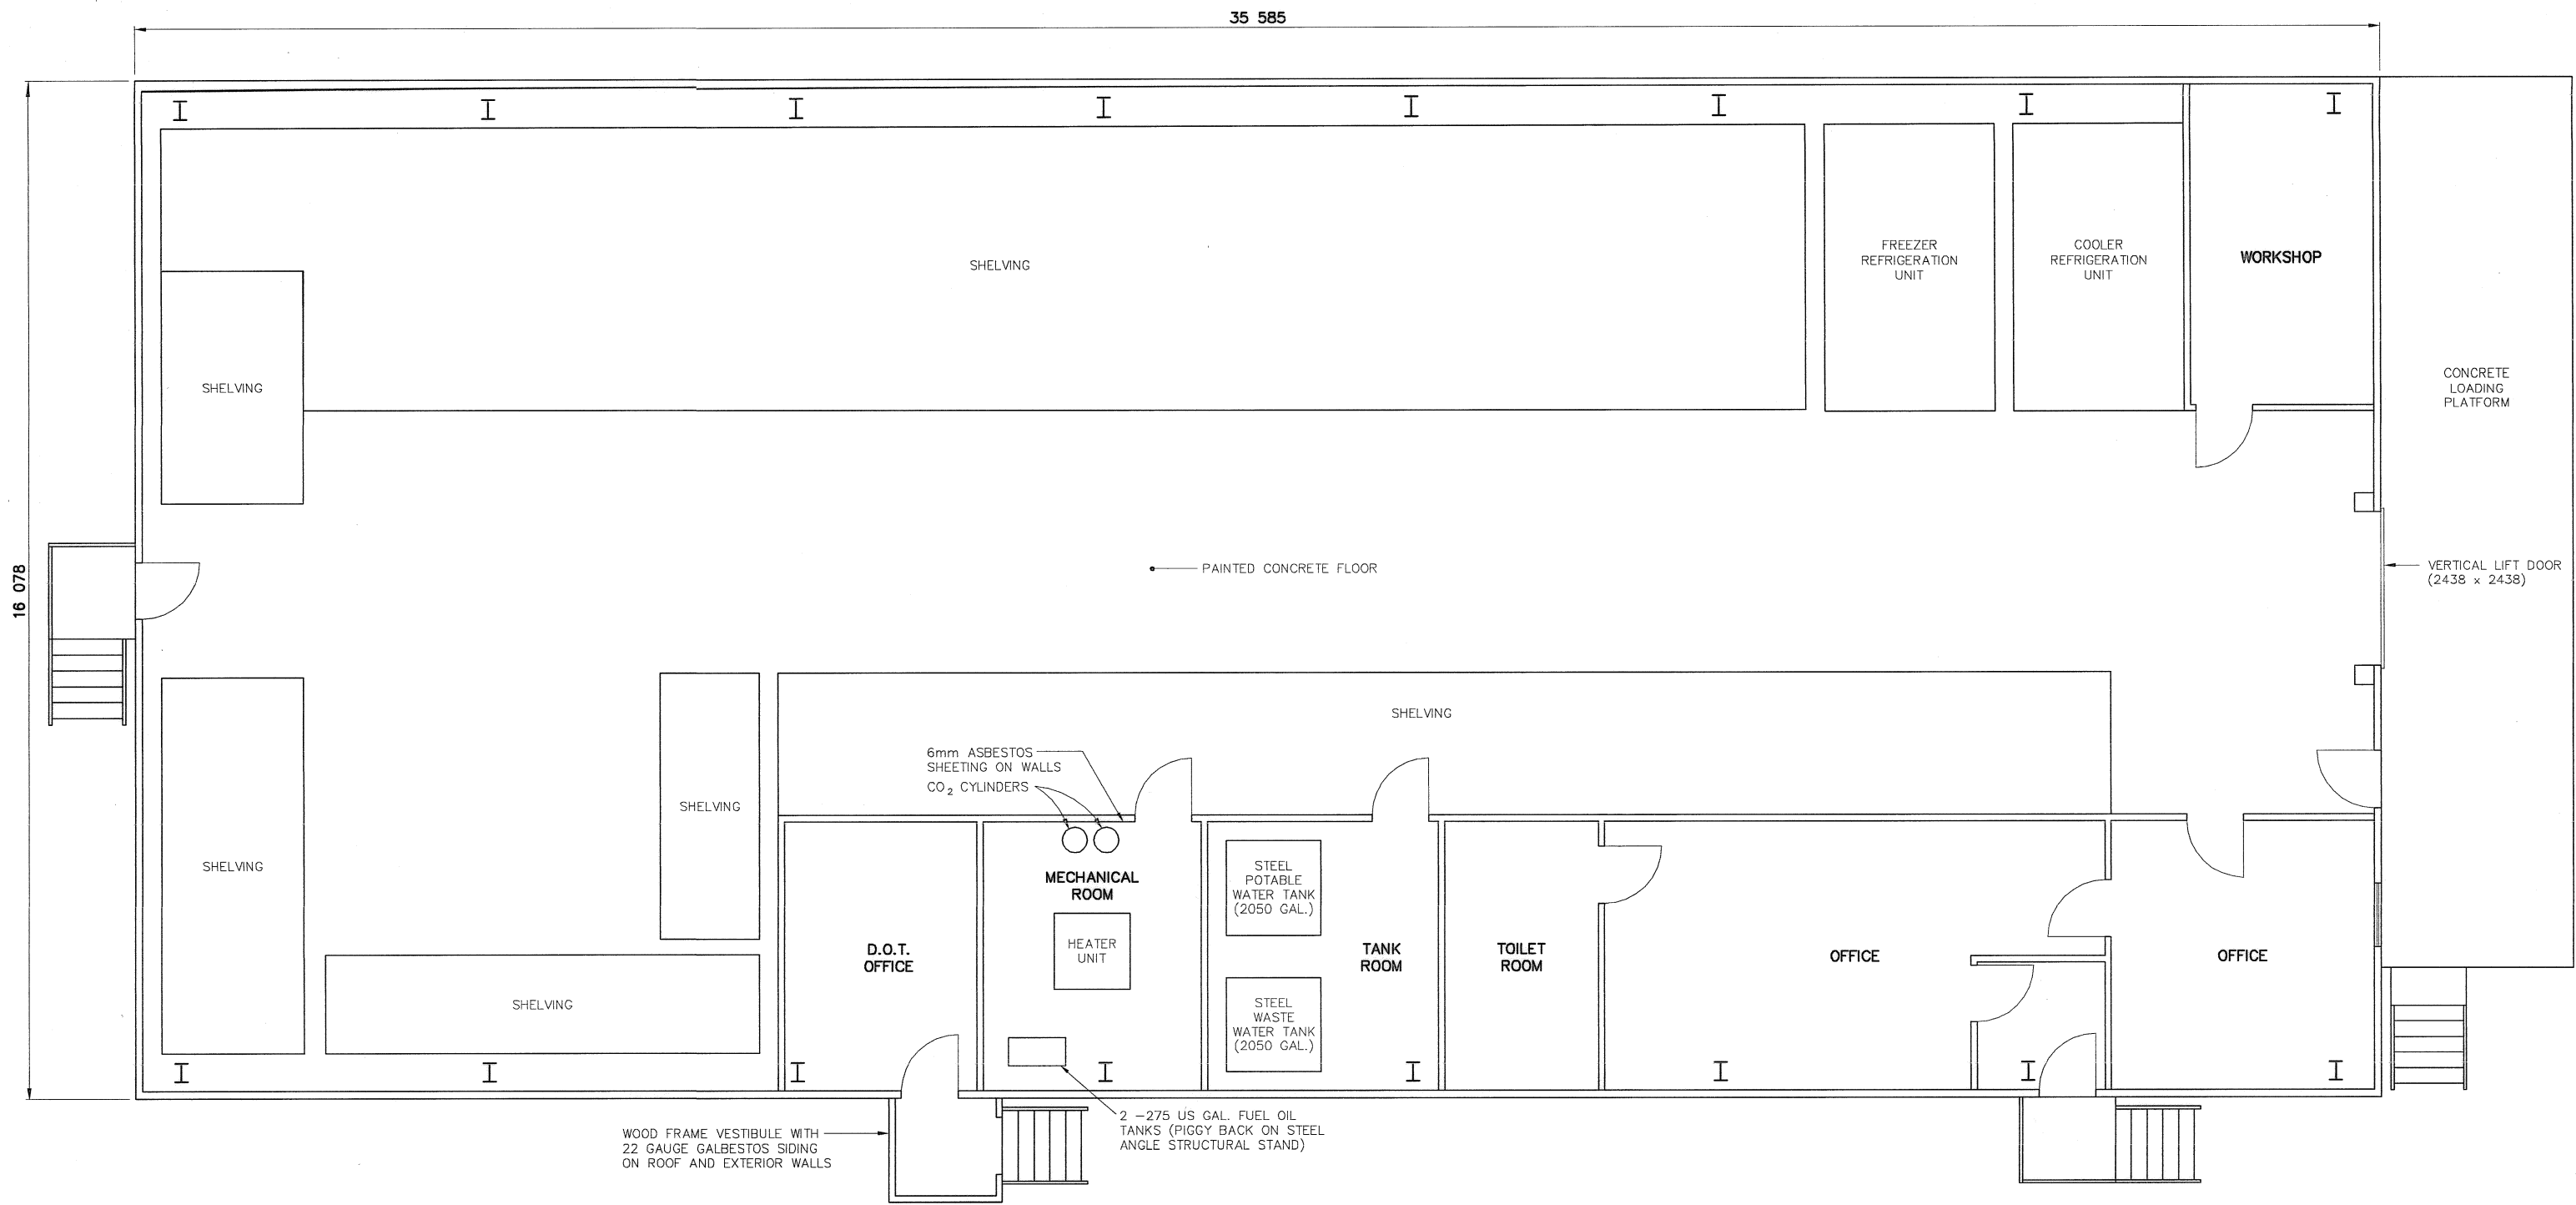

PLAN

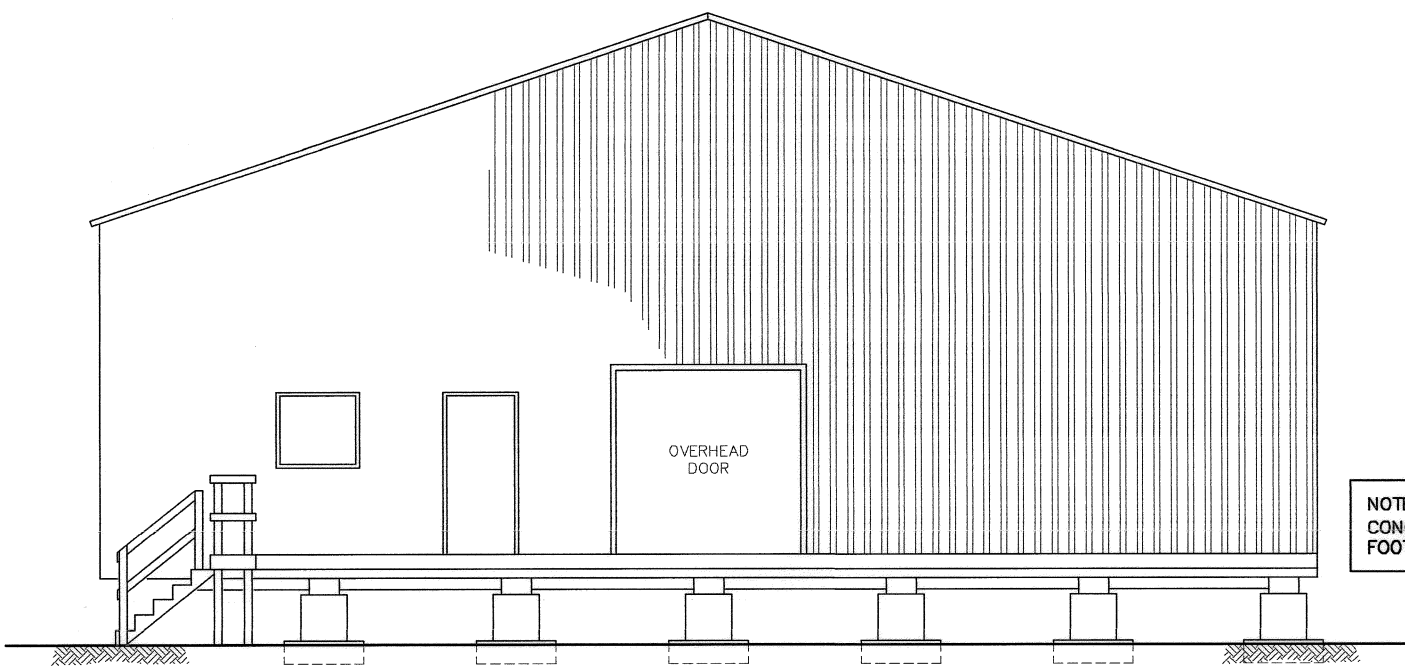


ELEVATION

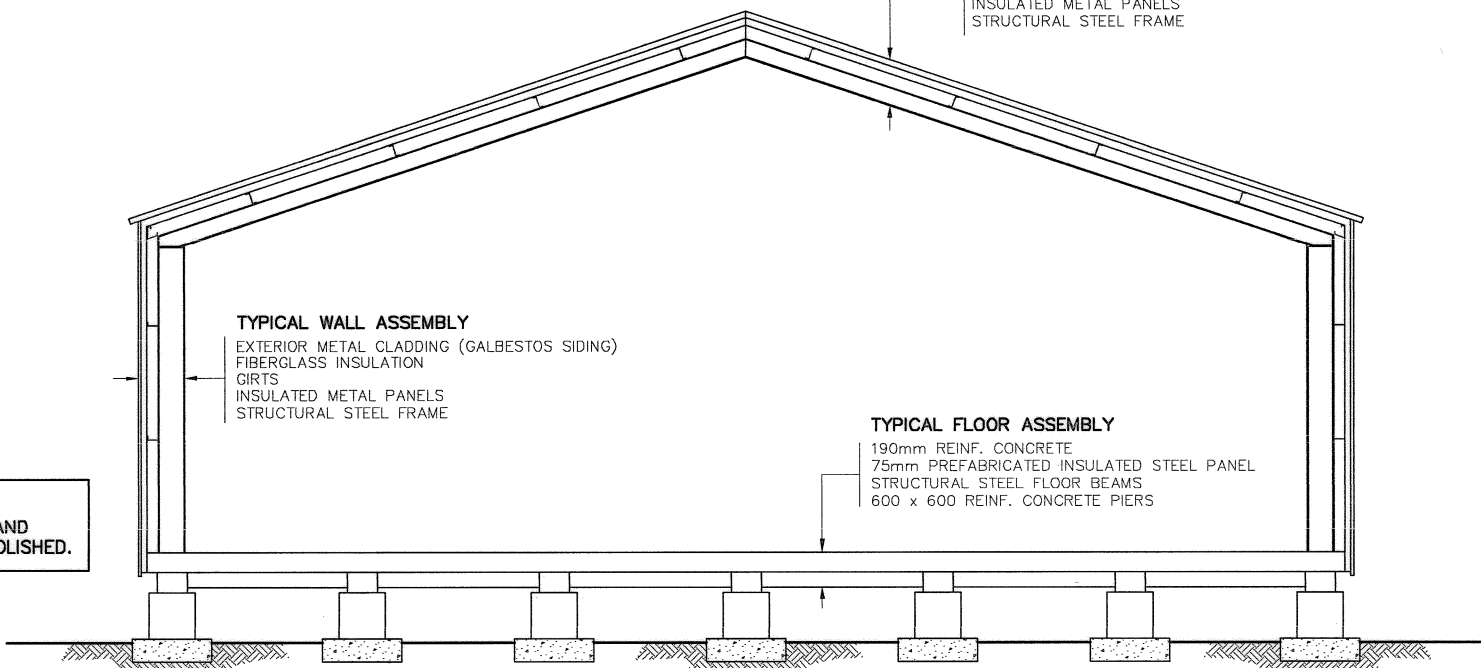


SECTION

NOTE:
CONCRETE COLUMNS AND
FOOTINGS TO BE DEMOLISHED.

NWSO NUMBER	COMMENTS
B9A	ASBESTOS REMOVAL REQUIRED.

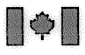

National
Defence



Défense
nationale


Headquarters
Quartier général


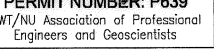
General Notes:



- ALL DIMENSIONS ARE IN MILLIMETRES UNLESS NOTED OTHERWISE.
- FACILITIES TO BE DEMOLISHED MAY CONTAIN PCB AND LEAD CONTAMINATED PAINT. REFER TO SECTION 02060 OF THE SPECIFICATIONS.
- REFER TO DEMOLITION TABLES IN SPECIFICATIONS FOR LIST OF MAJOR BUILDING CONTENTS.
- MECHANICAL EQUIPMENT/DUCTING NOT SHOWN.

Legend:

No.	DATE	REVISION	REVISION	APPR.



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Signature: 
Date: 
PERMIT NUMBER: P639
NWT/NU Association of Professional Engineers and Geoscientists



SCALE - ECHELLE 1 0.5 0 1 2 3m

PROJECT - PROJET
DYE-M CAPE DYER

DEW LINE CLEAN UP

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TRADE - METIER
STRUCTURAL


DATE
2010-12-07

SUBJECT - SUJET

AIR TERMINAL BUILDING
PLAN, SECTION AND ELEVATION

PRODUCTION	CONCURRENCE - ASSENTIMENT
DESIGNED ETUDIE DTH/THE	DES OFF AGENT CONCEPT
DRAWN DESSINE IC/CAE	SECT HD CHEF SECT
CHECKED VERIFIE DWF	DES MGR GEST CONCEPT
COORDINATION RRM	REVIEWED - REVU

DWG. NO. - DESSIN NO.
H-C75/3-9101-206



General Notes:

1. ALL DIMENSIONS ARE IN MILLIMETRES UNLESS NOTED OTHERWISE.
2. FACILITIES TO BE DEMOLISHED MAY CONTAIN PCB AND LEAD CONTAMINATED PAINT. REFER TO SECTION 02060 OF THE SPECIFICATIONS.
3. REFER TO DEMOLITION TABLES IN SPECIFICATIONS FOR LIST OF MAJOR BUILDING CONTENTS.
4. MECHANICAL EQUIPMENT/DUCTING NOT SHOWN.

Legend:

No.	DATE	REVISION	REVISION	APPR.
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PERMIT TO PRACTICE
AECOM Canada Ltd.
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Date: [Date]
PERMIT NUMBER: P639
NWT/NJ Association of Professional Engineers and Geoscientists

AECOM

HATCH

SCALE - ECHELLE 2 1 0 2 4 6m

PROJECT - PROJET
DYE-M CAPE DYER

DEW LINE CLEAN UP

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MINISTER OF NATIONAL DEFENCE.

TRADE - METIER
STRUCTURAL

DATE
2010-12-07

SUBJECT - SUJET


ATWELL DORMITORY
PLAN, SECTION AND ELEVATION

PRODUCTION	CONCURRENCE - ASSENTIMENT
DESIGNED ETUDIE DTM/THE	DES OFF AGENT CONCEPT
DRAWN DESSINE IC/CAE	SECT HD CHEF SECT
CHECKED VERIFIE DWF	DES MGR GEST CONCEPT
COORDINATION RRM	REVIEWED - REVU

DWG. NO. - DESSIN NO.
H-C75/3-9101-207

Canada


NWSO NUMBER	COMMENTS
B2A	CONCRETE FOOTINGS/POSTS. METAL ARCH. BUILDING WITH EXTERIOR WALLS AND PITCHED ROOF ADDED.
B2B	ASBESTOS REMOVAL REQUIRED. PCB CONTAMINATED CONCRETE IN MECHANICAL ROOMS.

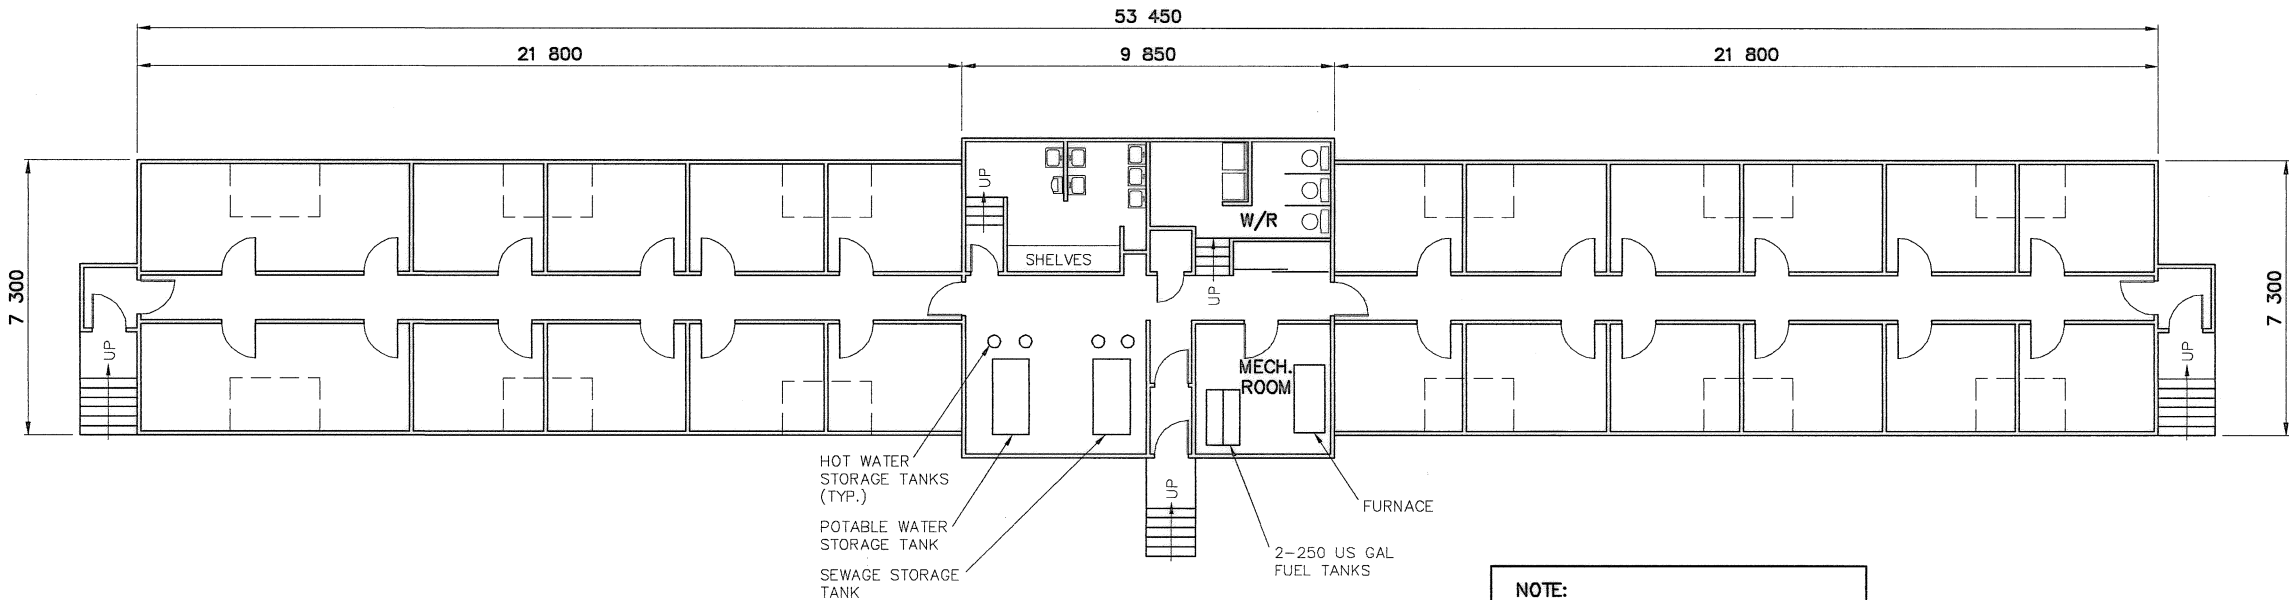


PLAN

NOTE:
REMOVE 10mm THICKNESS OF PCB
CONTAMINATED CONCRETE FROM
FLOORS OF MECHANICAL ROOMS.

NOTE:
CONCRETE FOOTINGS TO BE
DEMOLISHED.

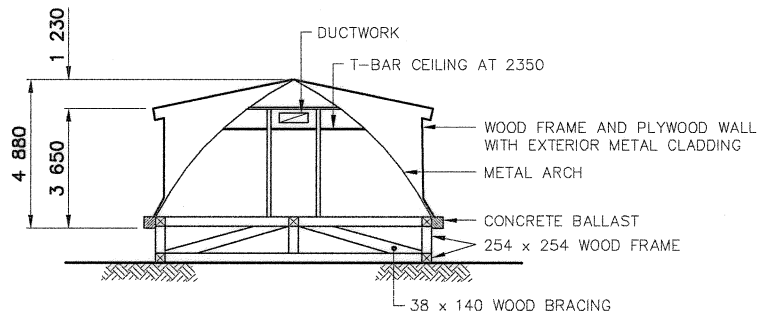

SECTION

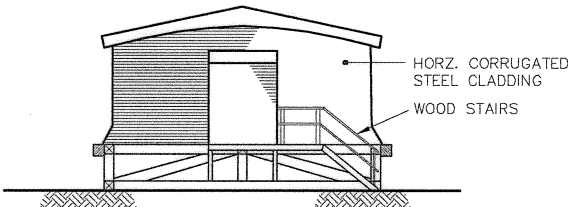


END ELEVATION


General Notes:

1. ALL DIMENSIONS ARE IN MILLIMETRES UNLESS NOTED OTHERWISE.
2. FACILITIES TO BE DEMOLISHED MAY CONTAIN PCB AND LEAD CONTAMINATED PAINT. REFER TO SECTION 02060 OF THE SPECIFICATIONS.
3. REFER TO DEMOLITION TABLES IN SPECIFICATIONS FOR LIST OF MAJOR BUILDING CONTENTS.
4. MECHANICAL EQUIPMENT/DUCTING NOT SHOWN.

Legend:

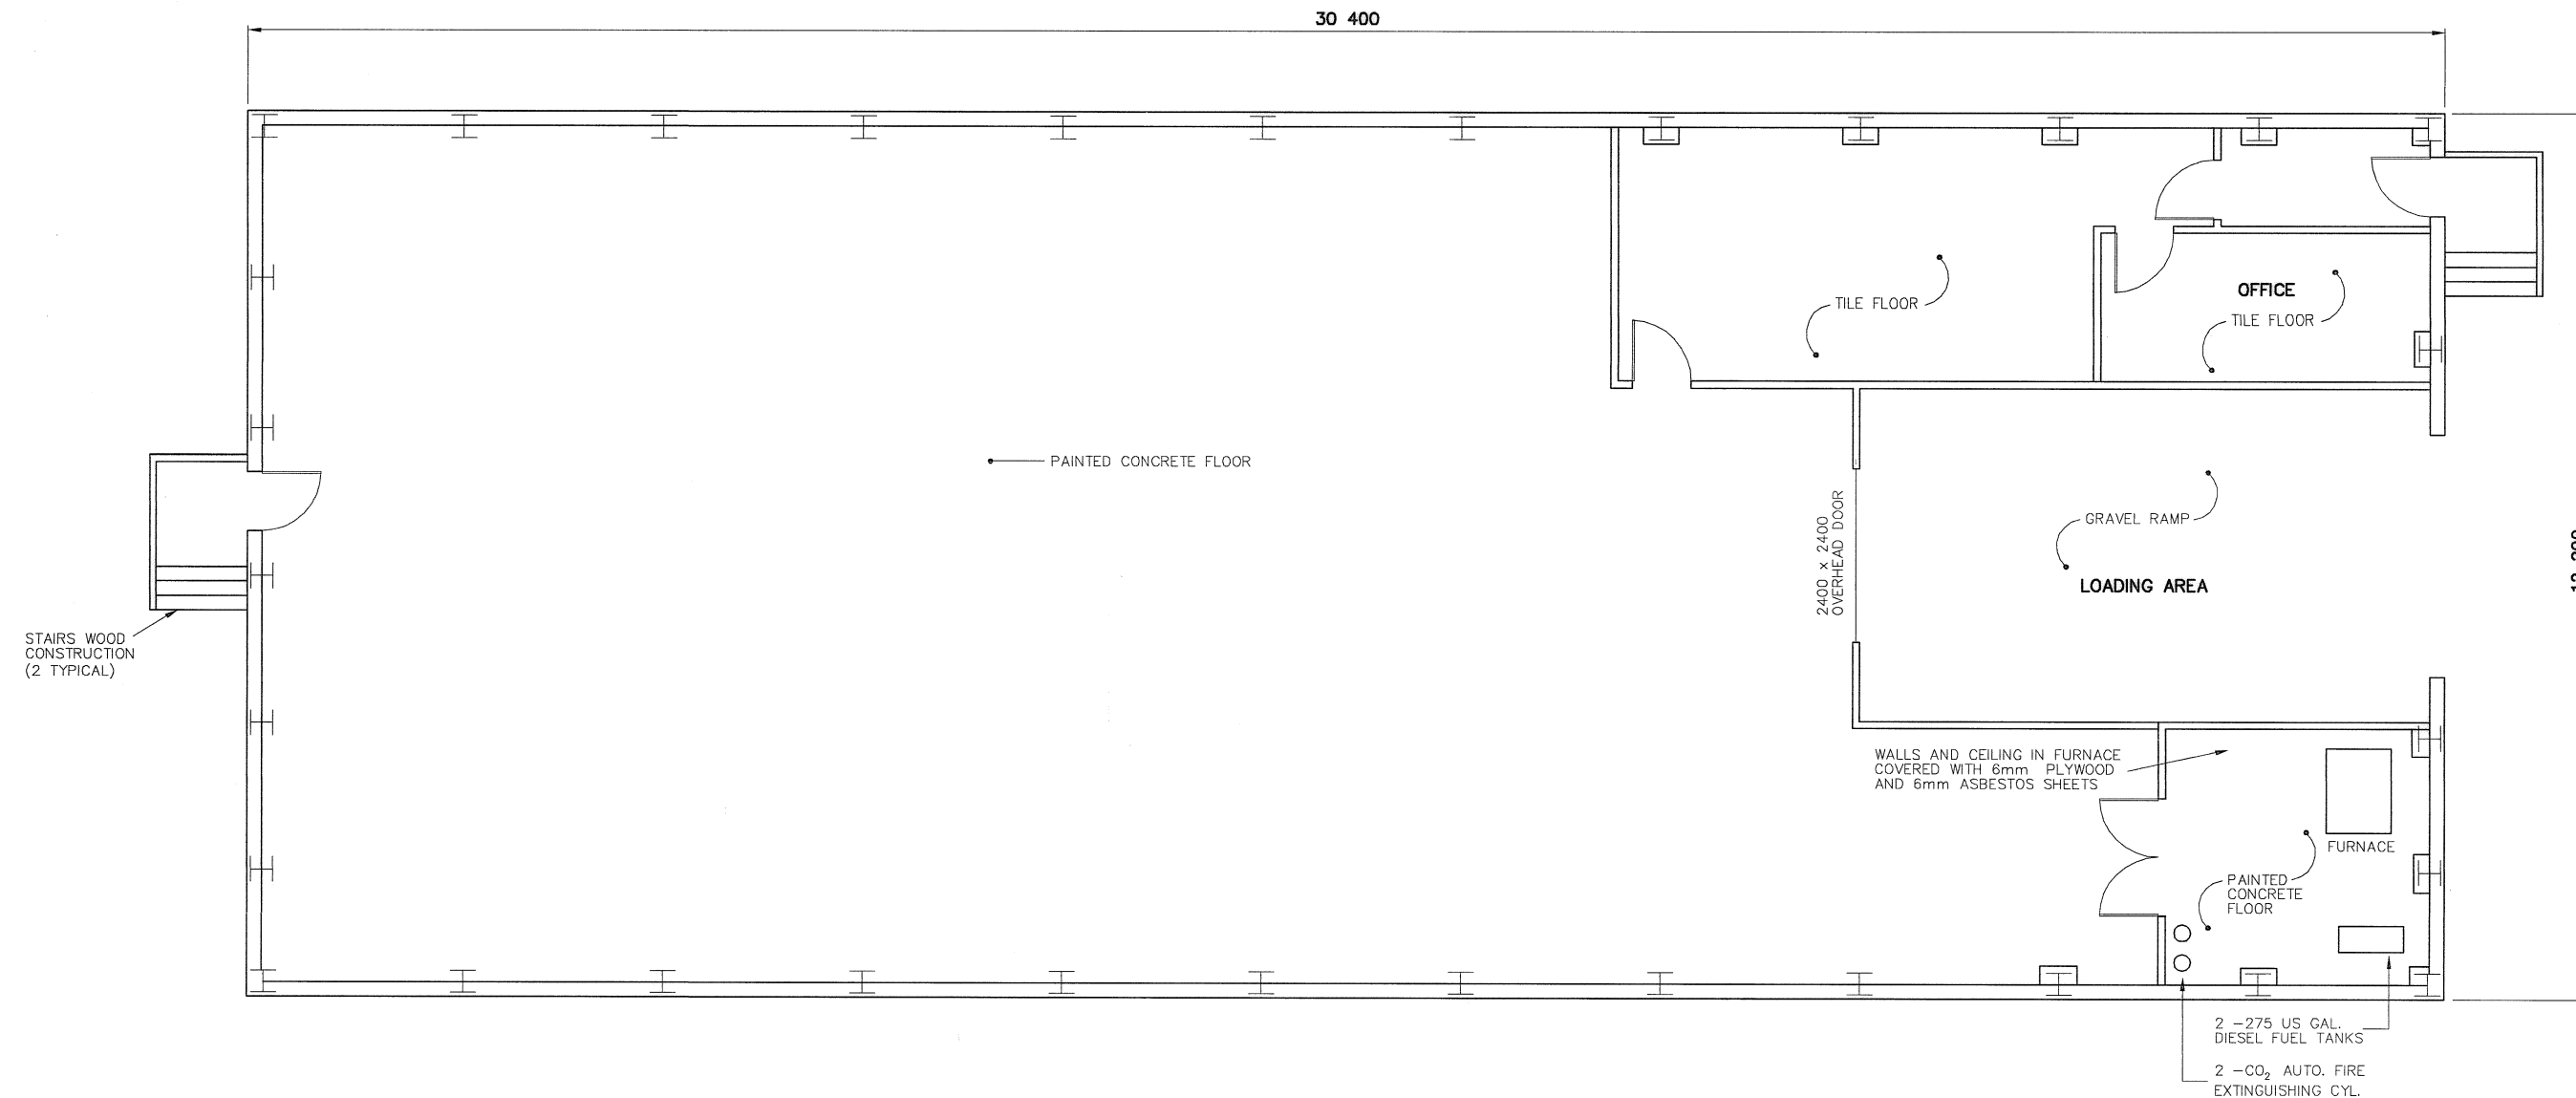


PLAN

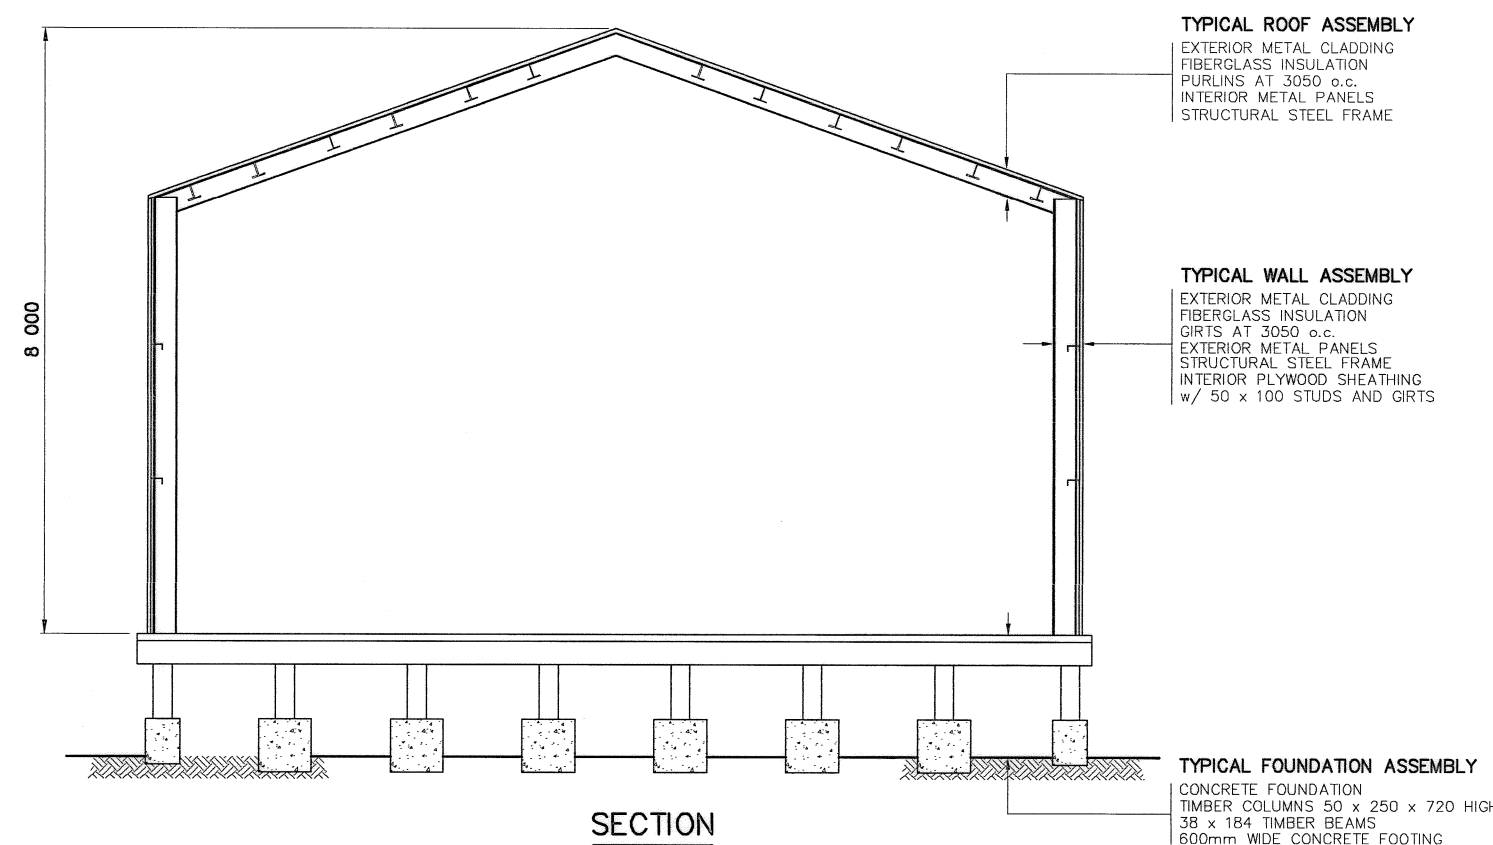

NOTE:
CONCRETE FOOTINGS TO BE
DEMOLISHED.

SECTION

NWSO NUMBER	COMMENTS
B13A	ASBESTOS REMOVAL REQUIRED.

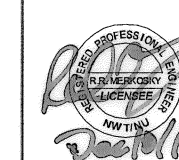

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AECOM Canada Ltd.
Signature: [Signature]
Date: [Date]
PERMIT NUMBER: P639
NWT/NJ Association of Professional
Engineers and Geoscientists

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HATCH

SCALE - ECHELLE 1 0.5 0 1 2 3m

PROJECT - PROJET
DYE-M CAPE DYER

DEW LINE CLEAN UP

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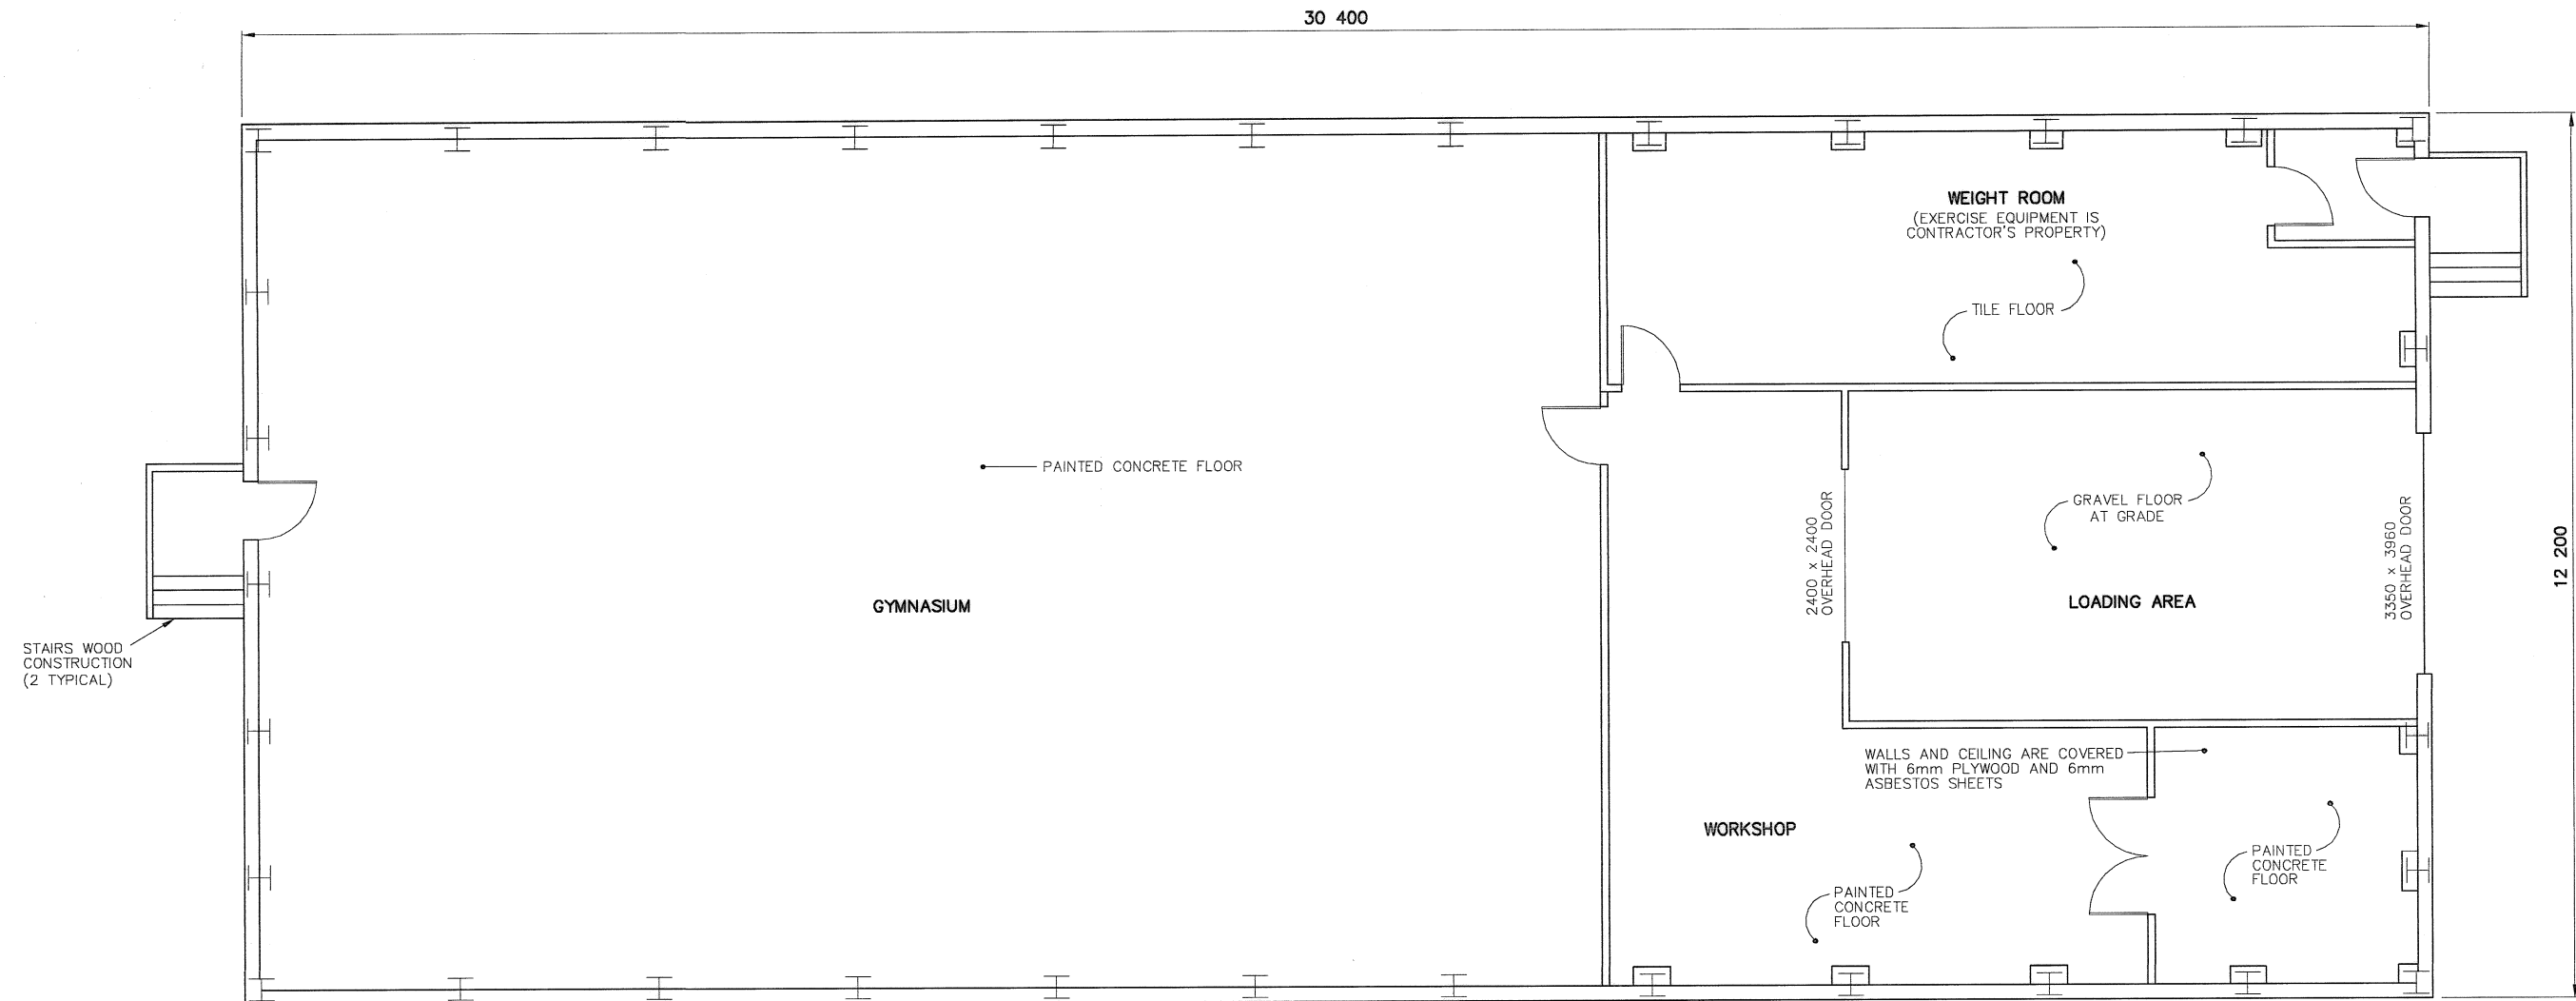
TRADE - METIER STRUCTURAL DATE 2010-12-07

SUBJECT - SUJET
WAREHOUSE-B13A
PLAN AND SECTION


PRODUCTION	CONCURRENCE - ASSENTIMENT
DESIGNED ETUDIE DTR/TME	DES OFF AGENT CONCEPT
DRAWN DESSINE IC/CAE	SECT HD CHEF SECT
CHECKED VERIFIE DWF	DES MGR GEST CONCEPT
COORDINATION RRM	REVIEWED - REVU

DWG. NO. - DESSIN NO.
H-C75/3-9101-208

Canada



PLAN

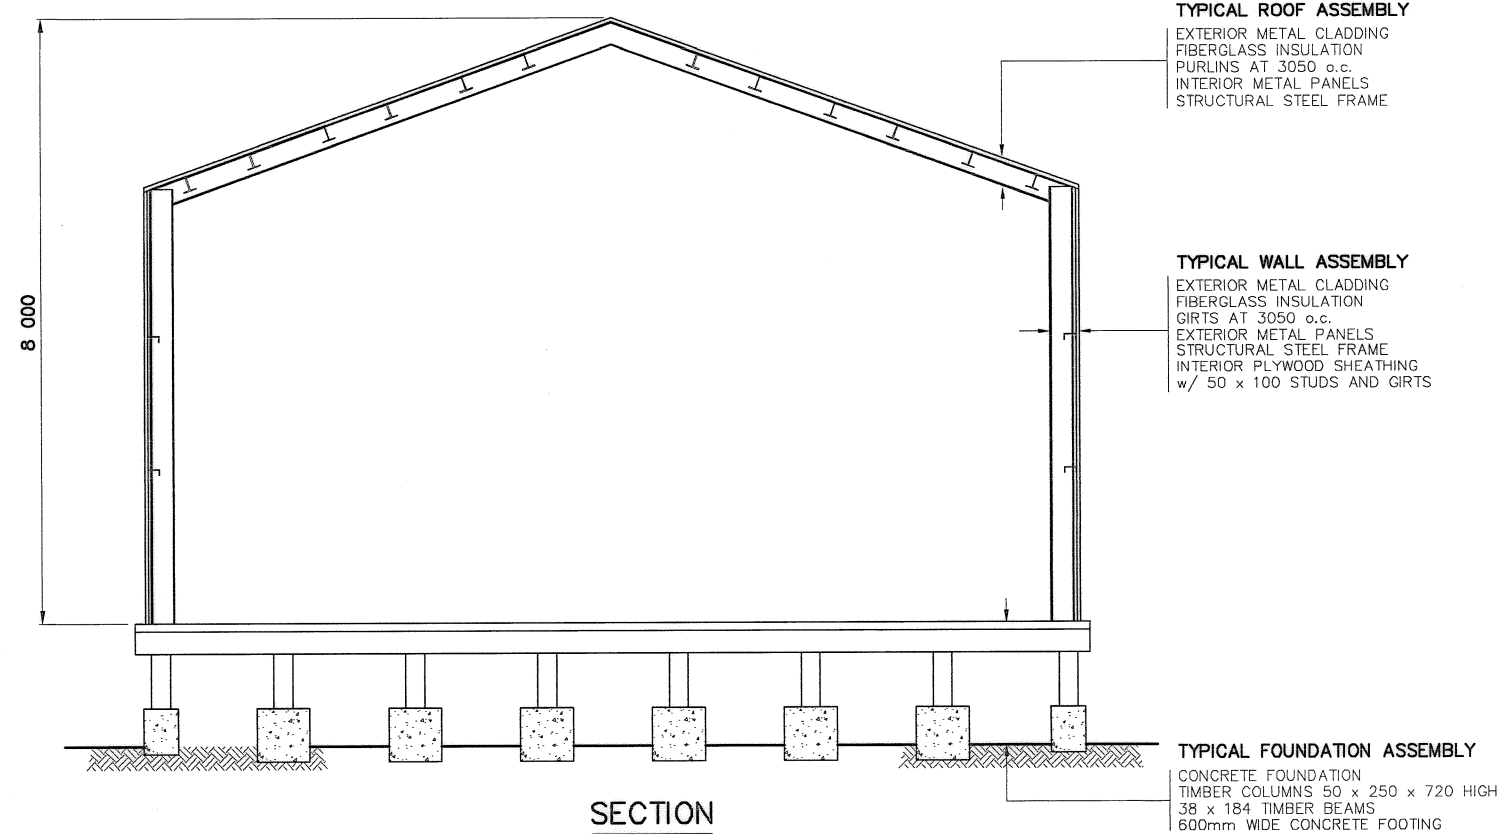

NOTE:
CONCRETE FOOTINGS TO BE
DEMOLISHED.

SECTION


NWSO NUMBER	COMMENTS
B13B	ASBESTOS REMOVAL REQUIRED.

General Notes:

1. ALL DIMENSIONS ARE IN MILLIMETRES UNLESS NOTED OTHERWISE.
2. FACILITIES TO BE DEMOLISHED MAY CONTAIN PCB AND LEAD CONTAMINATED PAINT. REFER TO SECTION 02060 OF THE SPECIFICATIONS.
3. REFER TO DEMOLITION TABLES IN SPECIFICATIONS FOR LIST OF MAJOR BUILDING CONTENTS.
4. MECHANICAL EQUIPMENT/DUCTING NOT SHOWN.

Legend:

No.	DATE	REVISION	REVISION	APPR.
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PERMIT TO PRACTICE
AECOM Canada Ltd.
Signature: *[Signature]*
Date: *[Date]*
PERMIT NUMBER: P639
NWT/NJ Association of Professional Engineers and Geoscientists

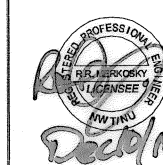AECOM

HATCH

SCALE - ECHELLE 1 0.5 0 1 2 3m

PROJECT - PROJET
DYE-M CAPE DYER

DEW LINE CLEAN UP

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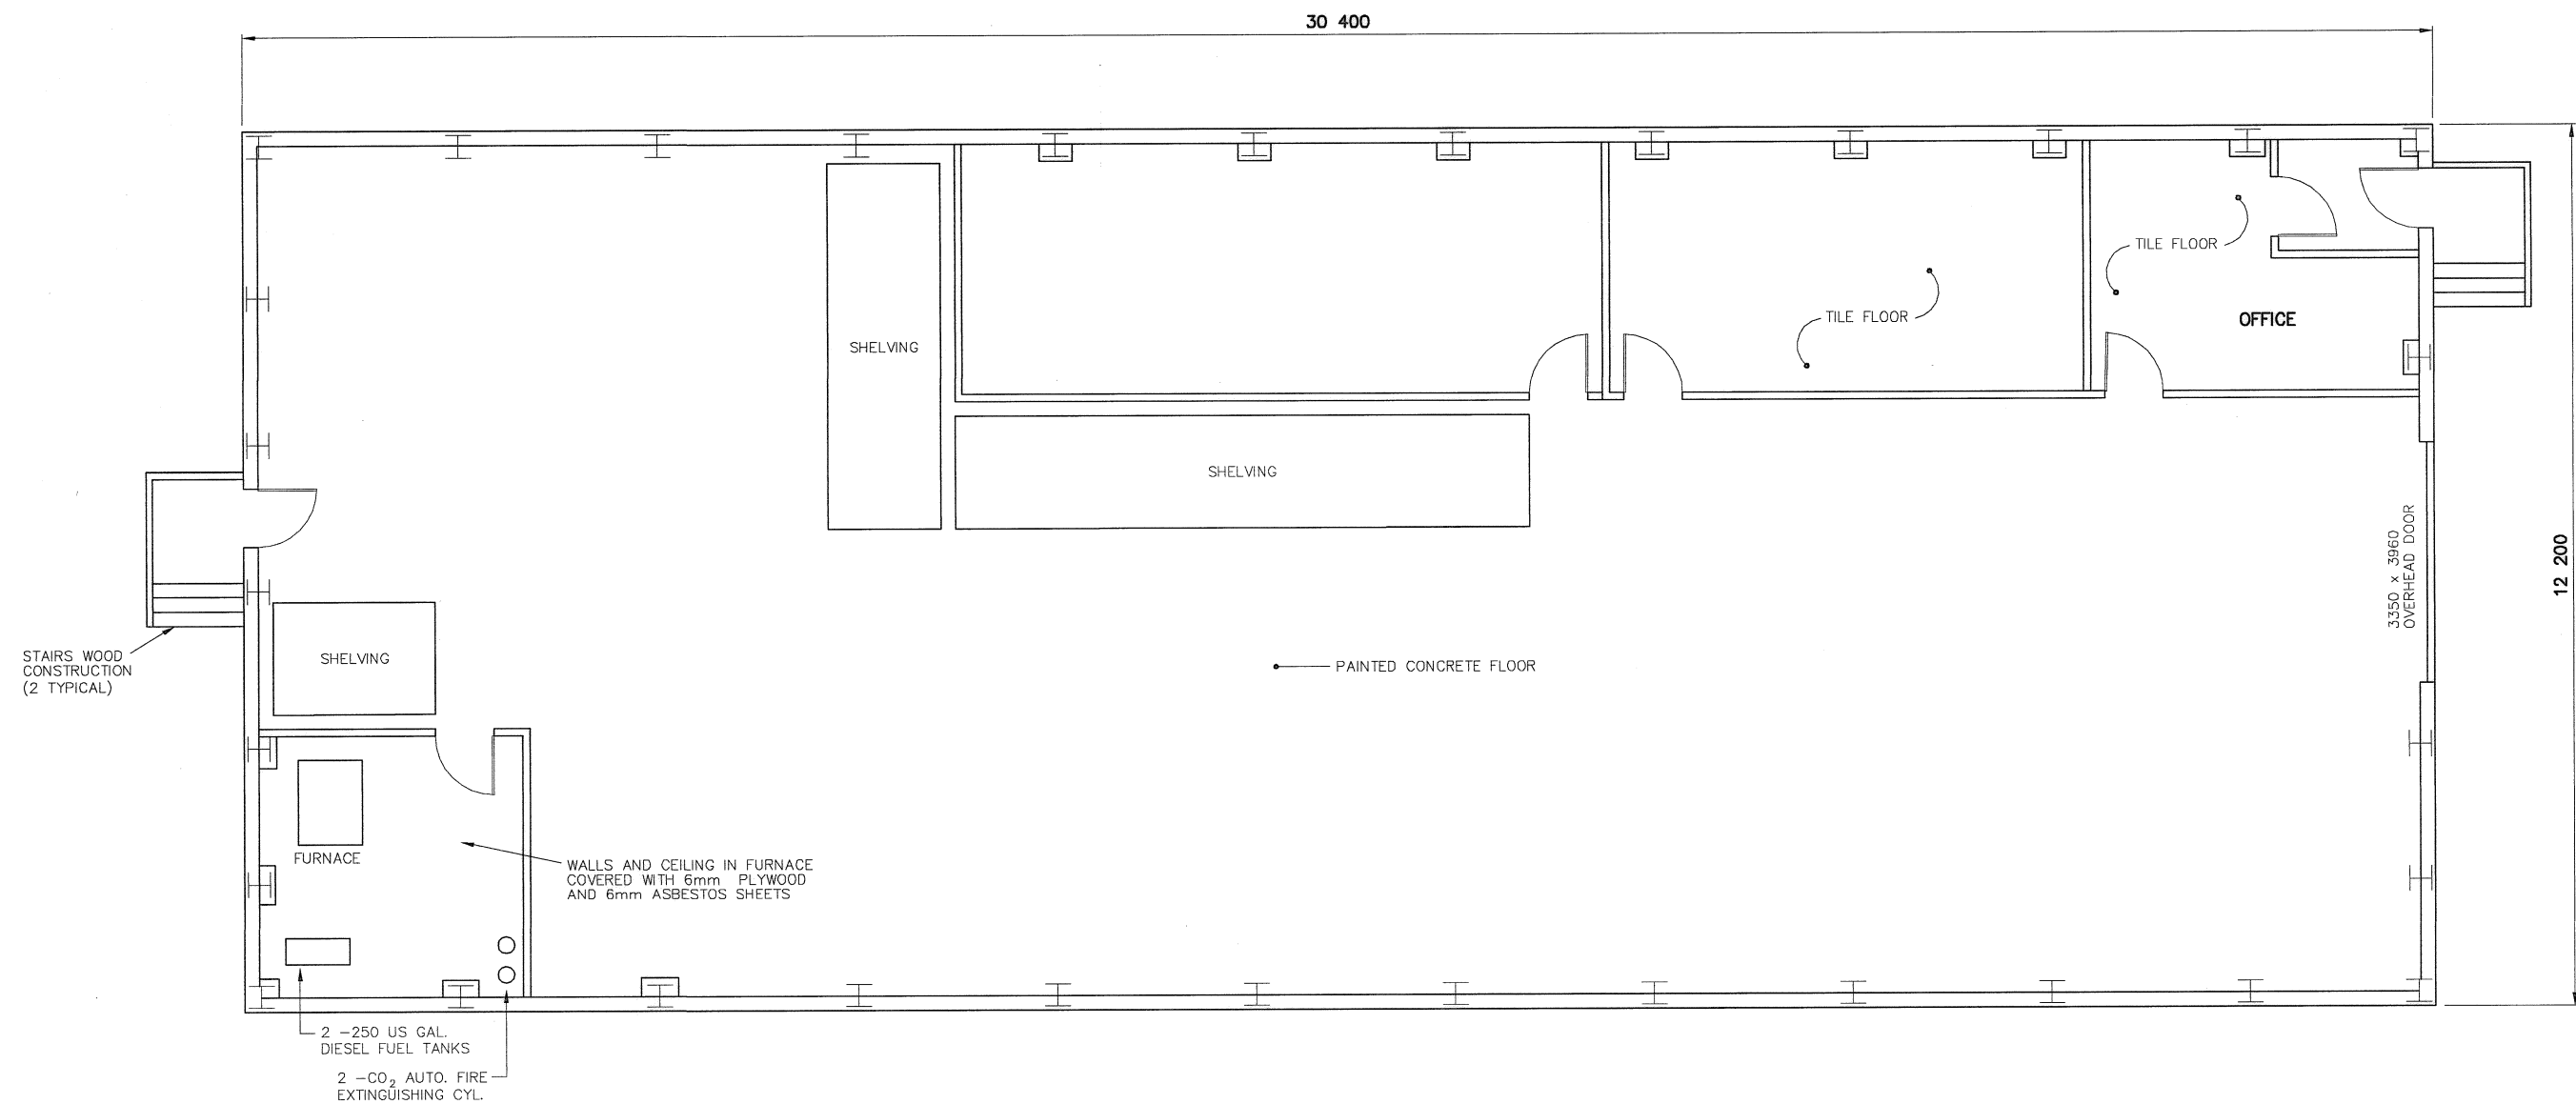
TRADE - METIER
STRUCTURAL
DATE
2010-12-07

SUBJECT - SUJET
WAREHOUSE-B13B
PLAN AND SECTION


PRODUCTION	CONCURRENCE - ASSENTIMENT
DESIGNED ETUDIE DTM/TME	DES OFF AGENT CONCEPT
DRAWN DESSINE IC/CAE	SECT HD CHEF SECT
CHECKED VERIFIE BWF	DES MGR GEST CONCEPT
COORDINATION RRM	REVIEWED - REVU

DWG. NO. - DESSIN NO.
H-C75/3-9101-209

Canada



PLAN

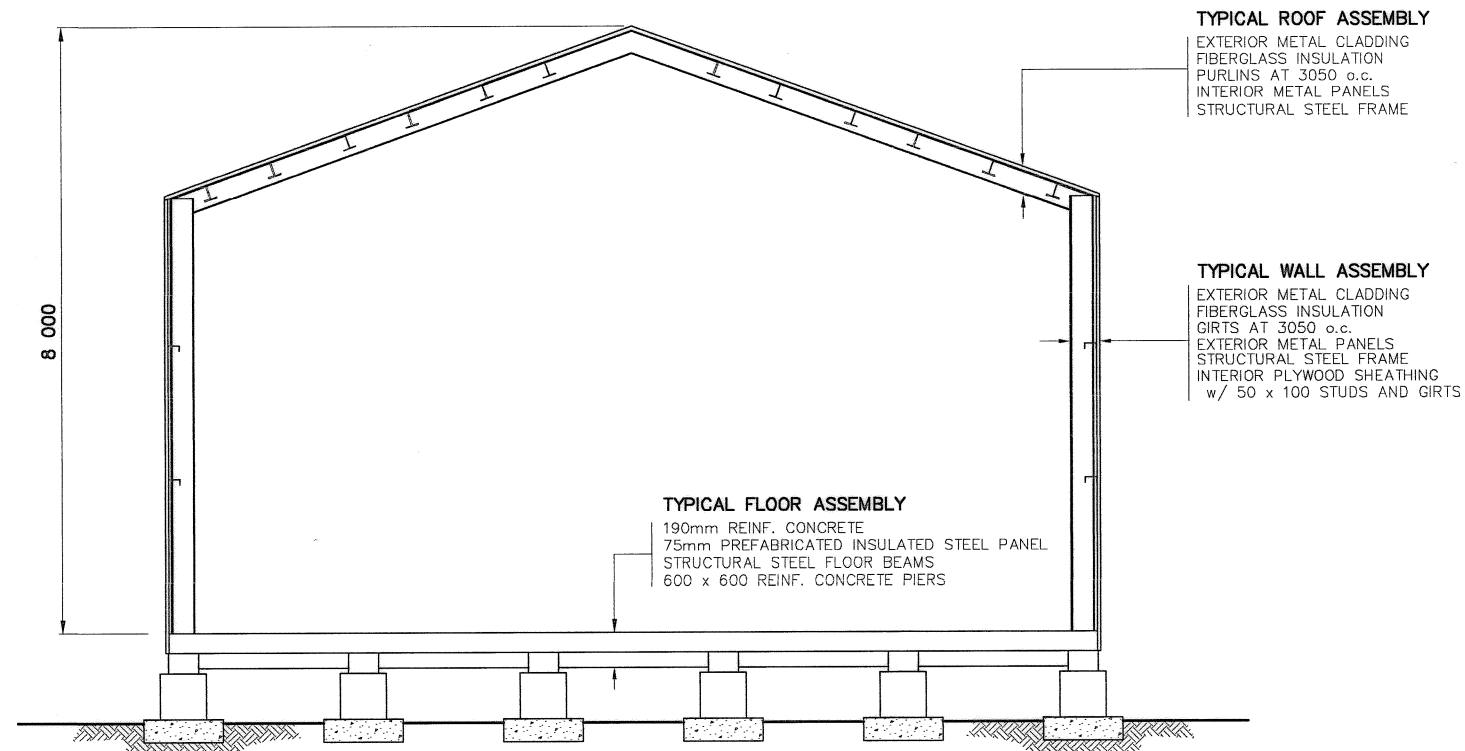

SECTION

NOTE:
CONCRETE FOOTINGS TO BE
DEMOLISHED.

NWSO NUMBER	COMMENTS
B13F	ASBESTOS REMOVAL REQUIRED. ADDITIONAL PORTIONS: 32.7m WOOD FRAME/PLYWOOD.



National Défense
Defence nationale

Headquarters
Quartier général

General Notes:

1. ALL DIMENSIONS ARE IN MILLIMETRES UNLESS NOTED OTHERWISE.
2. FACILITIES TO BE DEMOLISHED MAY CONTAIN PCB AND LEAD CONTAMINATED PAINT. REFER TO SECTION 02080 OF THE SPECIFICATIONS.
3. REFER TO DEMOLITION TABLES IN SPECIFICATIONS FOR LIST OF MAJOR BUILDING CONTENTS.
4. MECHANICAL EQUIPMENT/DUCTING NOT SHOWN.

Legend:

No.	DATE	REVISION	REVISION	APPR.
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Signature: *[Signature]*
Date: *Dec 10/10*
PERMIT NUMBER: P639
NWT/NL Association of Professional Engineers and Geoscientists

AECOM

HATCH

SCALE - ECHELLE 1 0.5 0 1 2 3m

PROJECT - PROJET
DYE-M CAPE DYER

DEW LINE CLEAN UP

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TRADE - METIER STRUCTURAL DATE 2010-12-07


SUBJECT - SUJET

WAREHOUSE-B13F
PLAN AND SECTION


PRODUCTION	CONCURRENCE - ASSENTIMENT
DESIGNED ETUDIE <i>DYM/THE</i>	DES OFF AGENT CONCEPT
DRAWN DESSINE <i>IC/CAE</i>	SECT HD CHEF SECT
CHECKED VERIFIE <i>DWF</i>	DES MGR GEST CONCEPT
COORDINATION <i>RAM</i>	REVIEWED - REVU

DWG. NO. - DESSIN NO.
H-C75/3-9101-210

Canada

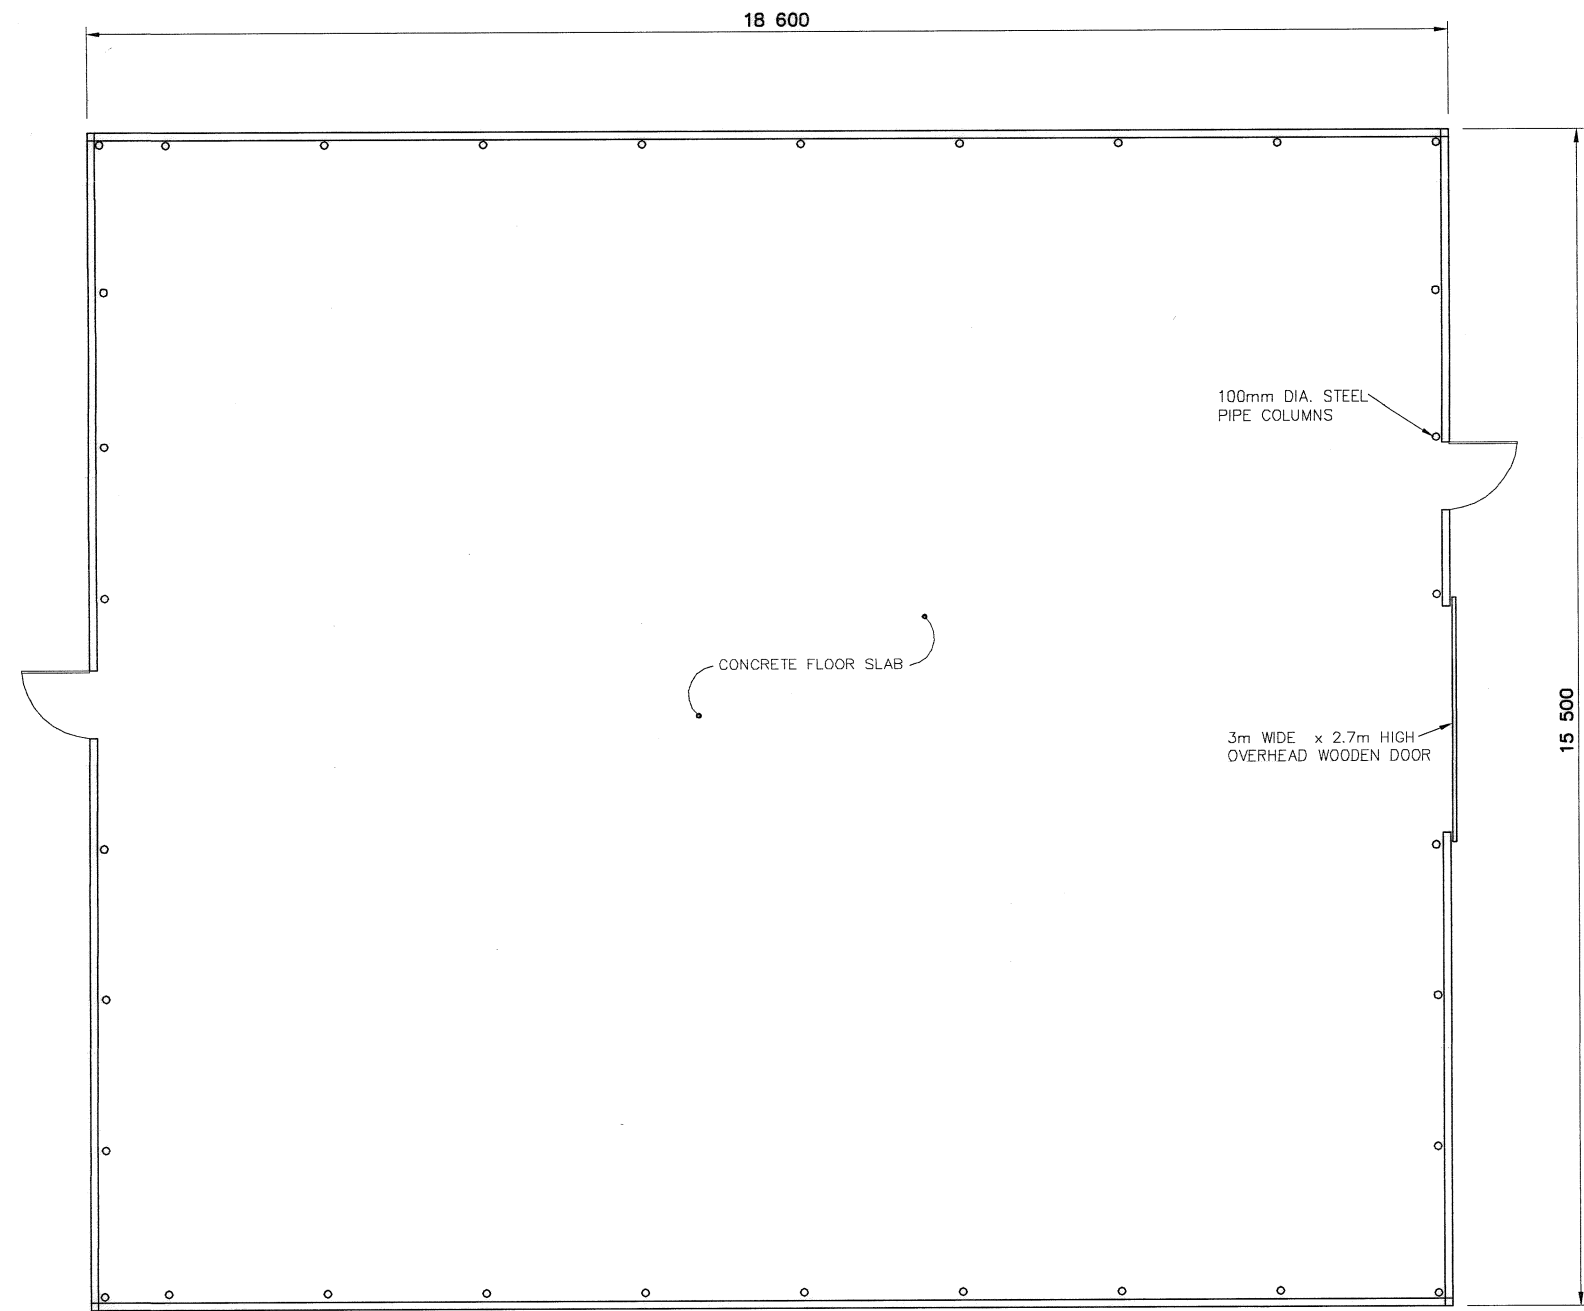

PLAN

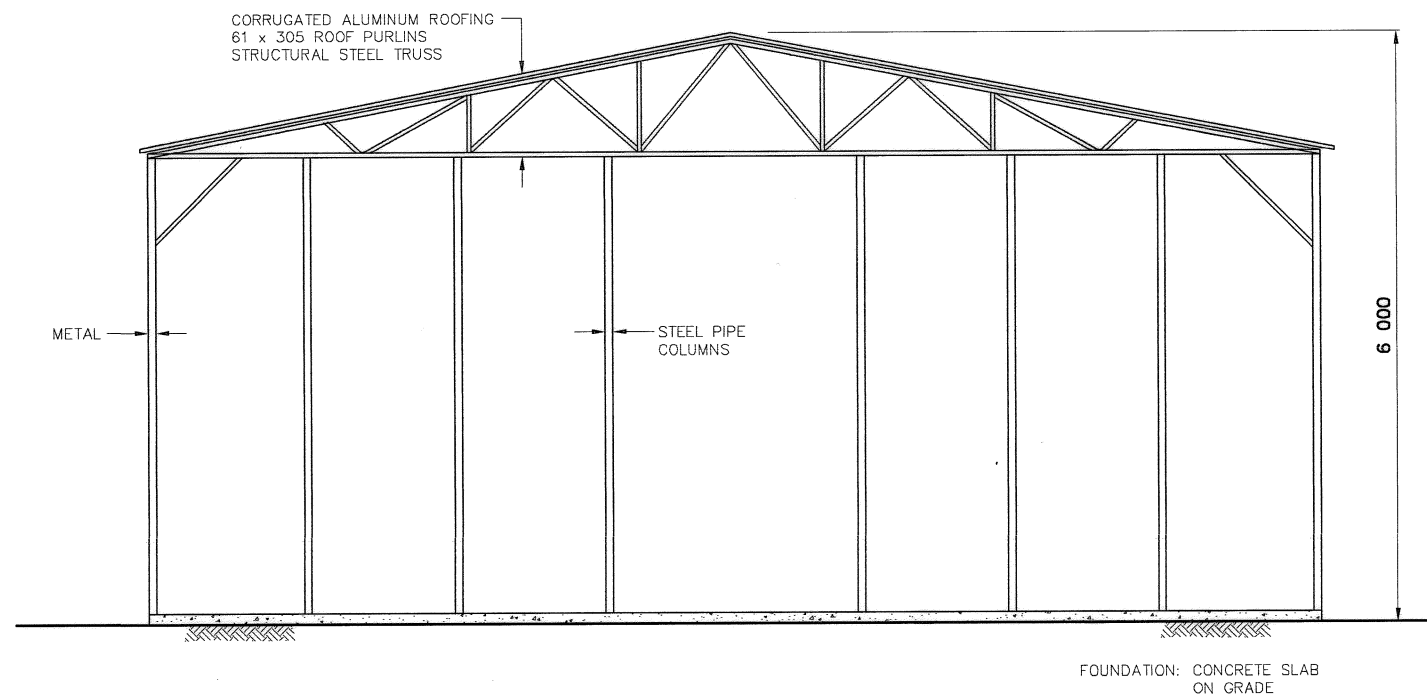

SECTION

NOTE:
REMOVE BARRELS AND CONTAINERS IN
STORAGE AND UNDERLYING GEOMEMBRANE
LINER PRIOR TO DEMOLITION.

NOTE:
DEMOLISH STRUCTURE TO TOP OF CONCRETE
FLOOR SLAB.

NWSO NUMBER	COMMENTS
B13E	AS SHOWN


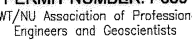
General Notes:

1. ALL DIMENSIONS ARE IN MILLIMETRES UNLESS NOTED OTHERWISE.
2. FACILITIES TO BE DEMOLISHED MAY CONTAIN PCB AND LEAD CONTAMINATED PAINT. REFER TO SECTION 02060 OF THE SPECIFICATIONS.
3. REFER TO DEMOLITION TABLES IN SPECIFICATIONS FOR LIST OF MAJOR BUILDING CONTENTS.
4. MECHANICAL EQUIPMENT/DUCTING NOT SHOWN.

Legend:

No.	DATE	REVISION	REVISION	APPR.
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Signature: 
Date: 
PERMIT NUMBER: P639
NWT/NU Association of Professional Engineers and Geoscientists

AECOM

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SCALE - ECHELLE N.T.S.

PROJECT - PROJET
DYE-M CAPE DYER

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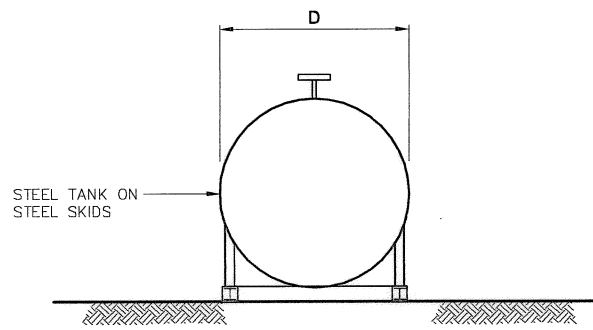
TRADE - METIER STRUCTURAL DATE 2010-12-07
SUBJECT - SUJET

WAREHOUSE-B13E
PLAN AND SECTION


PRODUCTION	CONCURRENCE - ASSENTIMENT
DESIGNED ETUDIE DTM/THE	DES OFF AGENT CONCEPT
DRAWN DESSINE IC/CAE	SECT HD CHEF SECT
CHECKED VERIFIE DWF	DES MGR GEST CONCEPT
COORDINATION RRM	REVIEWED - REVU

DWG. NO. - DESSIN NO.
H-C75/3-9101-211

Canada



FRONT ELEVATION

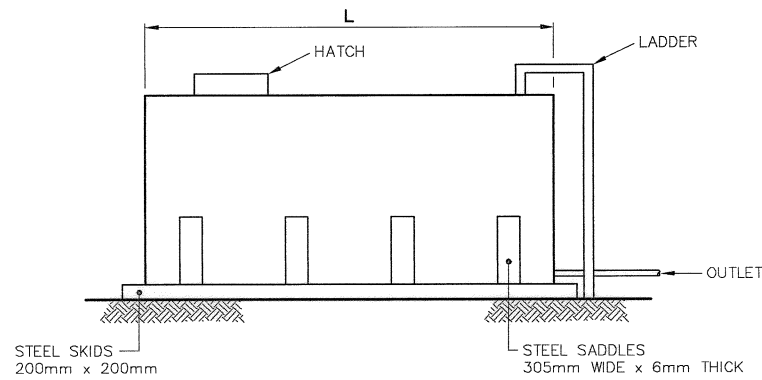


SIDE ELEVATION


6000 GALLON FUEL TANK

N.T.S.

NWSO NUMBER	COMMENTS
W38G	6000 US GALLON CAPACITY (MOGAS) D = 2400mm ; L = 5400mm 4 - STEEL SADDLES AT 1400mm O.C.

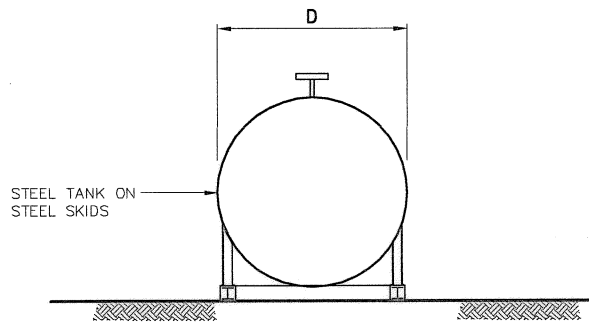

FRONT ELEVATION

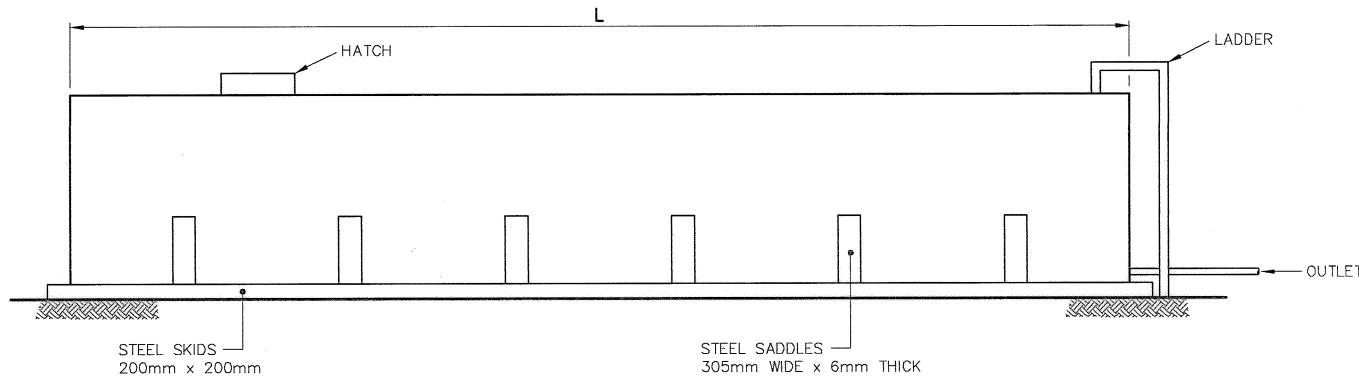

SIDE ELEVATION

18 300 GALLON FUEL TANK

N.T.S.

NWSO NUMBER	COMMENTS
W19G	18 300 US GALLON CAPACITY D = 2500mm ; L = 14 000mm 6 - STEEL SADDLES AT 2200mm o.c.



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Defence nationale

Headquarters
Quartier général

General Notes:

1. ALL DIMENSIONS ARE IN MILLIMETRES UNLESS NOTED OTHERWISE.
2. REFER TO DEMOLITION TABLES IN SPECIFICATIONS FOR LIST OF MAJOR BUILDING CONTENTS.
3. FACILITIES TO BE DEMOLISHED MAY CONTAIN PCB AND LEAD CONTAMINATED PAINT. REFER TO SECTION 02060 OF THE SPECIFICATIONS.

Legend:

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Date: [Date]
PERMIT NUMBER: P639
NWT/NJ Association of Professional
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AECOM

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SCALE - ECHELLE 1 0.5 0 1 2 3m

PROJECT - PROJET
DYE-M CAPE DYER

DEW LINE CLEAN UP

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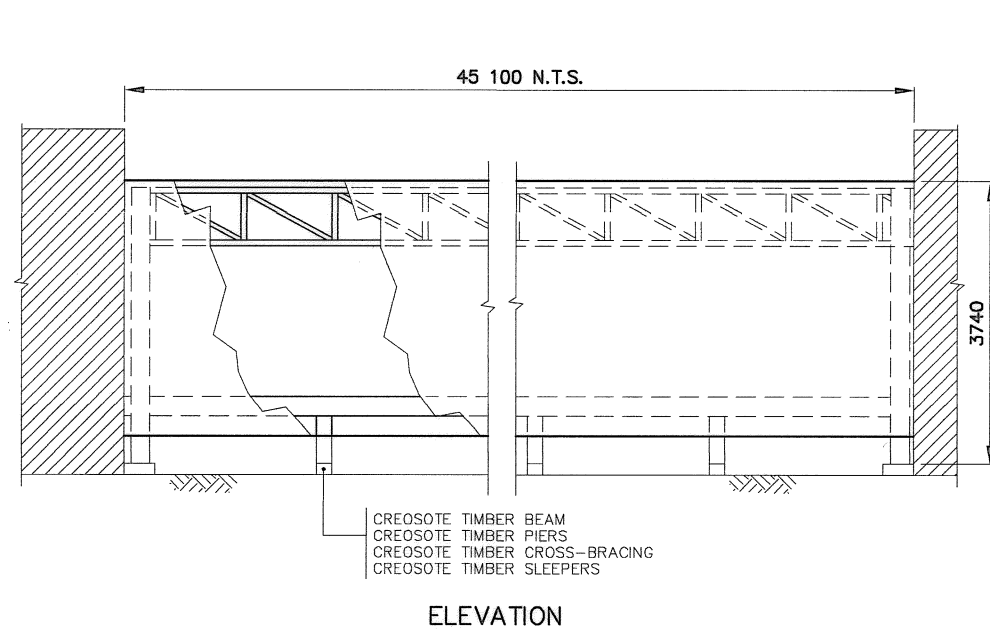
TRADE - METIER	STRUCTURAL	DATE	2010-12-07
SUBJECT - SUJET			

FUEL TANKS
ELEVATIONS


PRODUCTION	CONCURRENCE - ASSENTIMENT	
DESIGNED ETUDIE DYM/TME	DES OFF AGENT CONCEPT	
DRAWN DESSINE IC/CAE	SECT HD CHEF SECT	
CHECKED VERIFIE DMF	DES MGR GEST CONCEPT	
COORDINATION RRM	REVIEWED - REVU	

DWG. NO. - DESSIN NO.
H-C75/3-9101-212

Canada




ELEVATION

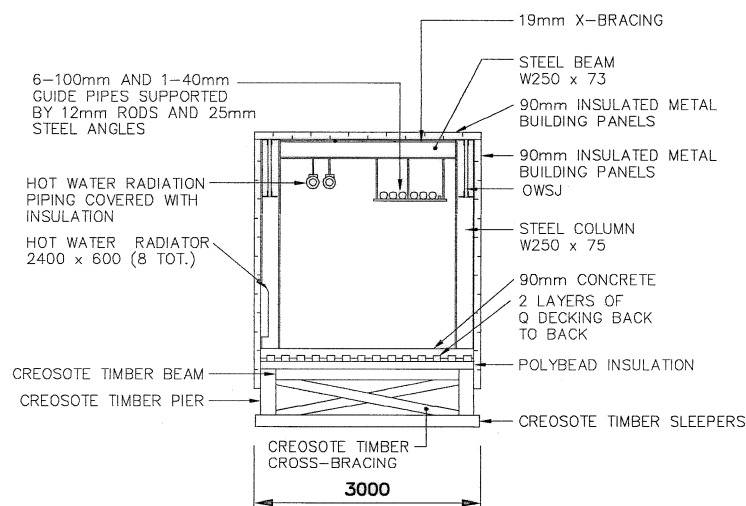


SECTION


BUILDING LINK

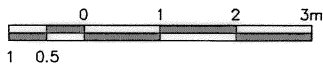

NWSO NUMBER	COMMENTS
W42D	45m TOTAL LENGTH.



National
Defence



D fense
nationale

Headquarters
Quartier g n ral

General Notes:


1. ALL DIMENSIONS ARE IN MILLIMETRES UNLESS NOTED OTHERWISE.


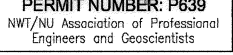
2. REFER TO DEMOLITION TABLES IN SPECIFICATIONS FOR LIST OF MAJOR BUILDING CONTENTS.

3. FACILITIES TO BE DEMOLISHED MAY CONTAIN PCB AND LEAD CONTAMINATED PAINT. REFER TO SECTION 02060 OF THE SPECIFICATIONS.

Legend:

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SCALE - ECHELLE
AS SHOWN

PROJECT - PROJET
DYE-M CAPE DYER

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TRADE - METIER
STRUCTURAL

DATE
2010-12-07

SUBJECT - SUJET
BUILDING LINK
SECTION AND ELEVATION

PRODUCTION	CONCURRENCE - ASSENTIMENT
DESIGNED �TU�DIE DTH/TME	DES OFF AGENT CONCEPT
DRAWN DESSINE IC/CNE	SECT HD CHEF SECT
CHECKED VERIFIE DUFF	DES MGR GEST CONCEPT
COORDINATION RRM	REVIEWED - REVU

DWG. NO. - DESSIN NO.
H-C75/3-9101-213

Canada

General Notes:

1. ALL DIMENSIONS ARE IN MILLIMETRES UNLESS NOTED OTHERWISE.
2. REFER TO DEMOLITION TABLES IN SPECIFICATIONS FOR LIST OF MAJOR BUILDING CONTENTS.
3. FACILITIES TO BE DEMOLISHED MAY CONTAIN PCB AND LEAD CONTAMINATED PAINT. REFER TO SECTION 02060 OF THE SPECIFICATIONS.

Legend:

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Date: *[Date]*
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SCALE - ECHELLE AS SHOWN

PROJECT - PROJET
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TRADE - METIER STRUCTURAL DATE 2010-12-07

SUBJECT - SUJET
SMALL COMMUNICATION BILLBOARD,
FEEDHORN FOUNDATION
PLAN, SECTION AND ELEVATIONS


PRODUCTION	CONCURRENCE - ASSENTIMENT
DESIGNED ETUDIE DTH/THE	DES OFF AGENT CONCEPT
DRAWN DESSINE IC/CAE	SECT HD CHEF SECT
CHECKED VERIFIE DWF	DES MGR GEST CONCEPT
COORDINATION RRM	REVIEWED - REVU

DWG. NO. - DESSIN NO.
H-C75/3-9101-214


Canada

NOTE:
SMALL COMMUNICATION BILLBOARDS
ARE OVERTURNED BESIDE CONCRETE
FOUNDATIONS.

NWSO NUMBER	COMMENTS
W09C	RIBBED CLADDING ON REAR AND SIDES. (GALBESTOS)
W09C	NO CLADDING.

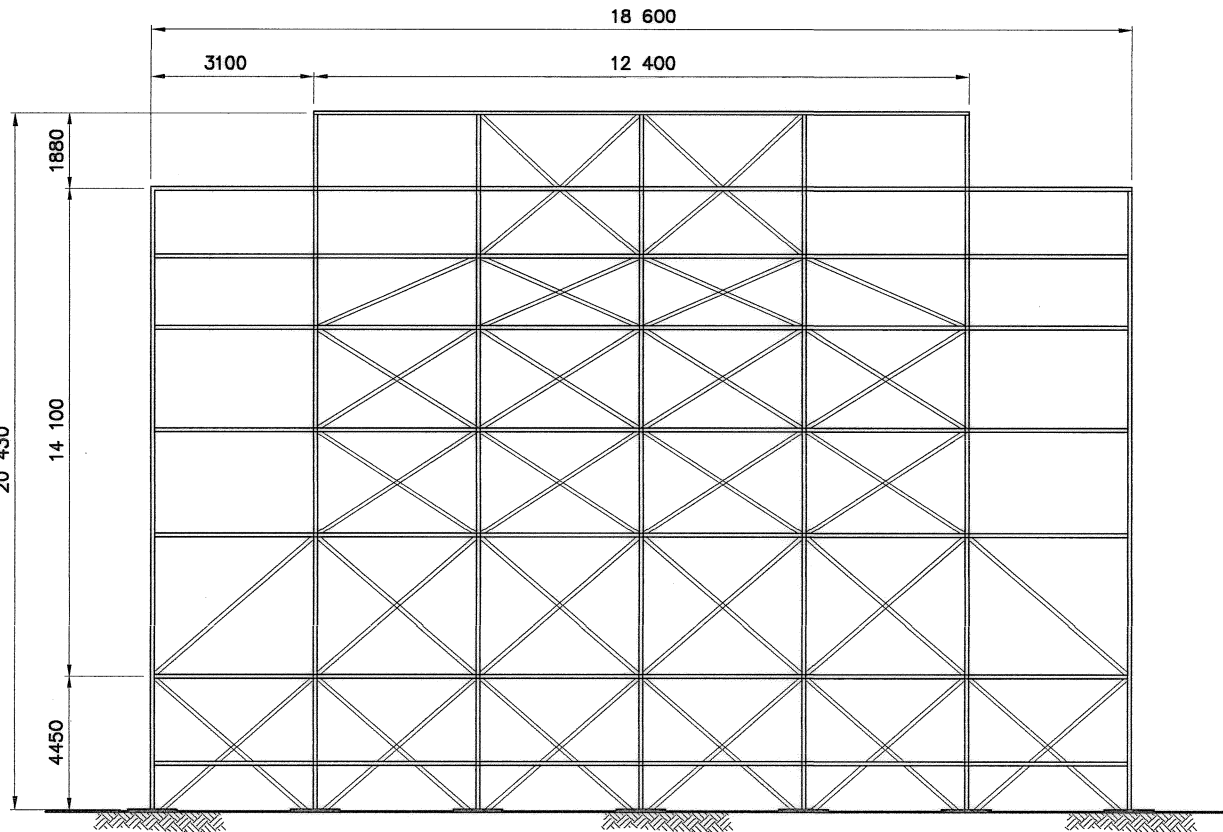


REAR ELEVATION

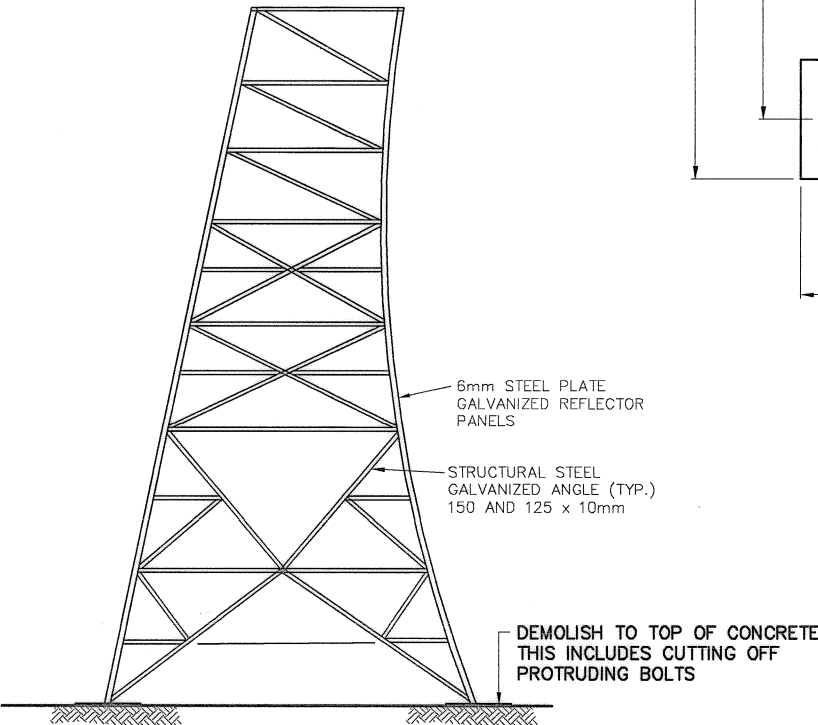

SECTION


SMALL COMMUNICATION BILLBOARD

N.T.S.

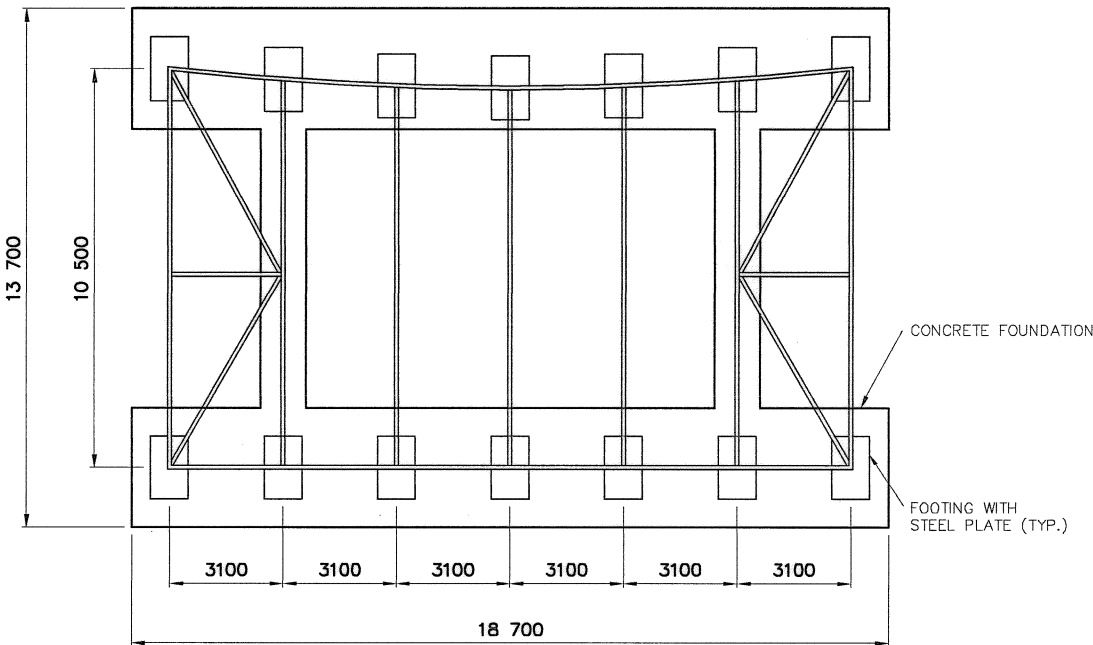


PLAN

- NOTES:
1. VISIBLE FOUNDATIONS ARE 1300 x 1700 CONCRETE FOOTINGS AT GRADE.

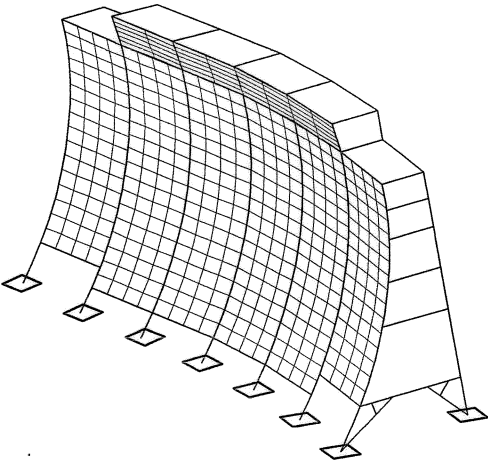


ISOMETRIC VIEW

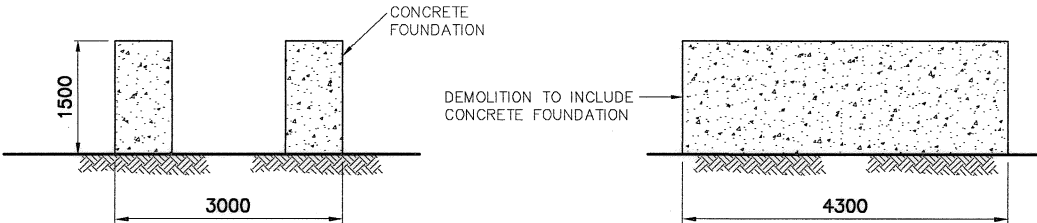

SIDE ELEVATION

END ELEVATION


TYPICAL FEEDHORN FOUNDATION (SMALL BILLBOARDS)

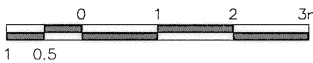



- General Notes:
1. ALL DIMENSIONS ARE IN MILLIMETRES UNLESS NOTED OTHERWISE.
 2. REFER TO DEMOLITION TABLES IN SPECIFICATIONS FOR LIST OF MAJOR BUILDING CONTENTS.

Legend:

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SCALE - ECHELLE 3 1.5 0 3 6 9m

PROJECT - PROJET
DYE-M CAPE DYER

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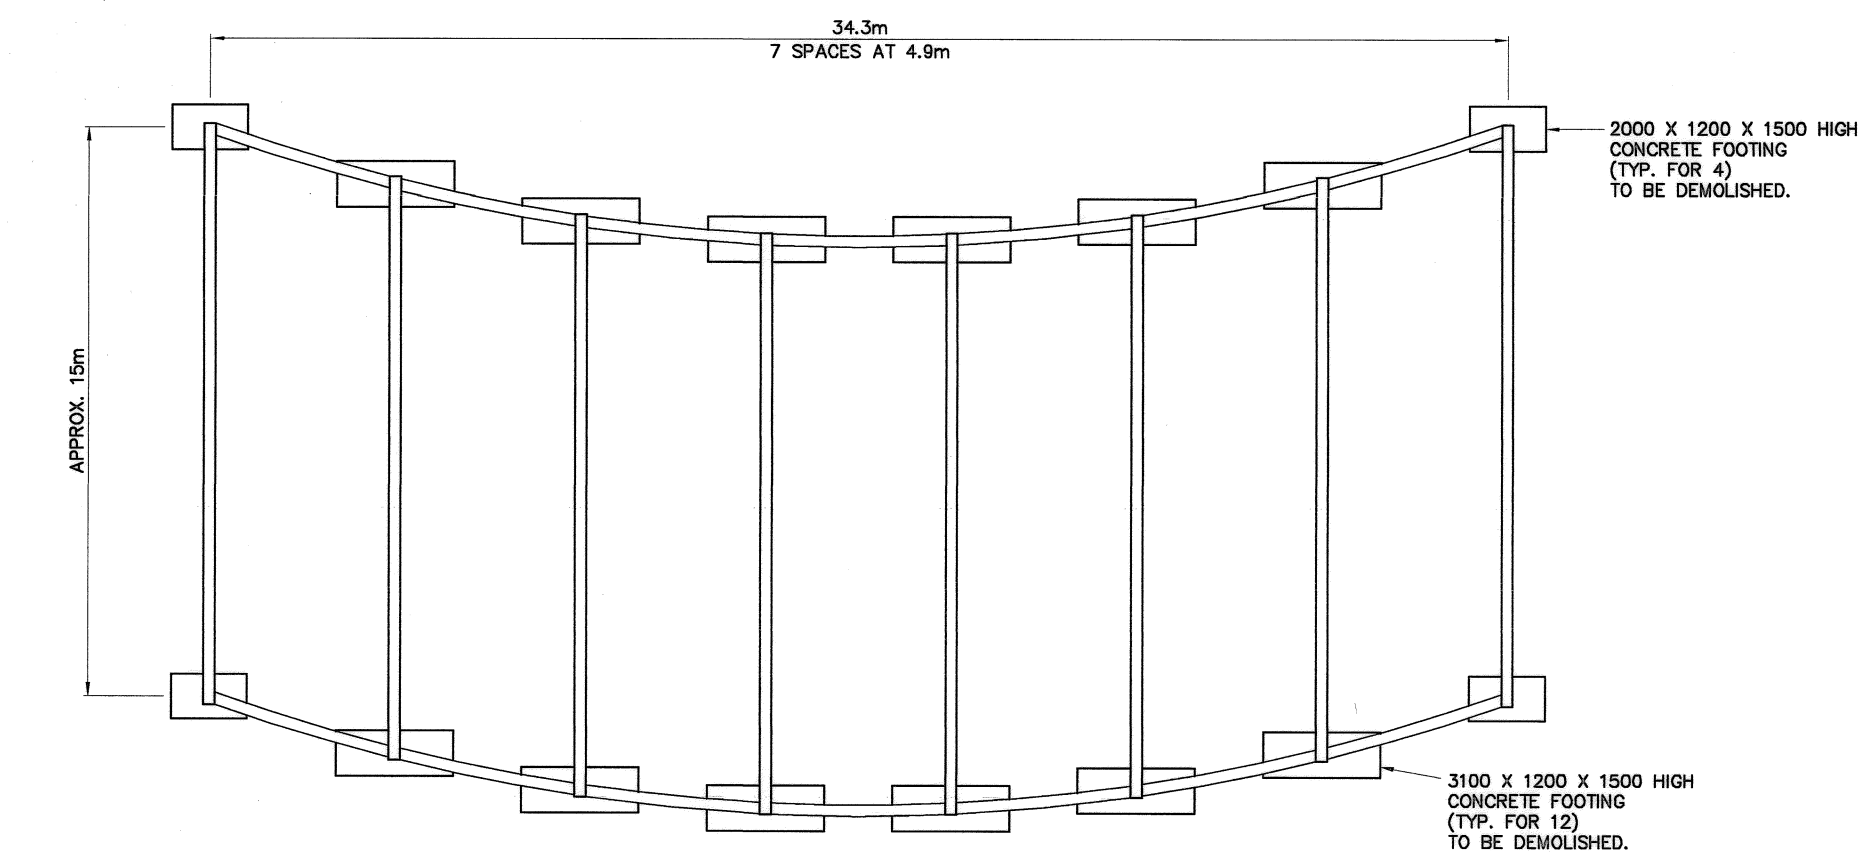
TRADE - METIER STRUCTURAL
DATE 2010-12-07

SUBJECT - SUJET

LARGE COMMUNICATION BILLBOARD
PLAN, SECTION AND ELEVATION

PRODUCTION	CONCURRENCE - ASSENTIMENT
DESIGNED ETUDIE DTM/TME	DES OFF AGENT CONCEPT
DRAWN DESSINE IC/CME	SECT HD CHIEF SECT
CHECKED VERIFIE BWF	DES MGR GEST CONCEPT
COORDINATION RRM	REVIEWED - REVU


DWG. NO. - DESSIN NO.
H-C75/3-9101-215




PLAN

NWSO NUMBER	COMMENTS
W09C	36.6m HIGH BILLBOARD (NOT ENCLOSED) WITH CONCRETE FOOTING FOUNDATIONS.
W09-C	MESH REFLECTORS ON CURVED PORTION.


NOTE:
CONCRETE FOOTINGS TO BE
DEMOLISHED.

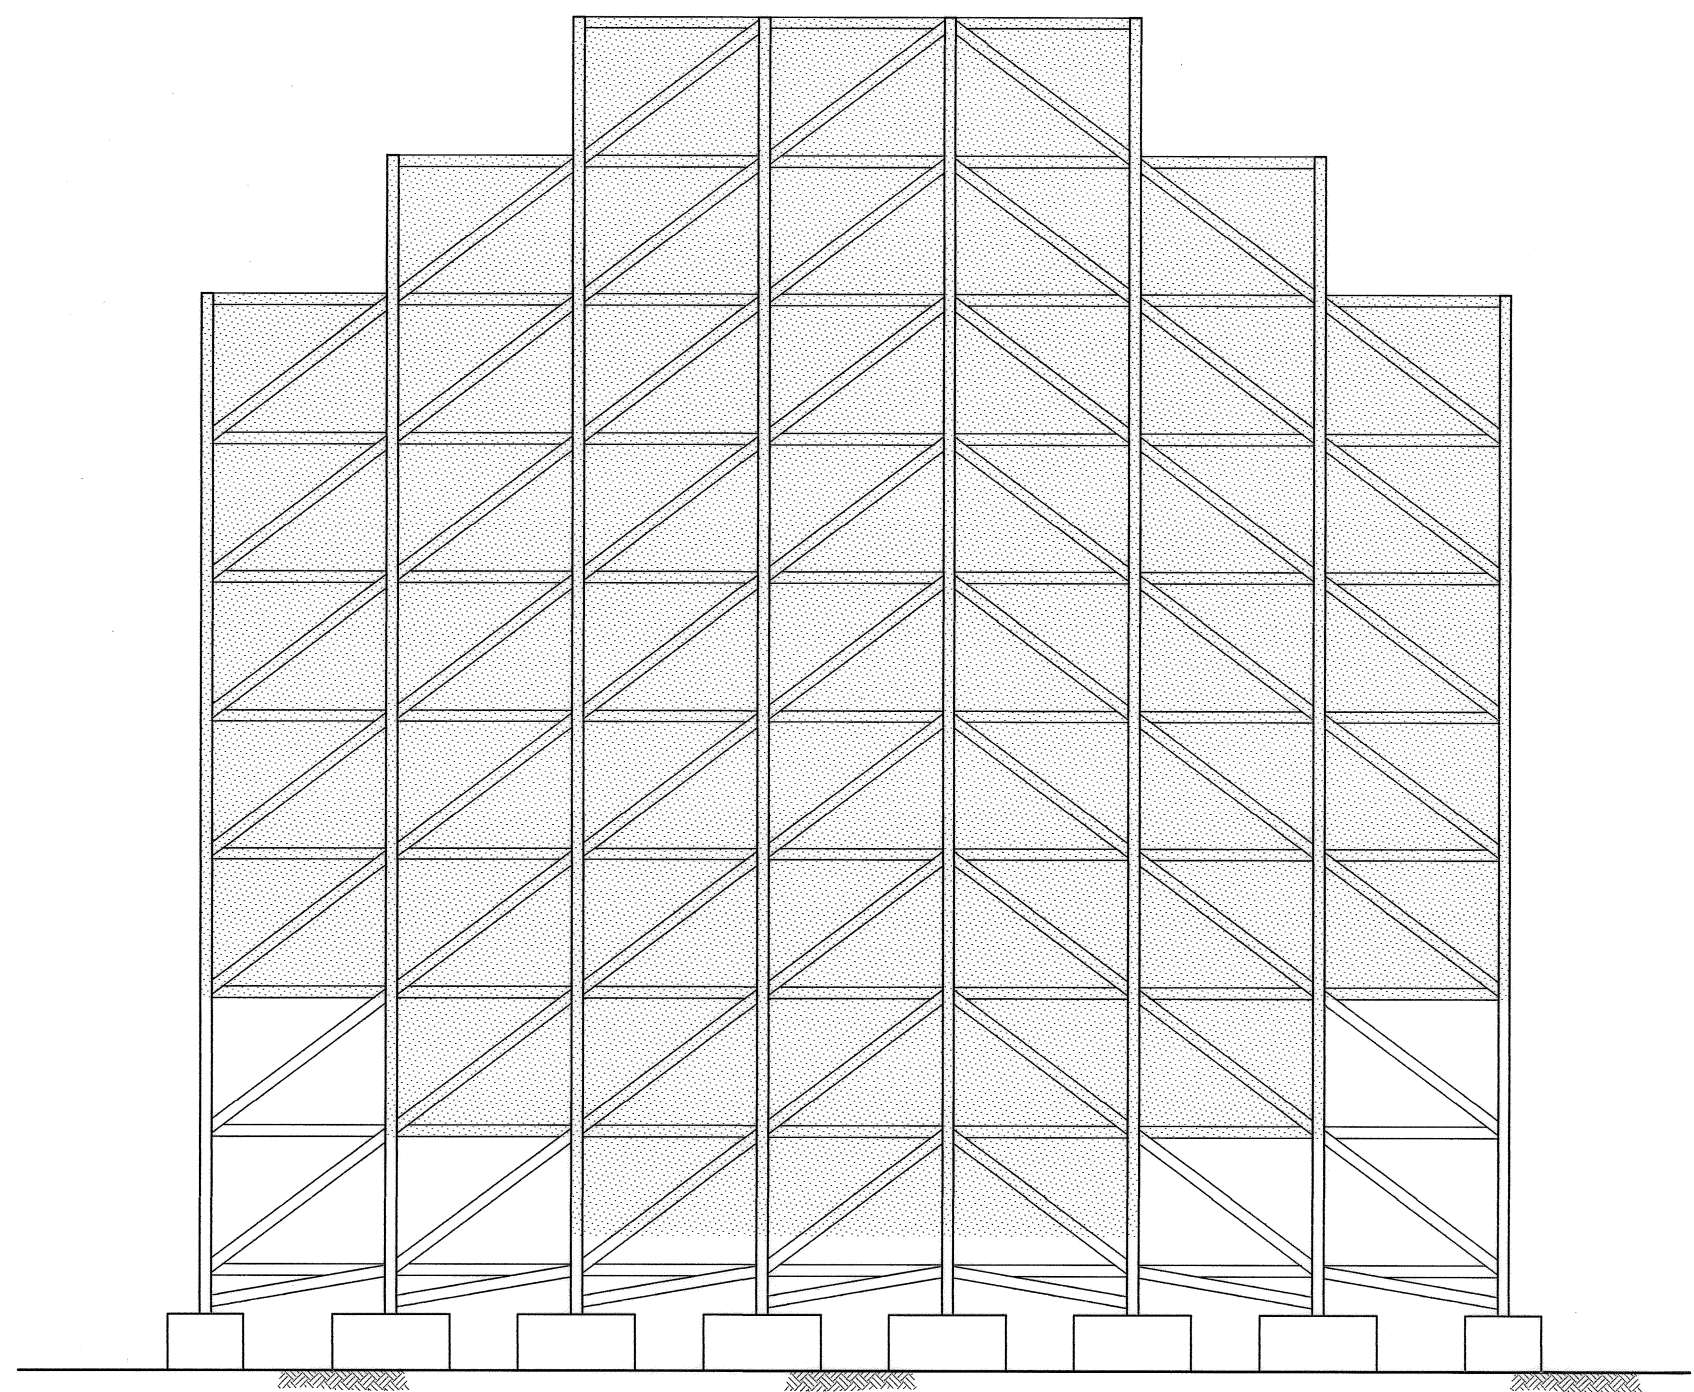

REAR ELEVATION

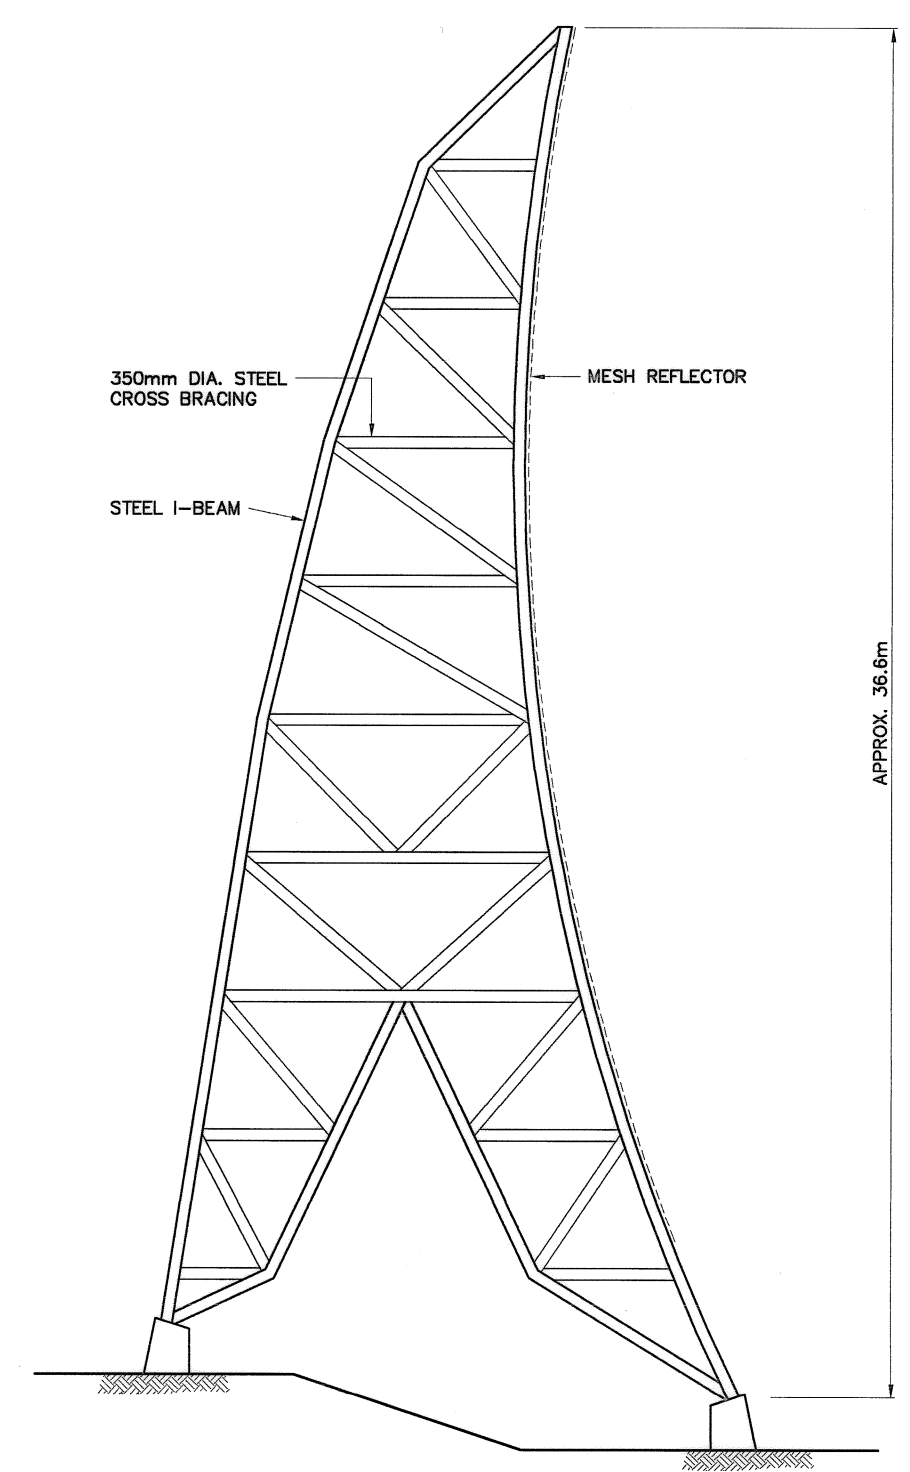


SECTION

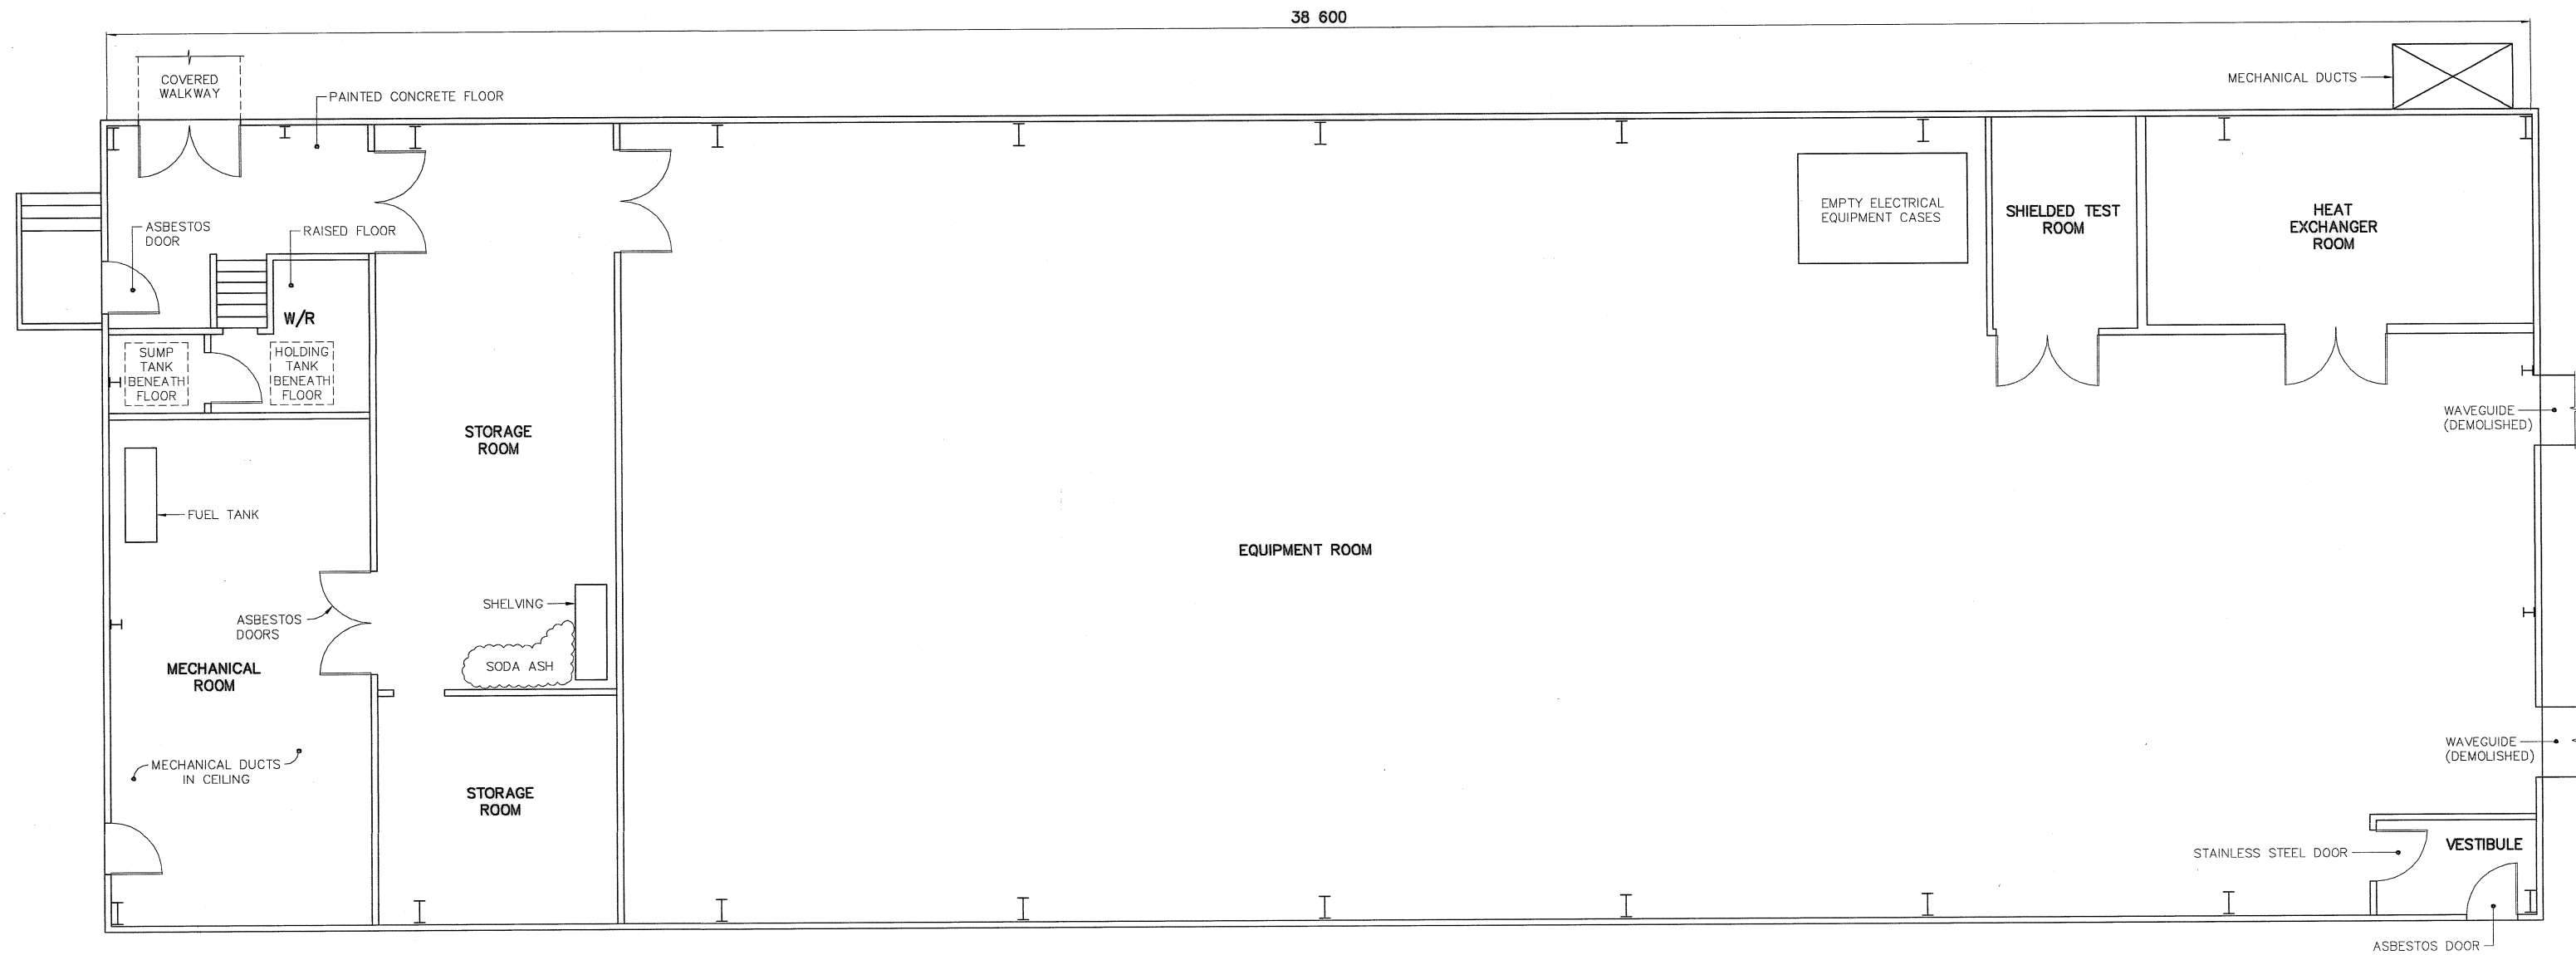

PLAN

NWSO NUMBER	COMMENTS
B25D	AS SHOWN. ASBESTOS DOORS REMOVAL REQUIRED.

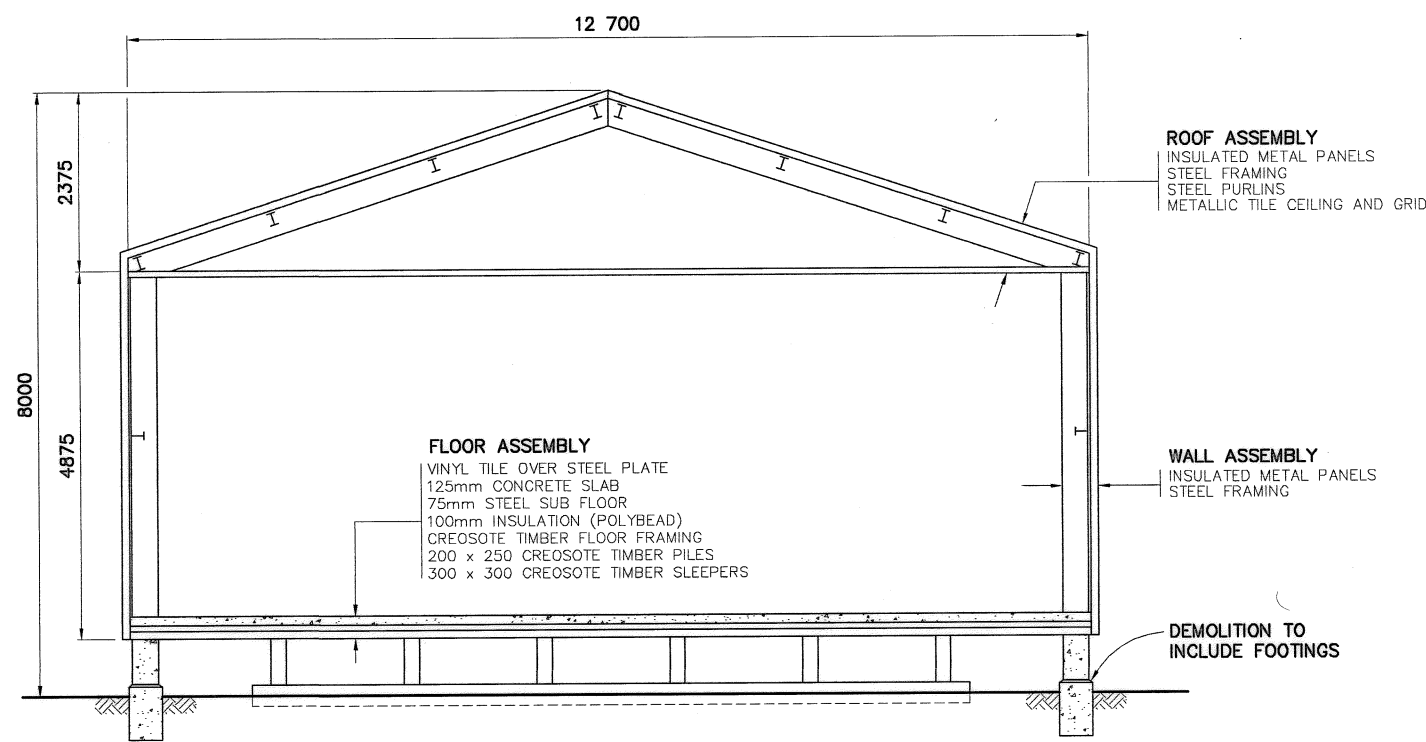

SECTION

NOTE:
CONCRETE FOOTINGS TO BE
DEMOLISHED.

General Notes:

1. ALL DIMENSIONS ARE IN MILLIMETRES UNLESS NOTED OTHERWISE.
2. REFER TO DEMOLITION TABLES IN SPECIFICATIONS FOR LIST OF MAJOR BUILDING CONTENTS.
3. FACILITIES TO BE DEMOLISHED MAY CONTAIN PCB AND LEAD CONTAMINATED PAINT. REFER TO SECTION 02060 OF THE SPECIFICATIONS.

Legend:

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Date: *[Date]*
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AECOM

HATCH

SCALE - ECHELLE 1 0.5 0 1 2 3m

PROJECT - PROJET
DYE-M CAPE DYER

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TRADE - METIER STRUCTURAL DATE 2010-12-07

SUBJECT - SUJET

SWITCHING CENTRE AND
COMMUNICATION BUILDING
PLAN AND SECTION

PRODUCTION	CONCURRENCE - ASSENTIMENT
DESIGNED ETUDIE <i>DTM/TME</i>	DES OFF AGENT CONCEPT
DRAWN DESSINE <i>IC/CAE</i>	SECT HD CHEF SECT
CHECKED VERIFIE <i>BUFF</i>	DES MGR GEST CONCEPT
COORDINATION <i>RRM</i>	REVIEWED - REVU

DWG. NO. - DESSIN NO.
H-C75/3-9101-216


Canada

General Notes:

1. ALL DIMENSIONS ARE IN MILLIMETRES UNLESS NOTED OTHERWISE.
2. REFER TO DEMOLITION TABLES IN SPECIFICATIONS FOR LIST OF MAJOR BUILDING CONTENTS.
3. FACILITIES TO BE DEMOLISHED MAY CONTAIN PCB AND LEAD CONTAMINATED PAINT. REFER TO SECTION 02060 OF THE SPECIFICATIONS.

Legend:

No.	DATE	REVISION	REVISION	APPR.

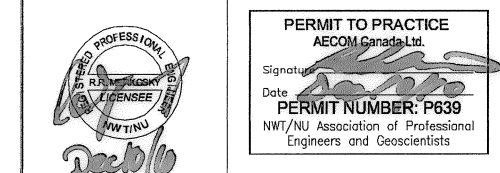

AECOM

HATCH

SCALE - ECHELLE 2 1 0 2 4 6m

PROJECT - PROJET
DYE-M CAPE DYER

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TRADE - METIER
STRUCTURAL

DATE
2010-12-07

SUBJECT - SUJET


POWER AND EQUIPMENT BUILDING
PLAN AND SECTION

PRODUCTION	CONCURRENCE - ASSENTIMENT
DESIGNED ETUDIE DTM/THE	DES OFF AGENT CONCEPT
DRAWN DESSINE IC/CAE	SECT HD CHEF SECT
CHECKED VERIFIE DWF	DES MGR GEST CONCEPT
COORDINATION RRM	REVIEWED - REVU

DWG. NO. - DESSIN NO.
H-C75/3-9101-217

Canada

NOTE:
DOORS ARE METAL UNLESS
NOTED OTHERWISE.

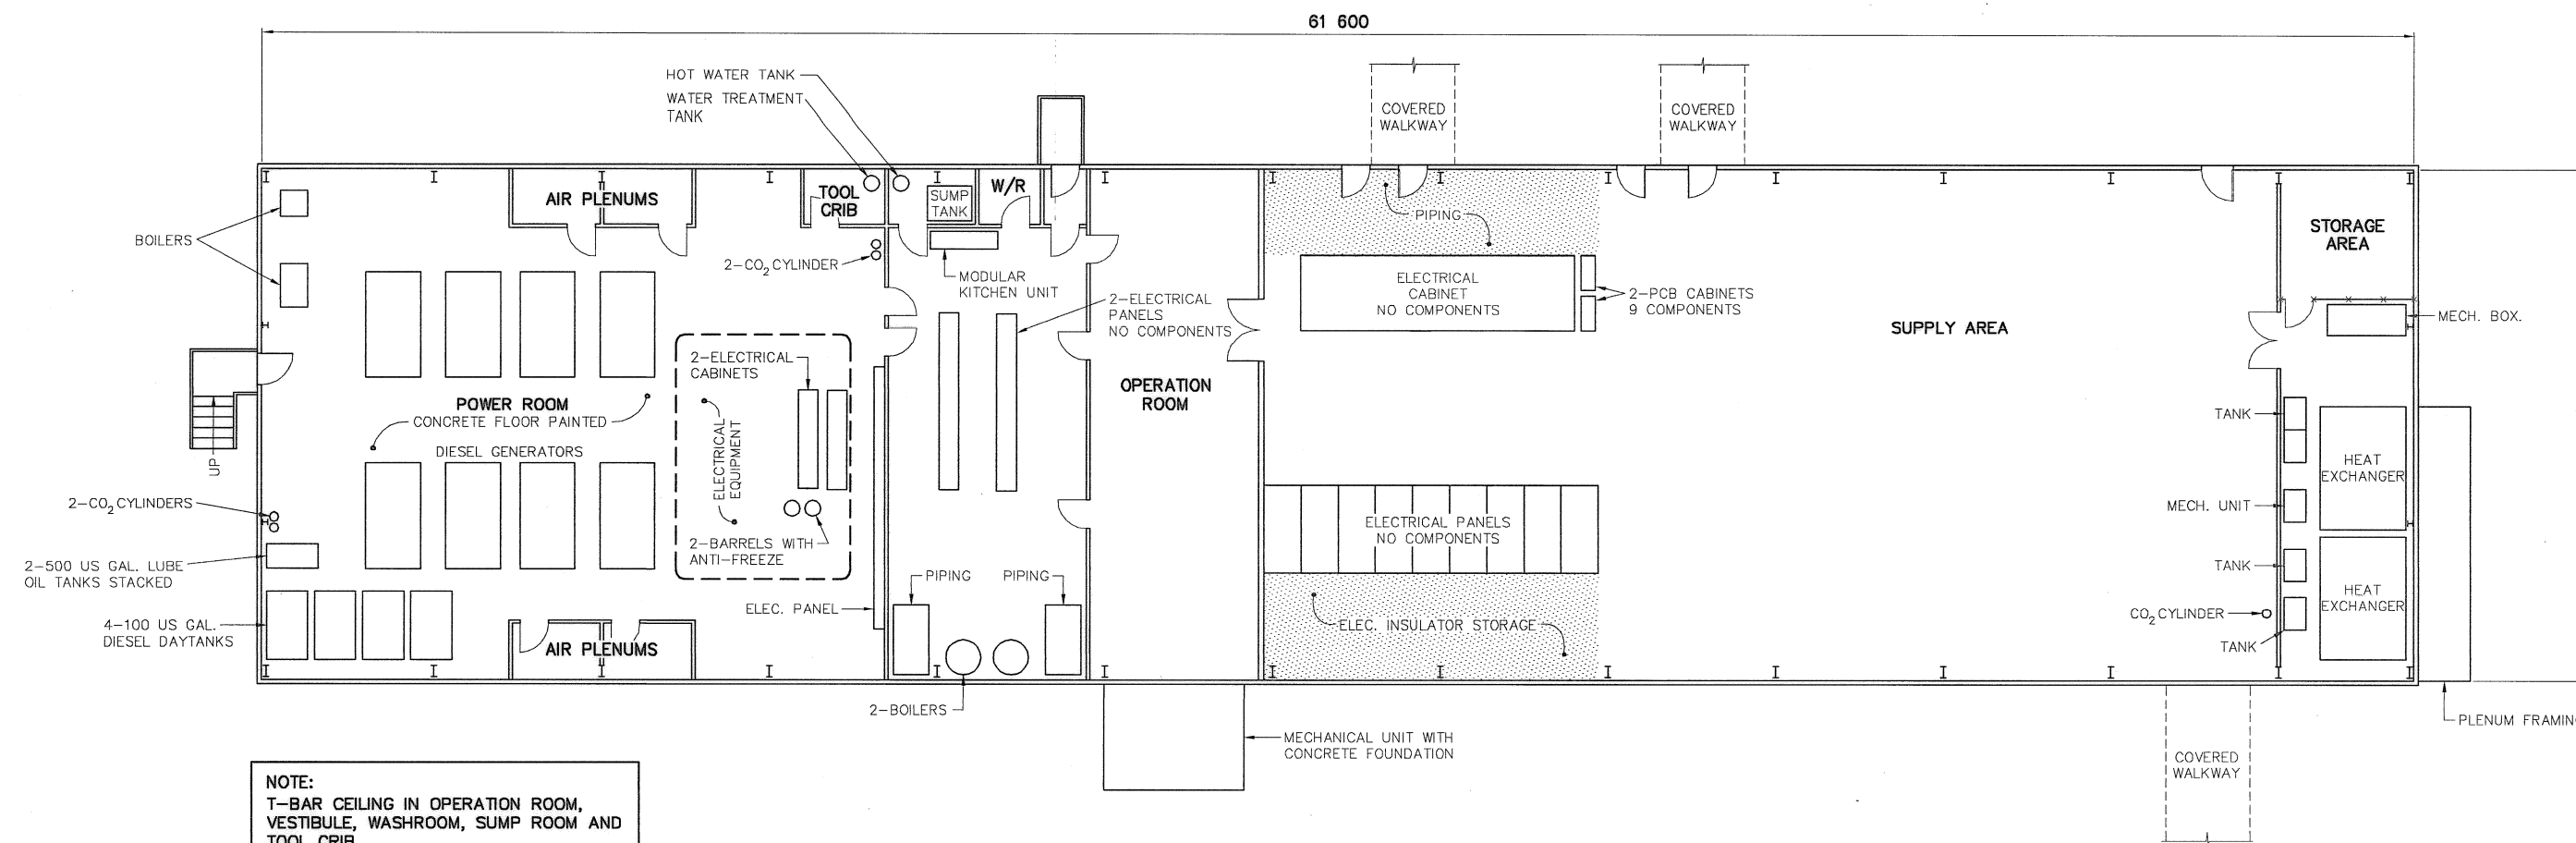


PLAN


NWSO NUMBER	COMMENTS
B25A	AS SHOWN. ASBESTOS DOORS REMOVAL REQUIRED.

NOTE:
MASS CONCRETE FOUNDATIONS
UNDER GENERATORS.



NOTE:
CONCRETE FOOTINGS TO BE
DEMOLISHED.

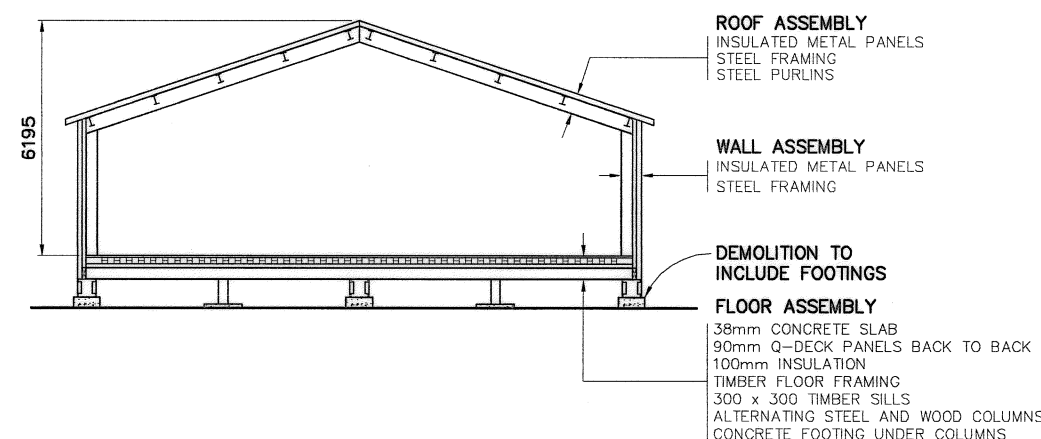



SECTION

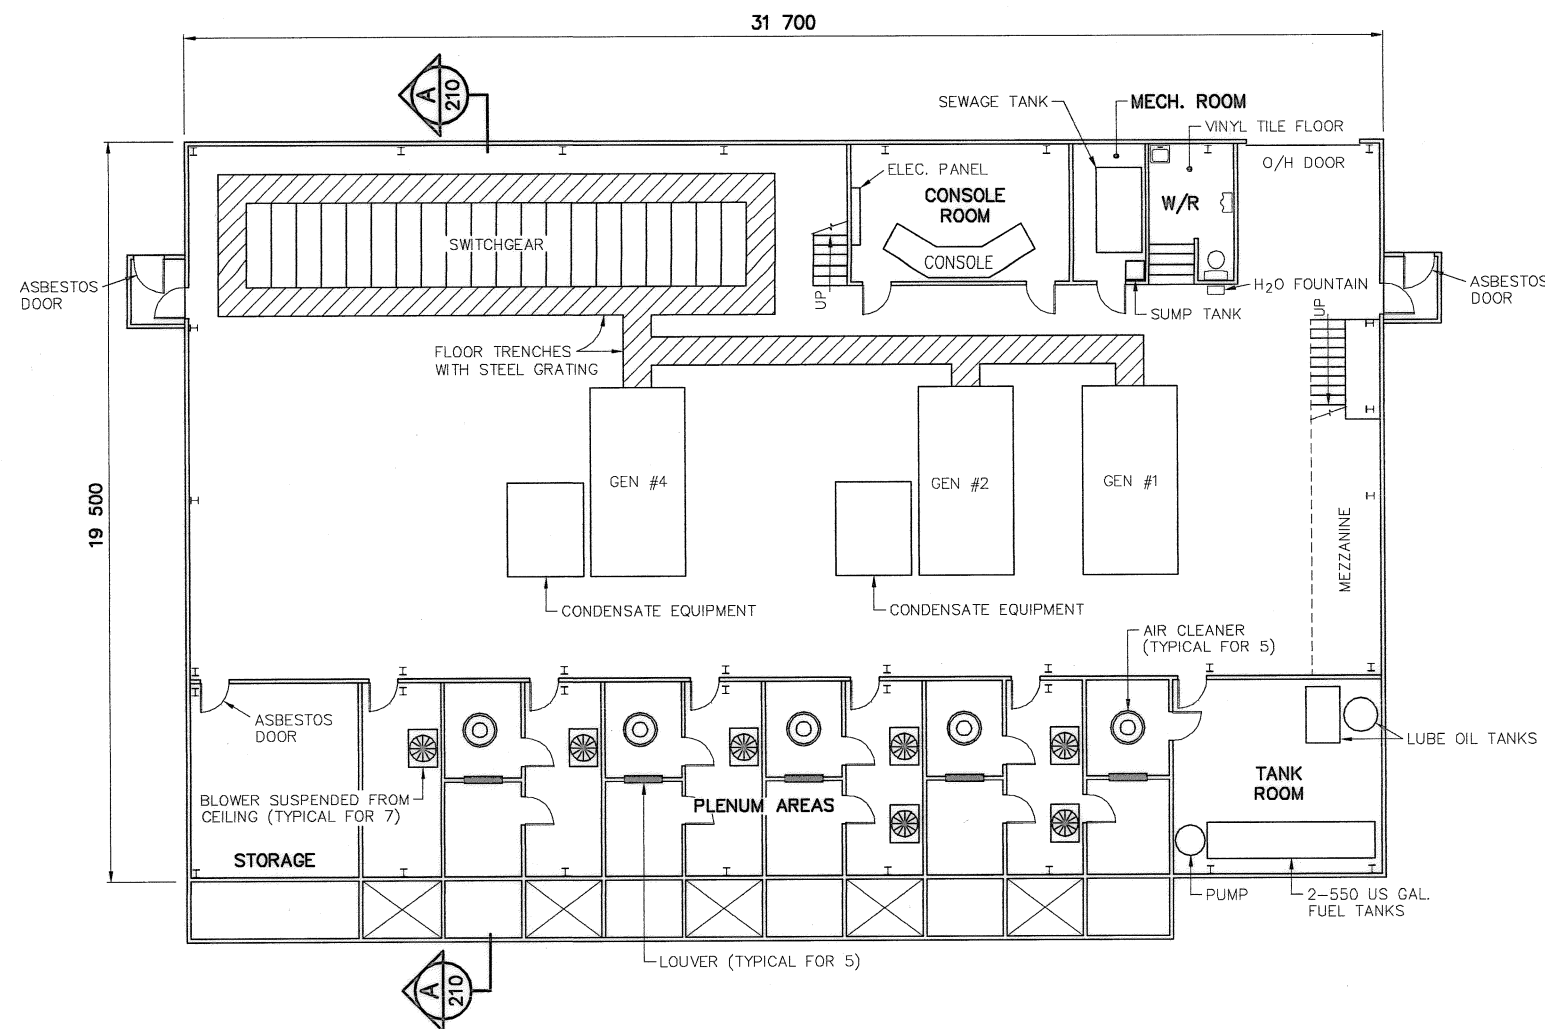


PLAN

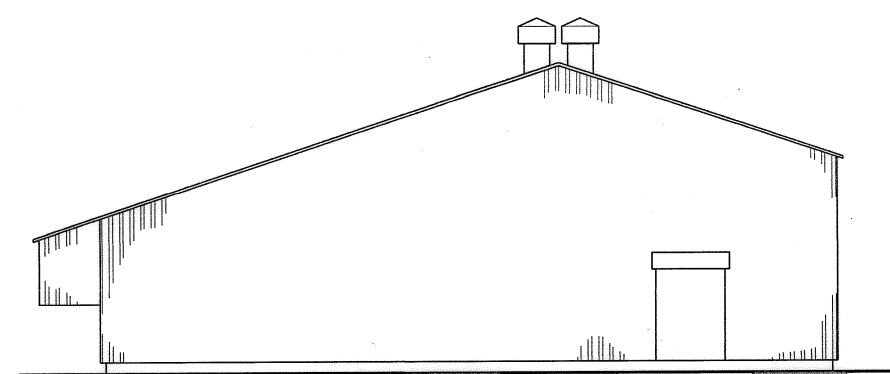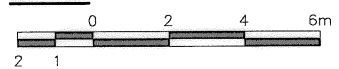

ELEVATION

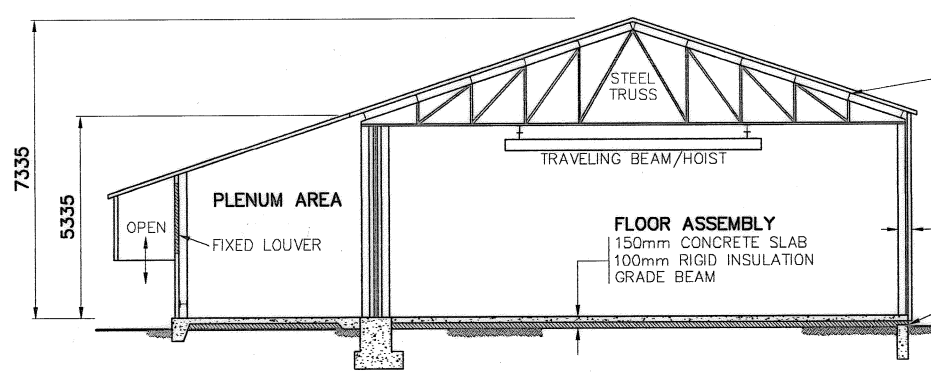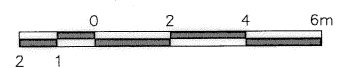

SECTION

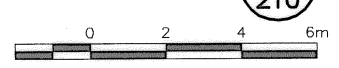

NWSO NUMBER	COMMENTS
B3B	ASBESTOS DOORS REMOVAL REQUIRED.

General Notes:

1. ALL DIMENSIONS ARE IN MILLIMETRES UNLESS NOTED OTHERWISE.
2. REFER TO DEMOLITION TABLES IN SPECIFICATIONS FOR LIST OF MAJOR BUILDING CONTENTS.
3. FACILITIES TO BE DEMOLISHED MAY CONTAIN PCB AND LEAD CONTAMINATED PAINT. REFER TO SECTION 02060 OF THE SPECIFICATIONS.

Legend:

No.	DATE	REVISION	REVISION	APPR.
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Date: *[Date]*
PERMIT NUMBER: P639
NWT/NJ Association of Professional Engineers and Geoscientists

SCALE - ECHELLE AS SHOWN

PROJECT - PROJET DYE-M CAPE DYER

DEW LINE CLEAN UP

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CANADA 2010, AS REPRESENTED BY THE
MINISTER OF NATIONAL DEFENCE.

TRADE - METIER	STRUCTURAL	DATE	2010-12-07
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SUBJECT - SUJET

POWERHOUSE
PLAN, SECTIONS AND ELEVATION

PRODUCTION	CONCURRENCE - ASSENTIMENT
DESIGNED ETUDIE DTM/THE	DES OFF AGENT CONCEPT
DRAWN DESSINE IC/CAE	SECT HD CHEF SECT
CHECKED VERIFIE BVF	DES MGR GEST CONCEPT
COORDINATION RRM	REVIEWED - REVU

DWG. NO. - DESSIN NO.
H-C75/3-9101-218



Canada

NT-NU SPILL REPORT

OIL, GASOLINE, CHEMICALS AND OTHER HAZARDOUS MATERIALS

NT-NU 24-HOUR SPILL REPORT LINE

TEL: (867) 920-8130

FAX: (867) 873-6924

EMAIL: spills@gov.nt.ca

REPORT LINE USE ONLY

A	REPORT DATE: MONTH – DAY – YEAR 06-14-2010		REPORT TIME 16h00		<input checked="" type="checkbox"/> ORIGINAL SPILL REPORT, OR <input type="checkbox"/> UPDATE # _____ TO THE ORIGINAL SPILL REPORT	REPORT NUMBER _____
	OCCURRENCE DATE: MONTH – DAY – YEAR observed 06-11-2010		OCCURRENCE TIME observed 06-11-10			
C	LAND USE PERMIT NUMBER (IF APPLICABLE) N2008X0003			WATER LICENCE NUMBER (IF APPLICABLE) 1BR-DYE0914		
	GEOGRAPHIC PLACE NAME OR DISTANCE AND DIRECTION FROM NAMED LOCATION (DYE-M), Cape Dyer, Nunavut				REGION <input type="checkbox"/> NWT <input checked="" type="checkbox"/> NUNAVUT <input type="checkbox"/> ADJACENT JURISDICTION OR OCEAN	
E	LATITUDE DEGREES 66 MINUTES 39 SECONDS			LONGITUDE DEGREES 61 MINUTES 21 SECONDS		
	RESPONSIBLE PARTY OR VESSEL NAME Defence Construction Canada		RESPONSIBLE PARTY ADDRESS OR OFFICE LOCATION 350 Albert, Suite 1720, Ottawa, Ontario, K1A 0K3			
G	ANY CONTRACTOR INVOLVED None		CONTRACTOR ADDRESS OR OFFICE LOCATION			
	PRODUCT SPILLED Contact water		QUANTITY IN LITRES, KILOGRAMS OR CUBIC METRES 60,000		U.N. NUMBER None	
H	SECOND PRODUCT SPILLED (IF APPLICABLE) None		QUANTITY IN LITRES, KILOGRAMS OR CUBIC METRES None		U.N. NUMBER None	
	SPILL SOURCE Land-farm		SPILL CAUSE Snow melt		AREA OF CONTAMINATION IN SQUARE METRES 4500	
J	FACTORS AFFECTING SPILL OR RECOVERY Weather: continued snow melt		DESCRIBE ANY ASSISTANCE REQUIRED None		HAZARDS TO PERSONS, PROPERTY OR ENVIRONMENT None	
	ADDITIONAL INFORMATION, COMMENTS, ACTIONS PROPOSED OR TAKEN TO CONTAIN, RECOVER OR DISPOSE OF SPILLED PRODUCT AND CONTAMINATED MATERIALS The land-farm area has overflowed its berms due to snow melt. Samples of contact water were taken 11 June 2010. No sheen was observed on the contact water. As the initial mitigation measure to maintain the facility's stability, the contact water is being pumped outside the berm in a pre-approved discharge location, following appropriate approvals granted through the INAC inspector. Analysis of contact water samples will be provided upon obtaining laboratory results.					
L	REPORTED TO SPILL LINE BY Robert Bellizzi	POSITION DLCU Env. Officer	EMPLOYER DCC	LOCATION CALLING FROM Ottawa	TELEPHONE 613-998-7288	
	M	ANY ALTERNATE CONTACT Nahed Farah	POSITION Assoc. Proj. Mng	EMPLOYER DCC	ALTERNATE CONTACT LOCATION Ottawa	ALTERNATE TELEPHONE 613-998-7917
REPORT LINE USE ONLY						
N	RECEIVED AT SPILL LINE BY	POSITION STATION OPERATOR	EMPLOYER	LOCATION CALLED YELLOWKNIFE, NT	REPORT LINE NUMBER (867) 920-8130	
	LEAD AGENCY <input type="checkbox"/> EC <input type="checkbox"/> CCG <input type="checkbox"/> GNWT <input type="checkbox"/> GN <input type="checkbox"/> ILA <input type="checkbox"/> INAC <input type="checkbox"/> NEB <input type="checkbox"/> TC			SIGNIFICANCE <input type="checkbox"/> MINOR <input type="checkbox"/> MAJOR <input type="checkbox"/> UNKNOWN		FILE STATUS <input type="checkbox"/> OPEN <input type="checkbox"/> CLOSED
AGENCY		CONTACT NAME	CONTACT TIME	REMARKS		
LEAD AGENCY						
FIRST SUPPORT AGENCY						
SECOND SUPPORT AGENCY						
THIRD SUPPORT AGENCY						

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Tamara Van Dyck
Environmental Officer
Defence Construction Canada
DEW Line Cleanup PMO
101 Colonel By Drive
Ottawa ON K1A 0K2

Monday March 21, 2011

June 2010 Monthly Report for Water Use License Number: IBR-DYE0914

The following results of the Monitoring Program (MP) and/or Water Use License are provided by the Environmental Sciences Group to meet the requirements of the above-noted license for *DYE-M (Cape Dyer)*.

1. SEWAGE EFFLUENT

A sewage lagoon was constructed at DYE-M in September of 2004. The Water Use License and MP require that samples from treated sewage lagoon effluent at the point of discharge to the receiving water be collected prior to each discharge event.

Two sewage lagoon samples were collected and analyzed from DYE-M in June, 2010. A summary of the results for the parameters tested is provided below. Laboratory results are provided in Appendix A.

LOCATION: SEWAGE LAGOON – OLD CELL EAST SIDE

GPS COORDINATES: 563352 / 7386908

SAMPLE: 10-21252

DATE: June 15, 2010

Parameter	Allowable Maximum Average Concentration	Units	10-21252 (June 15, 2010)
pH	6.0 to 9.0	pH units	6.65
Oil & Grease	None Visible	-	None Visible
Total Suspended Solids (TSS)	180	mg/L	<10
BOD	120	mg/L	42
Faecal Coliforms	100,000	CFU/100mL	N/A
Total Coliforms	-	CFU/ 100 mL	>200



Photo 1 (DSC01109): Sample 10-21252 Dye-M Collecting a sample of wastewater from the sewage lagoon.

LOCATION: SEWAGE LAGOON - OLD CELL NORTH SIDE

GPS COORDINATES: 563352 / 7386908

SAMPLE: 10-21264

DATE: June 16, 2010

Parameter	Allowable Maximum Average Concentration	Units	10-21264 (June 26, 2010)
pH	6.0 to 9.0	pH units	6.39
Oil & Grease	None Visible	-	None Visible
Total Suspended Solids (TSS)	180	mg/L	20
BOD	120	mg/L	<3
Faecal Coliforms	100,000	CFU/100 mL	600
Total Coliforms	-	CFU/ 100 mL	19000



Photo 2 (DSC01287): Sample 10-21264 Dye-M Sampling Sewage Lagoon - Old cell North Side

Waste water from the Old Cell of the sewage lagoon was discharged to the ground on July 11 and 12, 2010. The water was discharged on the east side of the lagoon away from the main camp. (0563407, 7386908)

We trust that the information provided meets current requirements. Please contact the undersigned if you have any questions or concerns.

Sincerely,

A handwritten signature in black ink, appearing to read 'Casucci'.

Candice Casucci
Environmental Sciences Group

cc: Eva Schulz (UMA)
Daniela Looke, Kat White, Marc Ellemers, Andrea Ellis, Megan Lord (ESG)

ESG	ASG Login No: 20628
12 Verite Ave	Site: DYE-M
Dept. of Chem. / Chem. Eng., RMC	Client Login No: 10-024
P.O. Box 17000, Stn. Forces	Samples Received: 16-Jun-10
Kingston, Ontario K7K 7B4	Date of analysis: 17-Jun-10
	Method No: ASG 042
	Date Reported: 23-Jun-10
	Page: 1 of 1

RESULTS OF BOD ANALYSIS		
Sample I.D.	Unit	BOD
21252	mg/L	42

*Averaged result of duplicates
 ~Readings conducted 10 hours past expected reading time.

LABORATORY QA/QC		
Sample I.D.	Unit	BOD
Blank	mg/L	< 3
Control	mg/L	122
Control Target	mg/L	165

Verite Ave	ASG Login No: 20628
Dept. of Chem. / Chem. Eng., RMC	Site: DYE-M
Box 17000, Stn. Forces	Client No: 10-024
Kingston, Ontario K7K 7B4	Samples Received: 16-Jun-10
541-6000 ext 6567	Date of analysis: 16-Jun-10
(613) 541-6596	Date Reported: 18-Jun-10
	Sheet: 1 of 1

RESULTS OF MICROBIOLOGICAL ANALYSIS

Sample Identification	Method: ASG 036 Total Coliforms (CFU/100 mL)	Method: ASG 036 <i>E. coli</i> (CFU/100 mL)	Method: ASG 036 Background (CFU/100 mL)	Method: ASG 041 Heterotrophic Plate Count (CFU/mL)
21252*	> 200	99	> 200	> 500

*Averaged results of duplicates

LABORATORY QA/QC

Sample Identification	Method: ASG 036 Total Coliforms (CFU/100 mL)	Method: ASG 036 <i>E. coli</i> (CFU/100 mL)	Method: ASG 036 Background (CFU/100 mL)	Method: ASG 041 Heterotrophic Plate Count (CFU/mL)
Blank	0	0	0	0
21252 ; Duplicate	> 200 ; > 200	88 ; 110	> 200	> 500 ; > 500
Control Sample	33	33	0	26
Control Target	34	34	0	34

ESG	ASG Login No: 20628
12 Verite Ave	Site: Dye-M
Dept. of Chem. / Chem. Eng., RMC	Client No: 10-024
P.O. Box 17000, Stn. Forces	Samples Received: 16-Jun-10
Kingston, Ontario K7K 7B4	Date of analysis: 16-Jun-10
(613) 541-6000 ext 6567	Method No: ASG 037
Fax: (613) 541-6596	Date Reported: 16-Jun-10
	Page: 1 of 1

RESULTS OF pH ANALYSIS

Sample I.D.	pH
21252	6.65

* Averaged result of duplicates

LABORATORY QA/QC

Sample I.D.	pH
Control	7.01
Control Target	7.00

ESG	ASG Login No: 20628
12 Verite Ave	Site: Dye-M
Dept. of Chem. / Chem. Eng., RMC	Client Login No: 10-024
P.O. Box 17000, Stn. Forces	Samples Received: 16-Jun-10
Kingston, Ontario K7K 7B4	Date of analysis: 17-Jun-10
(613) 541-6000 ext 6567	Method No: ASG 039
Fax: (613) 541-6596	Date Reported: 18-Jun-10
	Sheet: 1 of 1

RESULTS OF TOTAL SUSPENDED SOLIDS ANALYSIS

Sample I.D.	Sample Type^	Unit	Total Suspended Solids
21252*	SE	mg/L	< 10

LABORATORY QA/QC

Duplicate ; 21252	SE ; SE	mg/L	< 10 ; < 10
Control	Control	mg/L	220
Control Target	Control	mg/L	200
Blank	Control	mg/L	< 1

^SW =Surface Water, SI = Sewage Influent SE = Sewage Effluent

* Averaged result of duplicates

ESG	ASG Login No: 20679
12 Verite Ave	Site: Dye-M
Dept. of Chem. / Chem. Eng., RMC	Client Login No: 10-046
P.O. Box 17000, Stn. Forces	Samples Received: 28-Jun-10
Kingston, Ontario K7K 7B4	Date of analysis: 5-Jul-10
(613) 541-6000 ext 6567	Method No: ASG 042
Fax: (613) 541-6596	Date Reported: 5-Jul-10
	Page: 1 of 1

RESULTS OF BOD ANALYSIS

Sample I.D.	Unit	BOD
21264*	mg/L	< 3

*Averaged result of duplicates

LABORATORY QA/QC

Sample I.D.	Unit	BOD
Duplicate ; 21264*	mg/L	< 3 ; < 3
Blank	mg/L	< 3
Control	mg/L	152
Control Target	mg/L	165

ESG	ASG Login No: 20679
12 Verite Ave	Site: Dye-M
Dept. of Chem. / Chem. Eng., RMC	Client No: 10-046
P.O. Box 17000, Stn. Forces	Samples Received: 28-Jun-10
Kingston, Ontario K7K 7B4	Date of analysis: 28-Jun-10
(613) 541-6000 ext 6567	Method No: ASG 037
Fax: (613) 541-6596	Date Reported: 28-Jun-10
	Page: 1 of 1

RESULTS OF pH ANALYSIS

Sample I.D.	pH
21264	6.39

* Averaged result of duplicates

LABORATORY QA/QC

Sample I.D.	pH
21264 ; 21264	6.38 ; 6.40
Control	7.01
Control Target	7.00

ESG	ASG Login No: 20679
12 Verite Ave	Site: Dye-M
Dept. of Chem. / Chem. Eng., RMC	Client Login No: 10-046
P.O. Box 17000, Stn. Forces	Samples Received: 28-Jun-10
Kingston, Ontario K7K 7B4	Date of analysis: 29-Jun-10
(613) 541-6000 ext 6567	Method No: ASG 039
Fax: (613) 541-6596	Date Reported: 29-Jun-10
	Sheet: 1 of 1

RESULTS OF TOTAL SUSPENDED SOLIDS ANALYSIS

Sample I.D.	Sample Type^	Unit	Total Suspended Solids
21264*	SE	mg/L	20

LABORATORY QA/QC

Duplicate ; 21264*	SE ; SE	mg/L	19 ; 20
Control	Control	mg/L	180
Control Target	Control	mg/L	200
Blank	Control	mg/L	< 1

^SW =Surface Water, SI = Sewage Influent SE = Sewage Effluent
 * Averaged result of duplicates

				ASG Login No: 20679
rite Ave				Site: DYE-M
of Chem. / Chem. Eng., RMC				Client No: 10-046
Box 17000, Stn. Forces				Samples Received: 28-Jun-10
ton, Ontario K7K 7B4				Date of analysis: 28-Jun-10
541-6000 ext 6567				Date Reported: 30-Jun-10
613) 541-6596				Sheet: 1 of 1

RESULTS OF MICROBIOLOGICAL ANALYSIS

Sample Identification	Method: ASG 036 Total Coliforms (CFU/100 mL)	Method: ASG 036 E. coli (CFU/100 mL)	Method: ASG 036 Background (CFU/100 mL)	Method: ASG 044 Fecal Coliforms (CFU/100 mL)
21264*	19 000	410	> 200 000	600

LABORATORY QA/QC

Sample Identification	Method: ASG 036 Total Coliforms (CFU/100 mL)	Method: ASG 036 E. coli (CFU/100 mL)	Method: ASG 036 Background (CFU/100 mL)	Method: ASG 044 Fecal Coliforms (CFU/100 mL)
Blank	0	0	0	0
Control Sample	42	42	0	42
Control Sample Target	33	33	0	33

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Tamara Van Dyck
Environmental Officer
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101 Colonel By Drive
Ottawa ON K1A 0K2

Monday, March 21, 2011

RE: Analytical Results for Wastewater Samples Collected at DYE-M in June 2010

The following report summarizes results of the analysis of wastewater samples as per the DYE-M (Cape Dyer) DEW Line Cleanup Project (DLCU) Specifications.

The DYE-M specifications require that “wash water, melt water collection, rinse water resulting from the cleaning of fuel tanks and pipelines, and/or any other liquid effluent stream” meet the following guidelines prior to their discharge to land

Parameter	Maximum Allowable Concentration	Units
pH	6-9	pH units
Total arsenic (As)	0.100	mg/L
Dissolved cadmium (Cd)	0.010	mg/L
Dissolved chromium (Cr)	0.100	mg/L
Dissolved cobalt (Co)	0.050	mg/L
Dissolved copper (Cu)	0.200	mg/L
Dissolved lead (Pb)	0.050	mg/L
Total mercury (Hg)	0.0006	mg/L
Dissolved nickel (Ni)	0.200	mg/L
Total zinc (Zn)	0.500	mg/L
Oil & grease	5	mg/L
PCBs	1.0	mg/L
Phenols	-	-

Phenols

The wastewater samples collected by ESG at DYE-M in June, 2010 were not analyzed for phenols but they were analyzed for oil and grease. Research conducted by ESG¹ has determined that a) no federal, territorial or provincial criteria exist for the discharge of wastewater containing phenols to land at a minimum distance of 30-m from natural

¹ Environmental Sciences Group. *DEW Line Clean Up Project – Phenols in Wastewater*. June, 2007.

drainage courses b) the maximum concentration of phenols in DLCU wastewater to date (2.44 mg/L) is below the LC₅₀ for freshwater fish and crustaceans and below the oral and dermal LD₅₀s for rats and rodents and c) phenols in excess of the maximum allowable concentration (MAC) have historically co-occurred with a visible oil & grease sheen and/or with an exceedance of the MAC for oil & grease. This information, and a subsequent decision to not test for phenols, has been presented to the NWB. To date, verbal agreement from the NWB has been received, but the project is awaiting written confirmation of the decision to suspend testing for phenols.

WASTEWATER SAMPLES

Twelve wastewater samples were collected at DYE-M and analyzed in June 2010. A summary of the details of these results follows. Laboratory results are provided in Appendix A.

LOCATION: UPPER SITE NON HAZARDOUS WASTE LANDFILL – WATER POOLED AT NORTHWEST SIDE OF FACILITY

GPS COORDINATES: 572148 / 7395163

SAMPLE: 10-21242

DATE: June 11, 2010

Parameter	Maximum Allowable Concentration	Units	Sample # 10-21242
pH	6-9	pH units	7.88
Total arsenic (As)	0.100	mg/L	<0.003
Dissolved cadmium (Cd)	0.010	mg/L	<0.001
Dissolved chromium (Cr)	0.100	mg/L	<0.005
Dissolved cobalt (Co)	0.050	mg/L	<0.003
Dissolved copper (Cu)	0.200	mg/L	<0.005
Dissolved lead (Pb)	0.050	mg/L	<0.010
Total mercury (Hg)	0.0006	mg/L	<0.4
Dissolved nickel (Ni)	0.200	mg/L	<0.005
Total zinc (Zn)	0.500	mg/L	0.026
Oil & grease	5	mg/L	<2.0
PCBs	1.0	mg/L	<0.003
Phenols	-	-	N/A



Photo 1 (DSC00987): Sample 10-21242 Dye-M June 11th, 2010 Collecting a sample from the US NHWL

Waste water from the US -NHWL was discharged to the ground on June 16, 2010. The water was discharged to an INAC approved location, greater than 30m from natural drainage courses (571059 / 7394555)

LOCATION: UPPER SITE TIER II – WATER POOLED ALONG WESTSIDE OF FACILITY

GPS COORDINATES: 571054 / 7394618

SAMPLE: 10-21243

DATE: June 11, 2010

Parameter	Maximum Allowable Concentration	Units	Sample # 10-21243
pH	6-9	pH units	8.08
Total arsenic (As)	0.100	mg/L	<0.003
Dissolved cadmium (Cd)	0.010	mg/L	<0.001
Dissolved chromium (Cr)	0.100	mg/L	<0.005
Dissolved cobalt (Co)	0.050	mg/L	<0.003
Dissolved copper (Cu)	0.200	mg/L	<0.005
Dissolved lead (Pb)	0.050	mg/L	<0.010
Total mercury (Hg)	0.0006	mg/L	<0.4
Dissolved nickel (Ni)	0.200	mg/L	<0.005
Total zinc (Zn)	0.500	mg/L	<0.10
Oil & grease	5	mg/L	<2.0
PCBs	1.0	mg/L	<0.003
Phenols	-	-	N/A



Photo 2 (DSC00996): Sample 10-21243 Collecting a sample from the US Tier II

Waste water from the US Tier II was discharged to the ground on June 16, 2010. The water was discharged to an INAC approved location, greater than 30m from natural drainage courses (571059 / 7394555)

LOCATION: LANDFARM – WATER POOLED AT THE NORTH SIDE

GPS COORDINATES: 562952 / 7387007

SAMPLE: 10-21241

DATE: June 10, 2010

Parameter	Maximum Allowable Concentration	Units	Sample # 10-21241
pH	6-9	pH units	8.20
Total arsenic (As)	0.100	mg/L	N/A
Dissolved cadmium (Cd)	0.010	mg/L	N/A
Dissolved chromium (Cr)	0.100	mg/L	N/A
Dissolved cobalt (Co)	0.050	mg/L	N/A
Dissolved copper (Cu)	0.200	mg/L	N/A
Dissolved lead (Pb)	0.050	mg/L	<0.010
Total mercury (Hg)	0.0006	mg/L	N/A
Dissolved nickel (Ni)	0.200	mg/L	N/A
Total zinc (Zn)	0.500	mg/L	N/A
Oil & grease	5	mg/L	<2.0
PCBs	1.0	mg/L	<0.003
Phenols	-	-	N/A



Photo 3 (DSC00979): Sample 10-21241 Dye-M June 10th, 2010 Collecting a sample from the landfarm

LOCATION: LANDFARM – OUTFLOW PIPE DISCHARGE**GPS COORDINATES:** 562613 / 7387929**SAMPLE:** 10-21244**DATE:** June 11, 2010

Parameter	Maximum Allowable Concentration	Units	Sample # 10-21244
pH	6-9	pH units	6.67
Total arsenic (As)	0.100	mg/L	N/A
Dissolved cadmium (Cd)	0.010	mg/L	N/A
Dissolved chromium (Cr)	0.100	mg/L	N/A
Dissolved cobalt (Co)	0.050	mg/L	N/A
Dissolved copper (Cu)	0.200	mg/L	N/A
Dissolved lead (Pb)	0.050	mg/L	<0.010
Total mercury (Hg)	0.0006	mg/L	N/A
Dissolved nickel (Ni)	0.200	mg/L	N/A
Total zinc (Zn)	0.500	mg/L	N/A
Oil & grease	5	mg/L	<2.0
PCBs	1.0	mg/L	<0.003
Phenols	-	-	N/A



Photo 4 (DSC01014): Sample 10-21244 Dye-M Collecting a wastewater sample from the outflow pipes at the landfarm

LOCATION: LANDFARM – PUMP DISCHARGE

GPS COORDINATES: 562469 / 7387855

SAMPLE: 10-21245

DATE: June 11, 2010

Parameter	Maximum Allowable Concentration	Units	Sample # 10-24245
pH	6-9	pH units	6.66
Total arsenic (As)	0.100	mg/L	N/A
Dissolved cadmium (Cd)	0.010	mg/L	N/A
Dissolved chromium (Cr)	0.100	mg/L	N/A
Dissolved cobalt (Co)	0.050	mg/L	N/A
Dissolved copper (Cu)	0.200	mg/L	N/A
Dissolved lead (Pb)	0.050	mg/L	<0.010
Total mercury (Hg)	0.0006	mg/L	N/A
Dissolved nickel (Ni)	0.200	mg/L	N/A
Total zinc (Zn)	0.500	mg/L	N/A
Oil & grease	5	mg/L	<2.0
PCBs	1.0	mg/L	<0.003
Phenols	-	-	N/A



Photo 5 (DSC01027): Sample 10-21245 Dye-M Collecting a wastewater sample from the pump discharging water from the landfill

LOCATION: DITCH BY LANDFARM – LANDFARM DISCHARGE WATER
DOWNSTREAM OF DISCHARGE LOCATION
GPS COORDINATES: 562405 / 7387850
SAMPLE: 10-21246
DATE: June 11, 2010

Parameter	Maximum Allowable Concentration	Units	Sample # 10-21246
pH	6-9	pH units	6.65
Total arsenic (As)	0.100	mg/L	N/A
Dissolved cadmium (Cd)	0.010	mg/L	N/A
Dissolved chromium (Cr)	0.100	mg/L	N/A
Dissolved cobalt (Co)	0.050	mg/L	N/A
Dissolved copper (Cu)	0.200	mg/L	N/A
Dissolved lead (Pb)	0.050	mg/L	<0.010
Total mercury (Hg)	0.0006	mg/L	N/A
Dissolved nickel (Ni)	0.200	mg/L	N/A
Total zinc (Zn)	0.500	mg/L	N/A
Oil & grease	5	mg/L	<2.0
PCBs	1.0	mg/L	<0.003
Phenols	-	-	N/A



Photo 6 (DCS01028): Sample 10-21246 Dye-M Collecting a sample from culvert downstream of landfarm discharge - Northeast culvert at crossroads (MPA 4)

Waste water from the Landfarm area (10-21241, 44, 45, 46) began on June 11, prior to receiving analytical results. Samples were collected downgradient along the drainage course to ensure there were no impacts to the receiving environment. All results were below criteria, and discharge continued on June 16th, 2010.

LOCATION: LOWER SITE – BPA – POOLED WATER IN THE NORTHEAST CORNER.

GPS COORDINATES: 563026 / 7387524

SAMPLE: 10-21247

DATE: June 12, 2010

Parameter	Maximum Allowable Concentration	Units	Sample # 10-21247
pH	6-9	pH units	6.39
Total arsenic (As)	0.100	mg/L	<0.003
Dissolved cadmium (Cd)	0.010	mg/L	<0.001
Dissolved chromium (Cr)	0.100	mg/L	<0.005
Dissolved cobalt (Co)	0.050	mg/L	<0.003
Dissolved copper (Cu)	0.200	mg/L	<0.005
Dissolved lead (Pb)	0.050	mg/L	<0.010
Total mercury (Hg)	0.0006	mg/L	<0.4
Dissolved nickel (Ni)	0.200	mg/L	<0.005
Total zinc (Zn)	0.500	mg/L	0.134
Oil & grease	5	mg/L	11.5
PCBs	1.0	mg/L	<0.003
Phenols	-	-	N/A



Photo 7 (DSC01040): Sample 10-21247 Dye-M Sample bottles collected from the BPA

Water from the Lower Site BPA was over the criteria for Oil and Grease and therefore was not discharged to land. The wastewater was placed in a tote tanks for further treatment/sampling, and was later placed back into the BPA.

LOCATION: LOWER SITE – TIER II – POOLED WATER ON THE NORTH SIDE OF THE NEW CELL

GPS COORDINATES: 561898 / 7388331

SAMPLE: 10-21248

DATE: June 11, 2010

Parameter	Maximum Allowable Concentration	Units	Sample # 10-21248
pH	6-9	pH units	6.56
Total arsenic (As)	0.100	mg/L	<0.003
Dissolved cadmium (Cd)	0.010	mg/L	<0.001
Dissolved chromium (Cr)	0.100	mg/L	<0.005
Dissolved cobalt (Co)	0.050	mg/L	<0.003
Dissolved copper (Cu)	0.200	mg/L	<0.005
Dissolved lead (Pb)	0.050	mg/L	<0.010
Total mercury (Hg)	0.0006	mg/L	<0.4
Dissolved nickel (Ni)	0.200	mg/L	<0.005
Total zinc (Zn)	0.500	mg/L	0.016
Oil & grease	5	mg/L	2.0
PCBs	1.0	mg/L	<0.003
Phenols	-	-	N/A



Photo 8 (DSC01049): Sample 10-21248 Dye-M Collecting a sample from the LS Tier II

Waste water from the Lower Site - Tier II was discharged to the ground on June 16, 2010. The water was discharged to an area greater than 30m from natural drainage courses (561898 / 7388338).

LOCATION: LS NHWL – WASTEWATER SAMPLE COLLECTED FROM THE NORTHEAST CORNER

GPS COORDINATES: 562952 / 7387007

SAMPLE: 10-21249

DATE: June 14, 2010

Parameter	Maximum Allowable Concentration	Units	Sample # 10-21249
pH	6-9	pH units	7.23
Total arsenic (As)	0.100	mg/L	<0.003
Dissolved cadmium (Cd)	0.010	mg/L	<0.001
Dissolved chromium (Cr)	0.100	mg/L	0.006
Dissolved cobalt (Co)	0.050	mg/L	<0.003
Dissolved copper (Cu)	0.200	mg/L	<0.005
Dissolved lead (Pb)	0.050	mg/L	<0.010
Total mercury (Hg)	0.0006	mg/L	<0.4
Dissolved nickel (Ni)	0.200	mg/L	<0.005
Total zinc (Zn)	0.500	mg/L	0.013
Oil & grease	5	mg/L	<2.0
PCBs	1.0	mg/L	<0.003
Phenols	-	-	N/A



Photo 9 (DSC01086): Sample 10-21249 Dye-M Collecting a sample of wastewater from the LS NHWL

*Waste water from the LS NHWL was discharged to the ground on June 21, 2010.
(562931 / 7387009)*

LOCATION: LS FORMER BPA – WASTEWATER SAMPLE COLLECTED FROM THE NORTH SIDE

GPS COORDINATES: 5631011 / 7387530

SAMPLE: 10-21250 (Duplicate sample 10-21251)

DATE: June 14, 2010

Parameter	Maximum Allowable Concentration	Units	Sample # 10-21250
pH	6-9	pH units	7.08
Total arsenic (As)	0.100	mg/L	<0.003
Dissolved cadmium (Cd)	0.010	mg/L	<0.001
Dissolved chromium (Cr)	0.100	mg/L	<0.005
Dissolved cobalt (Co)	0.050	mg/L	<0.003
Dissolved copper (Cu)	0.200	mg/L	<0.005
Dissolved lead (Pb)	0.050	mg/L	<0.010
Total mercury (Hg)	0.0006	mg/L	<0.4
Dissolved nickel (Ni)	0.200	mg/L	<0.005
Total zinc (Zn)	0.500	mg/L	0.014
Oil & grease	5	mg/L	<2.0
PCBs	1.0	mg/L	<0.003
Phenols	-	-	N/A

SAMPLE: 10-21251 (Duplicate sample 10-21250)

DATE: June 14, 2010

Parameter	Maximum Allowable Concentration	Units	Sample # 10-21251
pH	6-9	pH units	7.18
Total arsenic (As)	0.100	mg/L	<0.003
Dissolved cadmium (Cd)	0.010	mg/L	<0.001
Dissolved chromium (Cr)	0.100	mg/L	<0.005
Dissolved cobalt (Co)	0.050	mg/L	<0.003
Dissolved copper (Cu)	0.200	mg/L	<0.005
Dissolved lead (Pb)	0.050	mg/L	<0.010
Total mercury (Hg)	0.0006	mg/L	<0.4
Dissolved nickel (Ni)	0.200	mg/L	<0.005
Total zinc (Zn)	0.500	mg/L	0.013
Oil & grease	5	mg/L	<2.0
PCBs	1.0	mg/L	<0.003
Phenols	-	-	N/A



Photo 10 (DSC01089): Sample 10-21250/51 Dye-M Bottles of water collected from the former BPA (LS)

*Waste water from the LS Former BPA was discharged to the ground on June 21, 2010.
(563129 / 7387533)*

LOCATION: UPPER SITE BPA – SAMPLE WAS COLLECTED FROM THE NORTH SIDE
GPS COORDINATES: 563352 / 7386908
SAMPLE: 10-21254
DATE: June 22, 2010

Parameter	Maximum Allowable Concentration	Units	Sample # 10-21254
pH	6-9	pH units	6.31
Total arsenic (As)	0.100	mg/L	<0.003
Dissolved cadmium (Cd)	0.010	mg/L	<0.001
Dissolved chromium (Cr)	0.100	mg/L	<0.005
Dissolved cobalt (Co)	0.050	mg/L	<0.001
Dissolved copper (Cu)	0.200	mg/L	<0.005
Dissolved lead (Pb)	0.050	mg/L	<0.010
Total mercury (Hg)	0.0006	mg/L	<0.0004
Dissolved nickel (Ni)	0.200	mg/L	<0.005
Total zinc (Zn)	0.500	mg/L	0.028
Oil & grease	5	mg/L	5.3
PCBs	1.0	mg/L	<0.003
Phenols	-	-	N/A



Photo 11 (DSC01244): Sample 10-21254 Dye-M Collecting a sample from the US BPA

Water from the Upper Site BPA was over the criterion for Oil and Grease and therefore was not discharged to land. The level of water in the Upper Site BPA decreased over the summer and no discharge events were required.

We trust that the information provided meets current requirements. Please contact the undersigned if you have any questions or concerns.

Sincerely,

A handwritten signature in black ink, appearing to read 'Casucci'.

Candice Casucci
Environmental Sciences Group

cc: Eva Schulz (UMA)
Daniela Loock, Kat White, Marc Ellemers, Megan Lord, Andrea Ellis (ESG)

APPENDIX A
LABORATORY RESULTS

ASU #	12752		Report ID:	Dye-M W7
Client:	ESG		Date Submitted:	14-Jun-10
			Date tested:	14-Jun-10
Site:	Dye-M		Date:	15-Jun-10
	10-010		Matrix:	water
Report of Analysis				
Sample	Oil & Grease			
	mg/L			
10-21241	<2.0			
Blank	<2.0			
Control	13.9			
Control Target	15.7			

ASU #	12752		Report ID:	Dye-M W8
Client:	ESG		Date Submitted:	14-Jun-10
			Date tested:	14-Jun-10
Site:	Dye-M		Date:	15-Jun-10
	10-010		Matrix:	water
Report of Analysis				
Sample	Dissolved Lead			
	mg/L			
10-21241	<0.010			
Blank	<0.010			
Control	8.10			
Control Target	8.00			

ESG	ASG Login No: 20605
12 Verite Ave	Site: Dye-M
Dept. of Chem. / Chem. Eng., RMC	Client No: 10-010
P.O. Box 17000, Stn. Forces	Samples Received: 12-Jun-10
Kingston, Ontario K7K 7B4	Date of analysis: 14-Jun-10
(613) 541-6000 ext 6567	Method No: ASG 015
Fax: (613) 541-6596	Date Reported: 15-Jun-10
	Sheet No: 1 of 1

RESULTS OF PCB IN WATER ANALYSIS

Sample Type **	Sample I.D.	Unit	Aroclor 1254	Aroclor 1260
W	21241*	mg/L	< 0.003	< 0.003

* Average result of duplicate

Report Values in PPM

LABORATORY QA/QC

Blank	mg/L	< 0.003	< 0.003
Duplicate ; 21241*	mg/L	< 0.003 ; < 0.003	< 0.003 ; < 0.003
Control Sample	mg/L	< 0.003	0.014
Control Sample Target	mg/L	< 0.003	0.015

** S = Soil , C = Concrete , PC = Paint Chip , SW = Swab , P = Plant , W = Water

ESG	ASG Login No: 20609
12 Verite Ave	Site: Dye-M
Dept. of Chem. / Chem. Eng., RMC	Client No: 10-011
P.O. Box 17000, Stn. Forces	Samples Received: 13-Jun-10
Kingston, Ontario K7K 7B4	Date of analysis: 14-Jun-10
(613) 541-6000 ext 6567	Method No: ASG 014
Fax: (613) 541-6596	Date Reported: 14-Jun-10
	Sheet: 1 of 1

RESULTS OF MERCURY ANALYSIS

Sample ID	Mercury ug/L
10-21242*	< 0.4

*Average result of duplicates.

LABORATORY QA/QC

Sample ID	Mercury ug/L
Duplicate ; 10-21242*	< 0.4 ; < 0.4
Blank	< 0.4
Control Target	4.00
Control Sample	4.10

ASU #	12750		Report ID:	Dye-M W4
Client:	ESG		Date Submitted:	14-Jun-10
			Date tested:	14-Jun-10
Site:	Dye-M		Date:	15-Jun-10
	10-011		Matrix:	water
Report of Analysis				
Sample	Oil & Grease			
	mg/L			
10-21242	<2.0			
Blank	<2.0			
Control	13.8			
Control Target	15.7			

RESULTS OF PCB IN WATER ANALYSIS

Sample Type **	Sample I.D.	Unit	Aroclor 1254	Aroclor 1260
W	21242	mg/L	< 0.003	< 0.003

* Average result of duplicate

Report Values in PPM

LABORATORY QA/QC

	Blank	mg/L	< 0.003	< 0.003
	Control Sample	mg/L	< 0.003	0.014
	Control Sample Target	mg/L	< 0.003	0.015

** S = Soil , C = Concrete , PC = Paint Chip , SW = Swab , P = Plant , W = Water

ASU #	12750		Report ID:	Dye-M W3				
Client:	ESG		Date Submitted:	14-Jun-10				
			Date tested:	14-Jun-10				
Site:	Dye-M		Date:	15-Jun-10				
	10-011		Matrix:	Water				
Report of Analysis								
Total Metals	Results in mg/L							
SAMPLE	Cu	Ni	Co	Cd	Pb	Zn	Cr	As
10-21242	-	-	-	-	-	0.026	<0.005	<0.003
Blank	-	-	-	-	-	<0.010	<0.005	<0.003
Control	-	-	-	-	-	3.05	0.82	0.78
Control Target	-	-	-	-	-	3.00	0.80	0.80
Dissolved Metals	Results in mg/L							
SAMPLE	Cu	Ni	Co	Cd	Pb	Zn	Cr	As
10-21242	<0.005	<0.005	<0.003	<0.001	<0.010	-	-	-
Blank	<0.005	<0.005	<0.003	<0.001	<0.010	-	-	-
Control	1.61	1.62	1.61	0.79	8.10	-	-	-
Control Target	1.60	1.60	1.60	0.80	8.00	-	-	-

ESG						ASG Login No:	20610
12 Verite Ave						Site:	Dye-M
Dept. of Chem. / Chem. Eng., RMC						Client No:	10-012
P.O. Box 17000, Stn. Forces						Samples Received:	13-Jun-10
Kingston, Ontario K7K 7B4						Date of analysis:	14-Jun-10
(613) 541-6000 ext 6567						Method No:	ASG 014
Fax: (613) 541-6596						Date Reported:	14-Jun-10
						Sheet:	1 of 1

RESULTS OF MERCURY ANALYSIS

Sample ID	Mercury ug/L
10-21243*	< 0.4

*Average result of duplicates.

LABORATORY QA/QC

Sample ID	Mercury ug/L
Duplicate ; 10-21243*	< 0.4 ; < 0.4
Blank	< 0.4
Control Target	4.00
Control Sample	4.10

ASU #	12751		Report ID:	Dye-M W5
Client:	ESG		Date Submitted:	14-Jun-10
			Date tested:	14-Jun-10
Site:	Dye-M		Date:	15-Jun-10
	10-012		Matrix:	water
Report of Analysis				
Sample	Oil & Grease			
	mg/L			
10-21243	<2.0			
Blank	<2.0			
Control	13.9			
Control Target	15.7			

ESG

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 Kingston, Ontario K7K 7B4
 (613) 541-6000 ext 6567
 Fax: (613) 541-6596

ASG Login No: 20610

Site: Dye-M

Client No: 10-012

Samples Received: 13-Jun-10

Date of analysis: 14-Jun-10

Method No: ASG 015

Date Reported: 15-Jun-10

Sheet No: 1 of 1

RESULTS OF PCB IN WATER ANALYSIS

Sample Type **	Sample I.D.	Unit	Aroclor 1254	Aroclor 1260
W	21243	mg/L	< 0.003	< 0.003

* Average result of duplicate

Report Values in PPM

LABORATORY QA/QC

Blank	mg/L	< 0.003	< 0.003
Control Sample	mg/L	< 0.003	0.014
Control Sample Target	mg/L	< 0.003	0.015

** S = Soil , C = Concrete , PC = Paint Chip , SW = Swab , P = Plant , W = Water

ASU #	12751		Report ID:	Dye-M W6				
Client:	ESG		Date Submitted:	14-Jun-10				
			Date tested:	14-Jun-10				
Site:	Dye-M		Date:	15-Jun-10				
	10-012		Matrix:	Water				
Report of Analysis								
Total Metals	Results in mg/L							
SAMPLE	Cu	Ni	Co	Cd	Pb	Zn	Cr	As
10-21243	-	-	-	-	-	<0.010	<0.005	<0.003
Blank	-	-	-	-	-	<0.010	<0.005	<0.003
Control	-	-	-	-	-	3.05	0.82	0.78
Control Target	-	-	-	-	-	3.00	0.80	0.80
Dissolved Metals	Results in mg/L							
SAMPLE	Cu	Ni	Co	Cd	Pb	Zn	Cr	As
10-21243	<0.005	<0.005	<0.003	<0.001	<0.010	-	-	-
Blank	<0.005	<0.005	<0.003	<0.001	<0.010	-	-	-
Control	1.61	1.62	1.61	0.79	8.10	-	-	-
Control Target	1.60	1.60	1.60	0.80	8.00	-	-	-

ASU #	12758		Report ID:	Dye-M W9
Client:	ESG		Date Submitted:	14-Jun-10
			Date tested:	14-Jun-10
Site:	Dye-M		Date:	15-Jun-10
	10-018		Matrix:	water
Report of Analysis				
Sample	Dissolved Lead			
	mg/L			
10-21244	<0.010	*		
10-21245	<0.010			
10-21246	<0.010			
Blank	<0.010			
10-21244	<0.010			
10-21244	<0.010			
Control	8.10			
Control Target	8.00			

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(613) 541-6000 ext 6567
Fax: (613) 541-6596

ASG Login No:	20613
Site:	Dye-M
Client No:	10-018
amples Received:	14-Jun-10
Date of analysis:	14-Jun-10
Method No:	ASG 015
Date Reported:	15-Jun-10
Sheet No:	1 of 1

Sample Type **	Sample I.D.	Unit	Aroclor 1254	Aroclor 1260
W	21244	mg/L	< 0.003	< 0.003
W	21245	mg/L	< 0.003	< 0.003
W	21246	mg/L	< 0.003	< 0.003

* Average result of duplicate

Report Values in PPM

	Blank	mg/L	< 0.003	< 0.003
	Control Sample	mg/L	< 0.003	0.014
	Control Sample Target	mg/L	< 0.003	0.015

** S = Soil , C = Concrete , PC = Paint Chip , SW = Swab , P = Plant , W = Water

ESG		
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Kingston, Ontario K7K 7B4		
(613) 541-6000 ext 6567		
Fax: (613) 541-6596		

ASG Login No:	20613
Site:	Dye-M
Client No:	10-018
Samples Received:	14-Jun-10
Date of analysis:	14-Jun-10
Method No:	ASG 037
Date Reported:	15-Jun-10
Page:	1 of 1

Sample I.D.	pH
21244*	6.67
21245	6.66
21246	6.65

* Averaged result of duplicates

Sample I.D.	pH
21244 ; 21244	6.67 ; 6.66
Control	6.98
Control Target	7.00

ASU #	12758		Report ID:	Dye-M W10										
Client:	ESG		Date Submitted:	14-Jun-10										
			Date tested:	16-Jun-10										
Site:	Dye-M		Date:	17-Jun-10										
	10-018		Matrix:	water										
Report of Analysis														
Sample	Oil & Grease													
	mg/L													
10-21244	<2.0													
10-21245	<2.0													
10-21246	<2.0													
Blank	<2.0													
Control	13.6													
Control Target	15.7													
ESG			ASG Login No:	20616										
12 Verite Ave			Site:	Dye-M										
Dept. of Chem. / Chem. Eng., RMC			Client No:	10-019										
P.O. Box 17000, Stn. Forces			Samples Received:	14-Jun-10										
Kingston, Ontario K7K 7B4			Date of analysis:	14-Jun-10										
(613) 541-6000 ext 6567			Method No:	ASG 014										
Fax: (613) 541-6596			Date Reported:	15-Jun-10										
			Sheet:	1 of 1										
<p align="center">RESULTS OF MERCURY ANALYSIS</p> <table border="1"> <thead> <tr> <th>Sample ID</th> <th>Mercury ug/L</th> </tr> </thead> <tbody> <tr> <td>10-21247</td> <td>< 0.4</td> </tr> <tr> <td>10-21248*</td> <td>< 0.4</td> </tr> <tr> <td></td> <td></td> </tr> </tbody> </table> <p>*Average result of duplicates.</p>					Sample ID	Mercury ug/L	10-21247	< 0.4	10-21248*	< 0.4				
Sample ID	Mercury ug/L													
10-21247	< 0.4													
10-21248*	< 0.4													
<p align="center">LABORATORY QA/QC</p> <table border="1"> <thead> <tr> <th>Sample ID</th> <th>Mercury ug/L</th> </tr> </thead> <tbody> <tr> <td>Duplicate ; 10-21248*</td> <td>< 0.4 ; < 0.4</td> </tr> <tr> <td>Blank</td> <td>< 0.4</td> </tr> <tr> <td>Control Target</td> <td>4.00</td> </tr> <tr> <td>Control Sample</td> <td>4.20</td> </tr> </tbody> </table>					Sample ID	Mercury ug/L	Duplicate ; 10-21248*	< 0.4 ; < 0.4	Blank	< 0.4	Control Target	4.00	Control Sample	4.20
Sample ID	Mercury ug/L													
Duplicate ; 10-21248*	< 0.4 ; < 0.4													
Blank	< 0.4													
Control Target	4.00													
Control Sample	4.20													

ESG				ASG Login No: 20616
12 Verite Ave				Site: Dye-M
Dept. of Chem. / Chem. Eng., RMC				Client No: 10-019
P.O. Box 17000, Stn. Forces				Samples Received: 14-Jun-10
Kingston, Ontario K7K 7B4				Date of analysis: 14-Jun-10
(613) 541-6000 ext 6567				Method No: ASG 037
Fax: (613) 541-6596				Date Reported: 15-Jun-10
				Page: 1 of 1

RESULTS OF pH ANALYSIS

Sample I.D.	pH
21247	6.39
21248	6.56

LABORATORY QA/QC

Sample I.D.	pH
Control	6.98
Control Target	7.00

ASU #	12747	Report ID:	Dye-M W1
Client:	ESG	Date Submitted:	14-Jun-10
		Date tested:	14-Jun-10
Site:	Dye-M	Date:	15-Jun-10
	10-019	Matrix:	water

Report of Analysis

Sample	Oil & Grease mg/L		
10-21247	11.5		
10-21248	<2.0		
Blank	<2.0		
Control	13.9		
Control Target	15.7		

ESG	ASG Login No: 20616
12 Verite Ave	Site: Dye-M
Dept. of Chem. / Chem. Eng., RMC	Client No: 10-019
P.O. Box 17000, Stn. Forces	Samples Received: 14-Jun-10
Kingston, Ontario K7K 7B4	Date of analysis: 14-Jun-10
(613) 541-6000 ext 6567	Method No: ASG 015
Fax: (613) 541-6596	Date Reported: 15-Jun-10
	Sheet No: 1 of 1

RESULTS OF PCB IN WATER ANALYSIS				
Sample Type **	Sample I.D.	Unit	Aroclor 1254	Aroclor 1260
W	21247	mg/L	< 0.003	< 0.003
W	21248	mg/L	< 0.003	< 0.003

* Average result of duplicate
 Report Values in PPM

LABORATORY QA/QC				
	Blank	mg/L	< 0.003	< 0.003
	Control Sample	mg/L	< 0.003	0.014
	Control Sample Target	mg/L	< 0.003	0.015

** S = Soil , C = Concrete , PC = Paint Chip , SW = Swab , P = Plant , W = Water

	Blank	mg/L	< 0.003	< 0.003
	Control Sample	mg/L	< 0.003	0.014
	Control Sample Target	mg/L	< 0.003	0.015

ASU #	12747		Report ID:	Dye-M W2				
Client:	ESG		Date Submitted:	14-Jun-10				
			Date tested:	14-Jun-10				
Site:	Dye-M		Date:	15-Jun-10				
	10-019		Matrix:	Water				
Report of Analysis								
Total Metals	Results in mg/L							
SAMPLE	Cu	Ni	Co	Cd	Pb	Zn	Cr	As
10-21247	-	-	-	-	-	0.134	<0.005	<0.003
10-21248	-	-	-	-	-	0.016	<0.005	<0.003
Blank	-	-	-	-	-	<0.010	<0.005	<0.003
10-21248	-	-	-	-	-	0.016	<0.005	<0.003
10-21248	-	-	-	-	-	0.015	<0.005	<0.003
Control	-	-	-	-	-	3.05	0.82	0.78
Control Target	-	-	-	-	-	3.00	0.80	0.80
Dissolved Metals	Results in mg/L							
SAMPLE	Cu	Ni	Co	Cd	Pb	Zn	Cr	As
10-21247	<0.005	<0.005	<0.003	<0.001	<0.010	-	-	-
10-21248	<0.005	<0.005	<0.003	<0.001	<0.010	-	-	-
Blank	<0.005	<0.005	<0.003	<0.001	<0.010	-	-	-
10-21248	<0.005	<0.005	<0.003	<0.001	<0.010	-	-	-
10-21248	<0.005	<0.005	<0.003	<0.001	<0.010	-	-	-
Control	1.61	1.62	1.61	0.79	8.10	-	-	-
Control Target	1.60	1.60	1.60	0.80	8.00	-	-	-

ESG

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 Fax: (613) 541-6596

ASG Login No: 20627

Site: Dye-M

Client No: 10-023

Samples Received: 16-Jun-10

Date of analysis: 17-Jun-10

Method No: ASG 021

Date Reported: 18-Jun-10

Sheet: 1 of 1

RESULTS OF MERCURY ANALYSIS

Sample ID	Mercury ug/L
21249	< 0.4
21250	< 0.4
21251*	< 0.4

*Average result of duplicates.

LABORATORY QA/QC

Sample ID	Mercury ug/L
Duplicate ; 21251*	< 0.4 ; < 0.4
Blank	< 0.4
Control Target	4.00
Control Sample	4.20

ESG

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 P.O. Box 17000, Stn. Forces
 Kingston, Ontario K7K 7B4
 (613) 541-6000 ext 6567
 Fax: (613) 541-6596

ASG Login No: 20627

Site: Dye-M

Client No: 10-023

Samples Received: 16-Jun-10

Date of analysis: 17-Jun-10

Method No: ASG 015

Date Reported: 18-Jun-10

Sheet No: 1 of 1

RESULTS OF PCB IN WATER ANALYSIS

Sample Type **	Sample I.D.	Unit	Aroclor 1254	Aroclor 1260
W	21249*	mg/L	< 0.003	< 0.003
W	21250	mg/L	< 0.003	< 0.003
W	21251	mg/L	< 0.003	< 0.003

* Average result of duplicate

Report Values in PPM

LABORATORY QA/QC

Blank	mg/L	< 0.003	< 0.003
Duplicate ; 21249*	mg/L	< 0.003 ; < 0.003	< 0.003 ; < 0.003
Control Sample	mg/L	< 0.003	0.013
Control Sample Target	mg/L	< 0.003	0.015

** S = Soil , C = Concrete , PC = Paint Chip , SW = Swab , P = Plant , W = Water

ESG	ASG Login No: 20627
12 Verite Ave	Site: Dye-M
Dept. of Chem. / Chem. Eng., RMC	Client No: 10-023
P.O. Box 17000, Stn. Forces	Samples Received: 16-Jun-10
Kingston, Ontario K7K 7B4	Date of analysis: 16-Jun-10
(613) 541-6000 ext 6567	Method No: ASG 037
Fax: (613) 541-6596	Date Reported: 16-Jun-10
	Page: 1 of 1

RESULTS OF pH ANALYSIS

Sample I.D.	pH
21249	7.23
21250	7.08
21251*	7.18

* Averaged result of duplicates

LABORATORY QA/QC

Sample I.D.	pH
21252* ; Duplicate	7.18 ; 7.17
Control	7.01
Control Target	7.00

ASU #	12768		Report ID:	Dye-M W15				
Client:	ESG		Date Submitted:	16-Jun-10				
			Date tested:	17-Jun-10				
Site:	Dye-M		Date:	18-Jun-10				
	10-023		Matrix:	Water				
Report of Analysis								
Total Metals	Results in mg/L							
SAMPLE	Cu	Ni	Co	Cd	Pb	Zn	Cr	As
10-21249	-	-	-	-	-	0.013	0.006	<0.003
10-21250	-	-	-	-	-	0.014	<0.005	<0.003
10-21251	-	-	-	-	-	0.013	<0.005	<0.003
Blank	-	-	-	-	-	<0.010	<0.005	<0.003
Control	-	-	-	-	-	3.04	0.83	0.77
Control Target	-	-	-	-	-	3.00	0.80	0.80
10-21251						0.013	<0.005	<0.003
10-21251						0.013	<0.005	<0.003
Dissolved Metals	Results in mg/L							
SAMPLE	Cu	Ni	Co	Cd	Pb	Zn	Cr	As
10-21249	<0.005	<0.005	<0.003	<0.001	<0.010	-	-	-
10-21250	<0.005	<0.005	<0.003	<0.001	<0.010	-	-	-
10-21251	<0.005	<0.005	<0.003	<0.001	<0.010	-	-	-
Blank	<0.005	<0.005	<0.003	<0.001	<0.010	-	-	-
Control	1.63	1.63	1.61	0.81	8.12	-	-	-
Control Target	1.60	1.60	1.60	0.80	8.00	-	-	-
10-21251	<0.005	<0.005	<0.003	<0.001	<0.010			
10-21251	<0.005	<0.005	<0.003	<0.001	<0.010			

ASU #	12768		Report ID:	Dye-M W14
Client:	ESG		Date Submitted:	16-Jun-10
			Date tested:	16-Jun-10
Site:	Dye-M		Date:	17-Jun-10
	10-023		Matrix:	water
Report of Analysis				
Sample	Oil & Grease			
	mg/L			
10-21249	<2.0			
10-21250	<2.0			
10-21251	<2.0			
Blank	<2.0			
Control	13.6			
Control Target	15.7			

ASU #	12811		Report ID:	Dye-M W17
Client:	ESG		Date Submitted:	25-Jun-10
			Date tested:	26-Jun-10
Site:	Dye-M		Date:	28-Jun-10
	10-054		Matrix:	water
Report of Analysis				
Sample	Oil & Grease			
	mg/L			
10-21254	5.3			
Blank	<2.0			
Control	14.3			
Control Target	15.7			
Results relate only to the items tested				

ESG					ASG Login No: 20668
12 Verite Ave					Site: Dye-M
Dept. of Chem. / Chem. Eng., RMC					Client No: 10-054
P.O. Box 17000, Stn. Forces					Samples Received: 25-Jun-10
Kingston, Ontario K7K 7B4					Date of analysis: 25-Jun-10
(613) 541-6000 ext 6567					Method No: ASG 015
Fax: (613) 541-6596					Date Reported: 28-Jun-10
					Sheet No: 1 of 1

RESULTS OF PCB IN WATER ANALYSIS

Sample Type **	Sample I.D.	Unit	Aroclor 1254	Aroclor 1260
W	21254	mg/L	< 0.003	< 0.003

* Average result of duplicate

Report Values in PPM

LABORATORY QA/QC

Blank	mg/L	< 0.003	< 0.003
Control Sample	mg/L	< 0.003	0.011
Control Sample Target	mg/L	< 0.003	0.015

** S = Soil , C = Concrete , PC = Paint Chip , SW = Swab , P = Plant , W = Water

ASU #	12811	Report ID:	Dye-M W16					
Client:	ESG	Date Submitted:	25-Jun-10					
		Date tested:	28-Jun-10					
Site:	Dye-M	Date:	28-Jun-10					
	10-054	Matrix:	Water					
Report of Analysis								
Total Metals	Results in mg/L							
SAMPLE	Cu	Ni	Co	Cd	Pb	Zn	Cr	As
10-21254	-	-	-	-	-	0.028	<0.005	<0.003
Blank	-	-	-	-	-	<0.010	<0.005	<0.003
Control	-	-	-	-	-	3.08	0.83	0.79
Control Target	-	-	-	-	-	3.00	0.80	0.80
Dissolved Metals								
Dissolved Metals	Results in mg/L							
SAMPLE	Cu	Ni	Co	Cd	Pb	Zn	Cr	As
10-21254	<0.005	<0.005	<0.003	<0.001	<0.010	-	-	-
Blank	<0.005	<0.005	<0.003	<0.001	<0.010	-	-	-
Control	1.62	1.64	1.63	0.81	8.12	-	-	-
Control Target	1.60	1.60	1.60	0.80	8.00	-	-	-

ESG	ASG Login No: 20668
12 Verite Ave	Site: Dye-M
Dept. of Chem. / Chem. Eng., RMC	Client No: 10-054
P.O. Box 17000, Stn. Forces	Samples Received: 25-Jun-10
Kingston, Ontario K7K 7B4	Date of analysis: 28-Jun-10
(613) 541-6000 ext 6567	Method No: ASG 014
Fax: (613) 541-6596	Date Reported: 28-Jun-10
	Sheet: 1 of 1

RESULTS OF MERCURY ANALYSIS

Sample ID	Mercury mg/L
21254	< 0.0004

LABORATORY QA/QC

Sample ID	Mercury mg/L
Blank	< 0.0004
Control Target	0.0040
Control Sample	0.0042

ESG	ASG Login No: 20668
12 Verite Ave	Site: Dye-M
Dept. of Chem. / Chem. Eng., RMC	Client No: 10-054
P.O. Box 17000, Stn. Forces	Samples Received: 25-Jun-10
Kingston, Ontario K7K 7B4	Date of analysis: 25-Jun-10
(613) 541-6000 ext 6567	Method No: ASG 037
Fax: (613) 541-6596	Date Reported: 28-Jun-10
	Page: 1 of 1

RESULTS OF pH ANALYSIS

Sample I.D.	pH
21254	6.31

* Averaged result of duplicates

LABORATORY QA/QC

Sample I.D.	pH
21254 ; 21254	6.30 ; 6.32
Control	7.01
Control Target	7.00

Candice Casucci
Environmental Sciences Group
The Royal Military College of Canada
PO Box 17000 Stn. Forces
Kingston, ON K7K 7B4



Tamara Van Dyck
Environmental Officer
Defence Construction Canada
DEW Line Cleanup PMO
350 Albert Street, Suite 1720
Ottawa ON K1A 0K3

Monday, March 21, 2011

August 2010 Monthly Report for Water Use License Number: IBR-DYE0914

The following results of the Monitoring Program (MP) and/or Water Use License are provided by the Environmental Sciences Group to meet the requirements of the above-noted license for *DYE-M (Cape Dyer)*.

1. SEWAGE EFFLUENT

A sewage lagoon was constructed at DYE-M in September of 2004. The Water Use License and MP require that samples from treated sewage lagoon effluent at the point of discharge to the receiving water be collected prior to each discharge event.

No samples were collected from the DYE-M sewage lagoons in July.

We trust that the information provided meets current requirements. Please contact the undersigned if you have any questions or concerns.

Sincerely,

Candice Casucci
Environmental Sciences Group

cc: Eva Schulz (UMA)
Daniela Looke, Kat White, Marc Ellemers, Andrea Ellis, Megan Lord (ESG)

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The Royal Military College of Canada
PO Box 17000 Stn. Forces
Kingston, ON K7K 7B4



Tamara Van Dyck
Environmental Officer
Defence Construction Canada
DEW Line Cleanup PMO
101 Colonel By Drive
Ottawa ON K1A 0K2

Monday, March 21, 2011

RE: Analytical Results for Wastewater Samples Collected at DYE-M in July 2010

The following report summarizes results of the analysis of wastewater samples as per the DYE-M (Cape Dyer) DEW Line Cleanup Project (DLCU) Specifications.

The DYE-M specifications require that “wash water, melt water collection, rinse water resulting from the cleaning of fuel tanks and pipelines, and/or any other liquid effluent stream” meet the following guidelines prior to their discharge to land (01560.4.1):

Parameter	Maximum Allowable Concentration	Units
pH	6-9	pH units
Total arsenic (As)	0.100	mg/L
Dissolved cadmium (Cd)	0.010	mg/L
Dissolved chromium (Cr)	0.100	mg/L
Dissolved cobalt (Co)	0.050	mg/L
Dissolved copper (Cu)	0.200	mg/L
Dissolved lead (Pb)	0.050	mg/L
Total mercury (Hg)	0.0006	mg/L
Dissolved nickel (Ni)	0.200	mg/L
Total zinc (Zn)	0.500	mg/L
Oil & grease	5	mg/L
PCBs	1.0	mg/L
Phenols	-	-

Phenols

The wastewater samples collected by ESG at DYE-M in July, 2010 were not analyzed for phenols but they were analyzed for oil and grease. Research conducted by ESG¹ has determined that a) no federal, territorial or provincial criteria exist for the discharge of wastewater containing phenols to land at a minimum distance of 30-m from natural

¹ Environmental Sciences Group. *DEW Line Clean Up Project – Phenols in Wastewater*. June, 2007.

drainage courses b) the maximum concentration of phenols in DLCU wastewater to date (2.44 mg/L) is below the LC₅₀ for freshwater fish and crustaceans and below the oral and dermal LD₅₀s for rats and rodents and c) phenols in excess of the maximum allowable concentration (MAC) have historically co-occurred with a visible oil & grease sheen and/or with an exceedance of the MAC for oil & grease. This information, and a subsequent decision to not test for phenols, has been presented to the NWB. To date, verbal agreement from the NWB has been received, but the project is awaiting written confirmation of the decision to suspend testing for phenols.

WASTEWATER SAMPLES

Fourteen wastewater samples were collected at DYE-M and analyzed in July 2010. A summary of the details of these results follows. Laboratory results are provided in Appendix A.

LOCATION: TREATMENT CELL/HOLDING BASIN #1

GPS COORDINATES: 0563052 7387584

SAMPLE: 10-21286

DATE: JULY 9, 2010

Parameter	Maximum Allowable Concentration	Units	Sample # 10-21286
pH	6-9	Units	6.98
Total Arsenic	0.100	pH units	<0.003
Dissolved Cadmium	0.010	mg/L	<0.001
Total Chromium	0.100	mg/L	0.006
Dissolved Cobalt	0.050	mg/L	<0.003
Dissolved Copper	0.200	mg/L	<0.005
Dissolved Lead	0.050	mg/L	<0.010
Total Mercury	0.0006	mg/L	<0.0004
Dissolved Nickel	0.200	mg/L	<0.005
Total Zinc	0.500	mg/L	<0.010
Oil & Grease	5	mg/L	3.7
PCBs	1.0	mg/L	<0.003
Phenols	-	mg/L	N/A

LOCATION: TREATMENT CELL/HOLDING BASIN #2

GPS COORDINATES: 0563039 7387593

SAMPLE: 10-21287

DATE: JULY 9, 2010

Parameter	Maximum Allowable Concentration	Units	Sample # 10-21287
pH	6-9	pH units	6.60
Total arsenic (As)	0.100	mg/L	<0.003
Dissolved cadmium (Cd)	0.010	mg/L	<0.001
Dissolved chromium (Cr)	0.100	mg/L	<0.005
Dissolved cobalt (Co)	0.050	mg/L	<0.003
Dissolved copper (Cu)	0.200	mg/L	<0.005
Dissolved lead (Pb)	0.050	mg/L	<0.010
Total mercury (Hg)	0.0006	mg/L	<0.0004
Dissolved nickel (Ni)	0.200	mg/L	<0.005
Total zinc (Zn)	0.500	mg/L	<0.010
Oil & grease	5	mg/L	<2.0
PCBs	1.0	mg/L	<0.003
Phenols	-	-	N/A

LOCATION: TREATMENT CELL/HOLDING BASIN #3
GPS COORDINATES: 0563055 7387596
SAMPLE: 10-21288
DATE: JULY 9, 2010

Parameter	Maximum Allowable Concentration	Units	Sample # 10-21288
pH	6-9	pH units	6.57
Total arsenic (As)	0.100	mg/L	<0.003
Dissolved cadmium (Cd)	0.010	mg/L	<0.001
Dissolved chromium (Cr)	0.100	mg/L	<0.005
Dissolved cobalt (Co)	0.050	mg/L	<0.003
Dissolved copper (Cu)	0.200	mg/L	<0.005
Dissolved lead (Pb)	0.050	mg/L	<0.010
Total mercury (Hg)	0.0006	mg/L	<0.0004
Dissolved nickel (Ni)	0.200	mg/L	<0.005
Total zinc (Zn)	0.500	mg/L	0.011
Oil & grease	5	mg/L	<2.0
PCBs	1.0	mg/L	<0.003
Phenols	-	-	N/A



Photo 1 (DSCN5709) Sample 10-21286/87/88 Dye-M Sampling treatment cells

Wastewater from the Holding Basins was below criteria for all parameters in 2010. Water from the holding basins can be discharged to land in 2011.

LOCATION: TANKER W19G

GPS COORDINATES: 563112 7387514

SAMPLE: 10-21297

DATE: JULY 9, 2010

Parameter	Maximum Allowable Concentration	Units	Sample # 10-21297
pH	6-9	pH units	6.77
Total arsenic (As)	0.100	mg/L	<0.003
Dissolved cadmium (Cd)	0.010	mg/L	<0.001
Dissolved chromium (Cr)	0.100	mg/L	<0.005
Dissolved cobalt (Co)	0.050	mg/L	<0.003
Dissolved copper (Cu)	0.200	mg/L	<0.005
Dissolved lead (Pb)	0.050	mg/L	<0.010
Total mercury (Hg)	0.0006	mg/L	0.0004
Dissolved nickel (Ni)	0.200	mg/L	<0.005
Total zinc (Zn)	0.500	mg/L	<0.010
Oil & grease	5	mg/L	5.2
PCBs	1.0	mg/L	<0.003
Phenols	-	-	N/A



Photo 2 (DSCN5706) Sample 10-21297 Dye-M Collecting a wastewater sample from W19G (in former LS BPA)

Wastewater from tanks W19G was above criteria for oil and grease and was not discharged to the ground in 2010.

LOCATION: LS BPA – SAMPLE CAME FROM A TOTE WHICH WAS FILLED WITH WATER FROM THE LS PBA.

GPS COORDINATES: 563030 7387479

SAMPLE: 10-21298

DATE: JULY 14, 2010

Parameter	Maximum Allowable Concentration	Units	Sample # 10-21298
pH	6-9	pH units	5.77
Total arsenic (As)	0.100	mg/L	<0.003
Dissolved cadmium (Cd)	0.010	mg/L	<0.001
Dissolved chromium (Cr)	0.100	mg/L	0.018
Dissolved cobalt (Co)	0.050	mg/L	<0.003
Dissolved copper (Cu)	0.200	mg/L	<0.005
Dissolved lead (Pb)	0.050	mg/L	<0.010
Total mercury (Hg)	0.0006	mg/L	<0.0004
Dissolved nickel (Ni)	0.200	mg/L	<0.005
Total zinc (Zn)	0.500	mg/L	0.140
Oil & grease	5	mg/L	114
PCBs	1.0	mg/L	<0.003
Phenols	-	-	N/A



Photo 3 (DSC01464) Sample 10-21298 Dye-M Collecting a sample from a tote in LS BPA (full of ponded water from LS PBA)

Wastewater from the tote tank in the LS BPA was above criteria for oil and grease and was below the pH range. The wastewater was not discharged to the ground in 2010. Water from the tote tank was placed back in the LS BPA before winter.

**LOCATION: LS BPA – Re-SAMPLED / COMPOSITE SAMPLE FROM THREE
DIFFERENT AREAS IN THE BPA**

GPS COORDINATES: 1) 563044 7387485
2) 536060 7387506
3) 563035 7387528

SAMPLE: 10-21299

DATE: JULY 14, 2010

Parameter	Maximum Allowable Concentration	Units	Sample # 10-21299
pH	6-9	pH units	6.19
Total arsenic (As)	0.100	mg/L	<0.003
Dissolved cadmium (Cd)	0.010	mg/L	<0.001
Dissolved chromium (Cr)	0.100	mg/L	0.010
Dissolved cobalt (Co)	0.050	mg/L	<0.003
Dissolved copper (Cu)	0.200	mg/L	<0.005
Dissolved lead (Pb)	0.050	mg/L	<0.010
Total mercury (Hg)	0.0006	mg/L	<0.0004
Dissolved nickel (Ni)	0.200	mg/L	<0.005
Total zinc (Zn)	0.500	mg/L	0.347
Oil & grease	5	mg/L	29.7
PCBs	1.0	mg/L	<0.003
Phenols	-	-	N/A



Photo 4 (DSC01466) Sample 10-21299 Dye-M Collecting a composite sample of ponded water from LS BPA - South side

Wastewater in the LS-BPA was above criteria for oil and grease and was not discharged to the ground in 2010

LOCATION: LS BPA – TANKER 6451 NORTH CHAMBER

GPS COORDINATES: N/A

SAMPLE: 10-21309

DATE: JULY 16, 2010

Parameter	Maximum Allowable Concentration	Units	Sample # 10-21309
pH	6-9	pH units	5.93
Total arsenic (As)	0.100	mg/L	<0.003
Dissolved cadmium (Cd)	0.010	mg/L	<0.001
Dissolved chromium (Cr)	0.100	mg/L	0.006
Dissolved cobalt (Co)	0.050	mg/L	<0.003
Dissolved copper (Cu)	0.200	mg/L	<0.005
Dissolved lead (Pb)	0.050	mg/L	<0.010
Total mercury (Hg)	0.0006	mg/L	<0.0004
Dissolved nickel (Ni)	0.200	mg/L	<0.005
Total zinc (Zn)	0.500	mg/L	0.125
Oil & grease	5	mg/L	63200
PCBs	1.0	mg/L	<0.003
Phenols	-	-	N/A



Photo 5 (DSC01497) Sample 10-21309 Dye-M Collecting a sample from Tanker 6451 - north side.

LOCATION: LS BPA – TANKER 6451 SOUTH CHAMBER

GPS COORDINATES: 563008 7387491

SAMPLE: 10-21310

DATE: JULY 16, 2010

Parameter	Maximum Allowable Concentration	Units	Sample # 10-21310
pH	6-9	pH units	5.85
Total arsenic (As)	0.100	mg/L	<0.003
Dissolved cadmium (Cd)	0.010	mg/L	<0.001
Dissolved chromium (Cr)	0.100	mg/L	0.006
Dissolved cobalt (Co)	0.050	mg/L	<0.003
Dissolved copper (Cu)	0.200	mg/L	<0.005
Dissolved lead (Pb)	0.050	mg/L	<0.010
Total mercury (Hg)	0.0006	mg/L	<0.0004
Dissolved nickel (Ni)	0.200	mg/L	<0.005
Total zinc (Zn)	0.500	mg/L	0.126
Oil & grease	5	mg/L	42300
PCBs	1.0	mg/L	<0.003
Phenols	-	-	N/A

SAMPLE: 10-21311

DATE: JULY 16, 2010

Parameter	Maximum Allowable Concentration	Units	Sample # 10-21311
pH	6-9	pH units	5.84
Total arsenic (As)	0.100	mg/L	<0.003
Dissolved cadmium (Cd)	0.010	mg/L	<0.001
Dissolved chromium (Cr)	0.100	mg/L	0.006
Dissolved cobalt (Co)	0.050	mg/L	<0.00
Dissolved copper (Cu)	0.200	mg/L	<0.005
Dissolved lead (Pb)	0.050	mg/L	<0.010
Total mercury (Hg)	0.0006	mg/L	<0.0004
Dissolved nickel (Ni)	0.200	mg/L	<0.005
Total zinc (Zn)	0.500	mg/L	0.126
Oil & grease	5	mg/L	69000
PCBs	1.0	mg/L	<0.003
Phenols	-	-	N/A



Photo 6 (DSC01499) Sample 10-21310/11 Dye-M Collecting a sample from Tanker 6451 - south side

LOCATION: LS BPA – TANKER 6451 MIDDLE CHAMBER

GPS COORDINATES: N/A

SAMPLE: 10-21312

DATE: JULY 16, 2010

Parameter	Maximum Allowable Concentration	Units	Sample # 10-21312
pH	6-9	pH units	5.96
Total arsenic (As)	0.100	mg/L	<0.003
Dissolved cadmium (Cd)	0.010	mg/L	0.004
Dissolved chromium (Cr)	0.100	mg/L	0.006
Dissolved cobalt (Co)	0.050	mg/L	<0.003
Dissolved copper (Cu)	0.200	mg/L	<0.005
Dissolved lead (Pb)	0.050	mg/L	<0.010
Total mercury (Hg)	0.0006	mg/L	<0.0004
Dissolved nickel (Ni)	0.200	mg/L	<0.005
Total zinc (Zn)	0.500	mg/L	0.126
Oil & grease	5	mg/L	25200
PCBs	1.0	mg/L	<0.003
Phenols	-	-	N/A

Wastewater from Tanker 6451 (LS-BPA) was above criteria for oil and grease and was below the pH range. The wastewater was not discharged to the ground in 2010.

LOCATION: US NHL - WASTEWATER POOLED IN FACILITY

GPS COORDINATES: 572150 7395171

SAMPLE: 10-21324

DATE: JULY 31, 2010

Parameter	Maximum Allowable Concentration	Units	Sample # 10-21324
pH	6-9	pH units	7.30
Total arsenic (As)	0.100	mg/L	<0.003
Dissolved cadmium (Cd)	0.010	mg/L	0.037
Dissolved chromium (Cr)	0.100	mg/L	0.011
Dissolved cobalt (Co)	0.050	mg/L	<0.003
Dissolved copper (Cu)	0.200	mg/L	<0.005
Dissolved lead (Pb)	0.050	mg/L	<0.010
Total mercury (Hg)	0.0006	mg/L	<0.0004
Dissolved nickel (Ni)	0.200	mg/L	<0.005
Total zinc (Zn)	0.500	mg/L	0.706
Oil & grease	5	mg/L	<2.0
PCBs	1.0	mg/L	<0.003
Phenols	-	-	N/A



Photo 7 (DSC01626) Sample 10-21324 Dye-M US NHL - Collecting a sample from the pooled water in the northwest corner.

Waste water from the US NHL was discharged to the ground on August 5, 2010, before results were received with permission from the Water Board. The water was discharged to an INAC approved location (572140 7395185). All results were below criteria.

LOCATION: US TIER II - WASTEWATER POOLED IN FACILITY

GPS COORDINATES: 571057 7394617

SAMPLE: 10-21325

DATE: JULY 31, 2010

Parameter	Maximum Allowable Concentration	Units	Sample # 10-21325
pH	6-9	pH units	7.15
Total arsenic (As)	0.100	mg/L	<0.003
Dissolved cadmium (Cd)	0.010	mg/L	0.002
Dissolved chromium (Cr)	0.100	mg/L	0.011
Dissolved cobalt (Co)	0.050	mg/L	<0.003
Dissolved copper (Cu)	0.200	mg/L	<0.005
Dissolved lead (Pb)	0.050	mg/L	<0.010
Total mercury (Hg)	0.0006	mg/L	<0.0004
Dissolved nickel (Ni)	0.200	mg/L	<0.005
Total zinc (Zn)	0.500	mg/L	0.035
Oil & grease	5	mg/L	<2.0
PCBs	1.0	mg/L	<0.003
Phenols	-	-	N/A



Photo 8 (DSC01637) Sample 10-21325 Dye-M US Tier II - Collecting a sample from the pooled water on the west side of the facility

Waste water from the US Tier II was discharged to the ground on August 5, 2010, before results were received with permission from the Water Board. The water was discharged to an INAC approved location (571047 7394637). All results were below criteria.

LOCATION: LS TIER II - WASTEWATER POOLED IN FACILITY

GPS COORDINATES: 561864 7388309

SAMPLE: 10-21326

DATE: JULY 31, 2010

Parameter	Maximum Allowable Concentration	Units	Sample # 10-21326
pH	6-9	pH units	7.10
Total arsenic (As)	0.100	mg/L	0.004
Dissolved cadmium (Cd)	0.010	mg/L	0.002
Dissolved chromium (Cr)	0.100	mg/L	0.085
Dissolved cobalt (Co)	0.050	mg/L	<0.003
Dissolved copper (Cu)	0.200	mg/L	<0.005
Dissolved lead (Pb)	0.050	mg/L	<0.010
Total mercury (Hg)	0.0006	mg/L	<0.0004
Dissolved nickel (Ni)	0.200	mg/L	<0.005
Total zinc (Zn)	0.500	mg/L	0.075
Oil & grease	5	mg/L	<2.0
PCBs	1.0	mg/L	<0.003
Phenols	-	-	N/A



Photo 9 (DSC01646) Sample 10-21326 Dye-M Collecting a sample from pooled water in the LS Tier II - Water pooled all along the north berm

Waste water from the LS Tier II was discharged to the ground on August4, 2010, before results were received with permission from the Water Board. The water was discharged to an INAC approved location (561902 7388362). All results were below criteria.

LOCATION: LS NHWL - WASTEWATER POOLED IN FACILITY

GPS COORDINATES: 562990 7387010

SAMPLE: 10-21327

DATE: JULY 31, 2010

Parameter	Maximum Allowable Concentration	Units	Sample # 10-21327
pH	6-9	pH units	6.82
Total arsenic (As)	0.100	mg/L	<0.03
Dissolved cadmium (Cd)	0.010	mg/L	<0.001
Dissolved chromium (Cr)	0.100	mg/L	0.042
Dissolved cobalt (Co)	0.050	mg/L	<0.003
Dissolved copper (Cu)	0.200	mg/L	<0.005
Dissolved lead (Pb)	0.050	mg/L	<0.010
Total mercury (Hg)	0.0006	mg/L	<0.0004
Dissolved nickel (Ni)	0.200	mg/L	<0.005
Total zinc (Zn)	0.500	mg/L	0.082
Oil & grease	5	mg/L	<2.0
PCBs	1.0	mg/L	<0.003
Phenols	-	-	N/A



Photo 10 (DSC01670) Sample 10-21327 Dye-M Collecting a sample from the LS NHWL - water pooled in the North east side of the new cell.

Waste water from the LS NHWL was discharged to the ground on August4, 2010, before results were received with permission from the Water Board.. All results were below criteria.

We trust that the information provided meets current requirements. Please contact the undersigned if you have any questions or concerns.

Sincerely,

A handwritten signature in black ink, appearing to read 'Casucci'.

Candice Casucci
Environmental Sciences Group

cc: Eva Schulz (UMA)
Daniela Loock, Kat White, Marc Ellemers, Megan Lord, Andrea Ellis (ESG)

APPENDIX A

LABORATORY RESULTS

ESG				ASG Login No:	20751
12 Verite Ave				Site:	Dye-M
Dept. of Chem. / Chem. Eng., RMC				Client No:	10-106
P.O. Box 17000, Stn. Forces				Samples Received:	12-Jul-10
Kingston, Ontario K7K 7B4				Date of analysis:	12-Jul-10
(613) 541-6000 ext 6567				Method No:	ASG 037
Fax: (613) 541-6596				Date Reported:	12-Jul-10
				Page:	1 of 1

RESULTS OF pH ANALYSIS

Sample I.D.	pH
21286*	5.52
21287	5.70
21288	5.78
21297	5.55

* Averaged result of duplicates

LABORATORY QA/QC

Sample I.D.	pH
21286* ; Duplicate	5.52 ; 5.52
Control	7.00
Control Target	7.00

ASU #	12886		Report ID:	Dye-M W18
Client:	ESG		Date Submitted:	12-Jul-10
			Date tested:	12-Jul-10
Site:	Dye-M		Date:	13-Jul-10
	10-106		Matrix:	water
Report of Analysis				
Sample	Oil & Grease			
	mg/L			
10-21286	3.7			
10-21287	<2.0			
10-21288	<2.0			
10-21297	5.2			
Blank	<2.0			
Control	14.0			
Control Target	15.9			

ESG					ASG Login No: 20751
12 Verite Ave					Site: Dye-M
Dept. of Chem. / Chem. Eng., RMC					Client No: 10-106
P.O. Box 17000, Stn. Forces					Samples Received: 12-Jul-10
Kingston, Ontario K7K 7B4					Date of analysis: 13-Jul-10
(613) 541-6000 ext 6567					Method No: ASG 021
Fax: (613) 541-6596					Date Reported: 13-Jul-10
					Sheet:

RESULTS OF MERCURY ANALYSIS

Sample ID	Mercury^ mg/L
21286*	< 0.0004
21287	< 0.0004
21288	< 0.0004
21297	0.0004

*Average result of duplicates.

^ Acid digestion performed.

Reported at 0.0004 mg/L detection limit.

LABORATORY QA/QC

Sample ID	Mercury^ mg/L
Duplicate ; 21286*	< 0.0004 ; < 0.0004
Blank	< 0.0004
Control Target	0.0040
Control Sample	0.0040

ASU #	12886		Report ID:	Dye-M W19				
Client:	ESG		Date Submitted:	12-Jul-10				
			Date tested:	13-Jul-10				
Site:	Dye-M		Date:	14-Jul-10				
	10-106		Matrix:	Water				
Report of Analysis								
Total Metals	Results in mg/L							
SAMPLE	Cu	Ni	Co	Cd	Pb	Zn	Cr	As
10-21286	-	-	-	-	-	<0.010	0.006	<0.003
10-21287	-	-	-	-	-	<0.010	<0.005	<0.003
10-21288	-	-	-	-	-	0.011	<0.005	<0.003
10-21297	-	-	-	-	-	<0.010	<0.005	<0.003
Blank	-	-	-	-	-	<0.010	<0.005	<0.003
Control	-	-	-	-	-	3.07	0.81	0.78
Control Target	-	-	-	-	-	3.00	0.80	0.80
10-21297	-	-	-	-	-	<0.010	<0.005	<0.003
10-21297	-	-	-	-	-	<0.010	<0.005	<0.003
Dissolved Metals	Results in mg/L							
SAMPLE	Cu	Ni	Co	Cd	Pb	Zn	Cr	As
10-21286	<0.005	<0.005	<0.003	<0.001	<0.010	-	-	-
10-21287	<0.005	<0.005	<0.003	<0.001	<0.010	-	-	-
10-21288	<0.005	<0.005	<0.003	<0.001	<0.010	-	-	-
10-21297	<0.005	<0.005	<0.003	<0.001	<0.010	-	-	-
Blank	<0.005	<0.005	<0.003	<0.001	<0.010	-	-	-
Control	1.58	1.62	1.61	0.80	7.96	-	-	-
Control Target	1.60	1.60	1.60	0.80	8.00	-	-	-
10-21297	<0.005	<0.005	<0.003	<0.001	<0.010	-	-	-
10-21297	<0.005	<0.005	<0.003	<0.001	<0.010	-	-	-

ESG					ASG Login No: 20751																														
12 Verite Ave					Site: Dye-M																														
Dept. of Chem. / Chem. Eng., RMC					Client No: 10-106																														
P.O. Box 17000, Stn. Forces					Samples Received: 12-Jul-10																														
Kingston, Ontario K7K 7B4					Date of analysis: 13-Jul-10																														
(613) 541-6000 ext 6567					Method No: ASG 006																														
Fax: (613) 541-6596					Date Reported: 14-Jul-10																														
					Sheet No: 1 of 1																														
RESULTS OF PCB IN WATER ANALYSIS																																			
<table><tr><th>Sample Type **</th><th>Sample I.D.</th><th>Unit</th><th>Aroclor 1254</th><th>Aroclor 1260</th></tr><tr><td>W</td><td>21286</td><td>mg/L</td><td>< 0.003</td><td>< 0.003</td></tr><tr><td>W</td><td>21287</td><td>mg/L</td><td>< 0.003</td><td>< 0.003</td></tr><tr><td>W</td><td>21288</td><td>mg/L</td><td>< 0.003</td><td>< 0.003</td></tr><tr><td>W</td><td>21297</td><td>mg/L</td><td>< 0.003</td><td>< 0.003</td></tr><tr><td></td><td></td><td></td><td></td><td></td></tr></table>						Sample Type **	Sample I.D.	Unit	Aroclor 1254	Aroclor 1260	W	21286	mg/L	< 0.003	< 0.003	W	21287	mg/L	< 0.003	< 0.003	W	21288	mg/L	< 0.003	< 0.003	W	21297	mg/L	< 0.003	< 0.003					
Sample Type **	Sample I.D.	Unit	Aroclor 1254	Aroclor 1260																															
W	21286	mg/L	< 0.003	< 0.003																															
W	21287	mg/L	< 0.003	< 0.003																															
W	21288	mg/L	< 0.003	< 0.003																															
W	21297	mg/L	< 0.003	< 0.003																															
* Average result of duplicate																																			
Report Values in PPM																																			
LABORATORY QA/QC																																			
<table><tr><td></td><td>Blank</td><td>mg/L</td><td>< 0.003</td><td>< 0.003</td></tr><tr><td></td><td>Control Sample</td><td>mg/L</td><td>< 0.003</td><td>0.018</td></tr><tr><td></td><td>Control Sample Target</td><td>mg/L</td><td>< 0.003</td><td>0.016</td></tr></table>							Blank	mg/L	< 0.003	< 0.003		Control Sample	mg/L	< 0.003	0.018		Control Sample Target	mg/L	< 0.003	0.016															
	Blank	mg/L	< 0.003	< 0.003																															
	Control Sample	mg/L	< 0.003	0.018																															
	Control Sample Target	mg/L	< 0.003	0.016																															
** S = Soil , C = Concrete , PC = Paint Chip , SW = Swab , P = Plant , W = Water																																			

ASU #	12914		Report ID:	Dye-M W20				
Client:	ESG		Date Submitted:	19-Jul-10				
			Date tested:	20-Jul-10				
Site:	Dye-M		Date:	20-Jul-10				
	10-131		Matrix:	Water				
Report of Analysis								
Total Metals	Results in mg/L							
SAMPLE	Cu	Ni	Co	Cd	Pb	Zn	Cr	As
10-21298	-	-	-	-	-	0.140	0.018	<0.003
10-21299	-	-	-	-	-	0.347	0.010	<0.003
Blank	-	-	-	-	-	<0.010	<0.005	<0.003
Control	-	-	-	-	-	3.09	0.83	0.78
Control Target	-	-	-	-	-	3.00	0.80	0.80
10-21299	-	-	-	-	-	0.349	0.011	<0.003
10-21299	-	-	-	-	-	0.344	0.010	<0.003
Dissolved Metals	Results in mg/L							
SAMPLE	Cu	Ni	Co	Cd	Pb	Zn	Cr	As
10-21298	<0.005	<0.005	<0.003	<0.001	<0.010	-	-	-
10-21299	<0.005	<0.005	<0.003	<0.001	<0.010	-	-	-
Blank	<0.005	<0.005	<0.003	<0.001	<0.010	-	-	-
Control	1.55	1.65	1.64	0.83	8.24	-	-	-
Control Target	1.60	1.60	1.60	0.80	8.00	-	-	-
10-21299	<0.005	<0.005	<0.003	<0.001	<0.010	-	-	-
10-21299	<0.005	<0.005	<0.003	<0.001	<0.010	-	-	-

ESG	ASG Login No: 20781
12 Verite Ave	Site: Dye-M
Dept. of Chem. / Chem. Eng., RMC	Client No: 10-131
P.O. Box 17000, Stn. Forces	Samples Received: 19-Jul-10
Kingston, Ontario K7K 7B4	Date of analysis: 20-Jul-10
(613) 541-6000 ext 6567	Method No: ASG 021
Fax: (613) 541-6596	Date Reported: 20-Jul-10
	Sheet: 1 of 1

RESULTS OF MERCURY IN WATER ANALYSIS

Sample ID	Mercury [^] mg/L
21298*	< 0.0004
21299	< 0.0004
21309	< 0.0004
21310	< 0.0004
21311	< 0.0004
21312	< 0.0004

*Average result of duplicates.

[^] Acid digestion performed.

Reported at 0.0004 mg/L detection limit.

LABORATORY QA/QC

Sample ID	Mercury [^] mg/L
Duplicate ; 21298*	< 0.0004 ; < 0.0004
Blank	< 0.0004
Control Target	0.0040
Control Sample	0.0040

ESG	ASG Login No: 20781
12 Verite Ave	Site: Dye-M
Dept. of Chem. / Chem. Eng., RMC	Client No: 10-131
P.O. Box 17000, Stn. Forces	Samples Received: 19-Jul-10
Kingston, Ontario K7K 7B4	Date of analysis: 20-Jul-10
(613) 541-6000 ext 6567	Method No: ASG 037
Fax: (613) 541-6596	Date Reported: 20-Jul-10
	Page: 1 of 1

RESULTS OF pH ANALYSIS

Sample I.D.	pH
21298*	5.77
21299	6.19
21309	5.93
21310	5.85
21311	5.84
21312	5.96

* Averaged result of duplicates

LABORATORY QA/QC

Sample I.D.	pH
21298* ; Duplicate	5.76 ; 5.78
Control	7.01
Control Target	7.00

ASU #	12914	Report ID:	Dye-M W21
Client:	ESG	Date Submitted:	19-Jul-10
		Date tested:	19-Jul-10
Site:	Dye-M	Date:	21-Jul-10
	10-131	Matrix:	water
Report of Analysis			
Sample	Oil & Grease		
	mg/L		
10-21298	114		
10-21299	29.7		
10-21309**	63200		
10-21310**	42300		
10-21311**	69000		
10-21312**	25200		
Blank	<2.0		
Control	14.4		
Control Target	15.9		
Results relate only to the items tested			
** samples had significant layer of free product on top, sample was treated as a whole and the water layer was not extracted for oil & grease.			

ESG					ASG Login No: 20781
12 Verite Ave					Site: Dye-M
Dept. of Chem. / Chem. Eng., RMC					Client No: 10-131
P.O. Box 17000, Stn. Forces					Samples Received: 19-Jul-10
Kingston, Ontario K7K 7B4					Date of analysis: 19-Jul-10
(613) 541-6000 ext 6567					Method No: ASG 015
Fax: (613) 541-6596					Date Reported: 21-Jul-10
					Sheet No: 1 of 1

RESULTS OF PCB IN WATER ANALYSIS

Sample Type **	Sample I.D.	Unit	Aroclor 1254	Aroclor 1260
W	21298*	mg/L	< 0.003	< 0.003
W	21299	mg/L	< 0.003	< 0.003
W	^21309	mg/L	< 0.003	< 0.003
W	^21310	mg/L	< 0.003	< 0.003
W	^21311	mg/L	< 0.003	< 0.003
W	^21312	mg/L	< 0.003	< 0.003

* Average result of duplicate
 Report Values in PPM
 ^ Sample recived with both aqueus and organic phases. Analysis performed on aqueus phase.

LABORATORY QA/QC

Blank	mg/L	< 0.003	< 0.003
Duplicate ; 21298*	mg/L	< 0.003 ; < 0.003	< 0.003 ; < 0.003
Control Sample	mg/L	< 0.003	0.015
Control Sample Target	mg/L	< 0.003	0.015

** S = Soil , C = Concrete , PC = Paint Chip , SW = Swab , P = Plant , W = Water

ASU #	12914	Report ID:	Dye-M W22					
Client:	ESG	Date Submitted:	19-Jul-10					
		Date tested:	23-Jul-10					
Site:	Dye-M	Date:	23-Jul-10					
	10-131	Matrix:	Water					
Report of Analysis								
Total Metals	Results in mg/L							
SAMPLE**	Cu	Ni	Co	Cd	Pb	Zn	Cr	As
10-21309	-	-	-	-	-	0.125	0.006	<0.003
10-21310	-	-	-	-	-	0.126	0.006	<0.003
10-21311	-	-	-	-	-	0.126	0.006	<0.003
10-21312	-	-	-	-	-	0.126	0.006	<0.003 *
Blank	-	-	-	-	-	<0.010	<0.005	<0.003
Control	-	-	-	-	-	2.97	0.84	0.76
Control Target	-	-	-	-	-	3.00	0.80	0.80
10-21312	-	-	-	-	-	0.126	0.006	<0.003
10-21312	-	-	-	-	-	0.126	0.006	<0.003
Dissolved Metals	Results in mg/L							
SAMPLE**	Cu	Ni	Co	Cd	Pb	Zn	Cr	As
10-21309	<0.005	<0.005	<0.003	<0.001	<0.010	-	-	-
10-21310	<0.005	<0.005	<0.003	<0.001	<0.010	-	-	-
10-21311	<0.005	<0.005	<0.003	<0.001	<0.010	-	-	-
10-21312	<0.005	<0.005	<0.003	0.004	<0.010	-	-	- *
Blank	<0.005	<0.005	<0.003	<0.001	<0.010	-	-	-
Control	1.46	1.64	1.64	0.80	8.16	-	-	-
Control Target	1.60	1.60	1.60	0.80	8.00	-	-	-
10-21312	<0.005	<0.005	<0.003	0.004	<0.010	-	-	-
10-21312	<0.005	<0.005	<0.003	0.004	<0.010	-	-	-

ESG

12 Verite Ave

Dept. of Chem. / Chem. Eng., RMC

P.O. Box 17000, Stn. Forces

Kingston, Ontario K7K 7B4

(613) 541-6000 ext 6567

Fax: (613) 541-6596

ASG Login No: 20863

Site: Dye-M

Client No: 10-218

Samples Received: 4-Aug-10

Date of analysis: 5-Aug-10

Method No: ASG 037

Date Reported: 5-Aug-10

Page: 1 of 1

RESULTS OF pH ANALYSIS

Sample I.D.	pH
21324*	7.30
21325	7.15
21326	7.10
21327	6.82

* Averaged result of duplicates

LABORATORY QA/QC

Sample I.D.	pH
21324* ; Duplicate	7.29 ;7.31
Control	7.01
Control Target	7.00

ASU #	12997	Report ID:	Dye-M W25
Client:	ESG	Date Submitted:	4-Aug-10
		Date tested:	4-Aug-10
Site:	Dye-M	Date:	5-Aug-10
	10-218	Matrix:	water
Report of Analysis			
Sample	Oil & Grease		
	mg/L		
10-21324	<2.0		
10-21325	<2.0		
10-21326	<2.0		
10-21327	<2.0		
Blank	<2.0		
Control	14.9		
Control Target	15.9		

ESG					ASG Login No: 20863
12 Verite Ave					Site: Dye-M
Dept. of Chem. / Chem. Eng., RMC					Client No: 10-218
P.O. Box 17000, Stn. Forces					Samples Received: 4-Aug-10
Kingston, Ontario K7K 7B4					Date of analysis: 5-Aug-10
(613) 541-6000 ext 6567					Method No: ASG 021
Fax: (613) 541-6596					Date Reported: 5-Aug-10
					Sheet: 1 of 1

RESULTS OF MERCURY IN WATER ANALYSIS

Sample ID	Mercury [^] mg/L
21234*	< 0.0004
21325	< 0.0004
21326	< 0.0004
21327	< 0.0004

*Average result of duplicates.

[^] Acid digestion performed.

Reported at 0.0004 mg/L detection limit.

LABORATORY QA/QC

Sample ID	Mercury [^] mg/L
Duplicate ; 21234*	< 0.0004 ; < 0.0004
Blank	< 0.0004
Control Target	0.0040
Control Sample	0.0039

ESG					ASG Login No: 20863
12 Verite Ave					Site: Dye-M
Dept. of Chem. / Chem. Eng., RMC					Client No: 10-218
P.O. Box 17000, Stn. Forces					Samples Received: 4-Aug-10
Kingston, Ontario K7K 7B4					Date of analysis: 4-Aug-10
(613) 541-6000 ext 6567					Method No: ASG 015
Fax: (613) 541-6596					Date Reported: 5-Aug-10
					Sheet No: 1 of 1

RESULTS OF PCB IN WATER ANALYSIS

Sample Type **	Sample I.D.	Unit	Aroclor 1254	Aroclor 1260
W	21324	mg/L	< 0.003	< 0.003
W	21325	mg/L	< 0.003	< 0.003
W	21326	mg/L	< 0.003	< 0.003
W	21327*	mg/L	< 0.003	< 0.003

* Average result of duplicate

Report Values in PPM

LABORATORY QA/QC

	Blank	mg/L	< 0.003	< 0.003
	Duplicate ; 21327*	mg/L	< 0.003 ; < 0.003	< 0.003 ; < 0.003
	Control Sample	mg/L	< 0.003	0.012
	Control Sample Target	mg/L	< 0.003	0.015

ASU #	12997		Report ID:	Dye-M W23				
Client:	ESG		Date Submitted:	4-Aug-10				
			Date tested:	6-Aug-10				
Site:	Dye-M		Date:	6-Aug-10				
	10-218		Matrix:	Water				
Report of Analysis								
Total Metals	Results in mg/L							
SAMPLE	Cu	Ni	Co	Cd	Pb	Zn	Cr	As
10-21324	-	-	-	-	-	0.706	0.011	<0.003
10-21325	-	-	-	-	-	0.035	0.017	<0.003
10-21326	-	-	-	-	-	0.075	0.085	0.004
10-21327	-	-	-	-	-	0.082	0.042	<0.003
Blank	-	-	-	-	-	<0.010	<0.005	<0.003
Control	-	-	-	-	-	2.89	0.78	0.74
Control Target	-	-	-	-	-	3.00	0.80	0.80
Dissolved Metals	Results in mg/L							
SAMPLE	Cu	Ni	Co	Cd	Pb	Zn	Cr	As
10-21324	<0.005	<0.005	<0.003	0.037	<0.010	-	-	-
10-21325	<0.005	<0.005	<0.003	0.002	<0.010	-	-	-
10-21326	<0.005	<0.005	<0.003	0.002	<0.010	-	-	-
10-21327	<0.005	<0.005	<0.003	<0.001	<0.010	-	-	-
Blank	<0.005	<0.005	<0.003	<0.001	<0.010	-	-	-
Control	1.42	1.56	1.54	0.77	7.76	-	-	-
Control Target	1.60	1.60	1.60	0.80	8.00	-	-	-

Candice Casucci
Environmental Sciences Group
The Royal Military College of Canada
PO Box 17000 Stn. Forces
Kingston, ON K7K 7B4



Tamara Van Dyck
Environmental Officer
Defence Construction Canada
DEW Line Cleanup PMO
350 Albert Street, Suite 1720
Ottawa ON K1A 0K3

Monday, March 21, 2011

August 2010 Monthly Report for Water Use License Number: IBR-DYE0914

The following results of the Monitoring Program (MP) and/or Water Use License are provided by the Environmental Sciences Group to meet the requirements of the above-noted license for *DYE-M (Cape Dyer)*.

1. SEWAGE EFFLUENT

A sewage lagoon was constructed at DYE-M in September of 2004. The Water Use License and MP require that samples from treated sewage lagoon effluent at the point of discharge to the receiving water be collected prior to each discharge event.

One sewage lagoon sample was collected and analyzed from DYE-M in August, 2010 (See table). Laboratory results are provided in Appendix A.

LOCATION: SEWAGE LAGOON - NEW CELL

GPS COORDINATES: 563352 7386915

SAMPLE: 10-21328

DATE: AUGUST 3, 2010

Parameter	Allowable Maximum Average Concentration	Units	Sample# 10-21328
pH	6.0 to 9.0	pH units	9.76
Oil & Grease	None Visible	-	None Visible
Total Suspended Solids (TSS)	180	mg/L	60
BOD	120	mg/L	35
Faecal Coliforms	100,000	CFU/100 mL	500
Total Coliforms	-	CFU/ 100 mL	13,000



Photo 1 (DSC17525) Sample 10-21328 Dye-M Collecting a sample from the new cell of the sewage lagoon.

Sample 10-21328 was above the pH range and was not discharged to land in 2010. Additional sampling will be required in 2011.

We trust that the information provided meets current requirements. Please contact the undersigned if you have any questions or concerns.

Sincerely,

A handwritten signature in black ink, appearing to read "Casucci".

Candice Casucci
Environmental Sciences Group

cc: Eva Schulz (UMA)
Daniela Looke, Kat White, Marc Ellemers, Andrea Ellis, Megan Lord (ESG)

APPENDIX A LABORATORY RESULTS

ESG				ASG Login No: 20862
12 Verite Ave				Site: DYE-M
Dept. of Chem. / Chem. Eng., RMC				Client No: 10-219
P.O. Box 17000, Stn. Forces				Samples Received: 4-Aug-10
Kingston, Ontario K7K 7B4				Date of analysis: 4-Aug-10
(613) 541-6000 ext 6567				Date Reported: 5-Aug-10
Fax: (613) 541-6596				Sheet: 1 of 1

RESULTS OF MICROBIOLOGICAL ANALYSIS

Sample Identification	Method: ASG 036 Total Coliforms (CFU/100 mL)	Method: ASG 036 E. coli (CFU/100 mL)	Method: ASG 036 Background (CFU/100 mL)	Method: ASG 044 Fecal Coliforms (CFU/100 mL)
21328*	13 000	100	9 000	500

LABORATORY QA/QC

Sample Identification	Method: ASG 036 Total Coliforms (CFU/100 mL)	Method: ASG 036 E. coli (CFU/100 mL)	Method: ASG 036 Background (CFU/100 mL)	Method: ASG 044 Fecal Coliforms (CFU/100 mL)
Blank	0	0	0	0
Control Sample	34	34	0	35
Control Sample Target	34	34	0	34

ESG				ASG Login No: 20862
12 Verite Ave				Site: Dye-M
Dept. of Chem. / Chem. Eng., RMC				Client No: 10-219
P.O. Box 17000, Stn. Forces				Samples Received: 4-Aug-10
Kingston, Ontario K7K 7B4				Date of analysis: 5-Aug-10
(613) 541-6000 ext 6567				Method No: ASG 037
Fax: (613) 541-6596				Date Reported: 5-Aug-10
				Page: 1 of 1

RESULTS OF pH ANALYSIS

Sample I.D.	pH
21328*	9.76

* Averaged result of duplicates

LABORATORY QA/QC

Sample I.D.	pH
Control	7.01
Control Target	7.00

ESG	ASG Login No: 20862
12 Verite Ave	Site: Dye-M
Dept. of Chem. / Chem. Eng., RMC	Client Login No: 10-219
P.O. Box 17000, Stn. Forces	Samples Received: 4-Aug-10
Kingston, Ontario K7K 7B4	Date of analysis: 6-Aug-10
(613) 541-6000 ext 6567	Method No: ASG 039
Fax: (613) 541-6596	Date Reported: 6-Aug-10
	Sheet: 1 of 1

RESULTS OF TOTAL SUSPENDED SOLIDS ANALYSIS

Sample I.D.	Sample Type ^	Unit	Total Suspended Solids
21328*	SE	mg/L	60

LABORATORY QA/QC

Duplicate ; 21328*	SE ; SE	mg/L	59 ; 61
Control	Control	mg/L	190
Control Target	Control	mg/L	200
Blank	Control	mg/L	< 1

^SW =Surface Water, SI = Sewage Influent SE = Sewage Effluent

* Averaged result of duplicates

ESG	ASG Login No: 20862
12 Verite Ave	Site: Dye-M
Dept. of Chem. / Chem. Eng., RMC	Client Login No: 10-219
P.O. Box 17000, Stn. Forces	Samples Received: 4-Aug-10
Kingston, Ontario K7K 7B4	Date of analysis: 9-Aug-10
(613) 541-6000 ext 6567	Method No: ASG 042
Fax: (613) 541-6596	Date Reported: 9-Aug-10
	Page: 1 of 1

RESULTS OF BOD ANALYSIS

Sample I.D.	Unit	BOD
21328*	mg/L	35

*Averaged result of duplicates

LABORATORY QA/QC

Sample I.D.	Unit	BOD
Duplicate ; 21328*	mg/L	34 ; 36
Blank	mg/L	< 3
Control	mg/L	160
Control Target	mg/L	165

Candice Casucci
Environmental Sciences Group
The Royal Military College of Canada
PO Box 17000 Stn. Forces
Kingston, ON K7K 7B4



Tamara Van Dyck
Environmental Officer
Defence Construction Canada
DEW Line Cleanup PMO
101 Colonel By Drive
Ottawa ON K1A 0K2

Monday, March 21, 2011

RE: Analytical Results for Wastewater Samples Collected at DYE-M in August 2010

The following report summarizes results of the analysis of wastewater samples as per the DYE-M (Cape Dyer) DEW Line Cleanup Project (DLCU) Specifications.

The DYE-M specifications require that “wash water, melt water collection, rinse water resulting from the cleaning of fuel tanks and pipelines, and/or any other liquid effluent stream” meet the following guidelines prior to their discharge to land (01560.4.1):

Parameter	Maximum Allowable Concentration	Units
pH	6-9	pH units
Total arsenic (As)	0.100	mg/L
Dissolved cadmium (Cd)	0.010	mg/L
Dissolved chromium (Cr)	0.100	mg/L
Dissolved cobalt (Co)	0.050	mg/L
Dissolved copper (Cu)	0.200	mg/L
Dissolved lead (Pb)	0.050	mg/L
Total mercury (Hg)	0.0006	mg/L
Dissolved nickel (Ni)	0.200	mg/L
Total zinc (Zn)	0.500	mg/L
Oil & grease	5	mg/L
PCBs	1.0	mg/L
Phenols	-	-

Phenols

The wastewater samples collected by ESG at DYE-M in August, 2010 were not analyzed for phenols but they were analyzed for oil and grease. Research conducted by ESG¹ has determined that a) no federal, territorial or provincial criteria exist for the discharge of wastewater containing phenols to land at a minimum distance of 30-m from natural drainage courses b) the maximum concentration of phenols in DLCU wastewater to date

¹ Environmental Sciences Group. *DEW Line Clean Up Project – Phenols in Wastewater*. June, 2007.

(2.44 mg/L) is below the LC₅₀ for freshwater fish and crustaceans and below the oral and dermal LD₅₀s for rats and rodents and c) phenols in excess of the maximum allowable concentration (MAC) have historically co-occurred with a visible oil & grease sheen and/or with an exceedance of the MAC for oil & grease. This information, and a subsequent decision to not test for phenols, has been presented to the NWB. To date, verbal agreement from the NWB has been received, but the project is awaiting written confirmation of the decision to suspend testing for phenols.

WASTEWATER SAMPLES

One wastewater sample was collected at DYE-M and analyzed in August 2010. A summary of the details of the results follows. Laboratory results provided in Appendix A.

LOCATION: LS TANK FARM AREA – METAL CONTAINER FULL OF WASTEWATER
GPS COORDINATES: 562937 7387449
SAMPLE: 10-21336
DATE: AUGUST 3, 2010

Parameter	Maximum Allowable Concentration	Units	Sample # 10-21336
pH	6-9	pH units	6.86
Total arsenic (As)	0.100	mg/L	<0.003
Dissolved cadmium (Cd)	0.010	mg/L	0.002
Dissolved chromium (Cr)	0.100	mg/L	<0.005
Dissolved cobalt (Co)	0.050	mg/L	<0.003
Dissolved copper (Cu)	0.200	mg/L	<0.005
Dissolved lead (Pb)	0.050	mg/L	<0.010
Total mercury (Hg)	0.0006	mg/L	<0.0004
Dissolved nickel (Ni)	0.200	mg/L	<0.005
Total zinc (Zn)	0.500	mg/L	0.176
Oil & grease	5	mg/L	29.4
PCBs	1.0	mg/L	<0.003
Phenols	-	-	N/A



Photo 1 (DSC01722) Sample 10-21336 Dye –M Collecting a sample from a metal container containing wastewater at the tank-farm.

Sample 10-21336 was over criteria for Oil and Grease and was not discharged to ground in 2010.

We trust that the information provided meets current requirements. Please contact the undersigned if you have any questions or concerns.

Sincerely,

A handwritten signature in black ink, appearing to read 'Casucci'.

Candice Casucci
Environmental Sciences Group

cc: Eva Schulz (UMA)
Daniela Loock, Kat White, Marc Ellemers, Megan Lord, Andrea Ellis (ESG)

APPENDIX A

LABORATORY RESULTS

ASU #	12999		Report ID:	Dye-M W26
Client:	ESG		Date Submitted:	4-Aug-10
			Date tested:	4-Aug-10
Site:	Dye-M		Date:	5-Aug-10
	10-221		Matrix:	water
Report of Analysis				
Sample	Oil & Grease			
	mg/L			
10-21336**	29.4			
Blank	<2.0			
Control	14.9			
Control Target	15.9			
Results relate only to the items tested				
** some sample lost due to bottle cracking and leaking during analysis				

ESG					ASG Login No:	20864
12 Verite Ave					Site:	Dye-M
Dept. of Chem. / Chem. Eng., RMC					Client No:	10-221
P.O. Box 17000, Stn. Forces					Samples Received:	4-Aug-10
Kingston, Ontario K7K 7B4					Date of analysis:	5-Aug-10
(613) 541-6000 ext 6567					Method No:	ASG 021
Fax: (613) 541-6596					Date Reported:	5-Aug-10
					Sheet:	1 of 1

RESULTS OF MERCURY IN WATER ANALYSIS

Sample ID	Mercury [^] mg/L
21336*	< 0.0004

*Average result of duplicates.
[^] Acid digestion performed.
Reported at 0.0004 mg/L detection limit.

ESG				ASG Login No: 20864
12 Verite Ave				Site: Dye-M
Dept. of Chem. / Chem. Eng., RMC				Client No: 10-221
P.O. Box 17000, Stn. Forces				Samples Received: 4-Aug-10
Kingston, Ontario K7K 7B4				Date of analysis: 5-Aug-10
(613) 541-6000 ext 6567				Method No: ASG 037
Fax: (613) 541-6596				Date Reported: 6-Aug-10
				Page: 1 of 1

RESULTS OF pH ANALYSIS

Sample I.D.	pH
21336	6.86

* Averaged result of duplicates

LABORATORY QA/QC

Sample I.D.	pH
Control	7.01
Control Target	7.00

PHOTOGRAPHIC LOG



Site Name:
DYE-M, Cape Dyer

Site Location:
Nunavut

Project No.
60153669

Photo No.
1

Date:
2010

Direction Photo Taken:

Description:

View of Beach Area including Temporary Storage Area and Debris Area 4.



Photo No.
2

Date:
2010

Direction Photo Taken:

Description:

View of Lower Site Station Area and Debris Area 5.



PHOTOGRAPHIC LOG



Site Name:
DYE-M, Cape Dyer

Site Location:
Nunavut

Project No.
60153669

Photo No.
3

Date:
2010

Direction Photo Taken:

Description:

Garage and Heated
Vehicle Storage Area
Contaminated Soil
Areas



Photo No.
4

Date:
2010

Direction Photo Taken:

Description:

Contaminated Soil Area
near Garage



PHOTOGRAPHIC LOG



Site Name:
DYE-M, Cape Dyer

Site Location:
Nunavut

Project No.
60153669

Photo No.
5

Date:
2010

Direction Photo Taken:

Description:
Overview of DEW Drop Area Containing Several Contaminated Soil Areas



Photo No.
6

Date:
2010

Direction Photo Taken:

Description:
Lower Site Non-Hazardous Waste Landfill Looking North from West Berm



PHOTOGRAPHIC LOG

Site Name: DYE-M, Cape Dyer	Site Location: Nunavut	Project No. 60153669
---------------------------------------	----------------------------------	--------------------------------

Photo No. 7	Date: 2010	
Direction Photo Taken:		
Description: Lower Site Tier II Disposal Facility		

Photo No. 8	Date: 2010	
Direction Photo Taken:		
Description: Looking South over Landfarm.		

PHOTOGRAPHIC LOG



Site Name: DYE-M, Cape Dyer		Site Location: Nunavut	Project No. 60153669
Photo No. 9	Date: 2010		
Direction Photo Taken:			
Description: Upper Site Non-Hazardous Waste Landfill Looking Southwest from Northeast Corner.			
Photo No. 10	Date: 2010		
Direction Photo Taken:			
Description: Upper Site Tier II Disposal Facility View of Access Ramp			

PHOTOGRAPHIC LOG



Site Name:
DYE-M, Cape Dyer

Site Location:
Nunavut

Project No.
60153669

Photo No.
11

Date:
2010

Direction Photo Taken:

Description:
Temporary Storage Area, Beach Site



Photo No.
12

Date:
2010

Direction Photo Taken:

Description:

Lower Site, PCB Storage Area

