APPENDIX 5

ENNADAI LAKE REMEDIATION PROJECT

MAPS AND DRAWINGS



Figure 1 Ennadai Lake showing nearby communities



Figure 2 – Ennadai Lake Showing IOL and Proposed Camp Location.



Figure 3 – Showing approximate work area with water intake location from Ennadai Lake.



Figure 4 – Ennadai Lake proposed Landfarm location.



Figure 5 – Ennadai Lake proposed Landfill location.



Figure 6 – Ennadai Lake proposed Airstrip location, including proposed site layout.

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REMEDIATION PROJECT

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Sheet No.		TITLE				
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R.048071.015	C02	GENERAL SITE PLAN				
R.048071.015	C03	SITE PLAN SHOWING SITE ACCESS				
R.048071.015	C04	SITE PLAN APEC 2, 3, 4, 5, 6, 8, 29				
R.048071.015	C05	SITE PLAN APEC 2, 5, 8, 29				
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R.048071.015	C14	AREAS OF CULTURAL SIGNIFICANCE AS IDENTIFIED BY ARVIAT COMMUNITY MEMBERS				




ENNADALAKE


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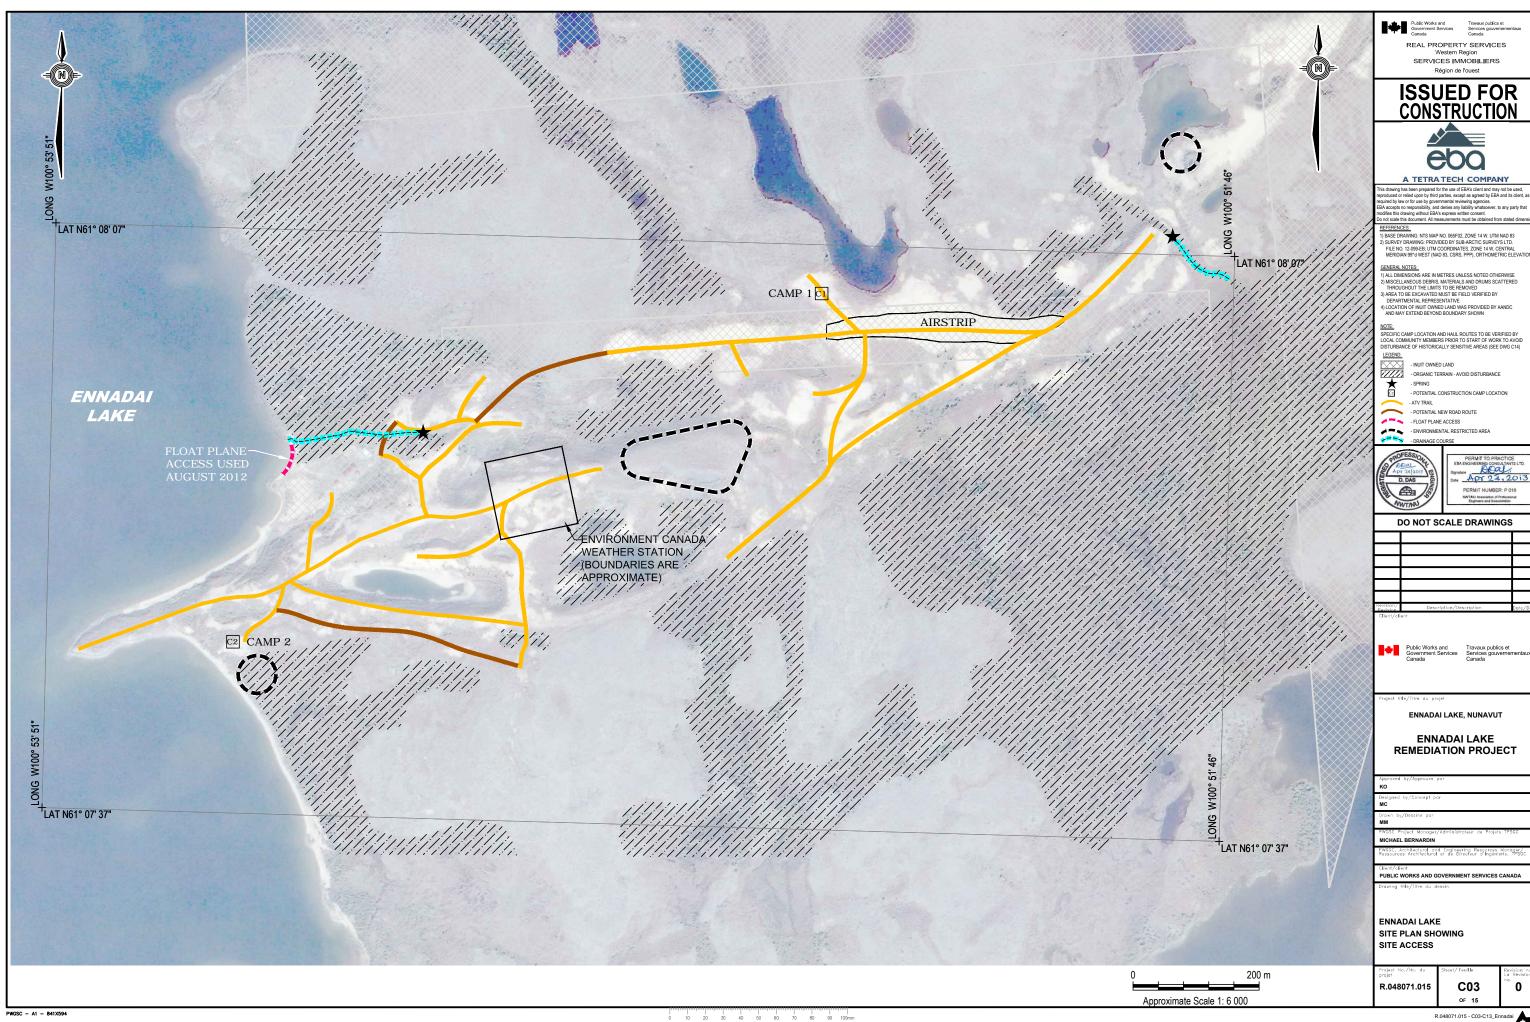
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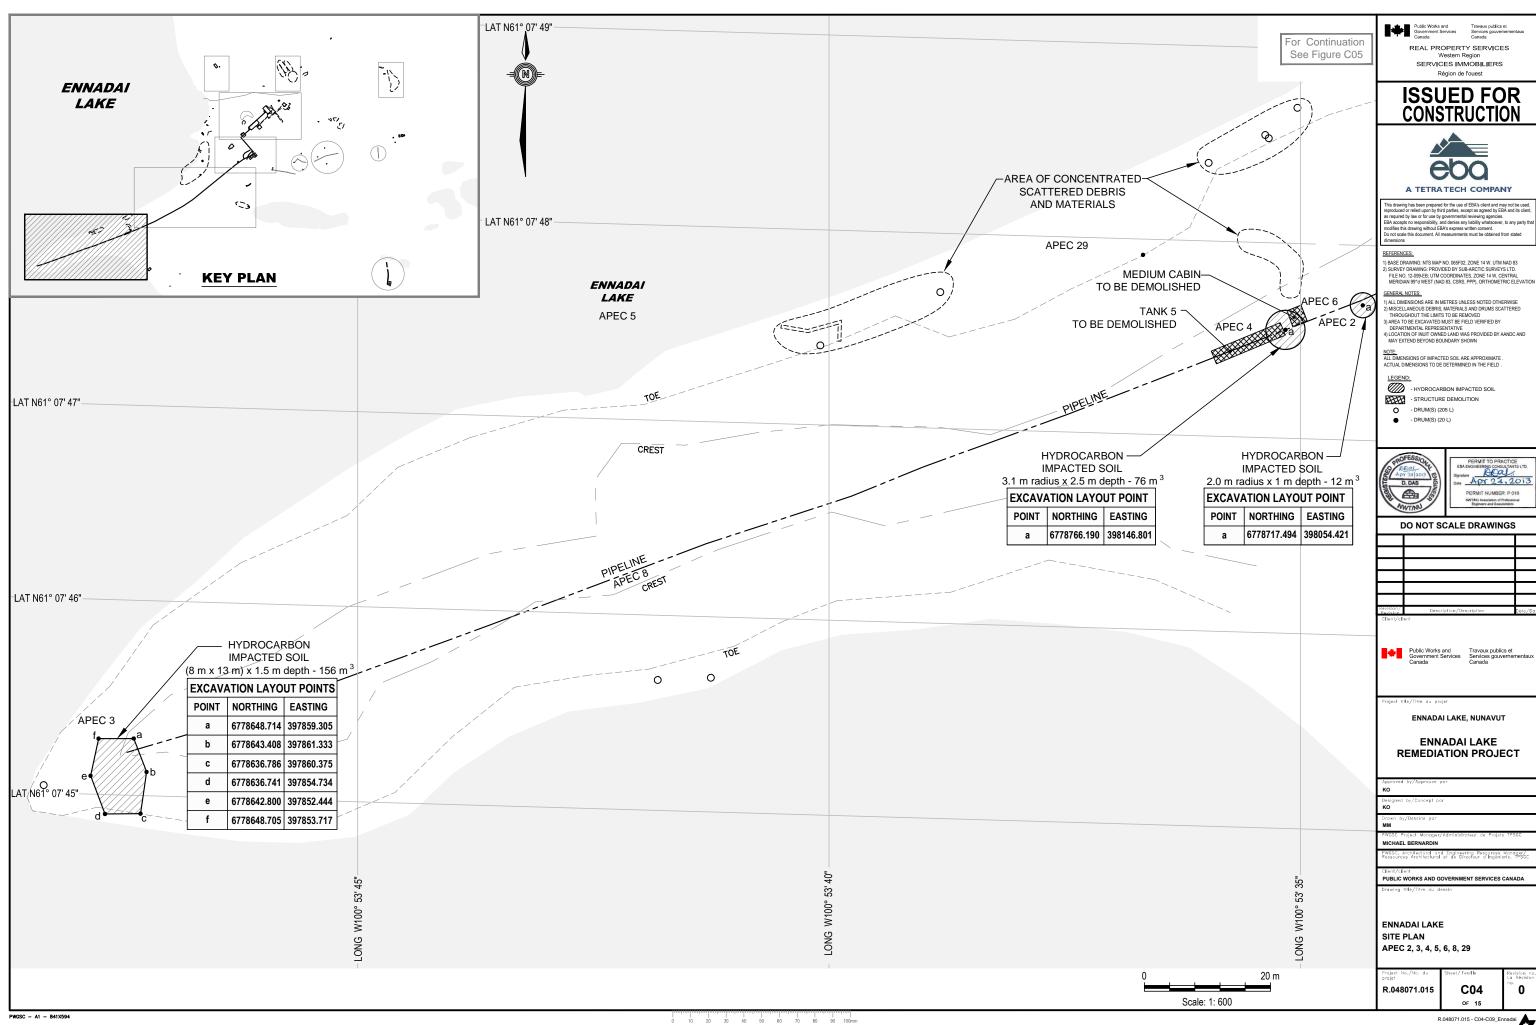
APRIL 2013










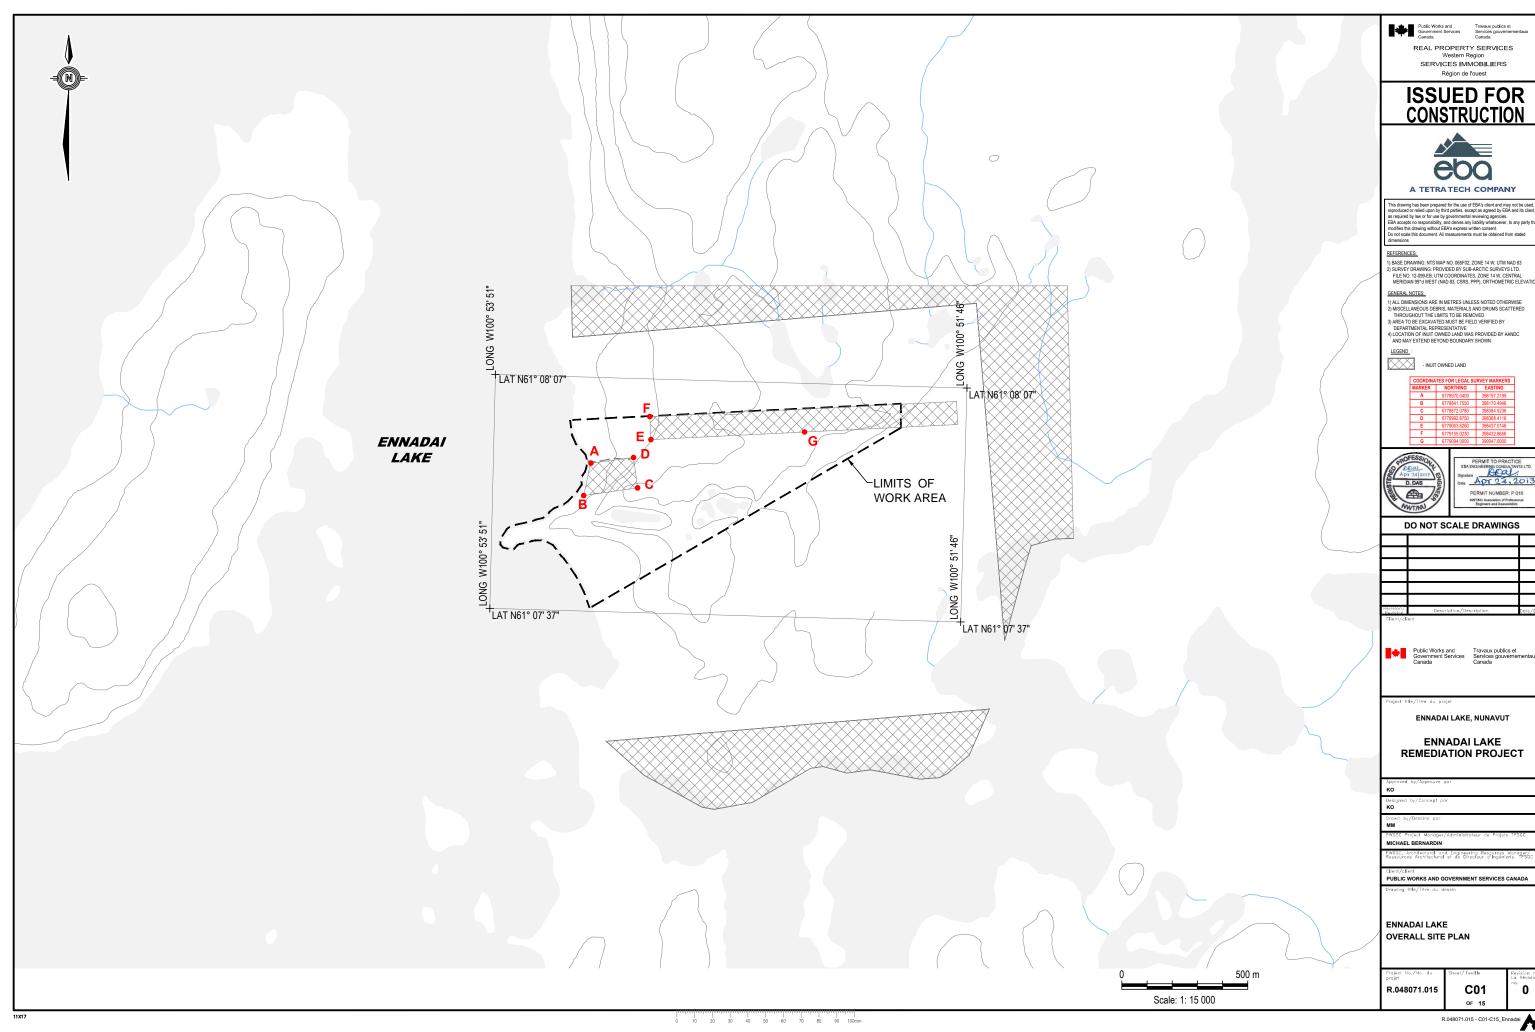


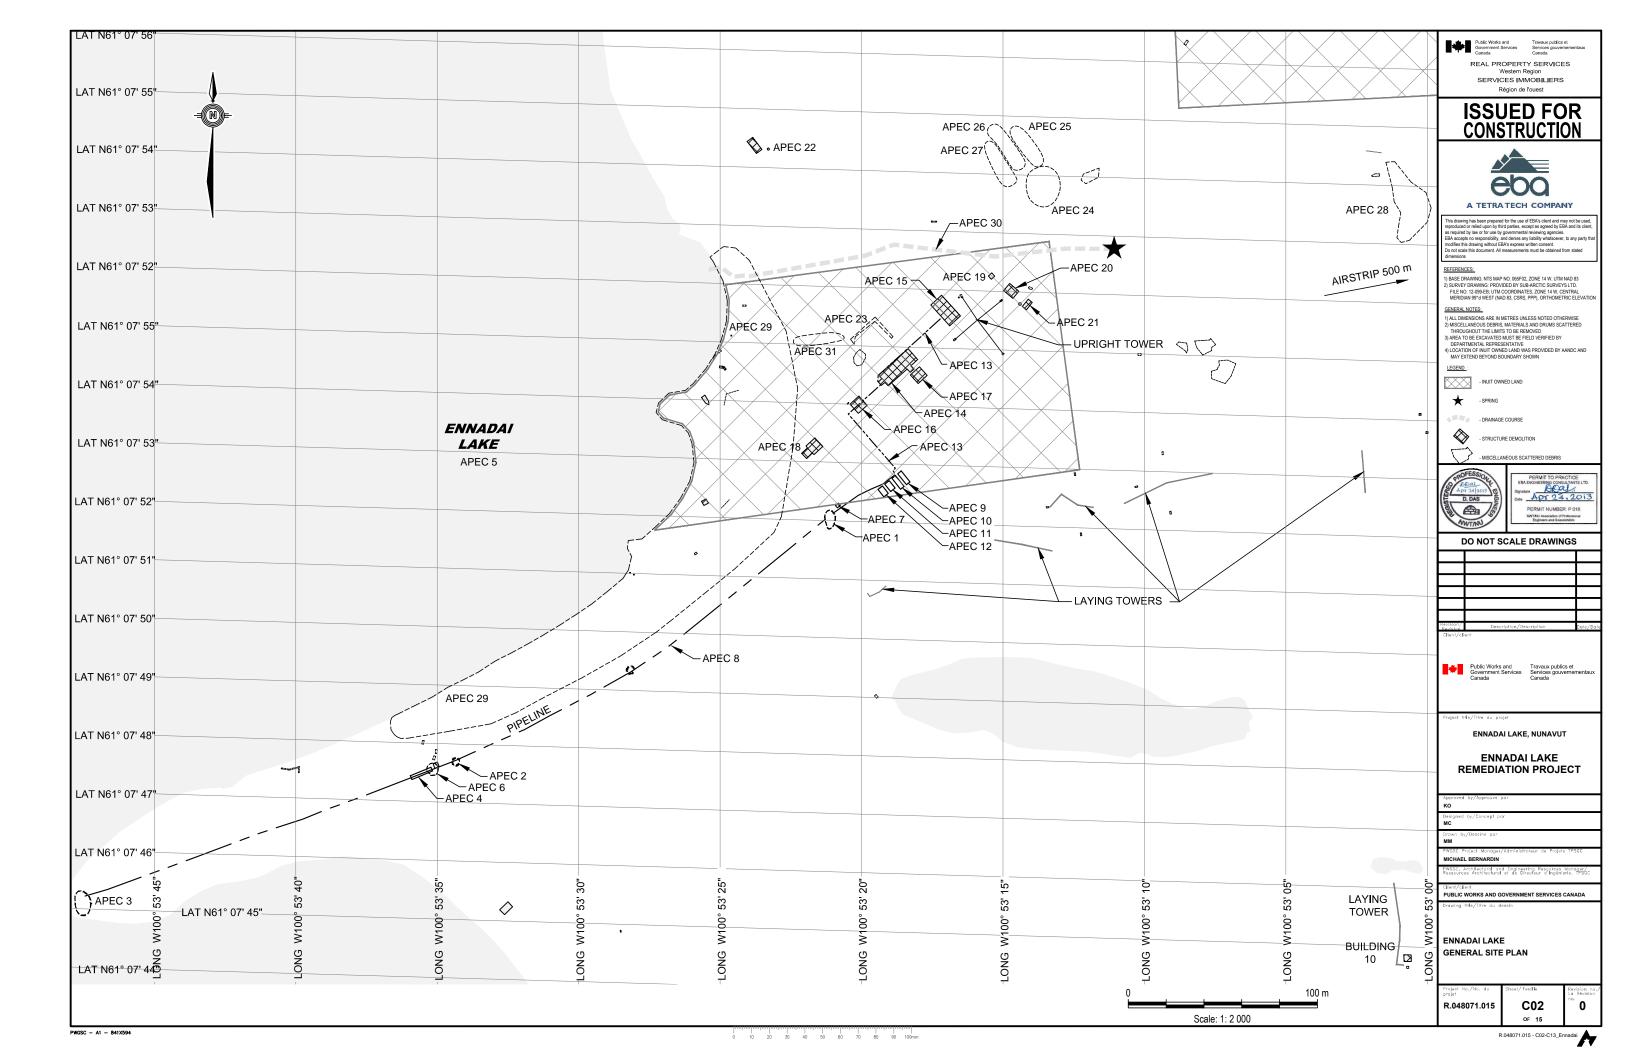


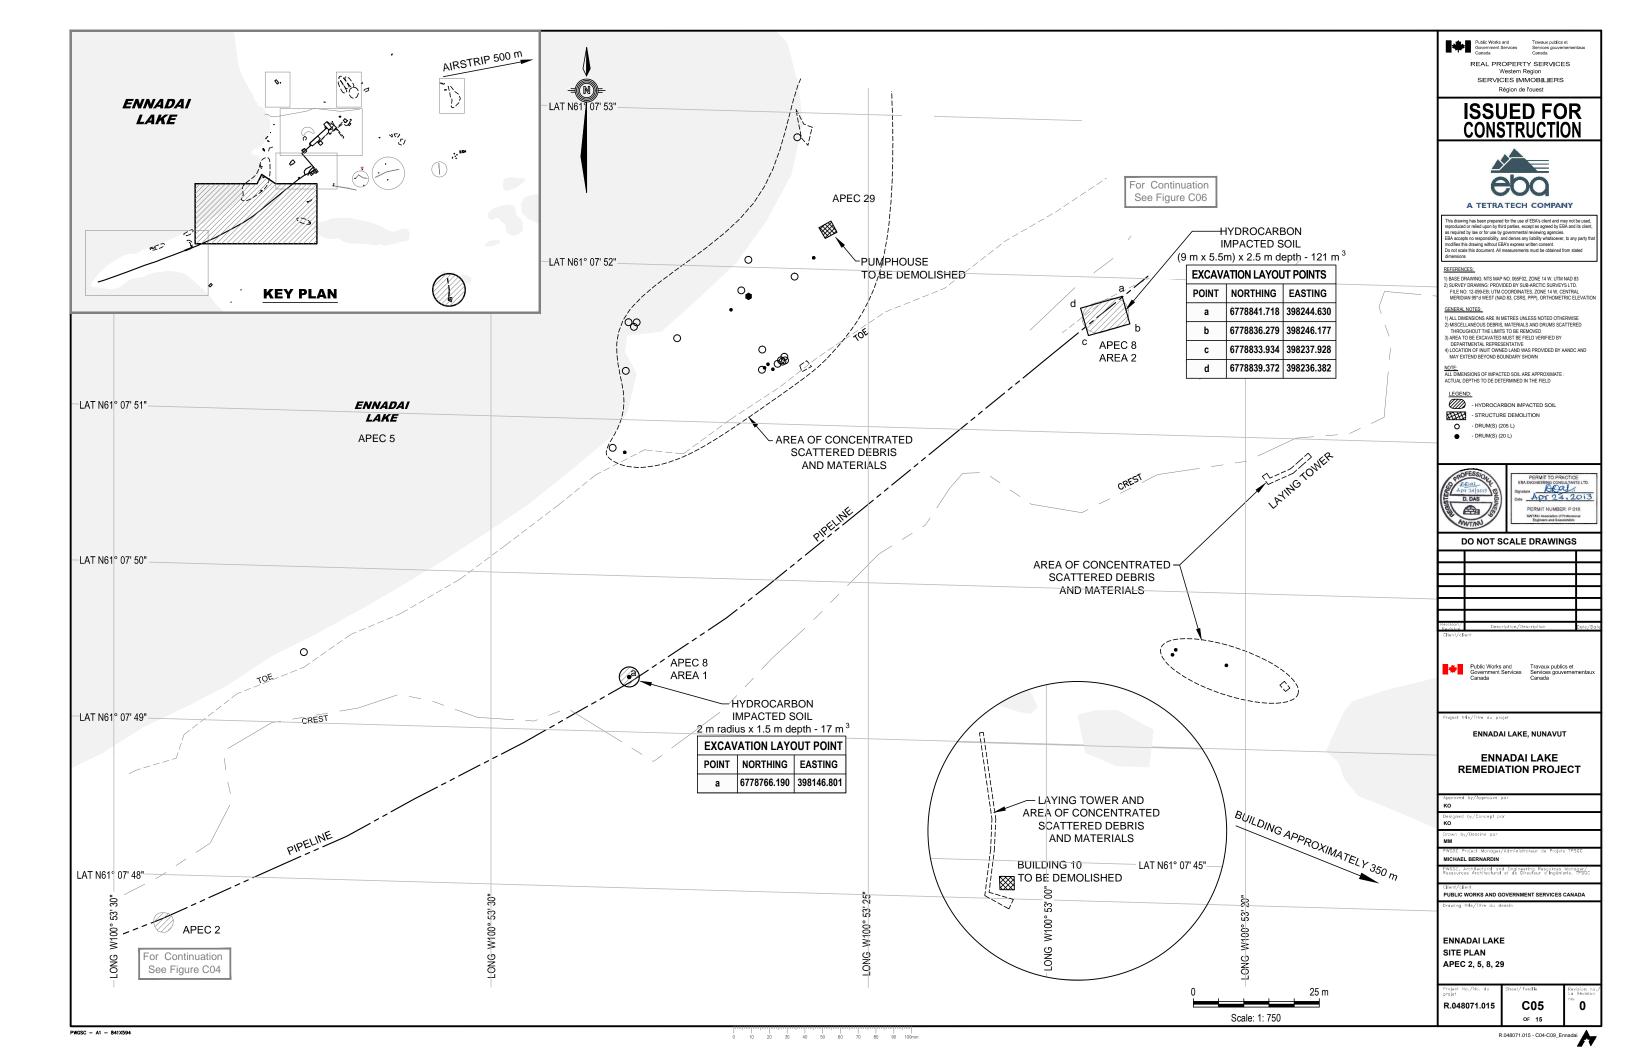


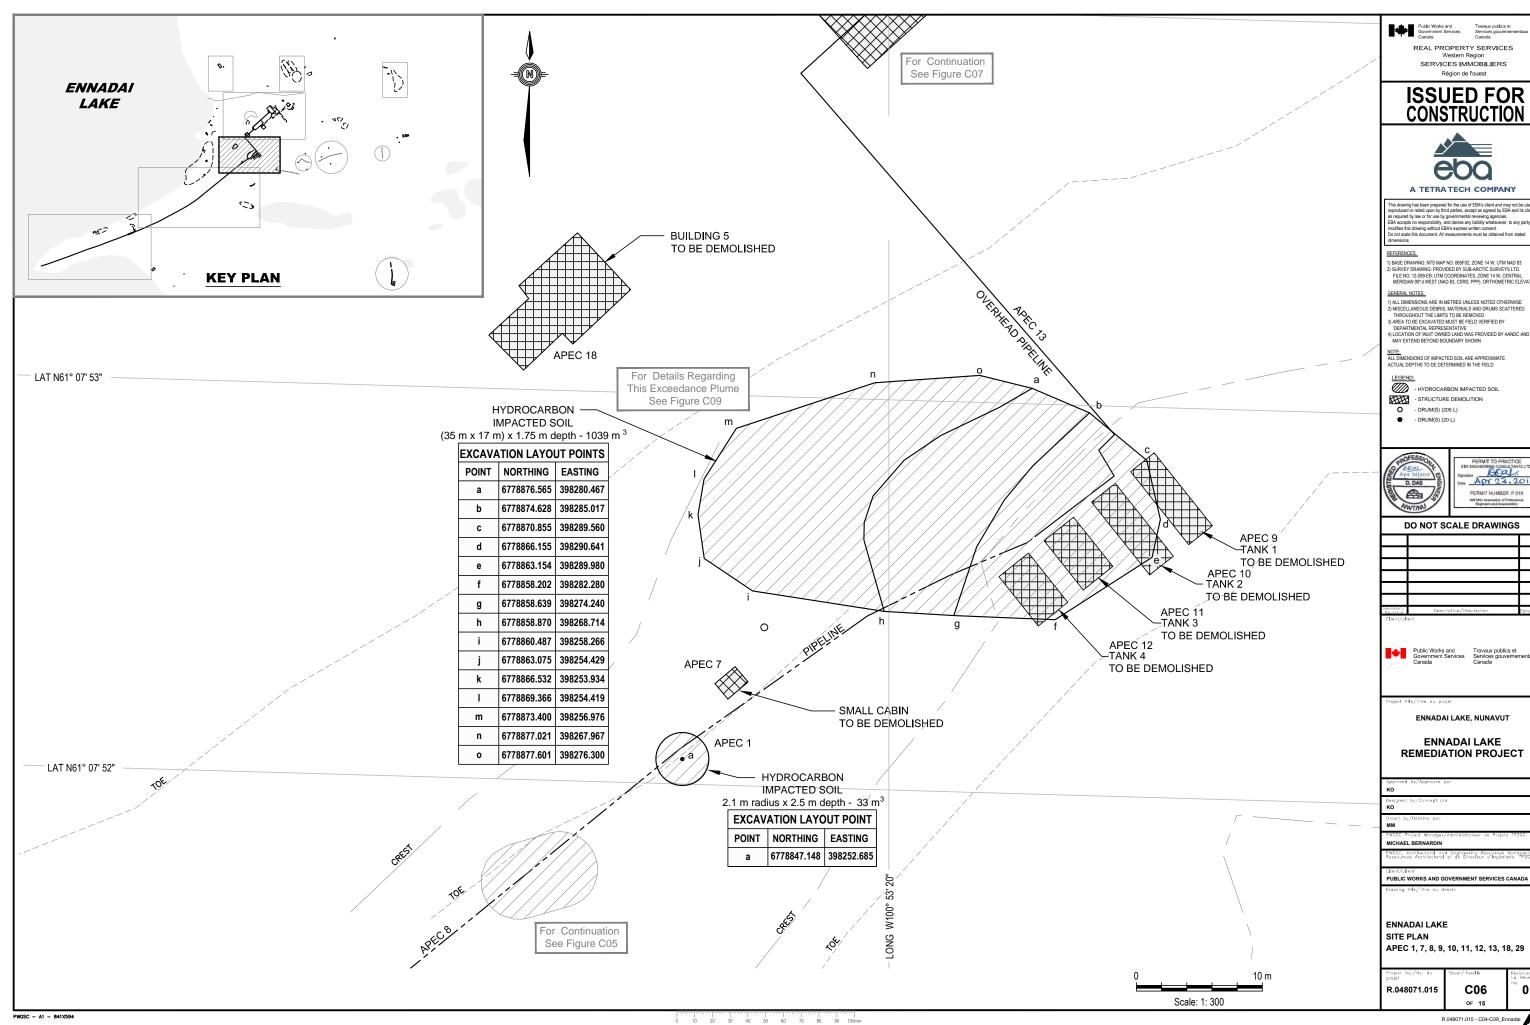

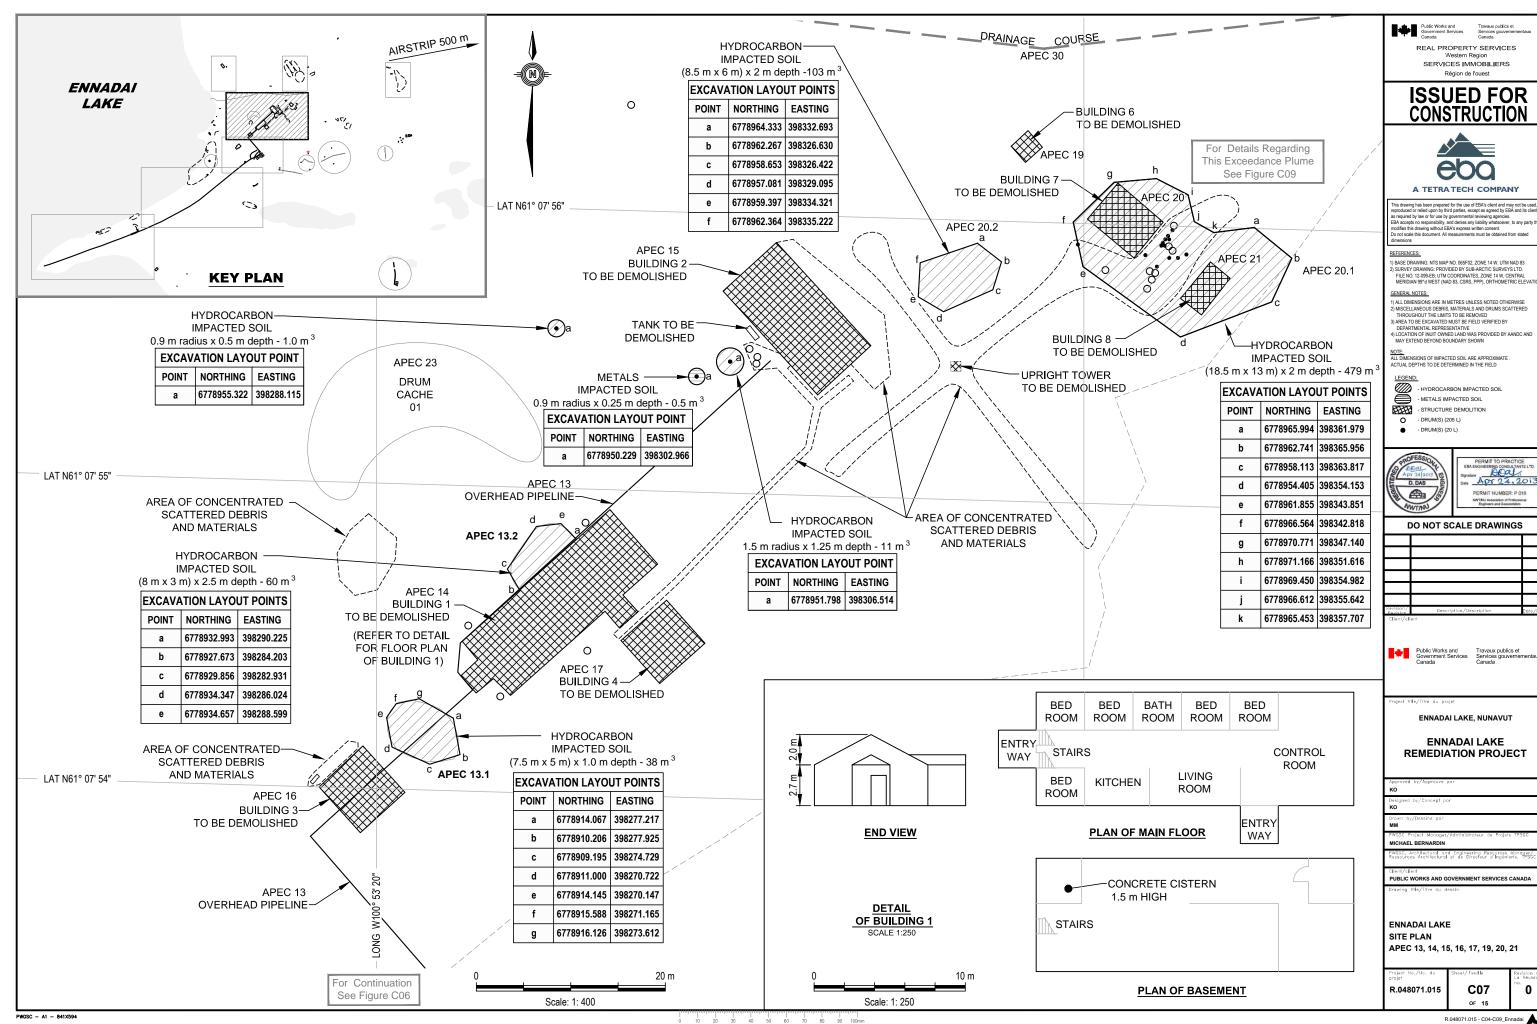

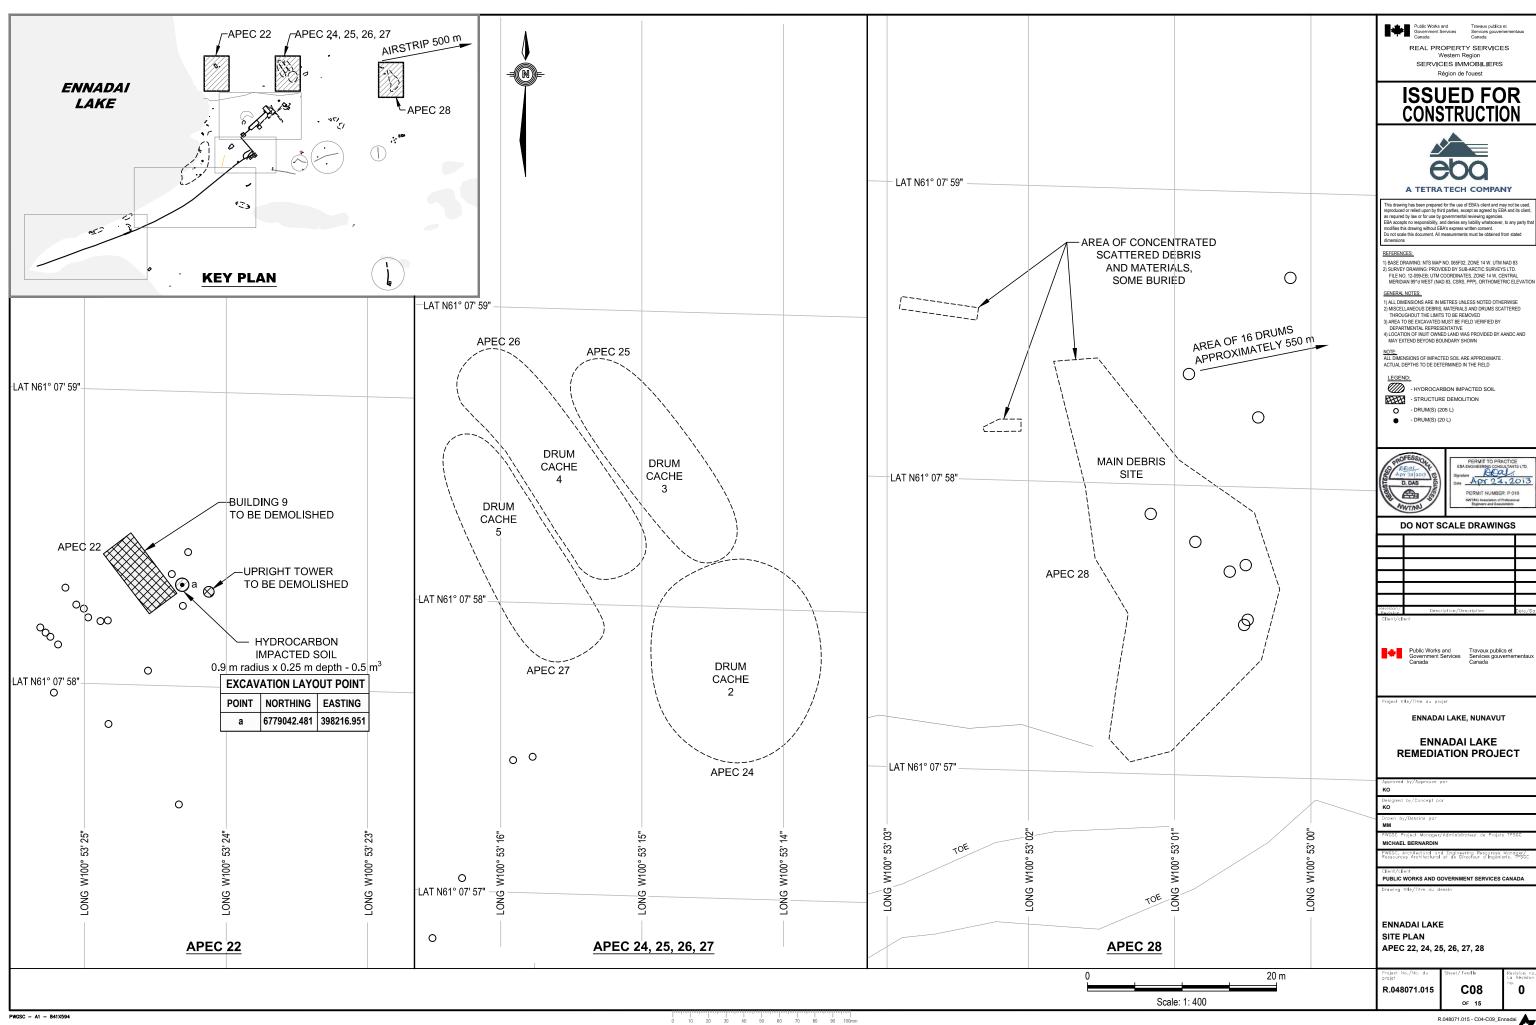

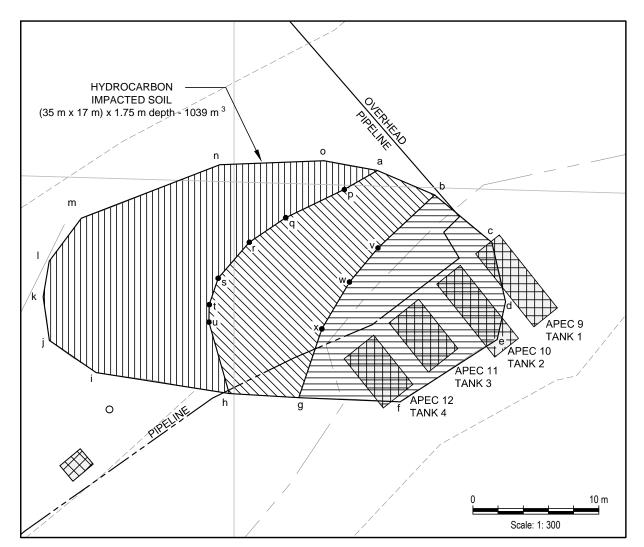

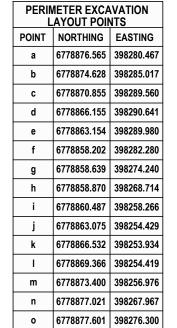

DETAIL OF IMPACTED SOIL AREAS FOR APEC 9, 10, 11, 12

Refer to Figure C06 for Location

-CONTAMINATED SOIL 0 - 2.5 m bgl

-CONTAMINATED SOIL 0.5 - 2.5 m bgl

AREA 3

-CONTAMINATED SOIL 1.0 - 2.5 m bgl

INTERIOR EXCAVATION LAYOUT POINTS							
POINT	NORTHING	EASTING					
р	6778875.061	398277.851					
q	6778872.822	398273.247					
r	6778870.920	398270.304					
S	6778868.015	398267.833					
t	6778865.918	398267.127					
u	6778864.583	398267.102					
٧	6778870.420	398280.519					
w	6778867.714	398278.257					
х	6778863.993	398276.061					

XCA\ POII	/ATION NTS		PERIMETER EXCAVATION LAYOUT POINTS				
HING	EASTING		POINT	NORTHING	EASTING		
5.061	398277.851		а	6778965.994	398361.979		
2.822	398273.247		b	6778962.741	398365.956		
0.920	398270.304		С	6778958.113	398363.817		
8.015	398267.833		d	6778954.405	398354.153		
5.918	398267.127		е	6778961.855	398343.851		
4.583	398267.102		f	6778966.564	398342.818		
0.420	398280.519		g	6778970.771	398347.140		
7.714	398278.257		h	6778971.166	398351.616		
3.993	398276.061		i	6778969.450	398354.982		
		•	j	6778966.612	398355.642		

DETAIL OF IMPACTED SOIL AREAS FOR APEC 20, 21

APEC 20.1

Refer to Figure C07 for Location

-CONTAMINATED SOIL 0 - 2.5 m bgl AREA 2
-CONTAMINATED SOIL 0.5 - 2.5 m bgl

LAYOUT POINTS							
POINT	NORTHING	EASTING					
I	6778964.143	398355.329					
m	6778962.816	398356.233					
n	6778961.198	398356.229					
0	6778959.917	398355.504					
р	6778959.122	398354.176					
q	6778959.098	398352.629					
r	6778960.638	398349.944					
S	6778961.905	398349.195					
t	6778963.452	398349.171					
u	6778964.804	398349.924					
٧	6778965.599	398351.252					
w	6778965.499	398352.824					

Scale: 1: 150

AREA 1 EXCAVATION

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NOTE: REFER TO FIGURES C06 & C07 FOR LOCATIONS OF THE IMPACTED SOIL




- STRUCTURE DEMOLITION

- DRUM(S) (20 L)



PERMIT NUMBER: P 018

DO NOT SCALE DRAWINGS

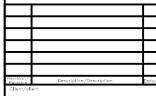

ENNADAI LAKE, NUNAVUT

ENNADAI LAKE REMEDIATION PROJECT

PUBLIC WORKS AND GOVERNMENT SERVICES CANADA


ENNADAI LAKE DETAIL OF IMPACTED SOIL AREAS APEC 9, 10, 11, 12, 20, 21


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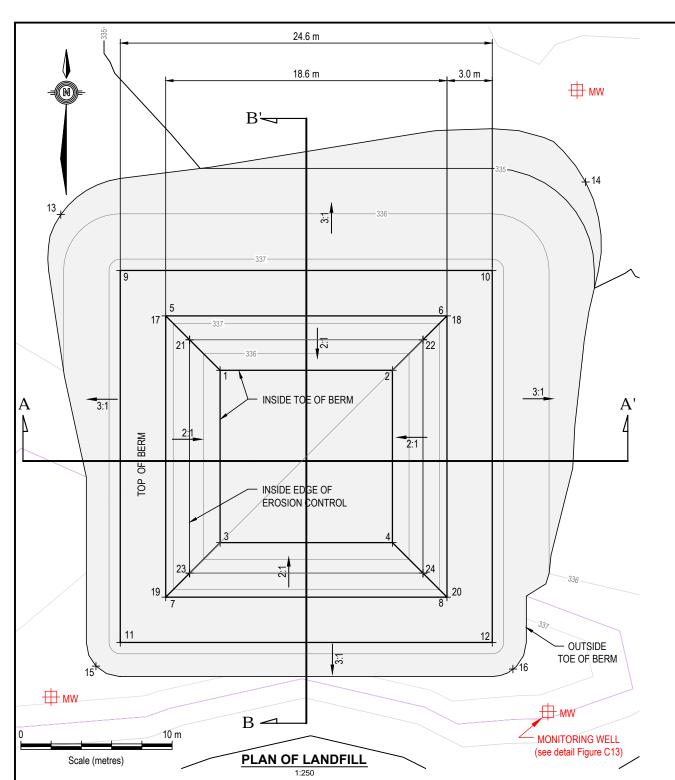
C09

0 10 20 30 40 50 60 70 80 90 100mm


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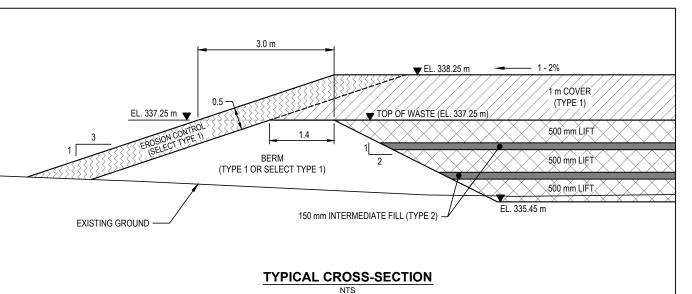


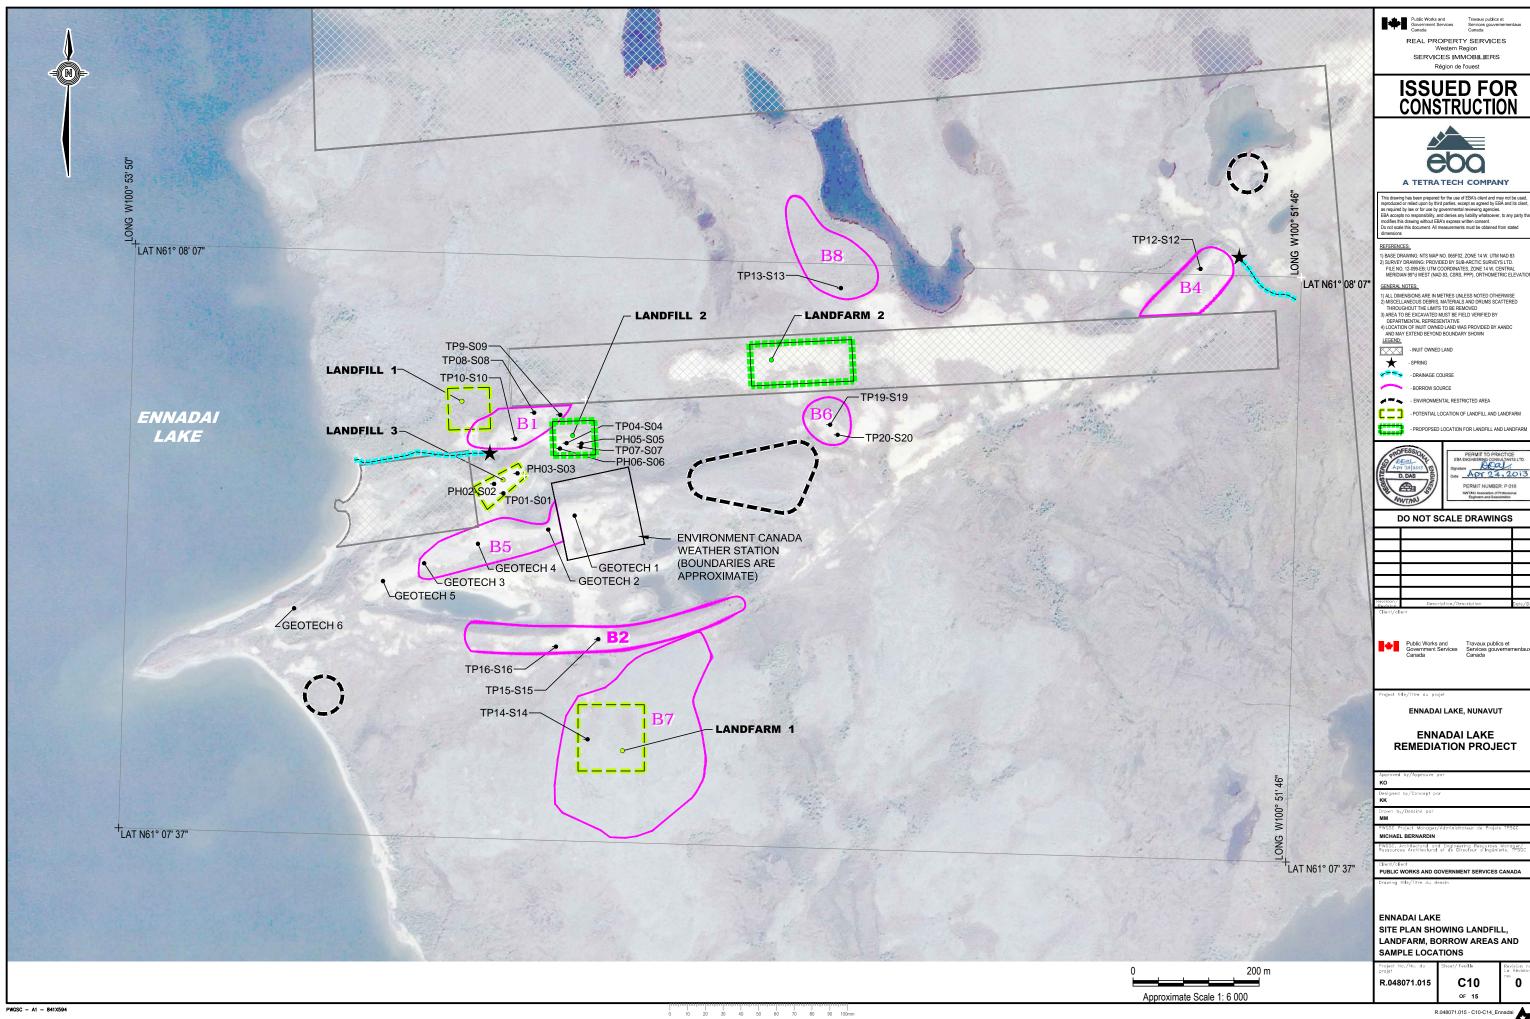

	LAY	OUT POINTS					LAY	OUT POINTS		
POINT	DESCRIPTION	NORTHING	EASTING	ELEVATION (m)	POIN	т	DESCRIPTION	NORTHING	EASTING	ELEVATION (m)
1	INSIDE TOE OF BERM	6779015.354	398528.663	335.450	11		CREST OF BERM	6778997.354	398522.063	337.250
2	INSIDE TOE OF BERM	6779015.354	398540.063	335.450	12		CREST OF BERM	6778997.354	398546.663	337.250
3	INSIDE TOE OF BERM	6779003.954	398528.663	335.450	13		OUTSIDE TOE OF BERM	6779025.647	398518.121	335.450
4	INSIDE TOE OF BERM	6779003.954	398540.063	335.450	14		OUTSIDE TOE OF BERM	6779027.808	398552.835	334.415
5	CREST OF BERM	6779018.954	398525.063	337.250	15		OUTSIDE TOE OF BERM	6778995.785	398520.451	336.500
6	CREST OF BERM	6779018.954	398543.663	337.250	16		OUTSIDE TOE OF BERM	6778995.598	398548.029	336.500
7	CREST OF BERM	6779000.354	398525.063	337.250	17		TOP OF COVER	6779018.954	398525.063	338.250
8	CREST OF BERM	6779000.354	398543.663	337.250	18		TOP OF COVER	6779018.954	398543.663	338.250
9	CREST OF BERM	6779021.954	398522.063	337.250	19		TOP OF COVER	6779000.354	398525.063	338.250
10	CREST OF BERM	6779021.954	398546.663	337.250	20	T	TOP OF COVER	6779000.354	398543.663	338.250

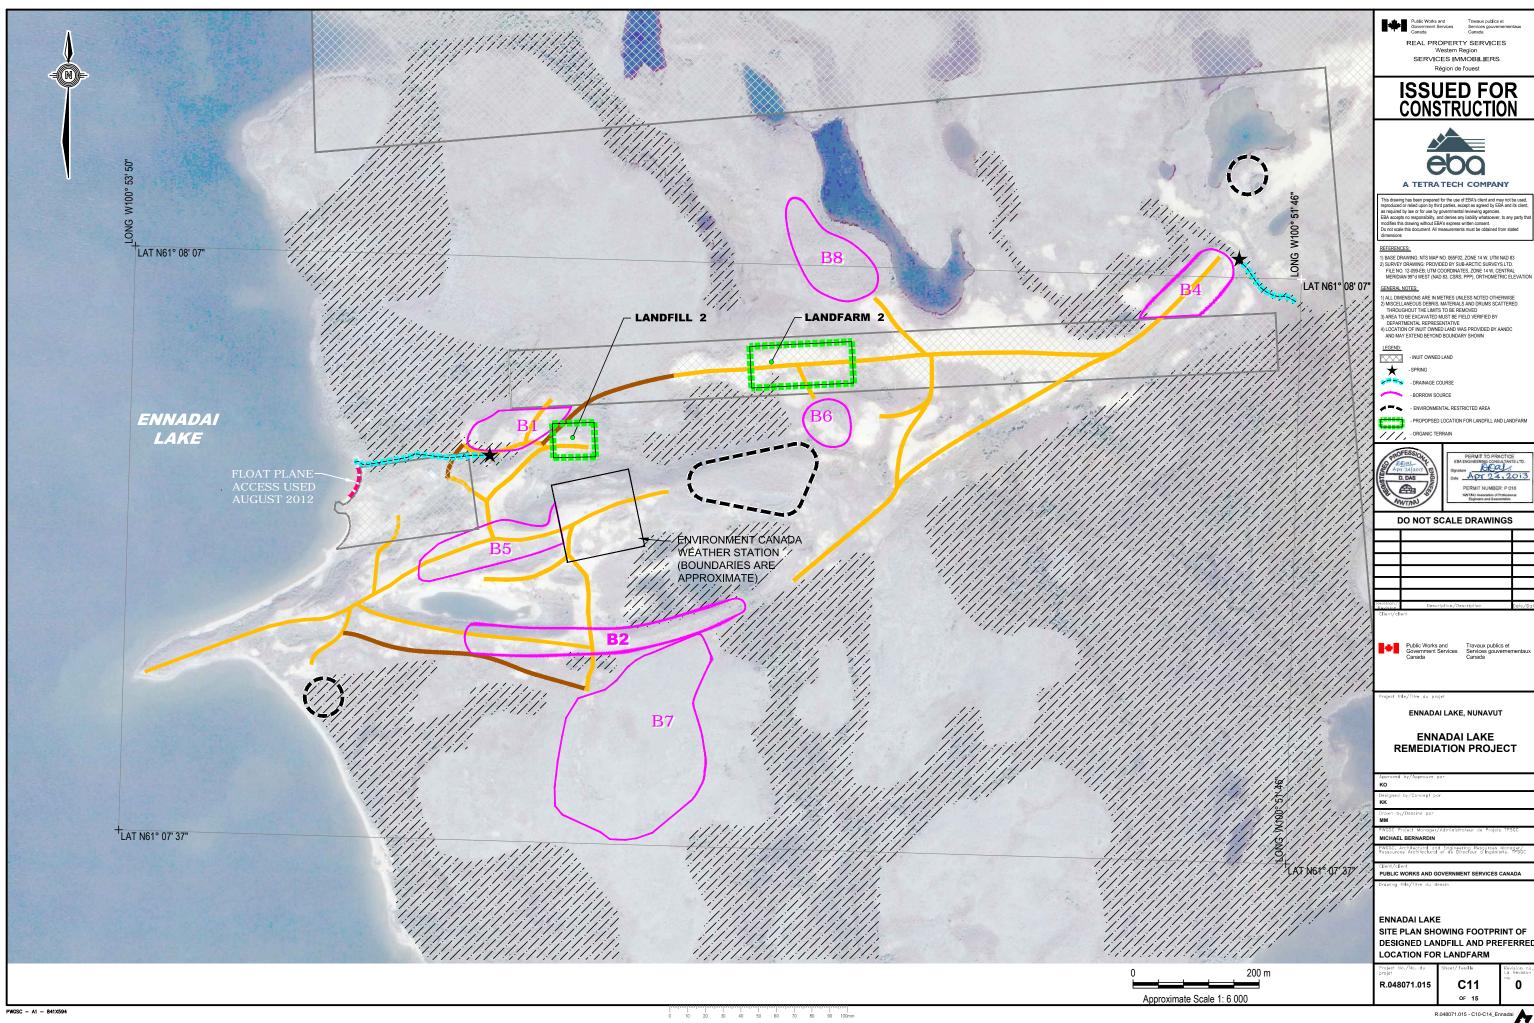

SOUTH NORTH APPROXIMATELY 35 m (varies) 342 342 24.6 m € 340· __3.0 m _18.6 m_ _3.0 m - 340 338 - 336 -TOP OF COVER EL. 338.2 - 338 EL. 337.25 - 336 岀 11.4 m EXISTING GROUND -334 **EXISTING GROUND** - 332 332 25 30 20 35 40 STATION (m) **CROSS-SECTION B-B'**

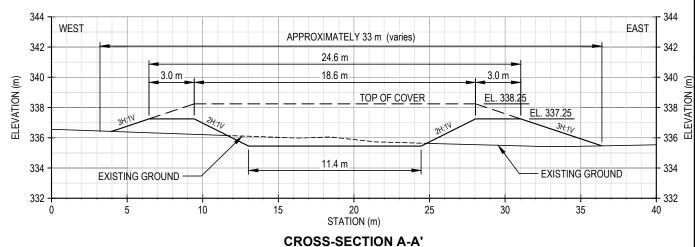

LAYOUT POINTS								
POINT	DESCRIPTION	NORTHING	EASTING	ELEVATION (m)				
21	INSIDE EDGE OF EROSION CONTROL	6779017.373	398526.644	338.250				
22	INSIDE EDGE OF EROSION CONTROL	6779017.373	398542.082	338.250				
23	INSIDE EDGE OF EROSION CONTROL	6779001.935	398526.644	338.250				
24	INSIDE EDGE OF EROSION CONTROL	6779001.935	398542.082	338.250				

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REFERENCES:

NET RETURNES.

1) BASE DRAWING: NTS MAP NO. 065F02, ZONE 14 W. UTM NAD 83
2) SURVEY DRAWING: PROVIDED BY SUB-ARCTIC SURVEYS LTD.
FILE NO. 12-0598-25 UTM COORDINATES, ZONE 14 W. CENTRAL
MERDIAN 99'd WEST (NAD 83, CSRS, PP), ORTHOMETRIC ELEVY

GENERAL NOTES:

1) ALL DIMENSIONS ARE IN METRES UNLESS NOTED OTHERWISE 2) MISCELLANEOUS DEBRIS, MATERIALS AND DRUMS SCATTERED THROUGHOUT THE LIMITS TO BE REMOVED 3) AREA TO BE EXCAVATED MIST BE FIELD VERIFIED BY DEPARTMENTAL REPRESENTATIVE

1) HEIGHT OF PERIMETER BERMS MAY VARY DEPENDING ON SURROUNDING TOPOGRAPHY AND FINAL DESIGN GRADES AND ELEVATIONS.

2) ALL DIMENSIONS SHOWN ARE DESIGN MINIMUMS UNLESS

LEGEND:

APPROXIMATE LOCATION OF PROPOSED GROUNDWATER MONITORING WELL (TO BE CONFIRMED IN FIELD)



Signature APY 24, 201 PERMIT NUMBER: P 018

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ENNADAI LAKE REMEDIATION PROJECT

ENNADAI LAKE LANDFILL

CONCEPTUAL DESIGN PLAN

R.048071.015

C12

