

Défense nationale_

DEW LINE CLEAN UP PROJECT

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H-C76/3-9101-108	TANNER BAY AREA SITE PLAN	H-C76/3-9101-118	MISCELLANEOUS DETAILS SHEET 1	© COPYRIGHT HER MAJESTY THE QUEEN IN RIGHT OF CANADA 2015, AS REPRESENTED BY THE MINISTER OF NATIONAL DEFENCE.	
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H-C76/3-9101-110	TYPICAL LANDFARM CLOSURE DETAIL				


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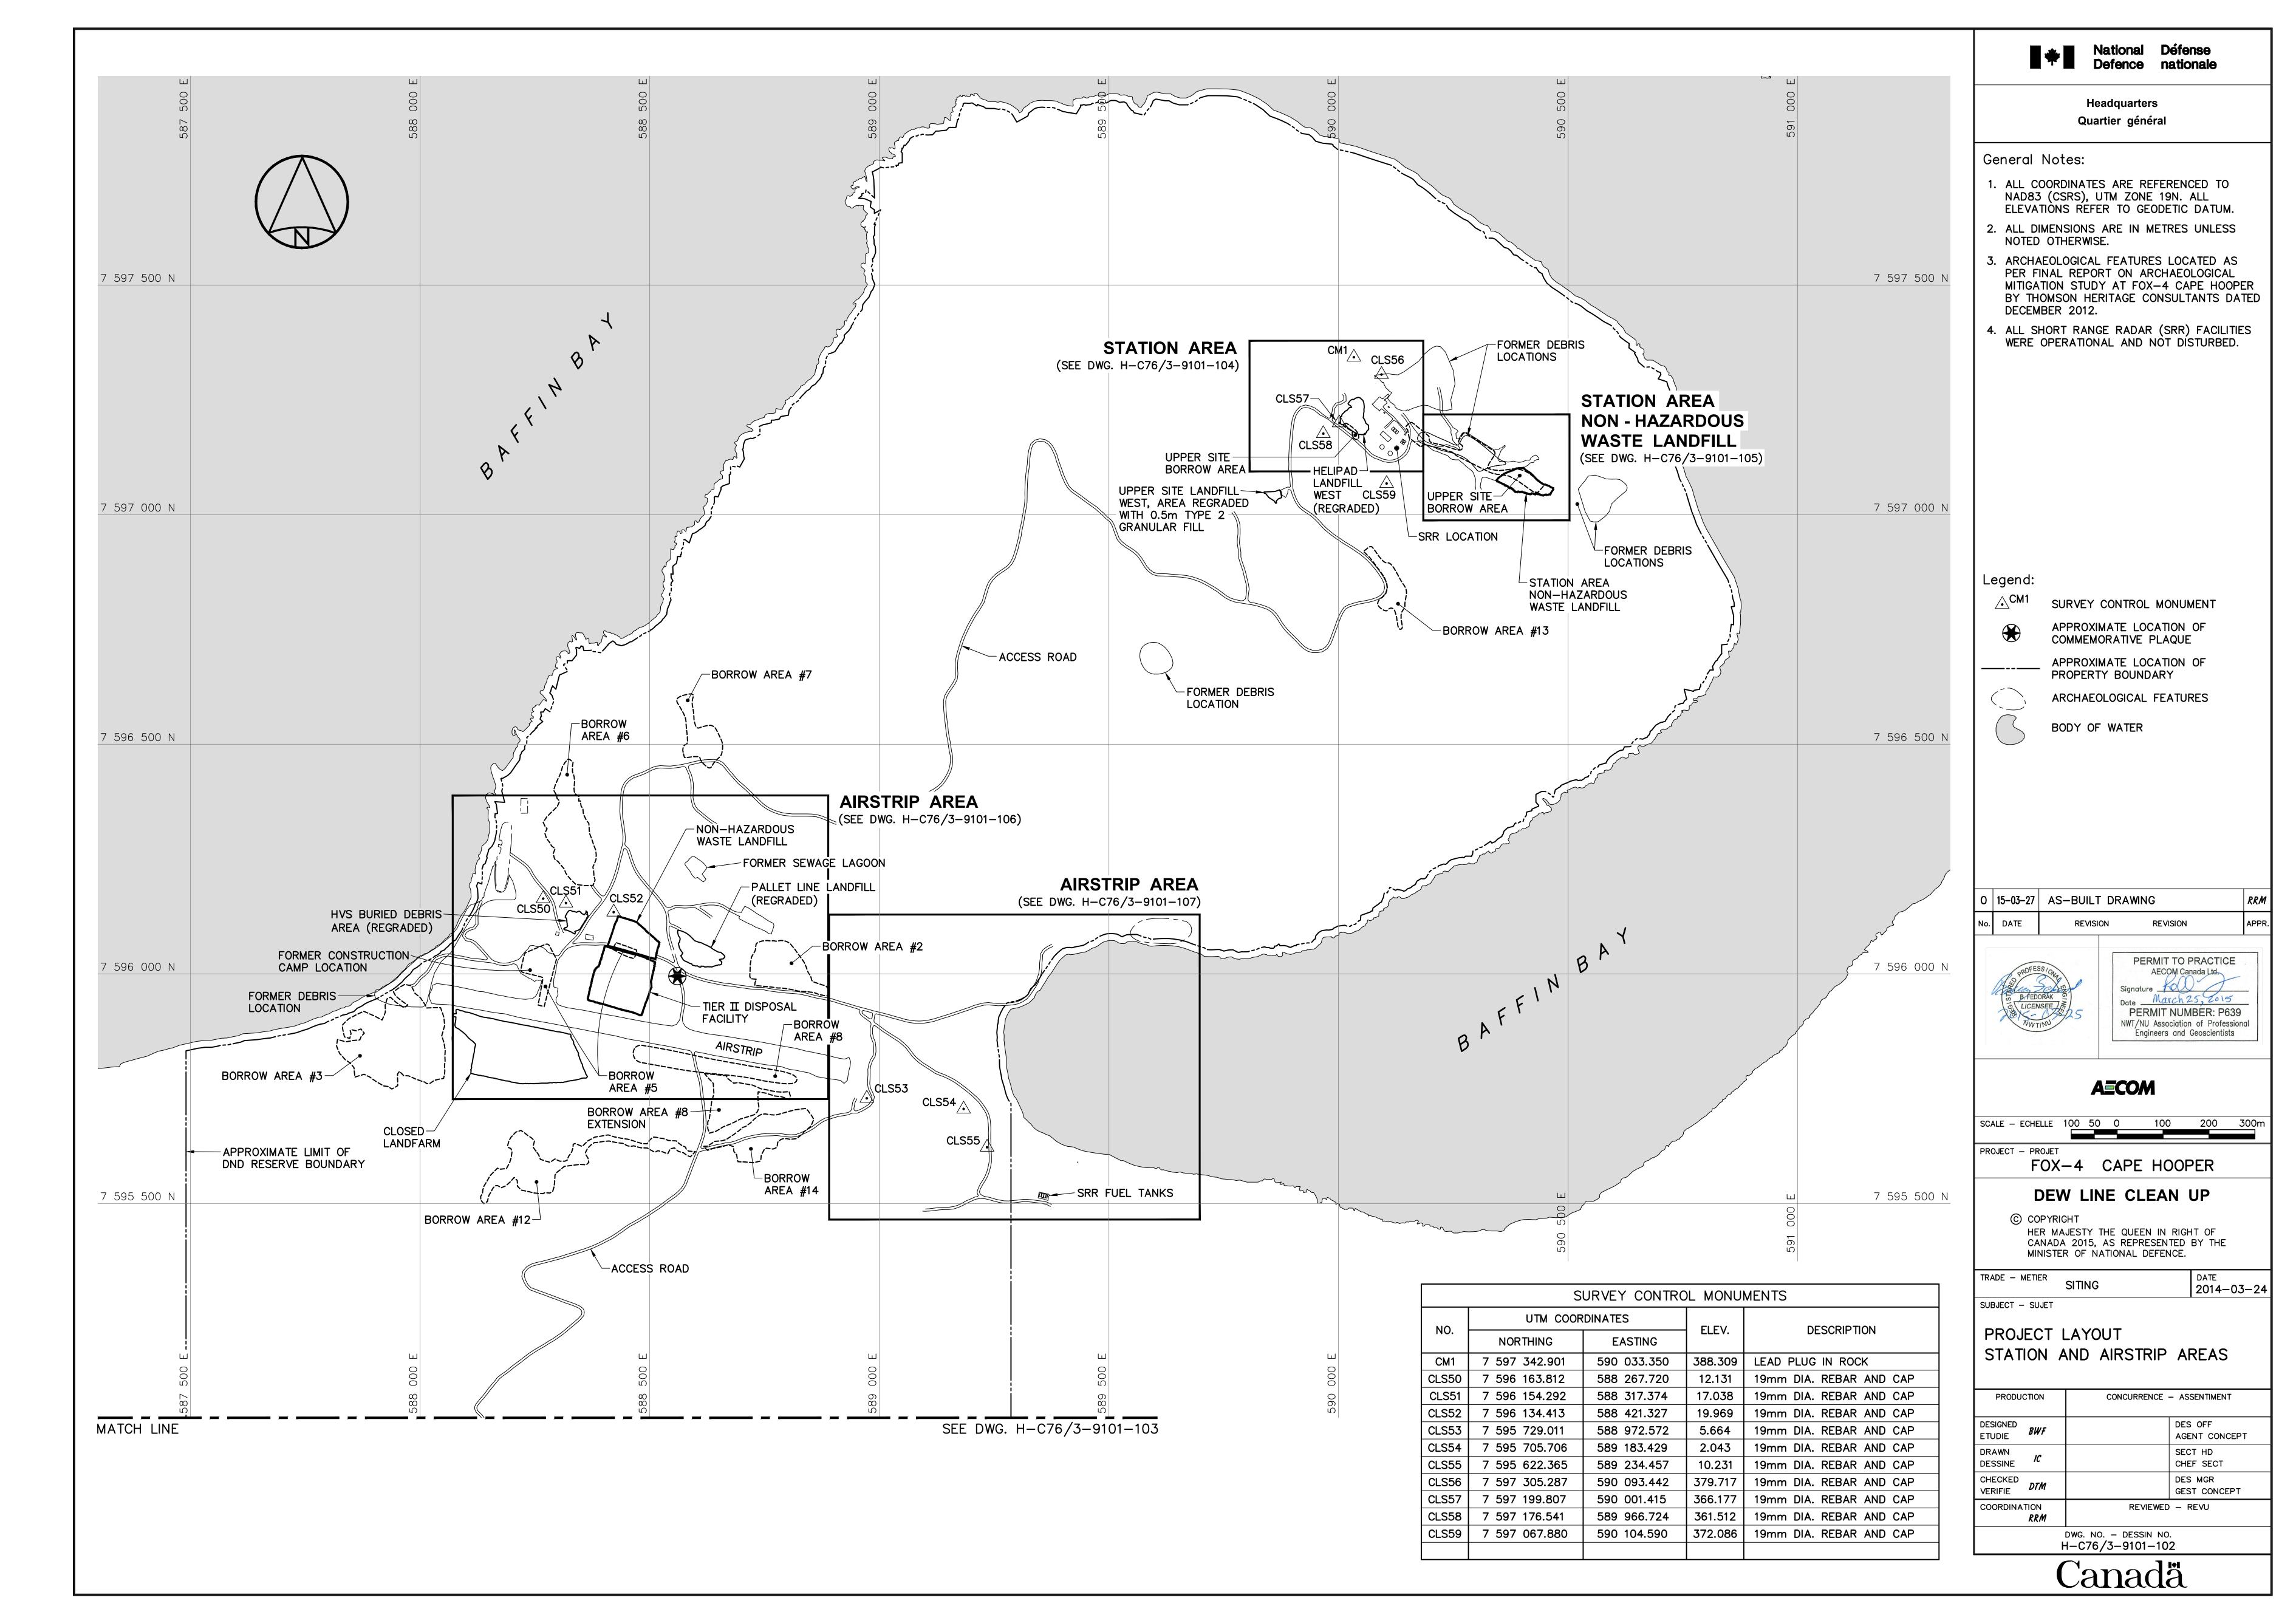
THIS DRAWING PACKAGE HAS BEEN REVISED BASED ON INFORMATION SUPPLIED BY DEFENCE CONSTRUCTION CANADA IN 1998, 1999, 2012 AND 2013.





FOX-4 CAPE HOOPER AS-BUILT DRAWINGS





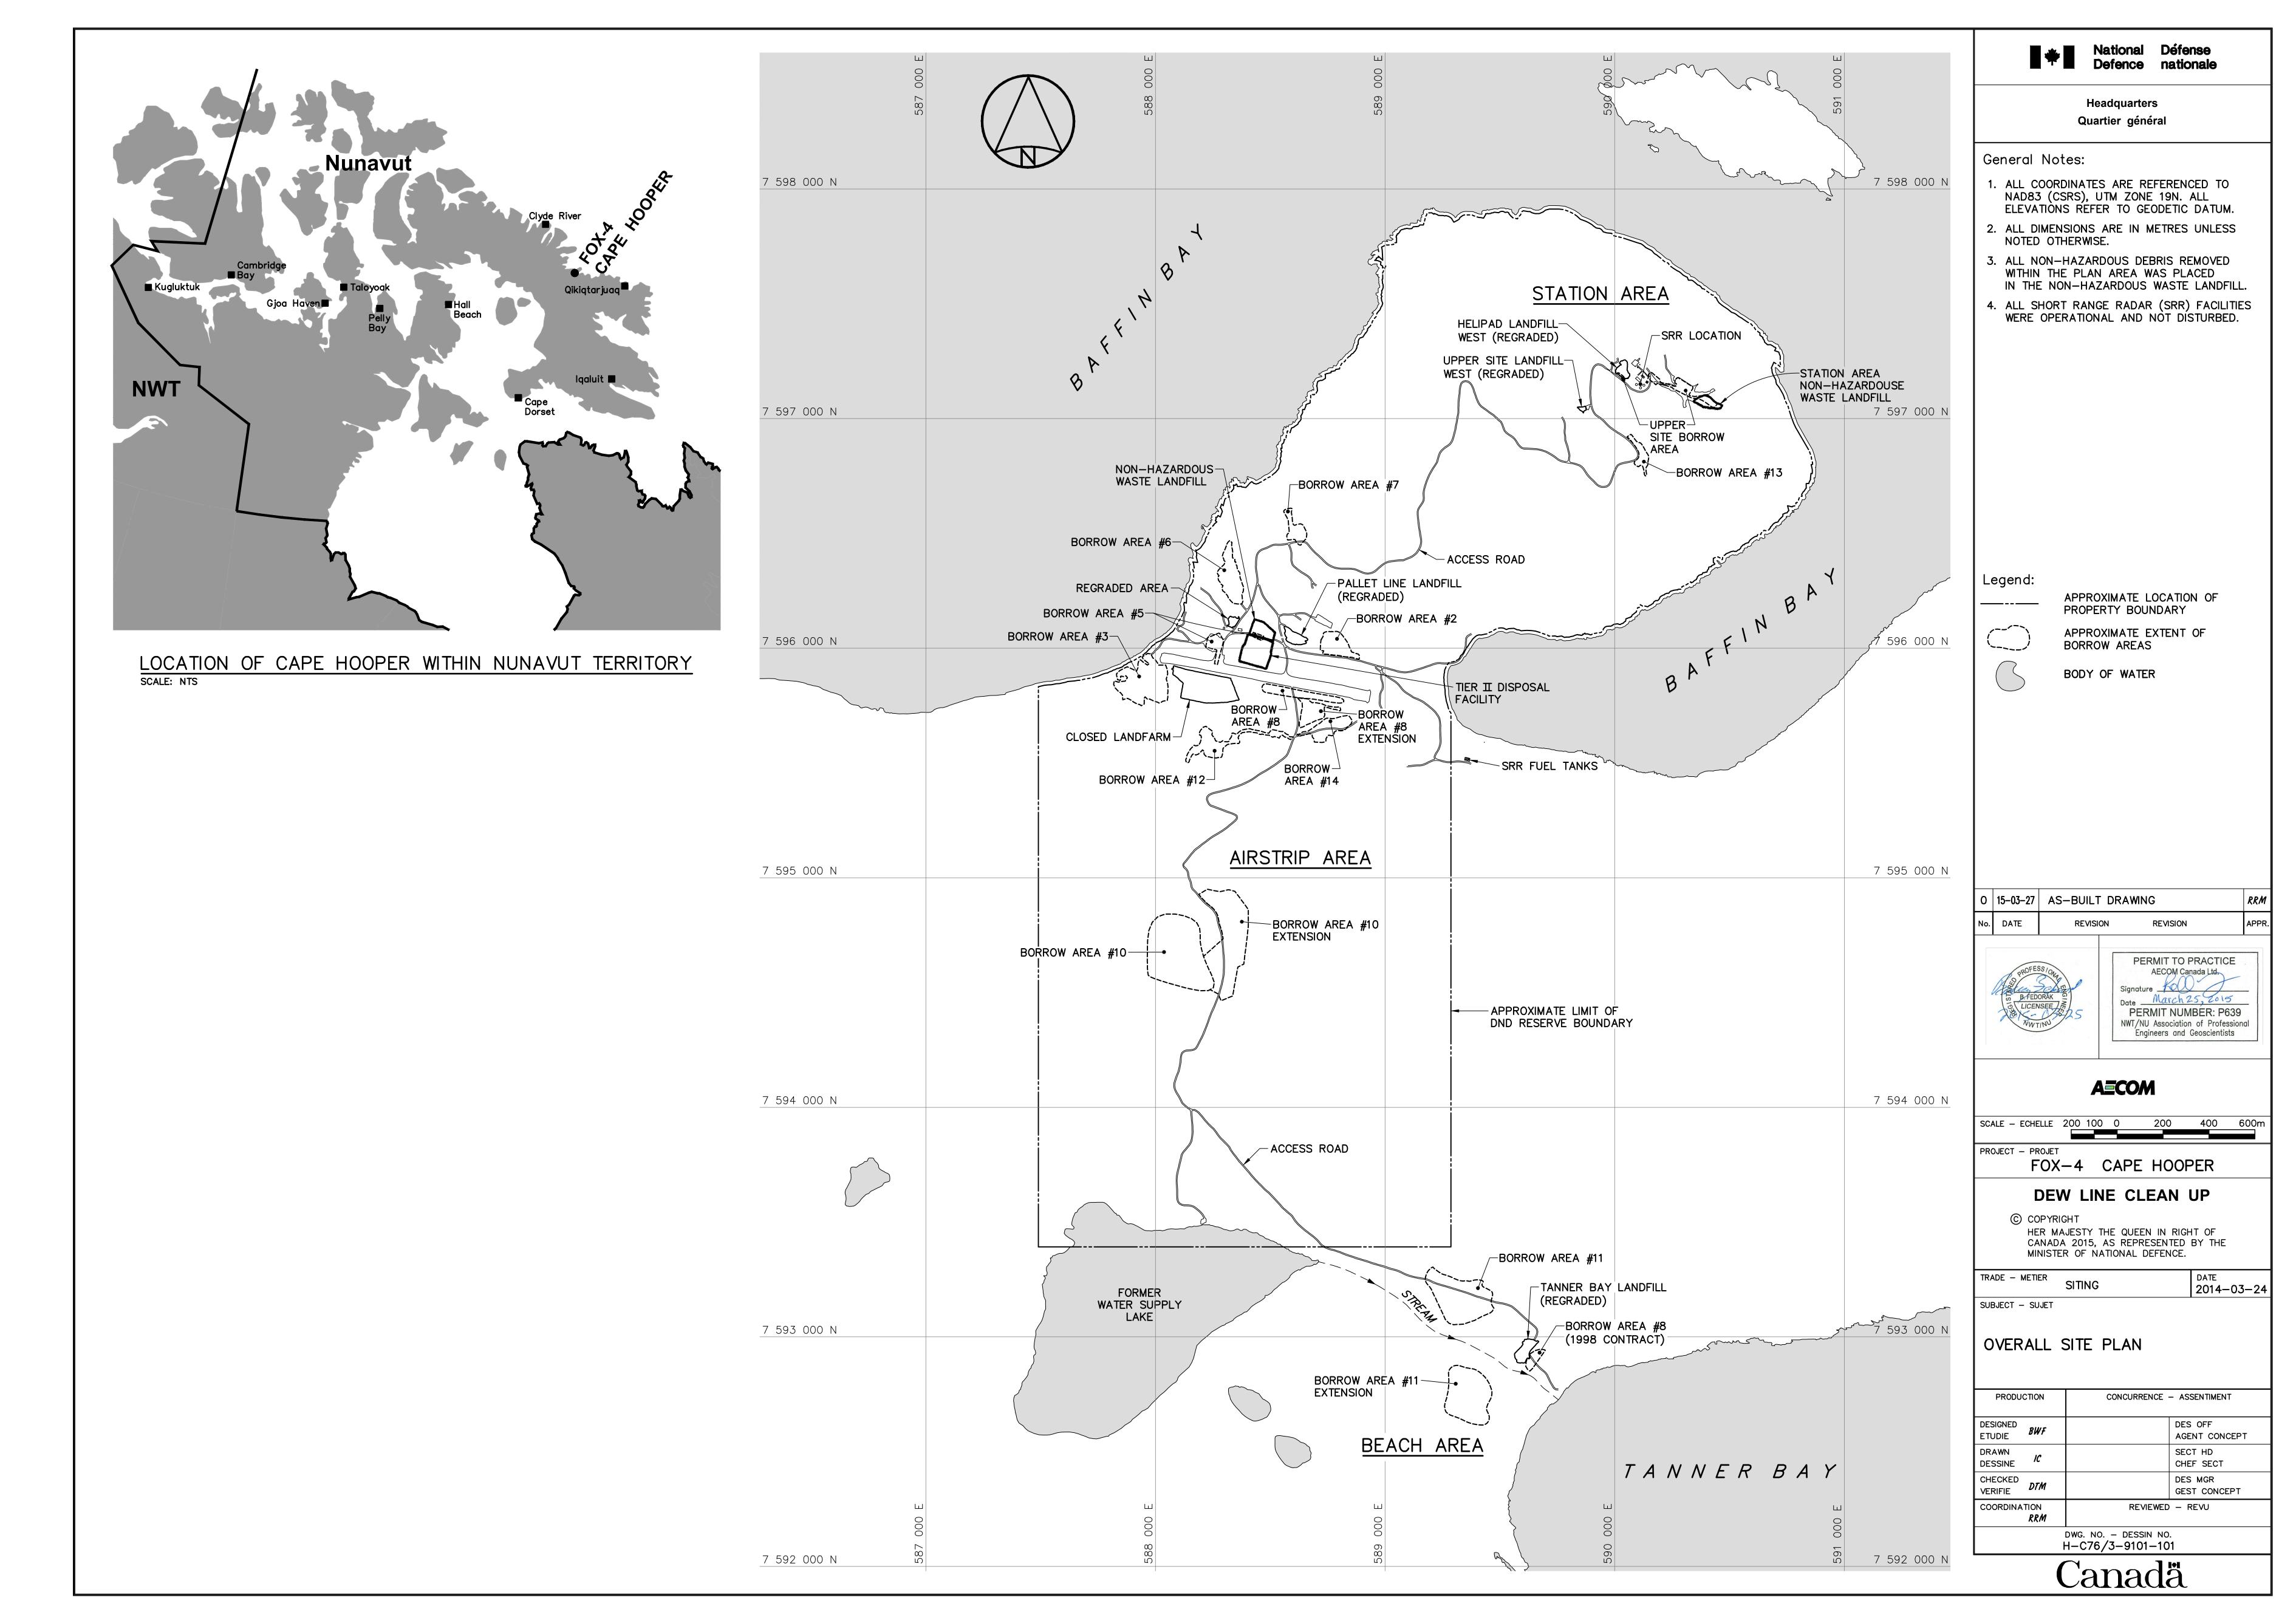

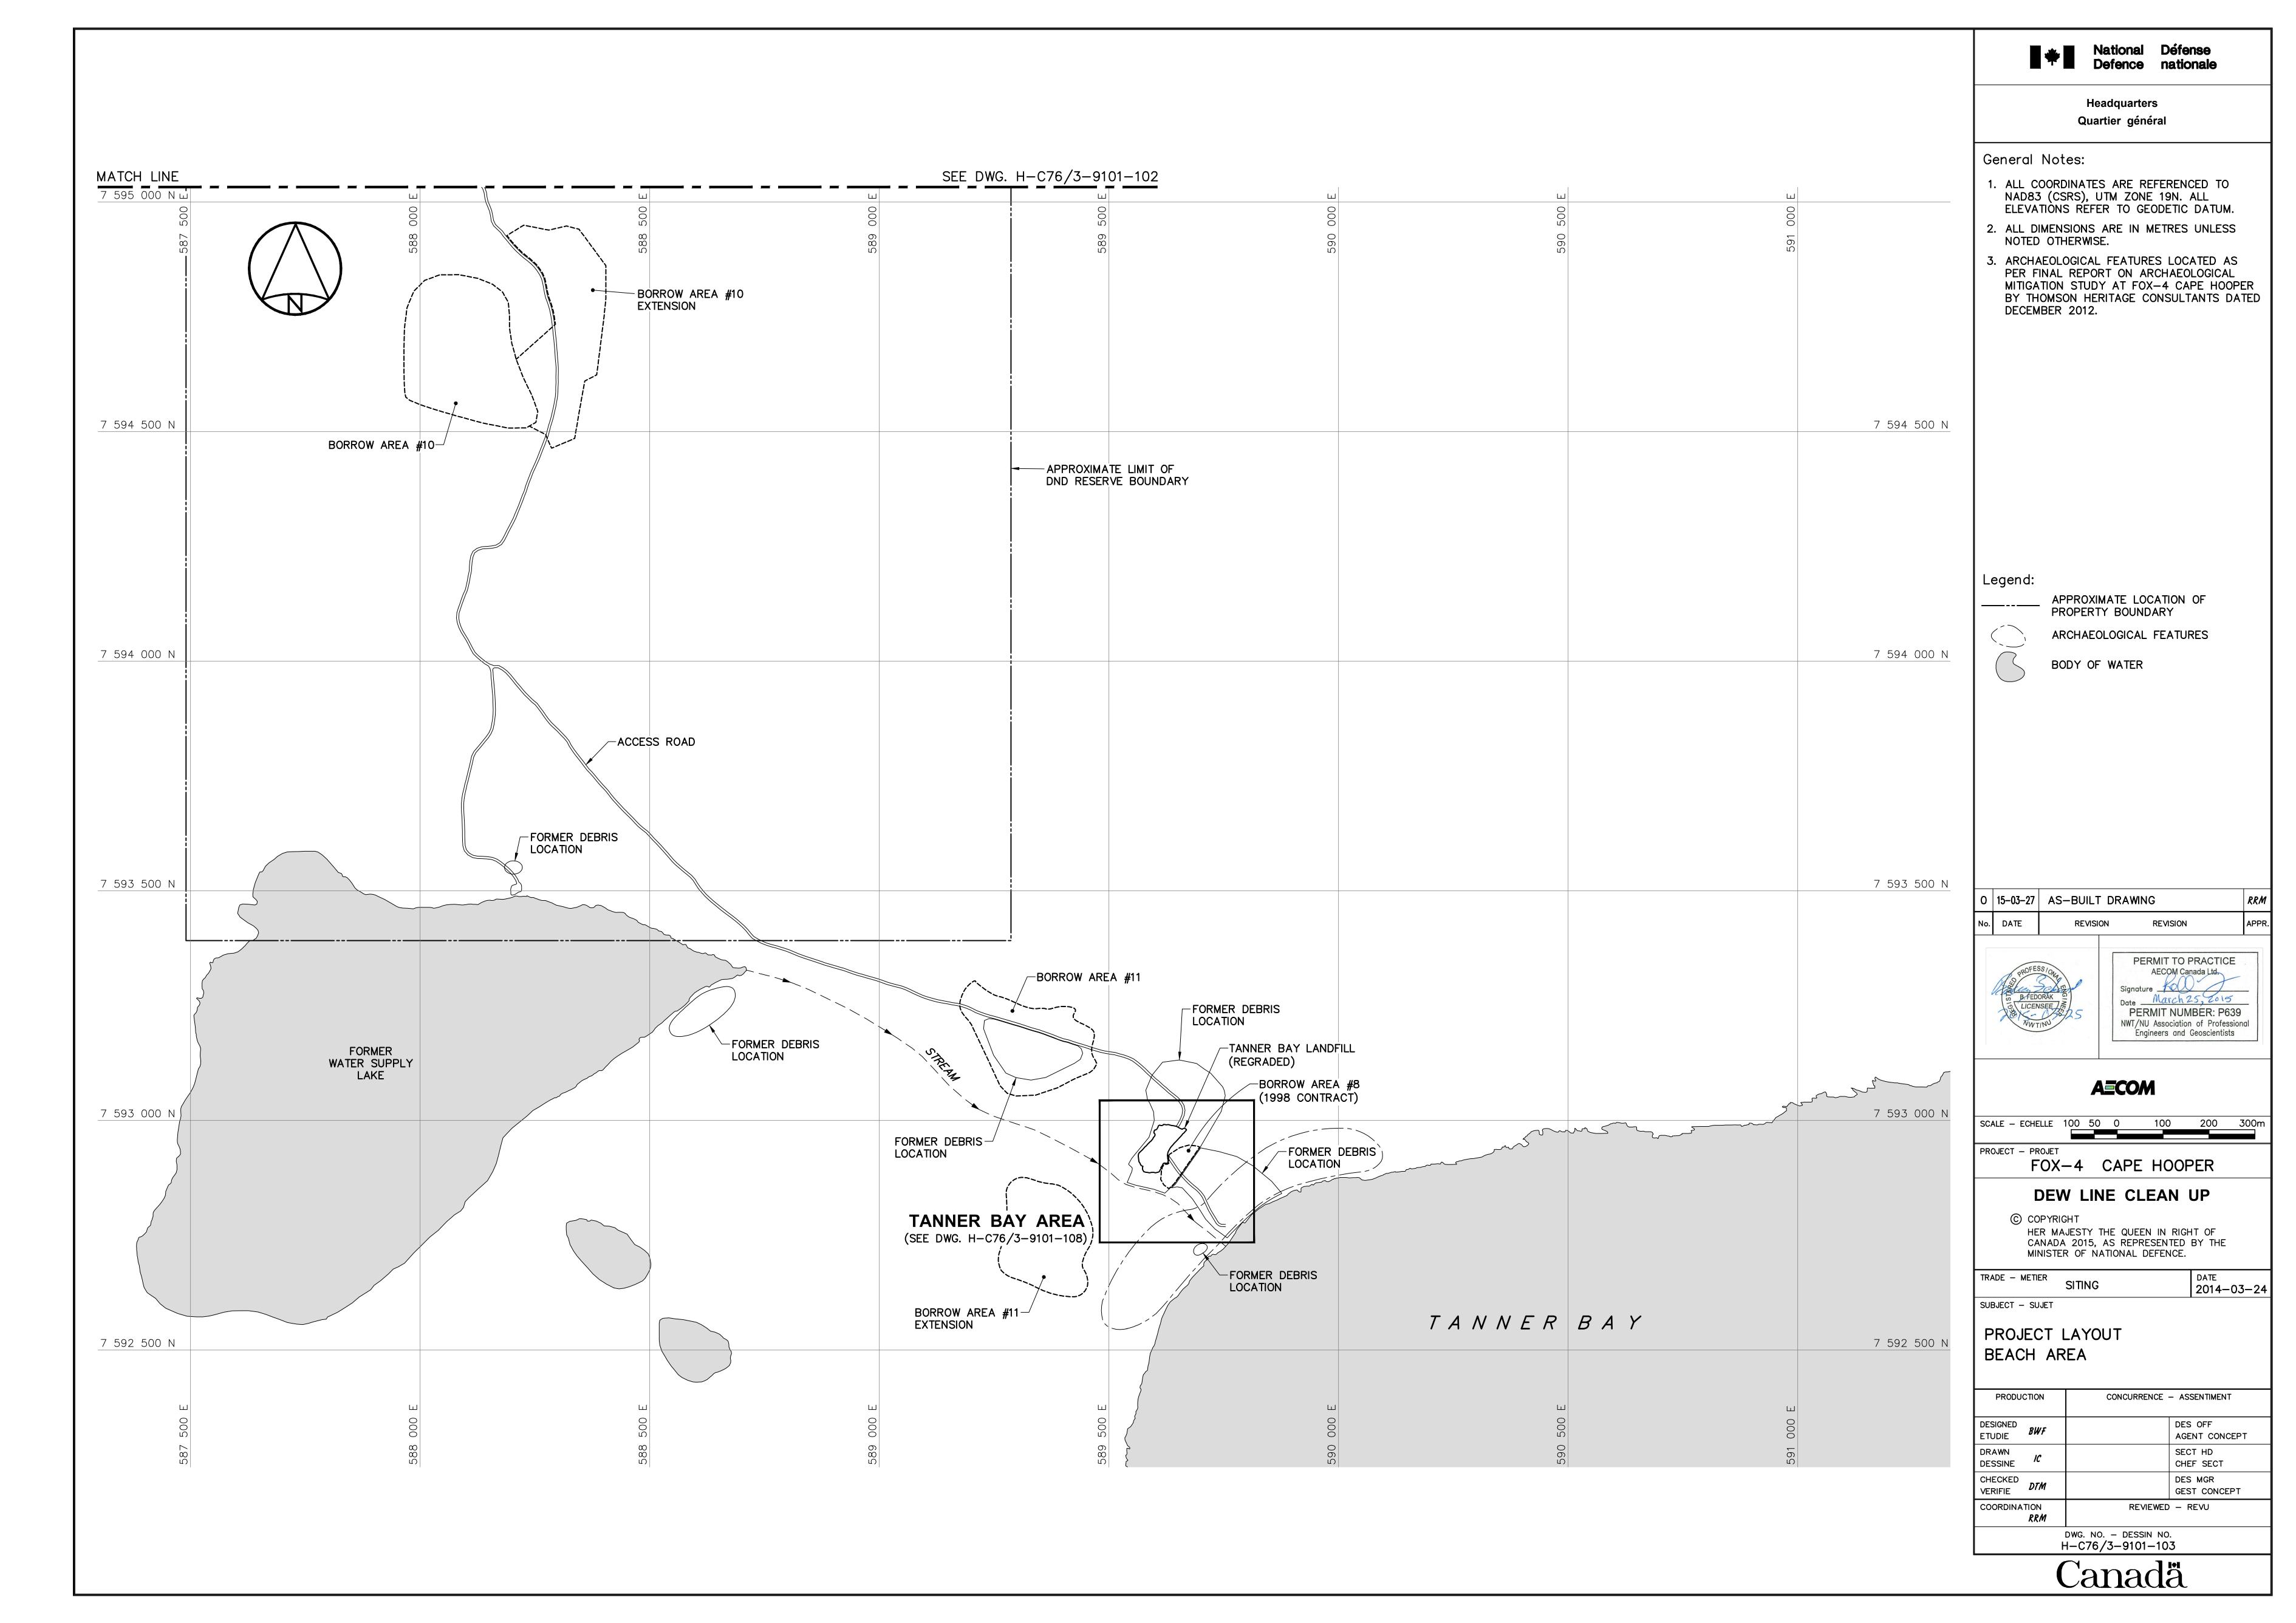

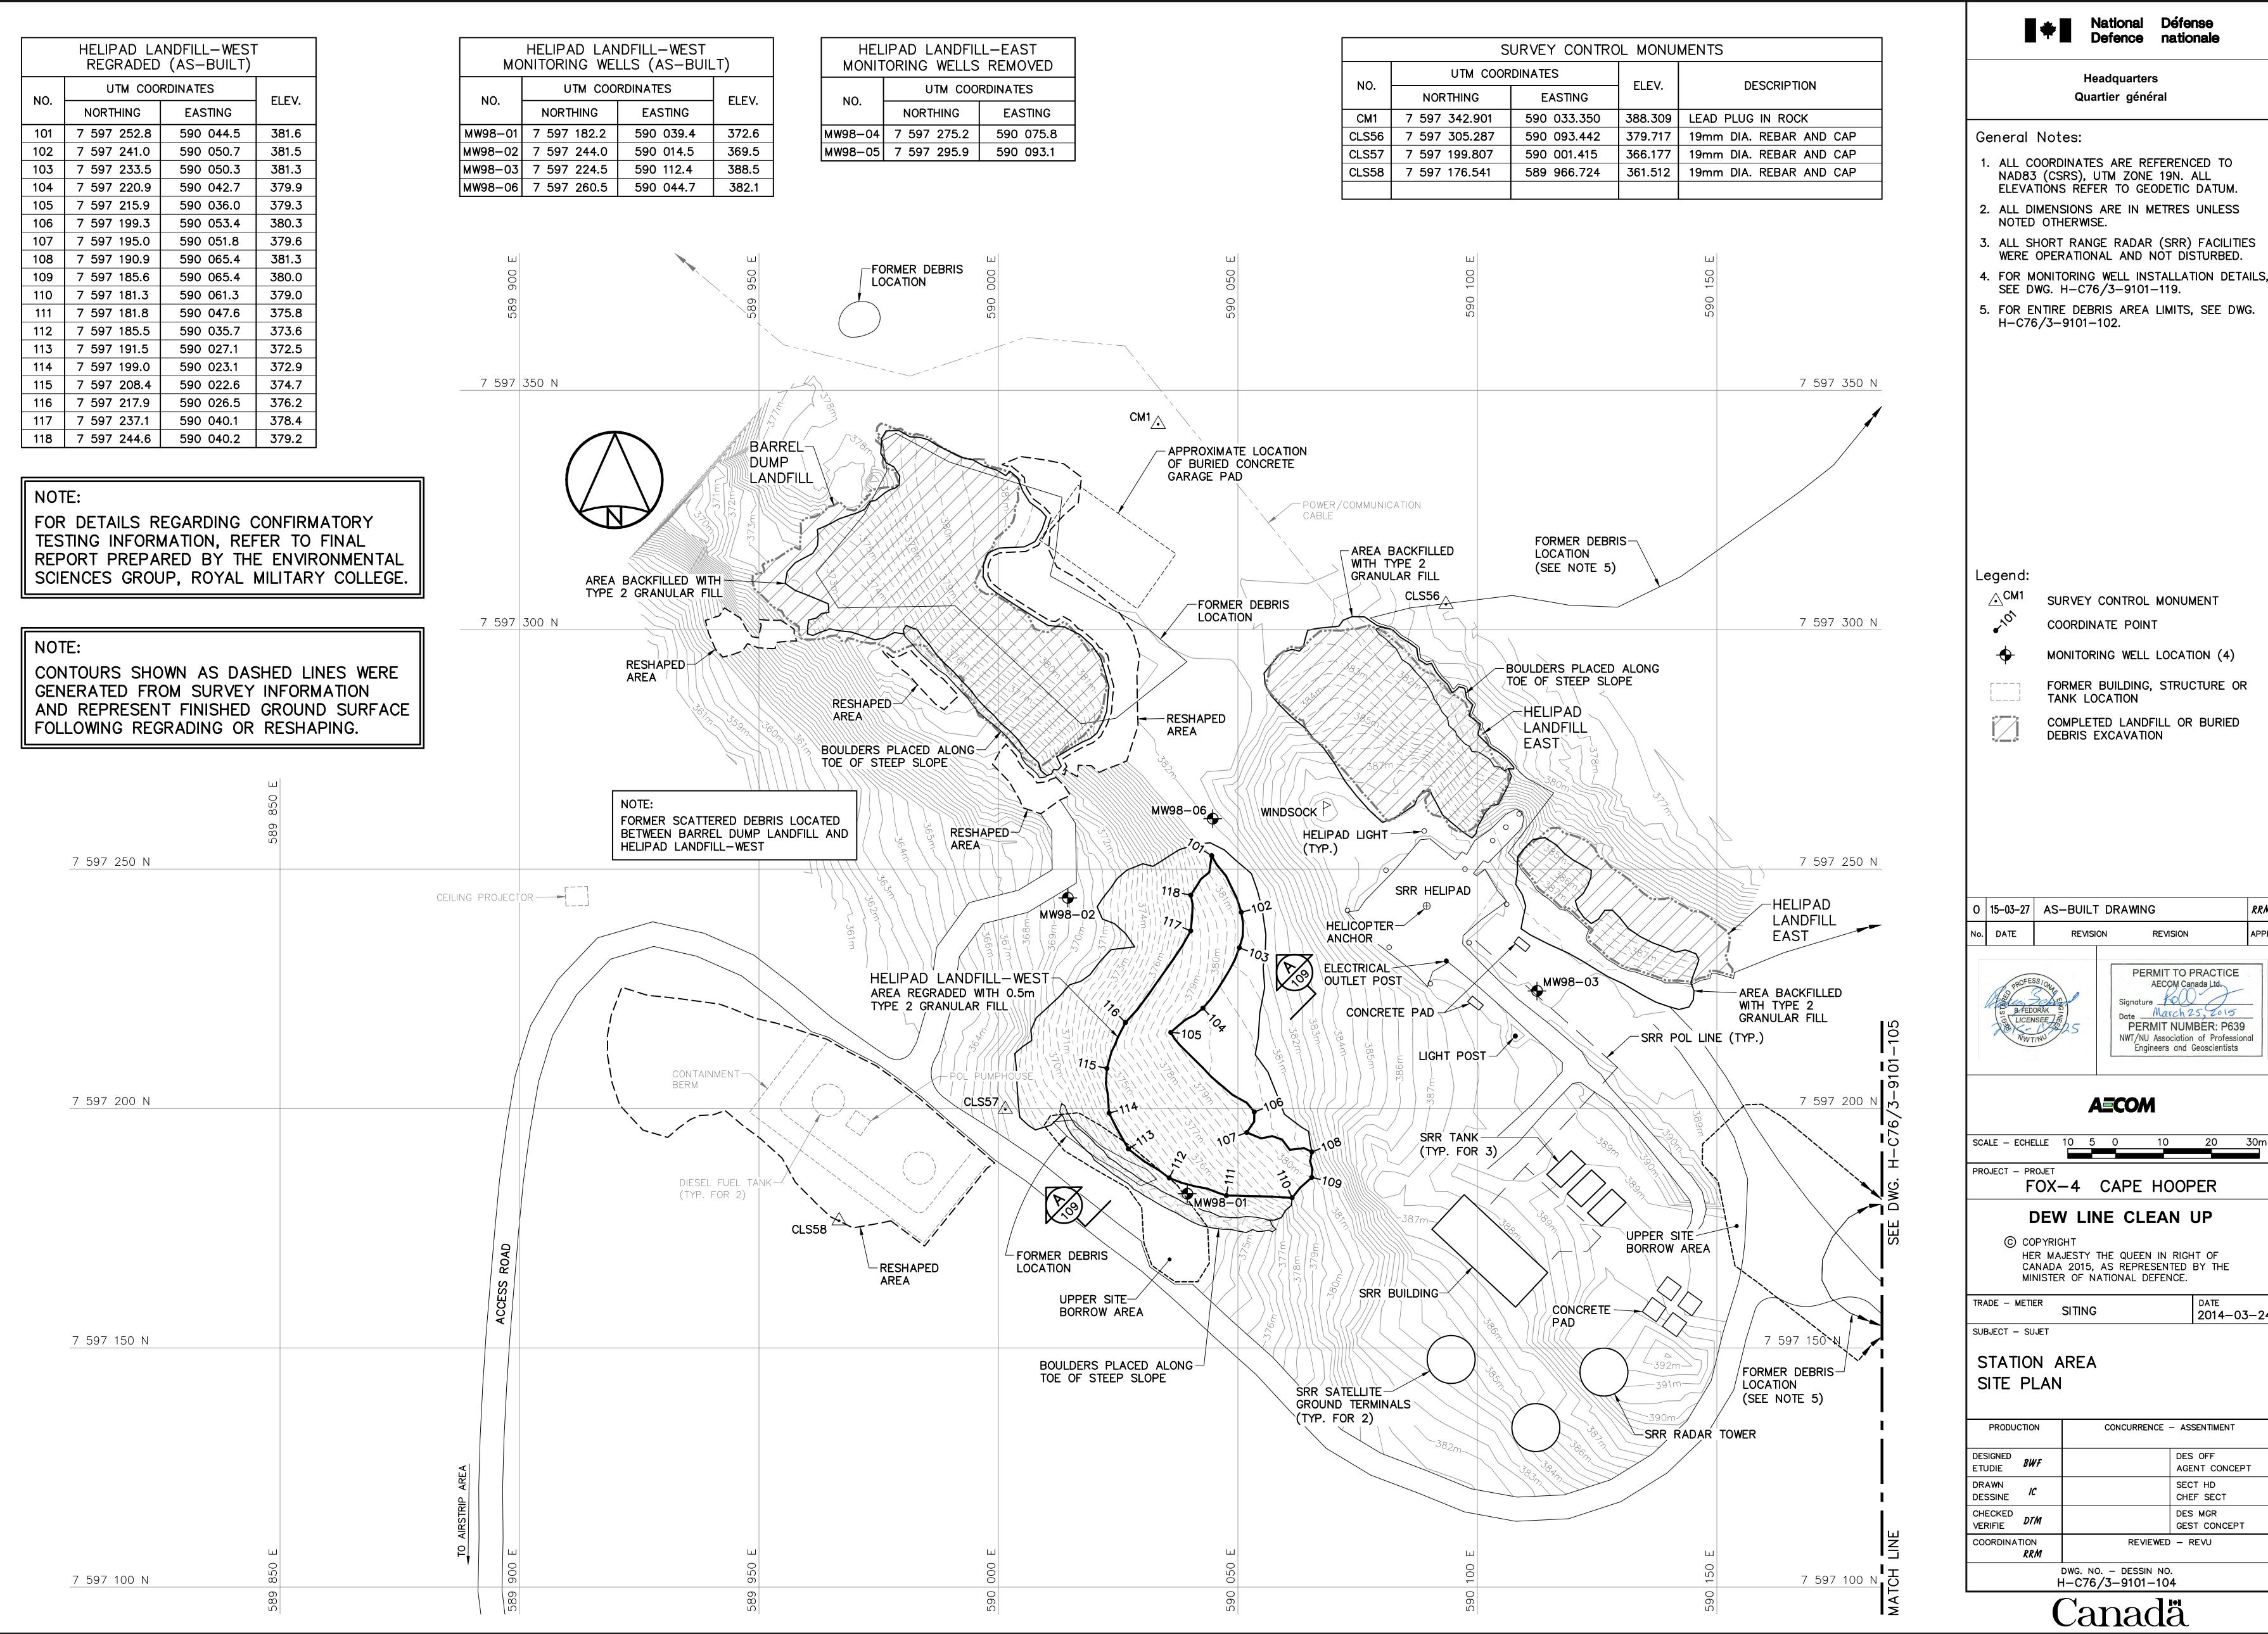



Headquarters Quartier général

General Notes:

- 1. ALL COORDINATES ARE REFERENCED TO NAD83 (CSRS), UTM ZONE 19N. ALL ELEVATIONS REFER TO GEODETIC DATUM.
- 2. ALL DIMENSIONS ARE IN METRES UNLESS NOTED OTHERWISE.
- 3. ALL SHORT RANGE RADAR (SRR) FACILITIES WERE OPERATIONAL AND NOT DISTURBED.
- 4. FOR MONITORING WELL INSTALLATION DETAILS, SEE DWG. H-C76/3-9101-119.
- 5. FOR ENTIRE DEBRIS AREA LIMITS, SEE DWG.
- H-C76/3-9101-102.

Legend:

SURVEY CONTROL MONUMENT

COORDINATE POINT

MONITORING WELL LOCATION (4)

FORMER BUILDING, STRUCTURE OR TANK LOCATION

COMPLETED LANDFILL OR BURIED DEBRIS EXCAVATION

0 | 15-03-27 | AS-BUILT DRAWING DATE REVISION REVISION

PERMIT TO PRACTICE AECOM Canada Ltd. Date _ March 25, 2015 PERMIT NUMBER: P639 NWT/NU Association of Professional Engineers and Geoscientists

2014-03-24

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PROJECT - PROJET FOX-4 CAPE HOOPER

DEW LINE CLEAN UP

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SUBJECT - SUJET


STATION AREA SITE PLAN


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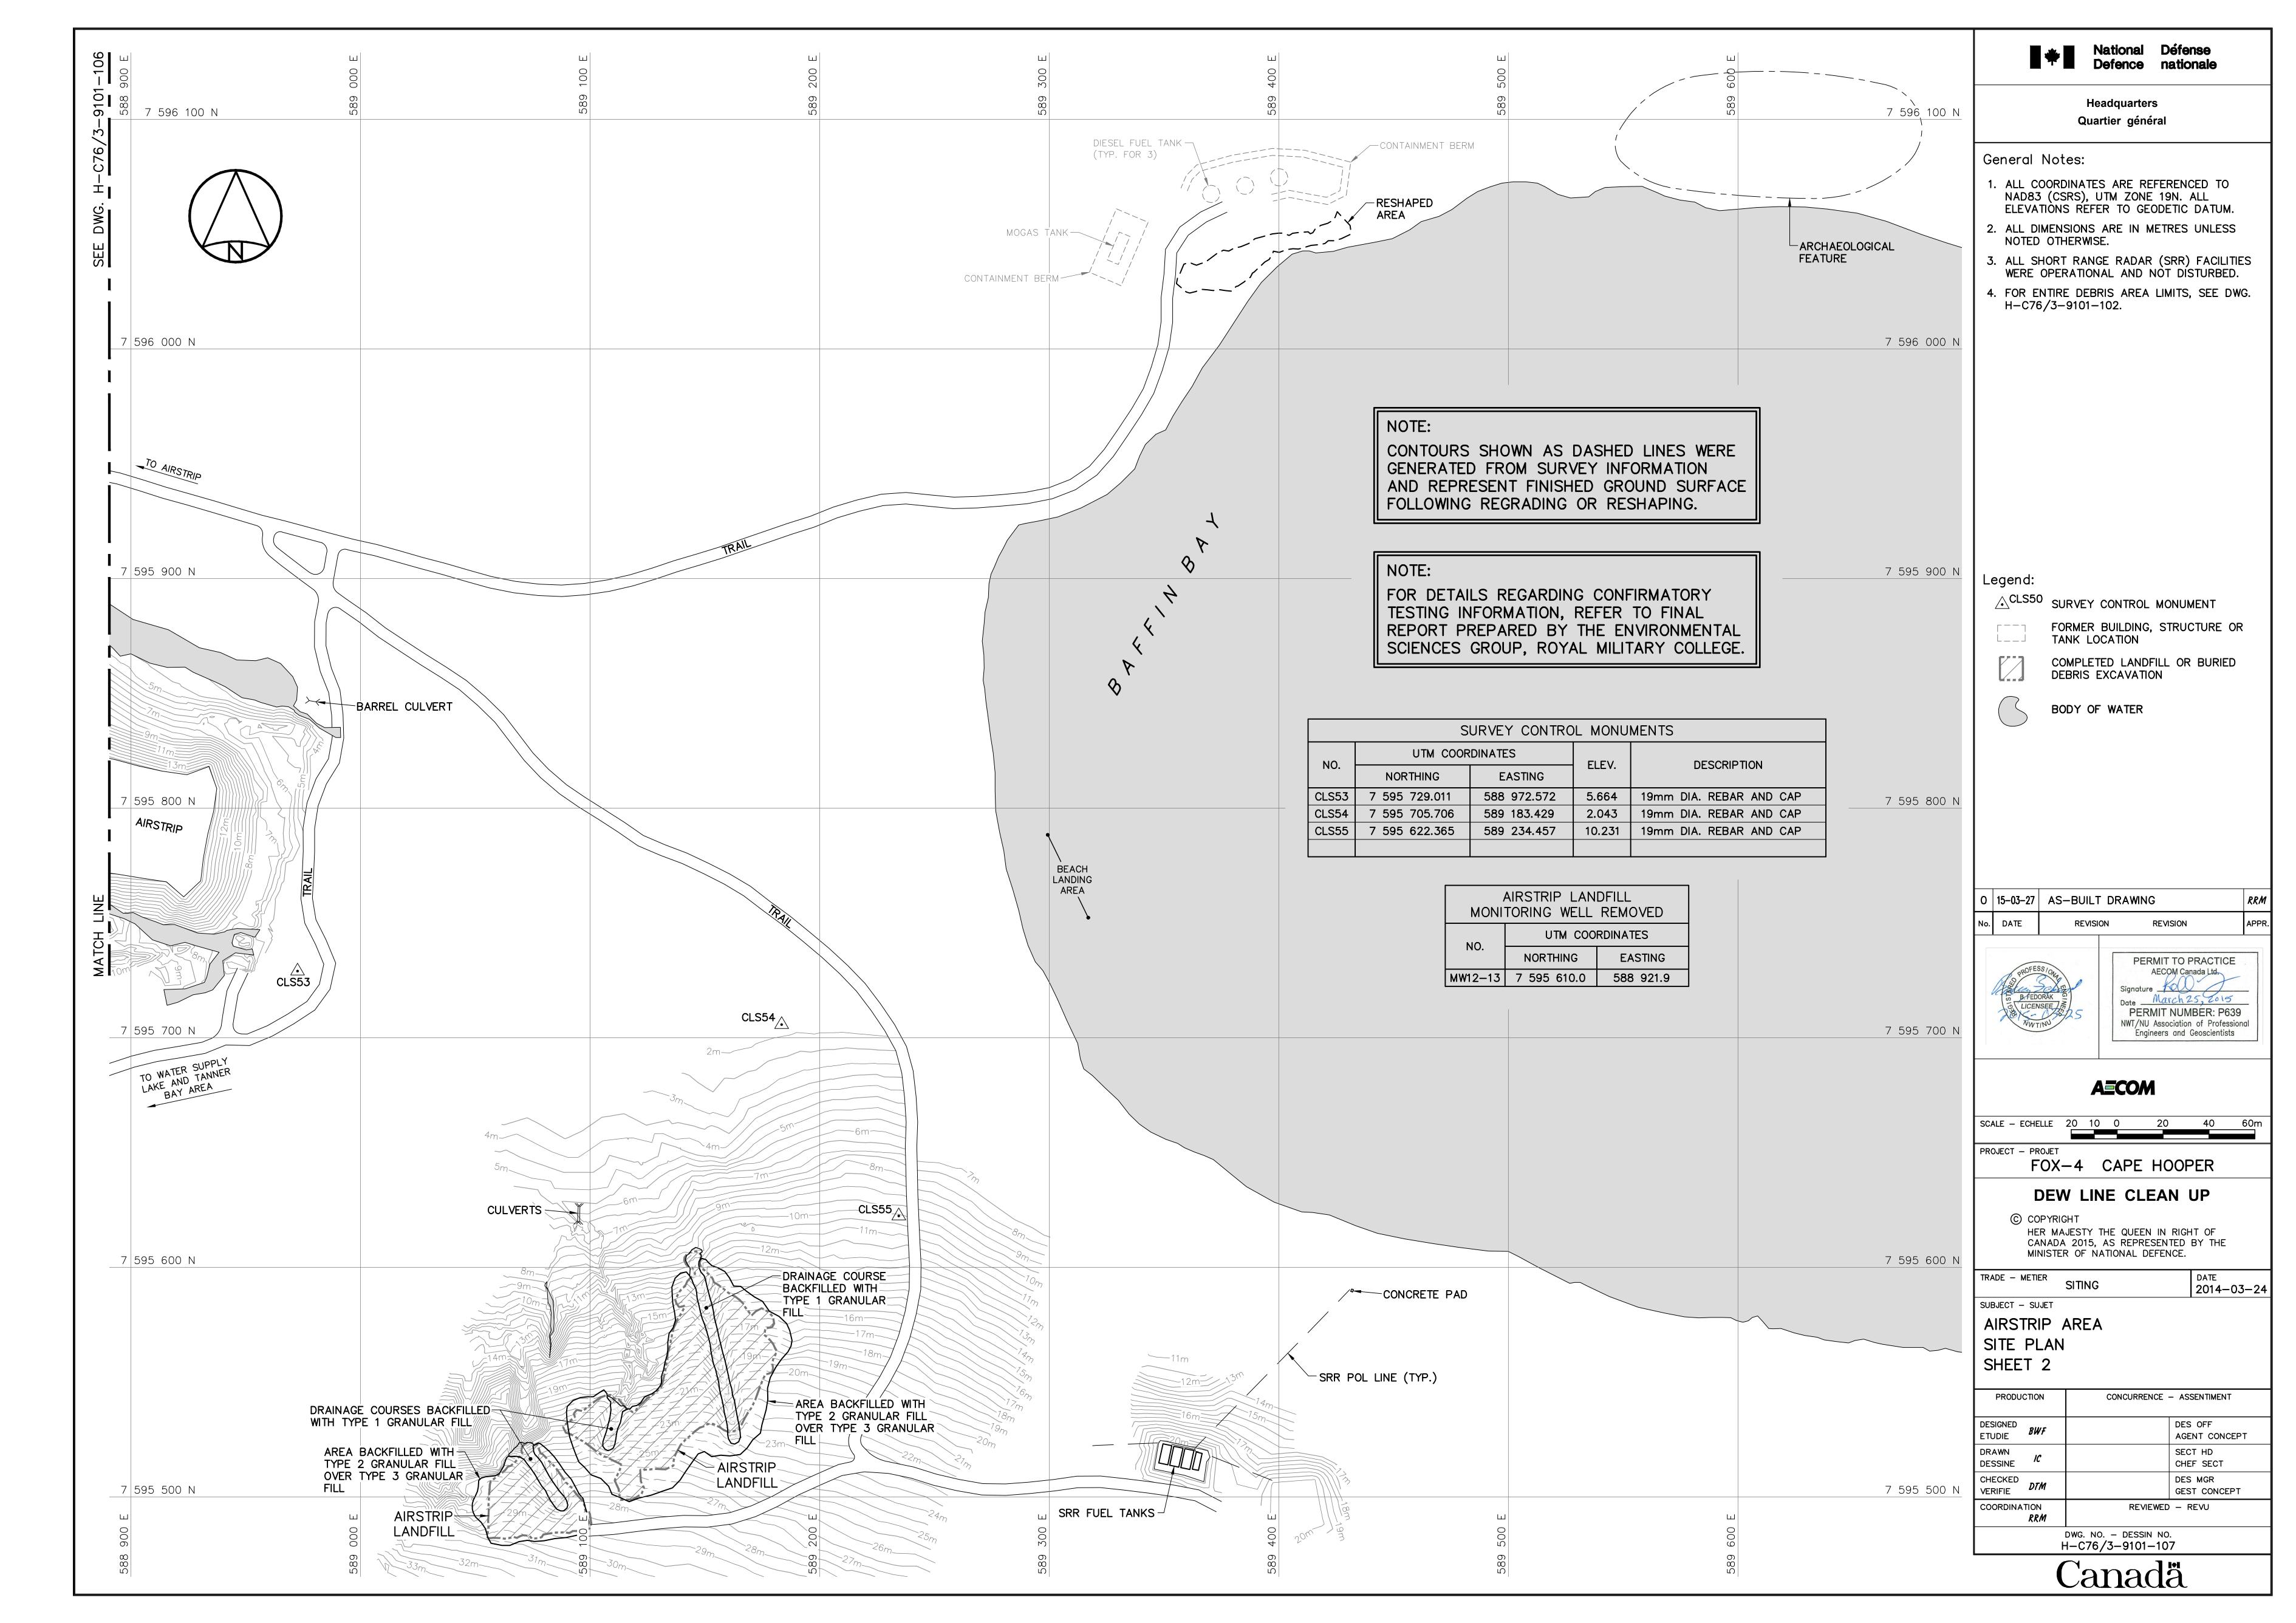
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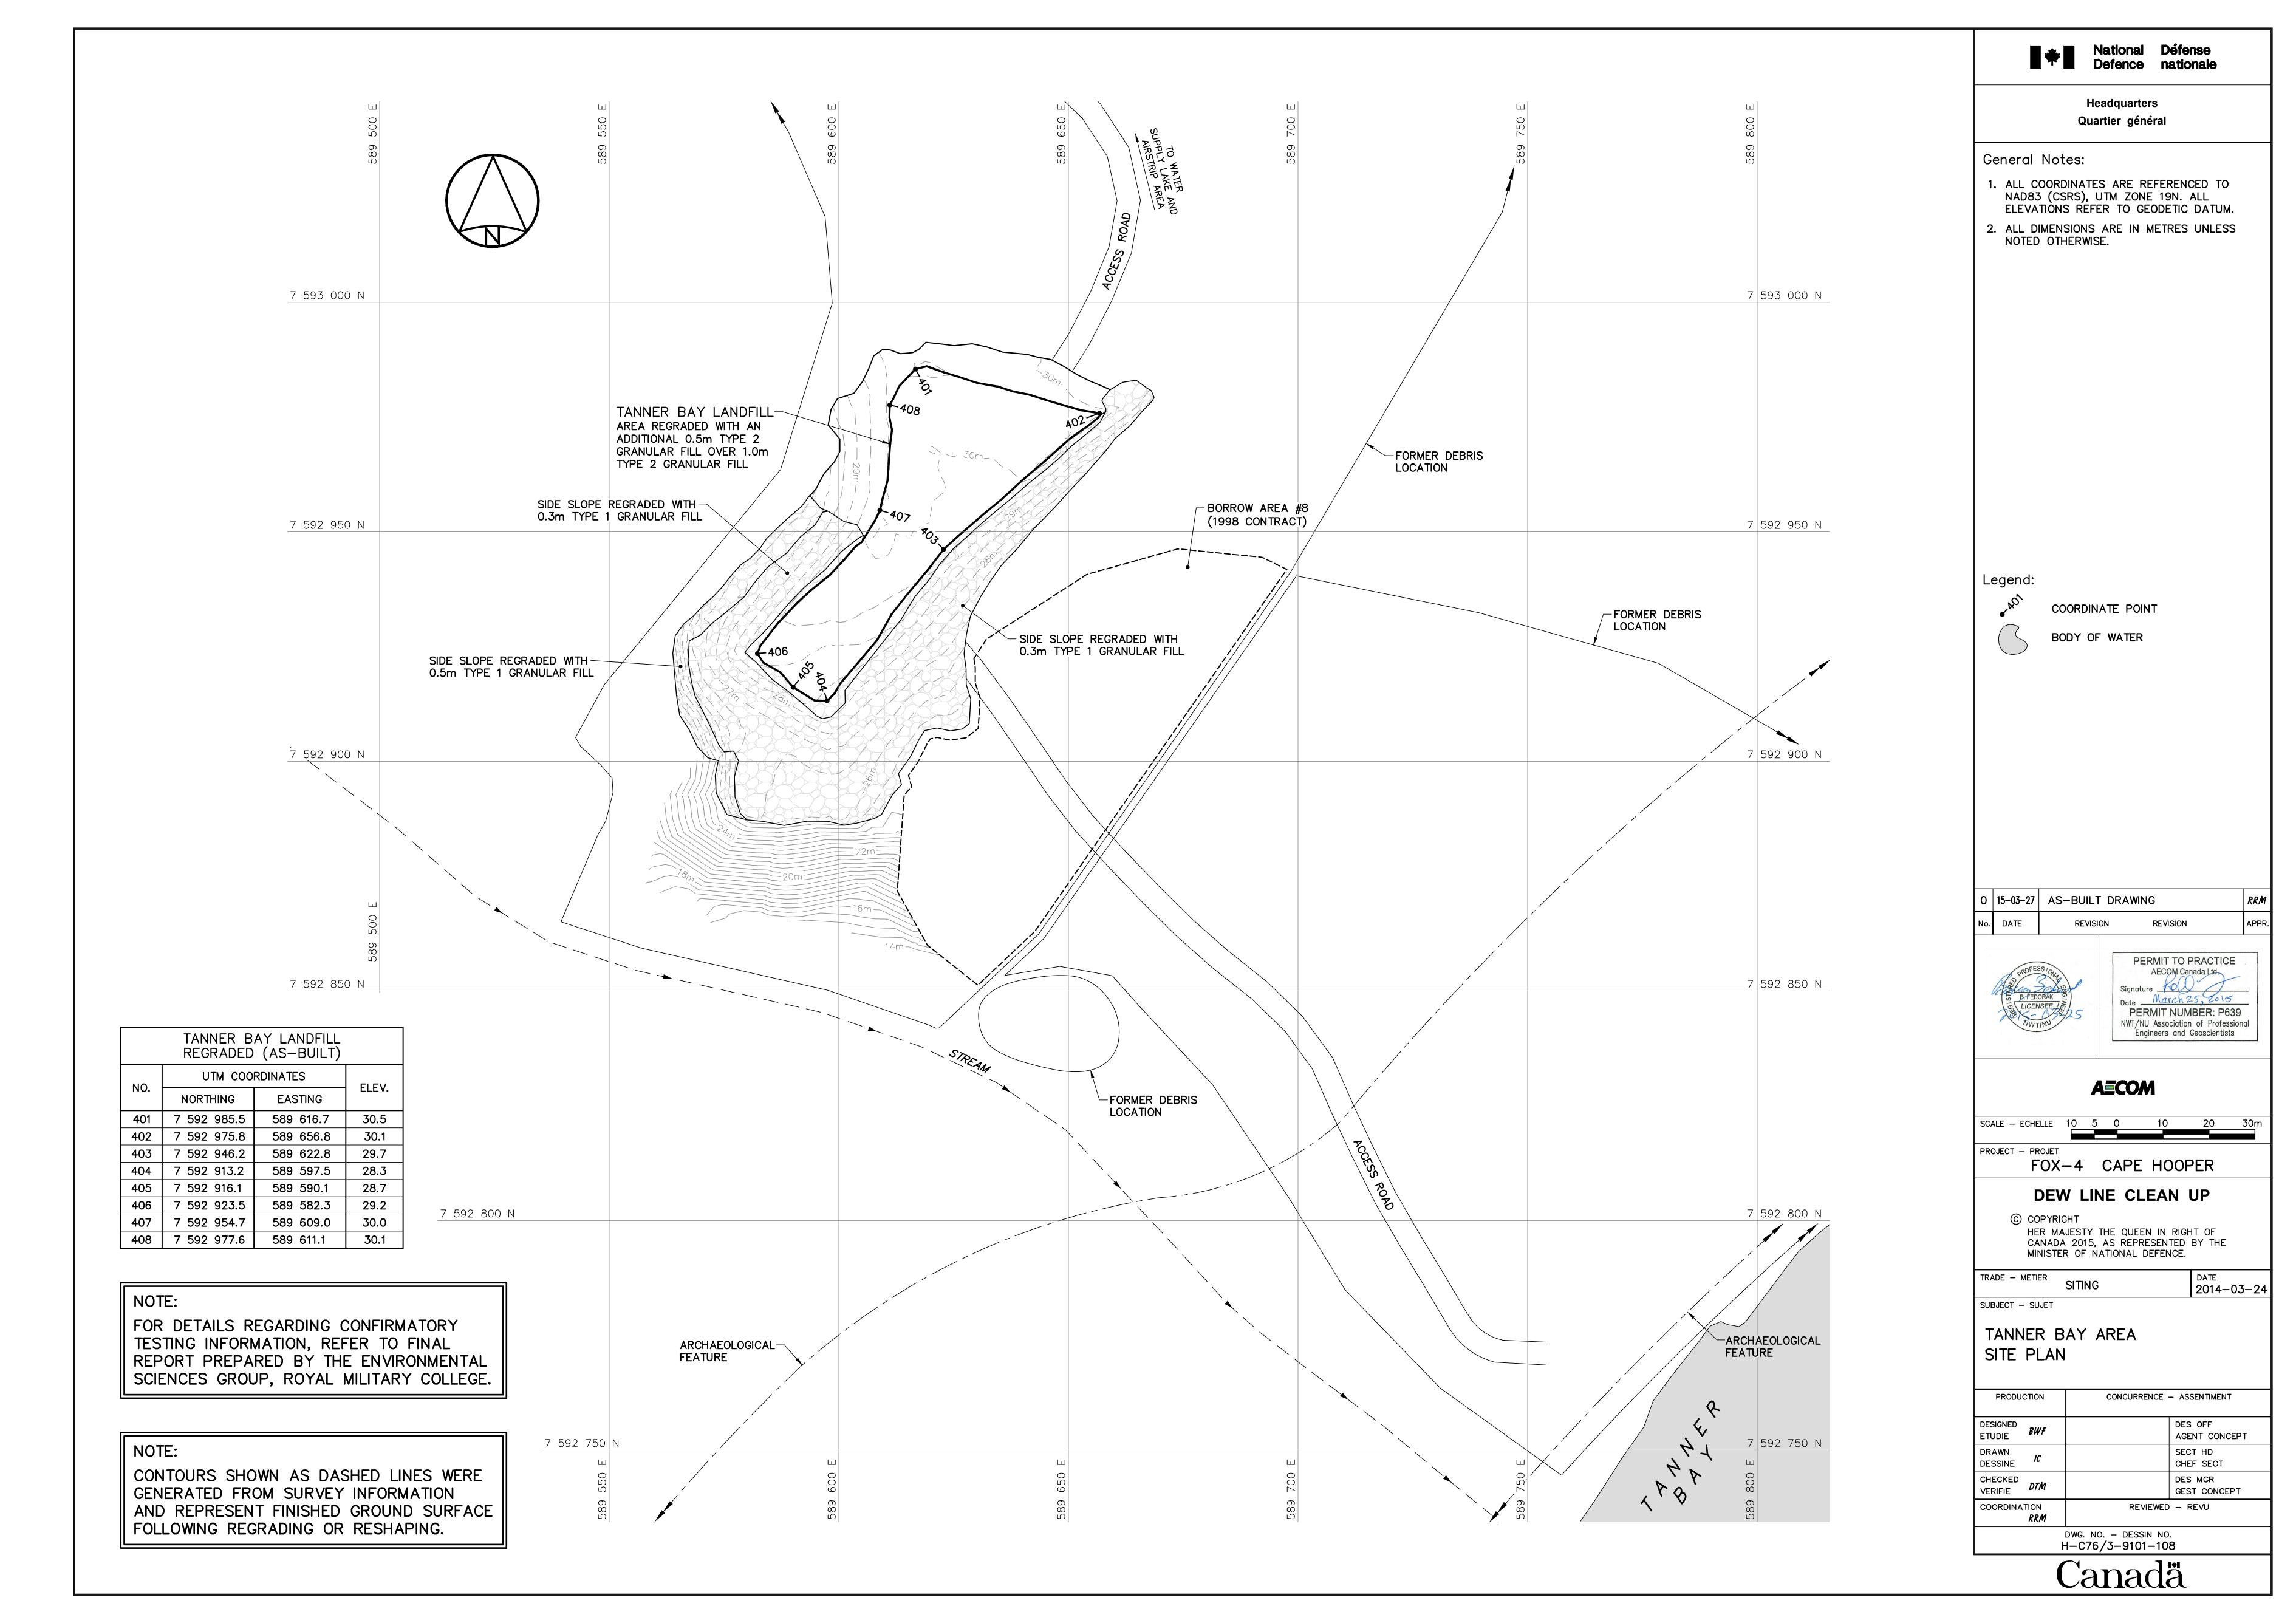
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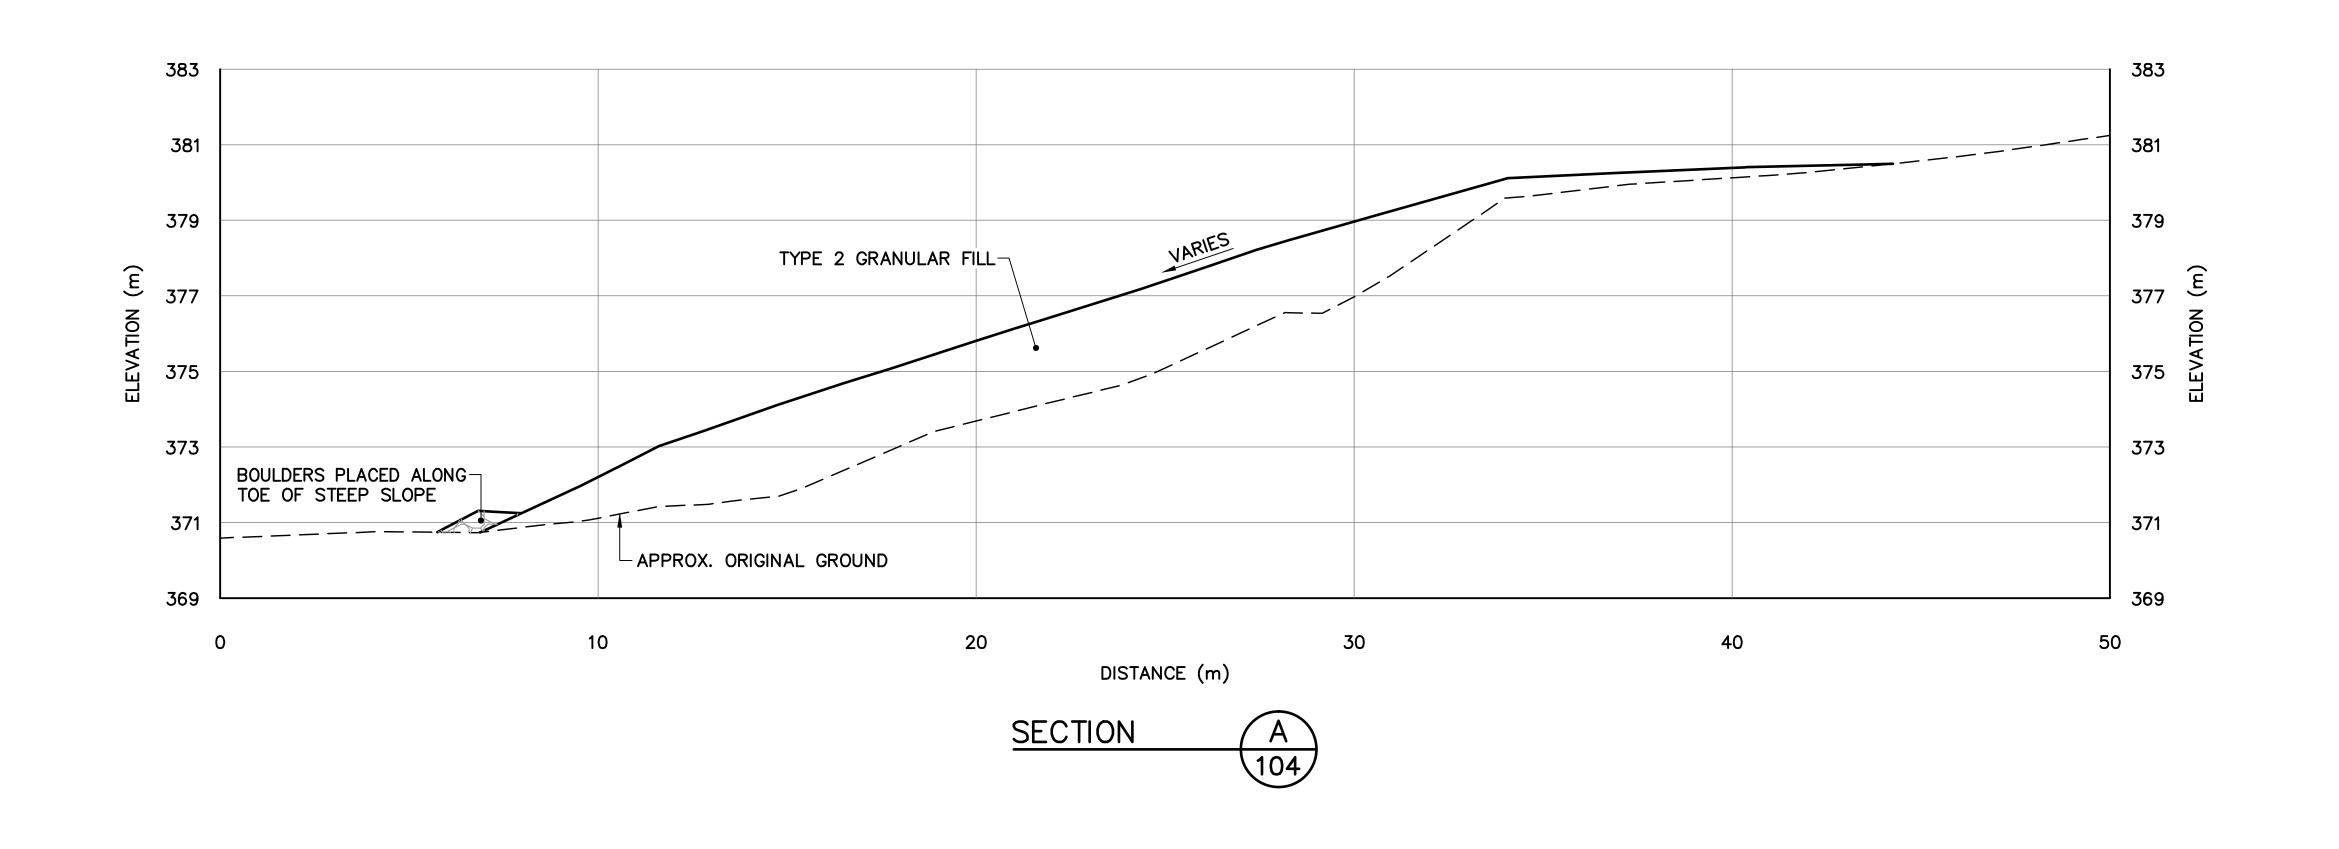
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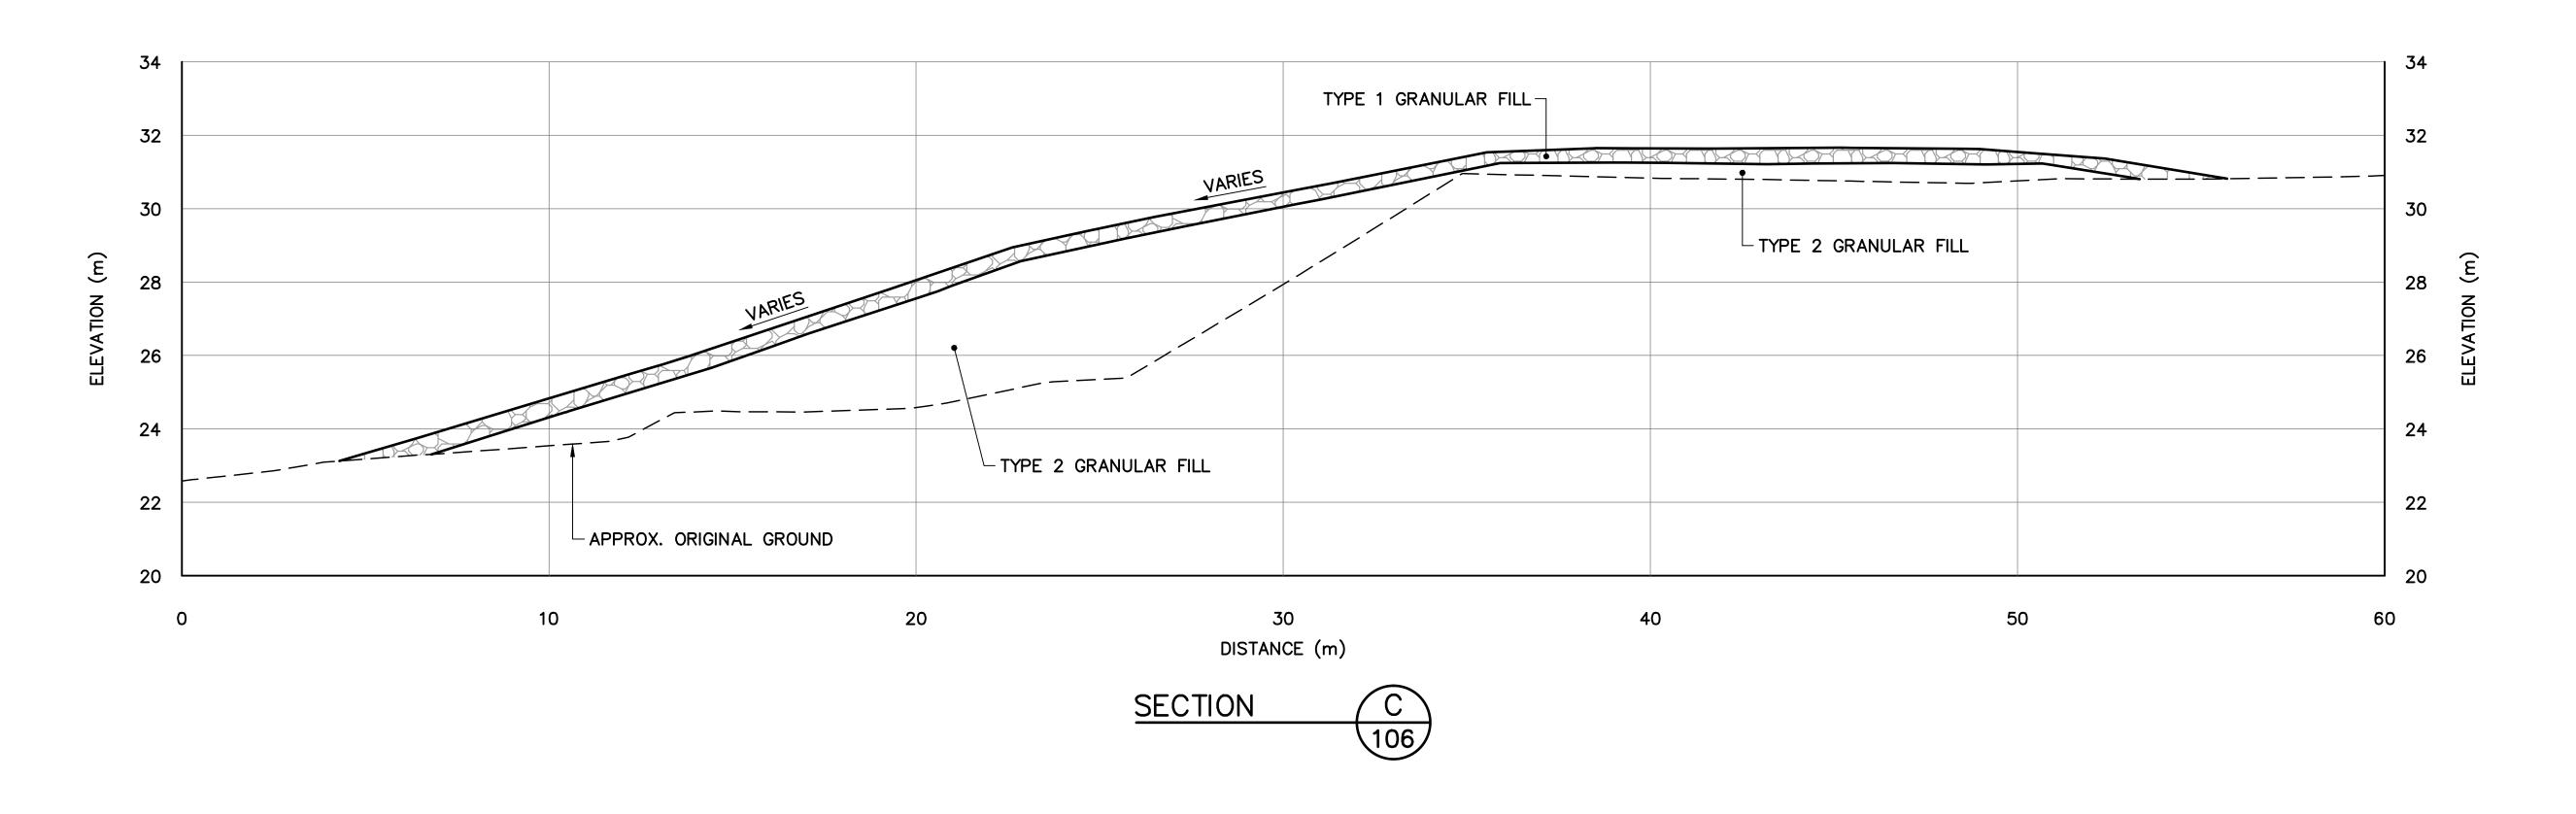








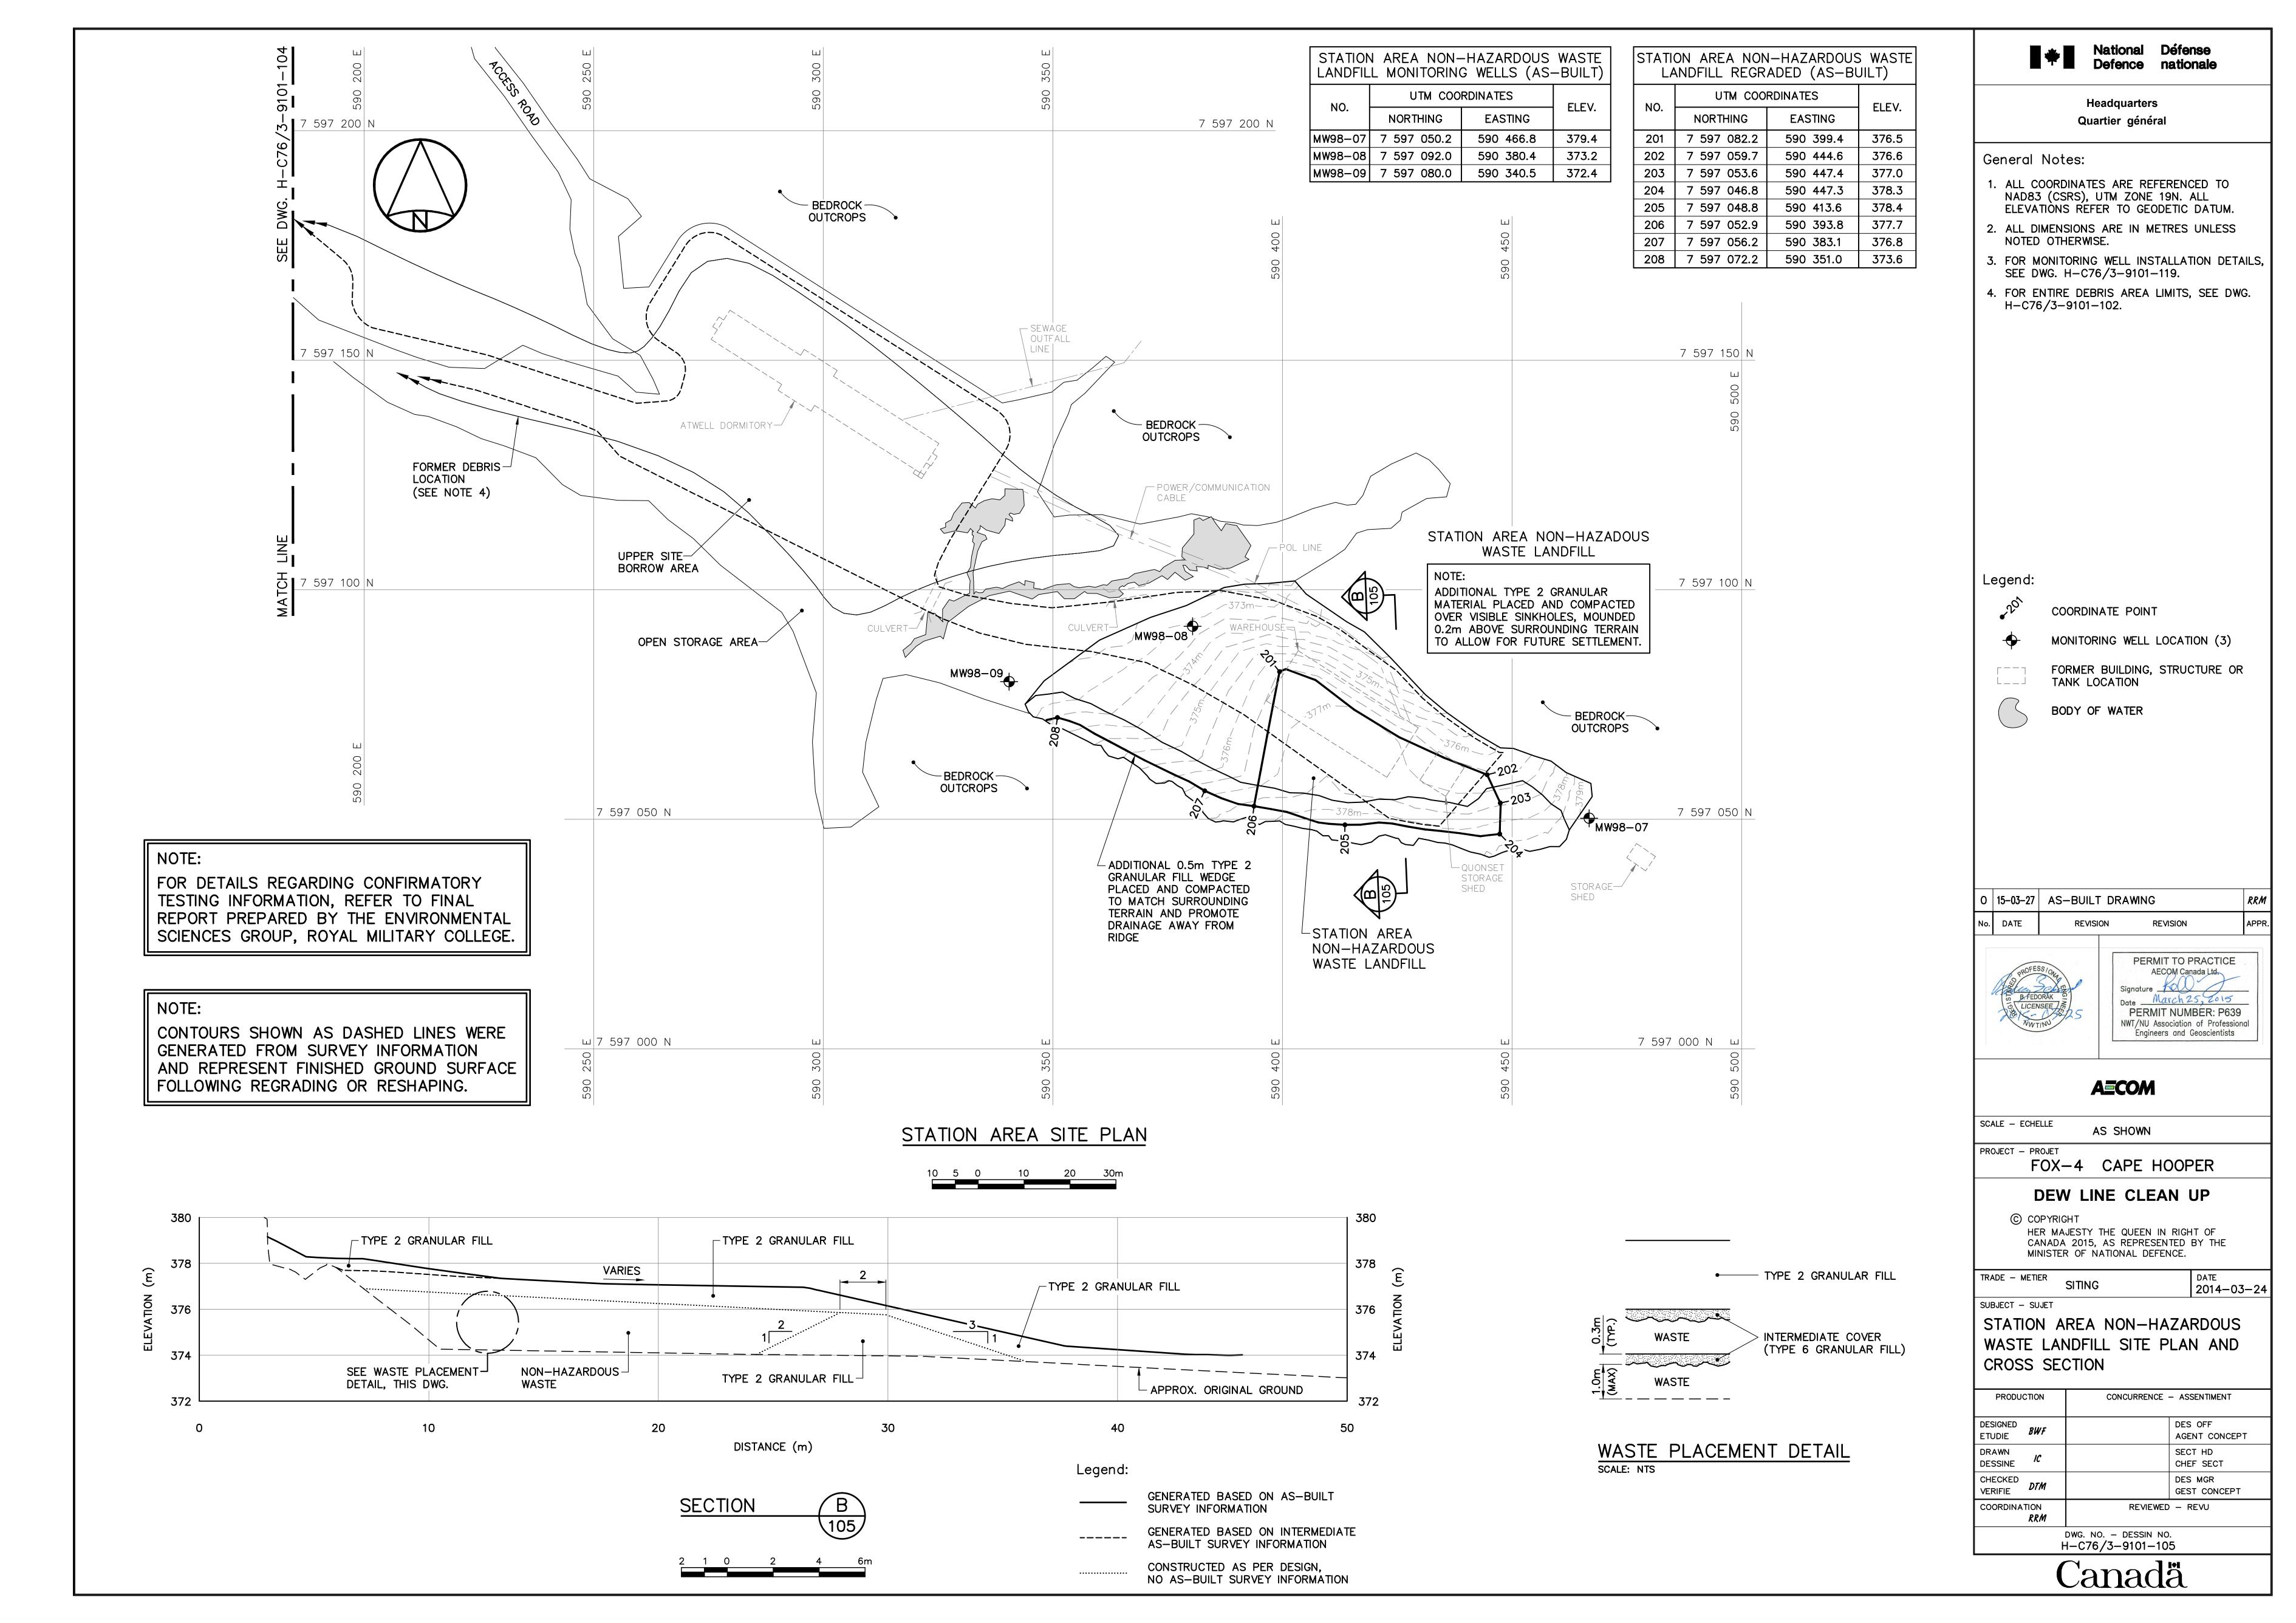

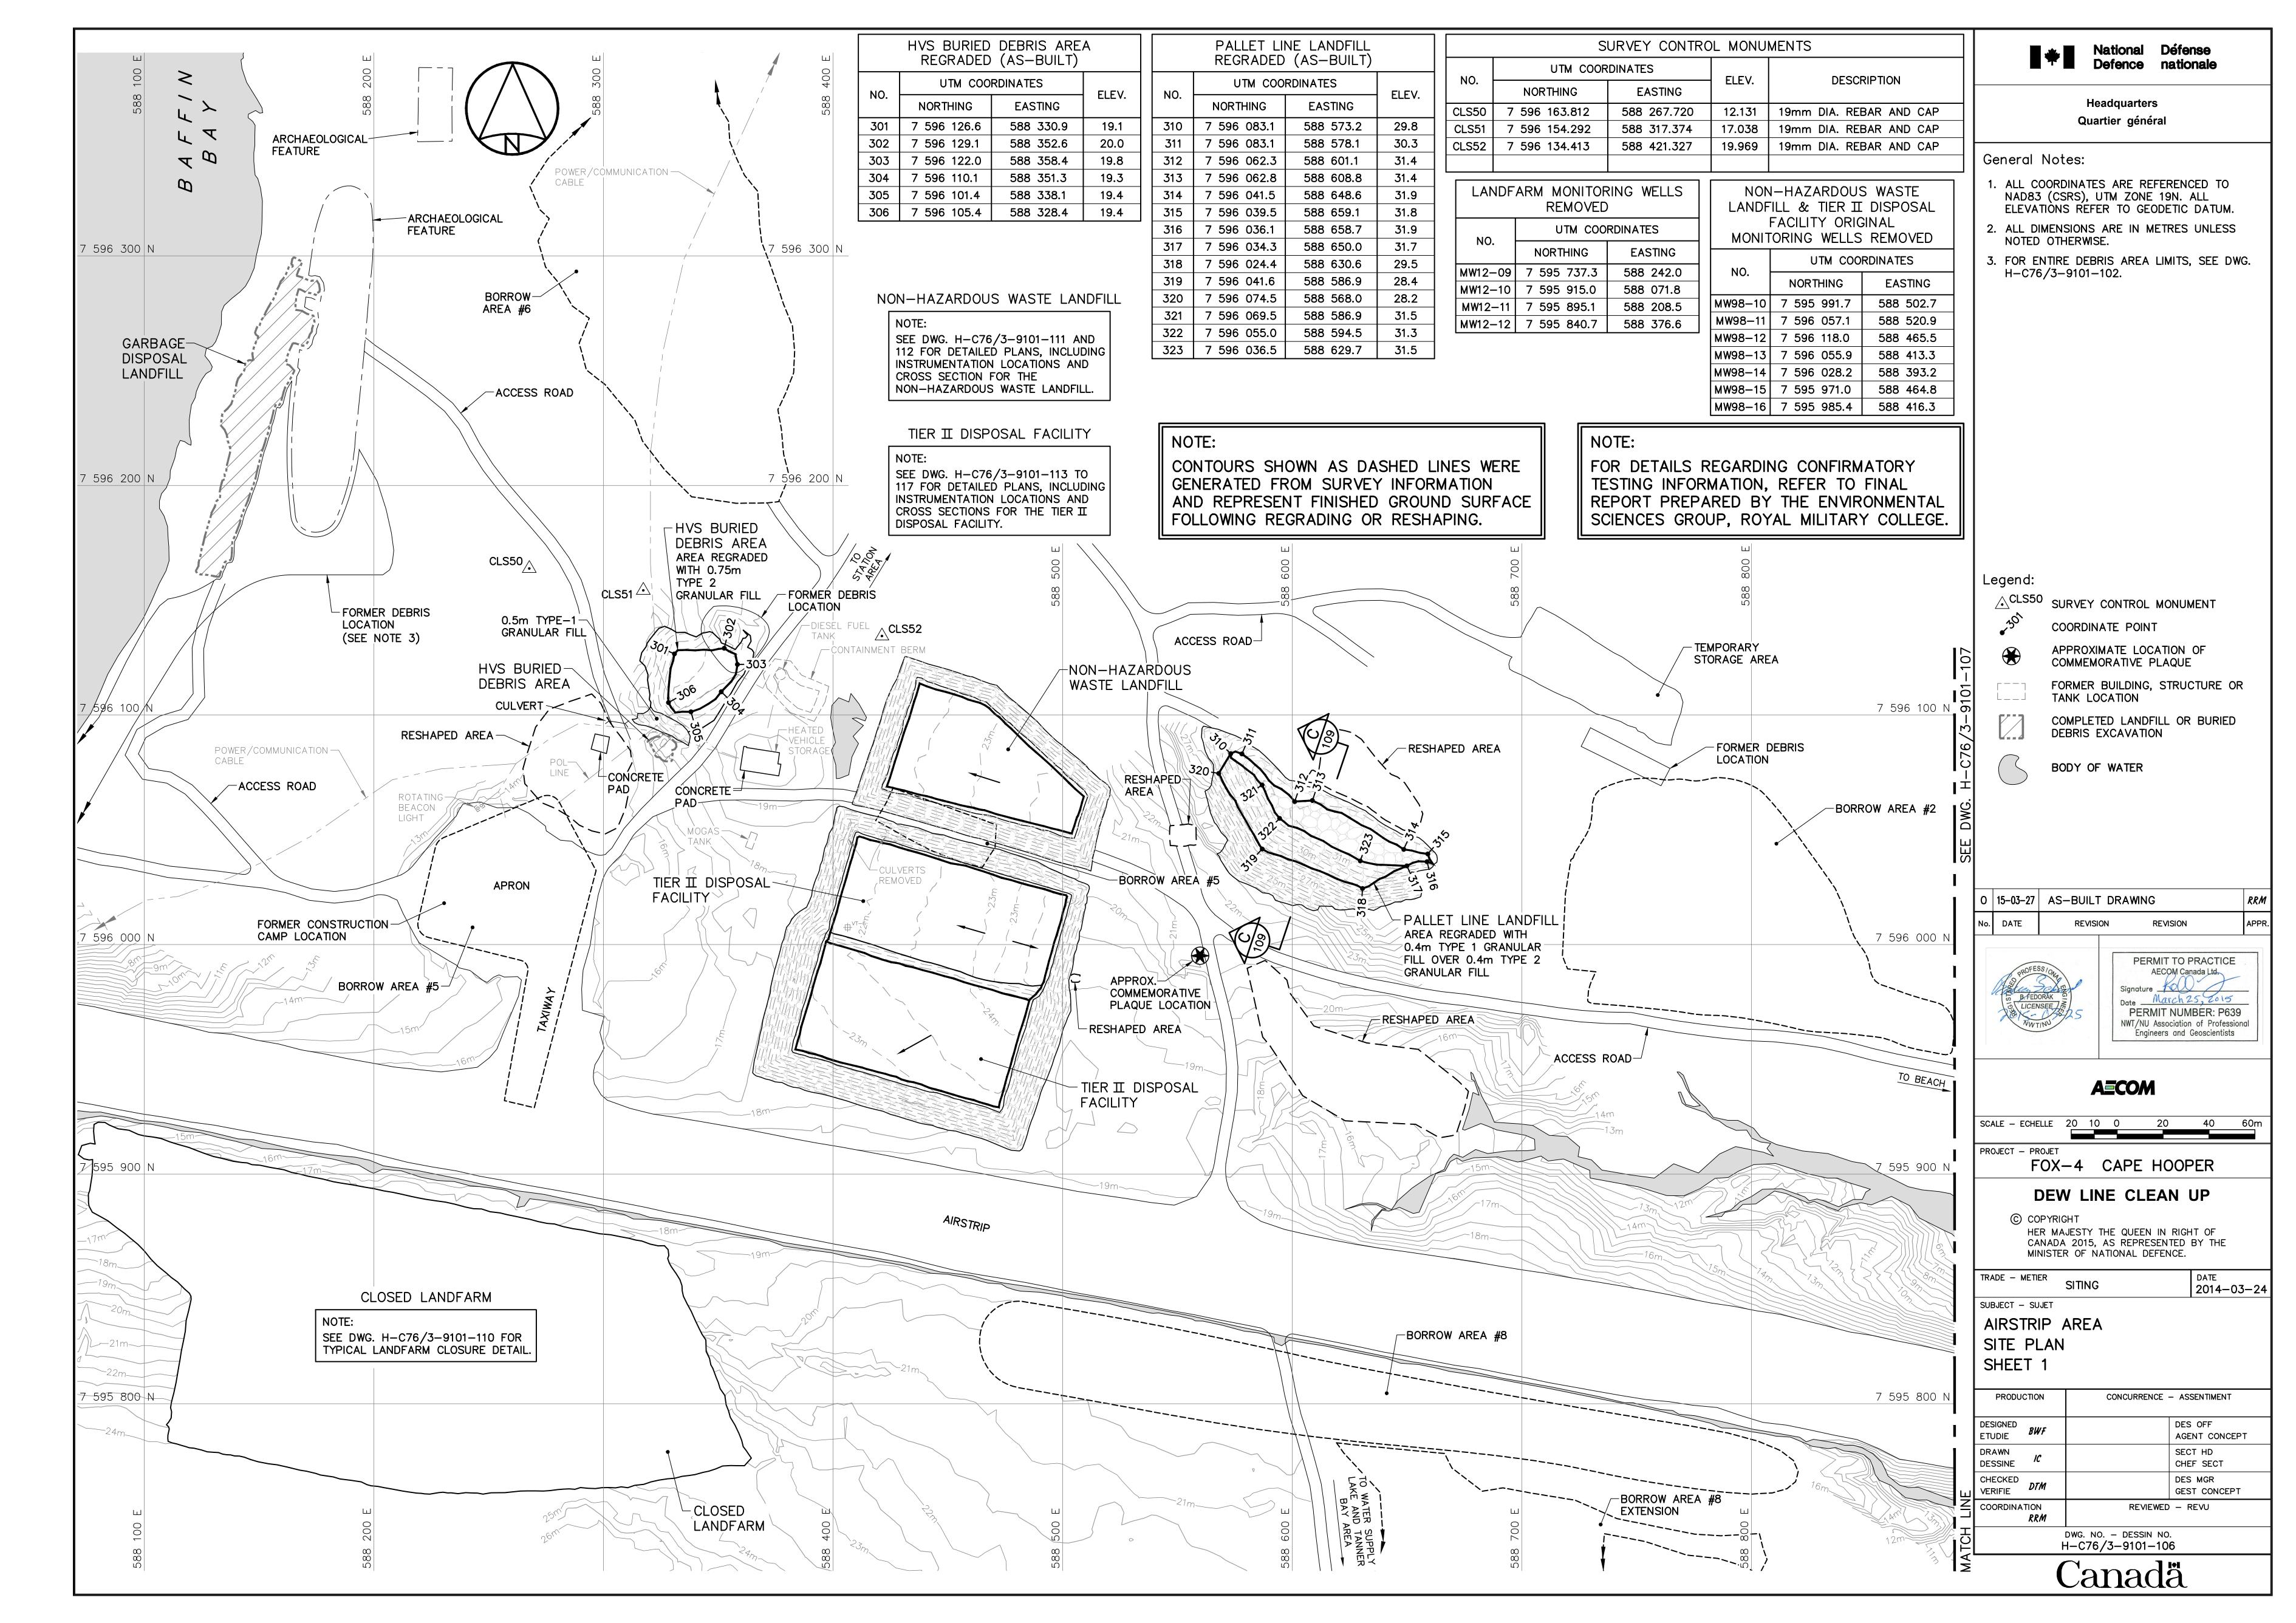




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- 2. ALL DIMENSIONS ARE IN METRES UNLESS NOTED OTHERWISE.

Legend:

GENERATED BASED ON AS-BUILT SURVEY INFORMATION



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PROJECT - PROJET
FOX-4 CAPE HOOPER

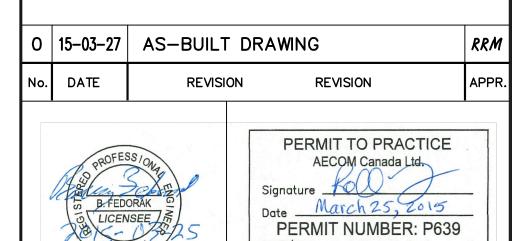DEW LINE CLEAN II

DEW LINE CLEAN UP

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TRADE - METIER


SUBJECT - SUJET

DATE 2014-03-24


HELIPAD LANDFILL—WEST
AND PALLET LINE LANDFILL

CROSS SECTIONS

PRODUCTION CONCURRENCE - ASSENTIMENT

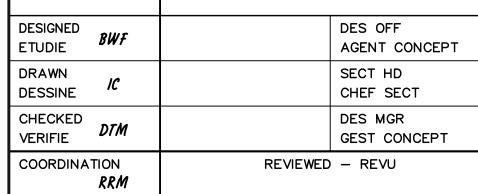

DWG. NO. - DESSIN NO. H-C76/3-9101-109

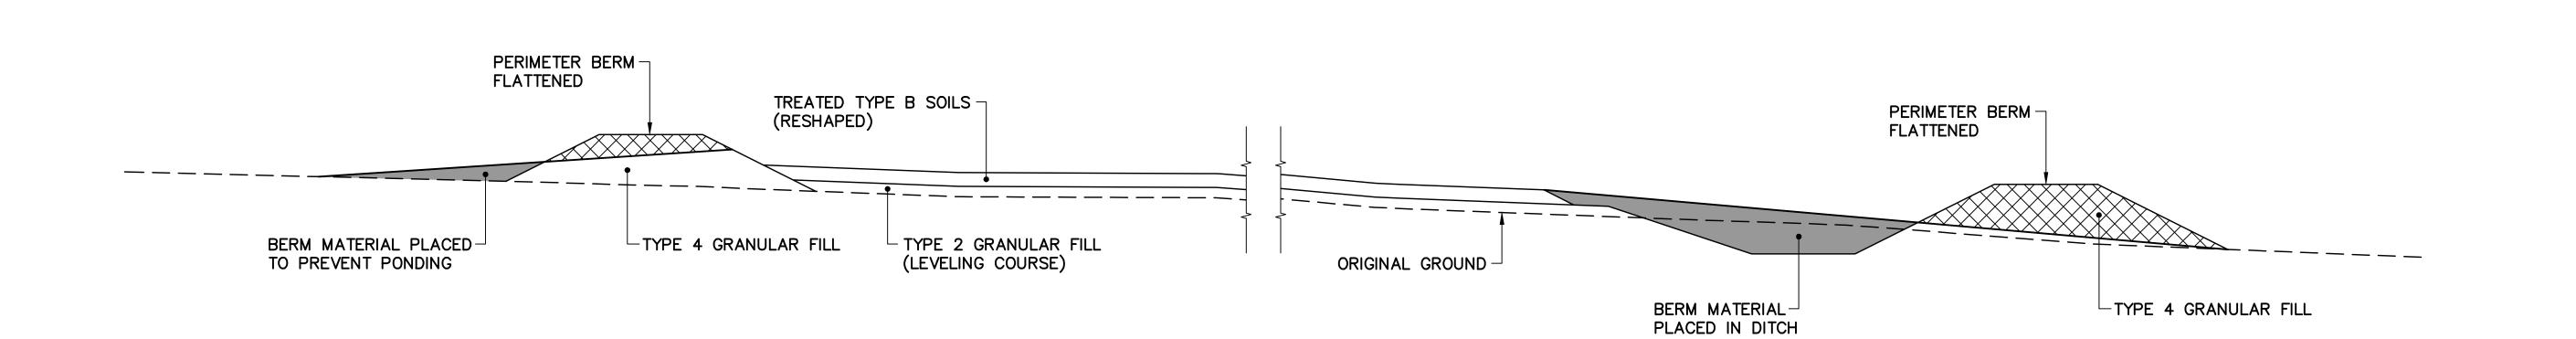

TYPICAL LANDFARM CLOSURE DETAIL SCALE: NTS




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- 2. ALL DIMENSIONS ARE IN METRES UNLESS NOTED OTHERWISE.

Legend:





AECOM Canada Ltd. Signature

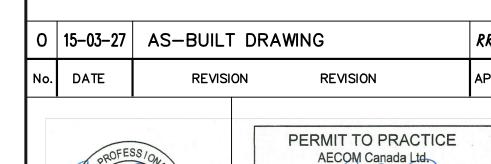Date

March 25, 2015

PERMIT NUMBER: P639

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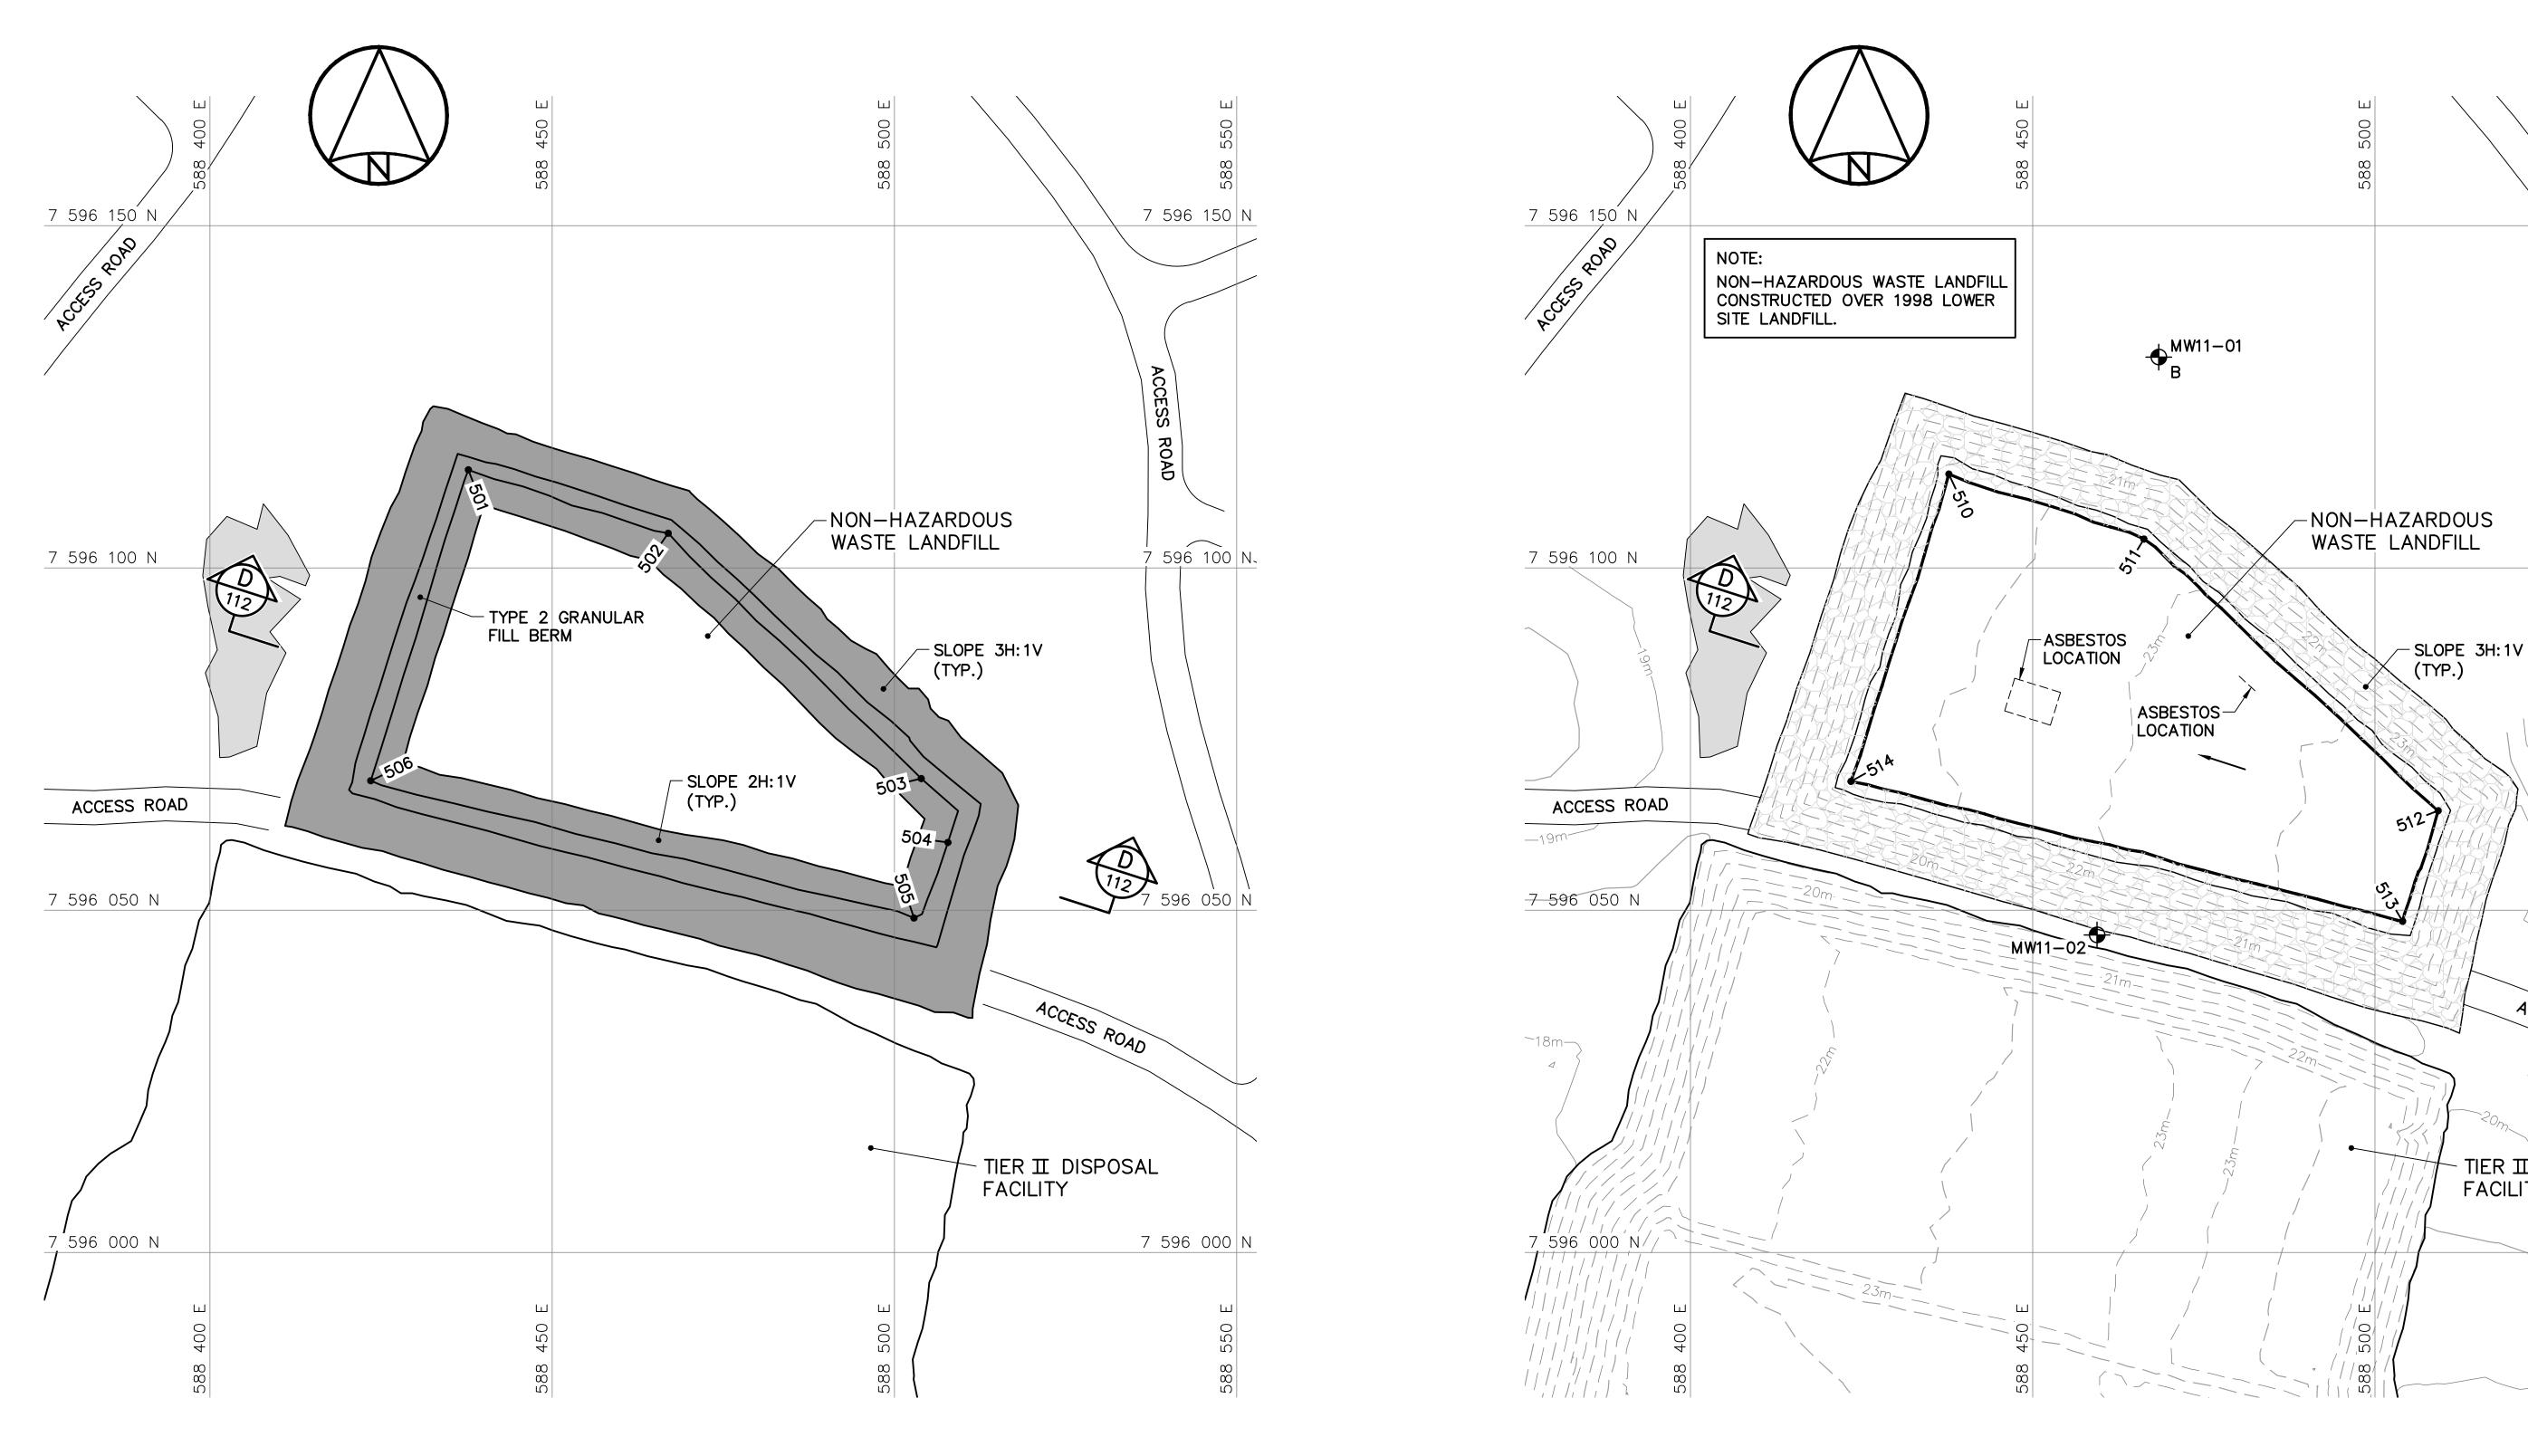
CANADA 2015, AS REPRESENTED BY THE MINISTER OF NATIONAL DEFENCE. TRADE - METIER DATE 2014-03-24 SITING

SUBJECT - SUJET TYPICAL LANDFARM

CLOSURE DETAIL

PRODUCTION CONCURRENCE - ASSENTIMENT DES OFF DESIGNED ETUDIE AGENT CONCEPT DRAWN SECT HD DESSINE CHEF SECT CHECKED DTM DES MGR GEST CONCEPT COORDINATION RRM REVIEWED - REVU

DWG. NO. - DESSIN NO. H-C76/3-9101-110



BERM CONSTRUCTION PLAN

NON-HAZARDOUS WASTE LANDFILL BERM CONSTRUCTION (AS-BUILT)					
NO.	UTM COORDINATES				
NO.	NORTHING	EASTING	ELEV.		
501	7 596 114.3	588 437.8	21.4		
502	7 596 105.1	588 466.9	22.1		
503	7 596 069.2	588 503.9	22.7		
504	7 596 059.9	588 507.8	22.9		
505	7 596 048.9	588 502.9	22.7		
506	7 596 068.9	588 423.5	21.3		

FOR DETAILS REGARDING CONFIRMATORY TESTING INFORMATION, REFER TO FINAL REPORT PREPARED BY THE ENVIRONMENTAL SCIENCES GROUP, ROYAL MILITARY COLLEGE.

CONTOURS SHOWN AS DASHED LINES WERE GENERATED FROM SURVEY INFORMATION AND REPRESENT FINISHED GROUND SURFACE FOLLOWING REGRADING OR RESHAPING.

NON-HAZARDOUS WASTE LANDFILL FINAL GRADING (AS-BUILT)

FINAL GRADING/INSTRUMENTATION PLAN

NO.	UTM COO	ELEV.	
NO.	NORTHING	EASTING	
510	7 596 113.7	588 437.8	22.1
511	7 596 104.2	588 466.2	22.8
512	7 596 064.6	588 509.2	23.9
513	7 596 048.4	588 504.0	23.9
514	7 596 068.8	588 423.5	22.1

COORDINATE POINTS AND ELEVATIONS PROVIDED ARE TO THE FINAL GRADE OF THE TYPE 2 GRANULAR FILL CAP PRIOR TO THE PLACEMENT OF THE TYPE 1 GRANULAR FILL ON THE SIDE SLOPES.

NON-HAZARDOUS WASTE LANDFILL MONITORING WELLS (AS-BUILT)					
NO.	UTM COO	ELEV.			
	NORTHING	EASTING			
W11-01	7 596 130.8	588 468.4	21.0		

588 459.4

19.5

MW11-02 7 596 046.4

MW11-03 7 596 025.9 588 524.3



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Headquarters Quartier général

General Notes:

7 596 150 N

7 596 100 N

7 596 050 N

7 596 000 N

588 550 E

₩W11-03


TIER II DISPOSAL

FACILITY

- 1. ALL COORDINATES ARE REFERENCED TO NAD83 (CSRS), UTM ZONE 19N. ALL ELEVATIONS REFER TO GEODETIC DATUM.
- 2. ALL DIMENSIONS ARE IN METRES UNLESS NOTED OTHERWISE.
- 3. FOR MONITORING WELL INSTALLATION DETAILS, SEE DWG. H-C76/3-9101-119.
- 4. VARIABLE SLOPE ON LANDFILL SURFACE, MINIMUM 2%-MAXIMUM 4%.




COORDINATE POINT

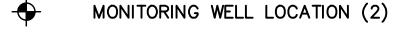


BACKGROUND MONITORING WELL LOCATION (1)



BODY OF WATER

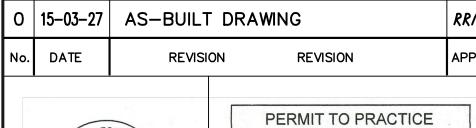

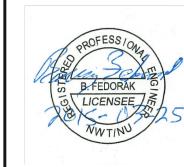

AECOM Canada Ltd. Signature KOO

Date March 25, 2015 PERMIT NUMBÉR: P639 NWT/NU Association of Professional Engineers and Geoscientists

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SCALE - ECHELLE 10 5 0 10 20 30m PROJECT - PROJET FOX-4 CAPE HOOPER

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TRADE - METIER DATE 2014-03-24

SUBJECT - SUJET

NON-HAZARDOUS WASTE LANDFILL BERM CONSTRUCTION PLAN AND GRADING/INSTRUMENTATION PLAN

PRODUCTION		CONCURRENCE - ASSENTIMENT	
DESIGNED ETUDIE	BWF		DES OFF AGENT CONCEPT
DRAWN DESSINE	IC		SECT HD CHEF SECT
CHECKED VERIFIE	DTM		DES MGR GEST CONCEPT
COORDINATION RRM		REVIEWED	- REVU

DWG. NO. - DESSIN NO. H-C76/3-9101-111

WASTE

WASTE


WASTE


INTERMEDIATE COVER
(TYPE 6 GRANULAR FILL)

WASTE

WASTE PLACEMENT DETAIL
SCALE: NTS

NOTE:
NON-HAZARDOUS WASTE LANDFILL
CONSTRUCTED OVER 1998 LOWER
SITE LANDFILL.

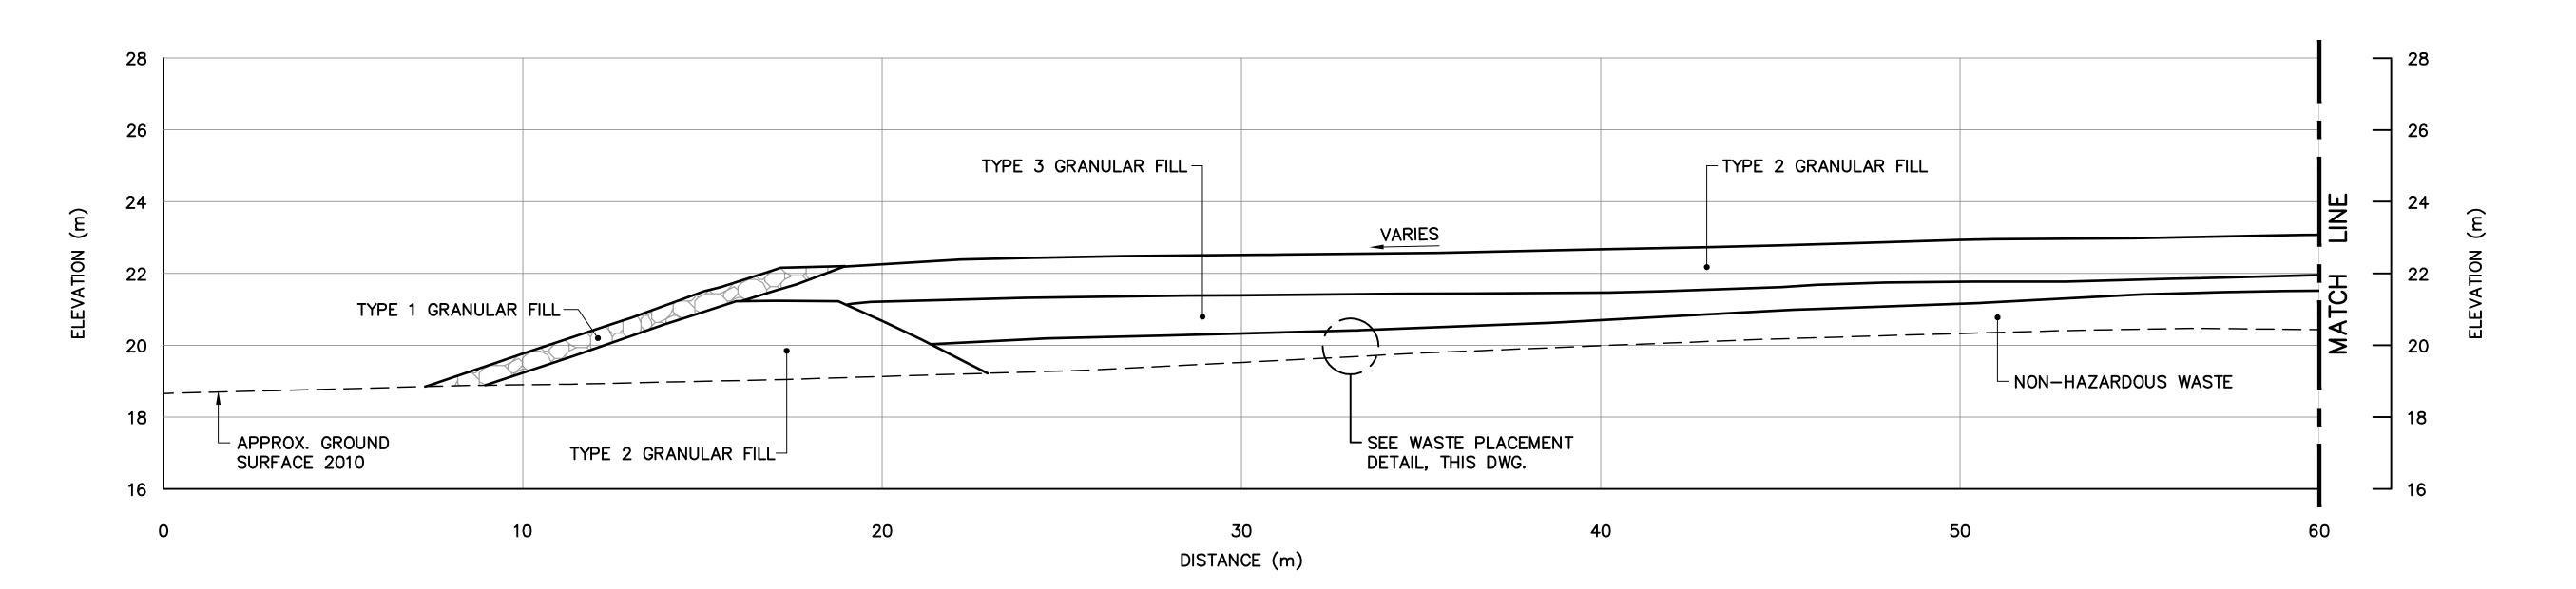

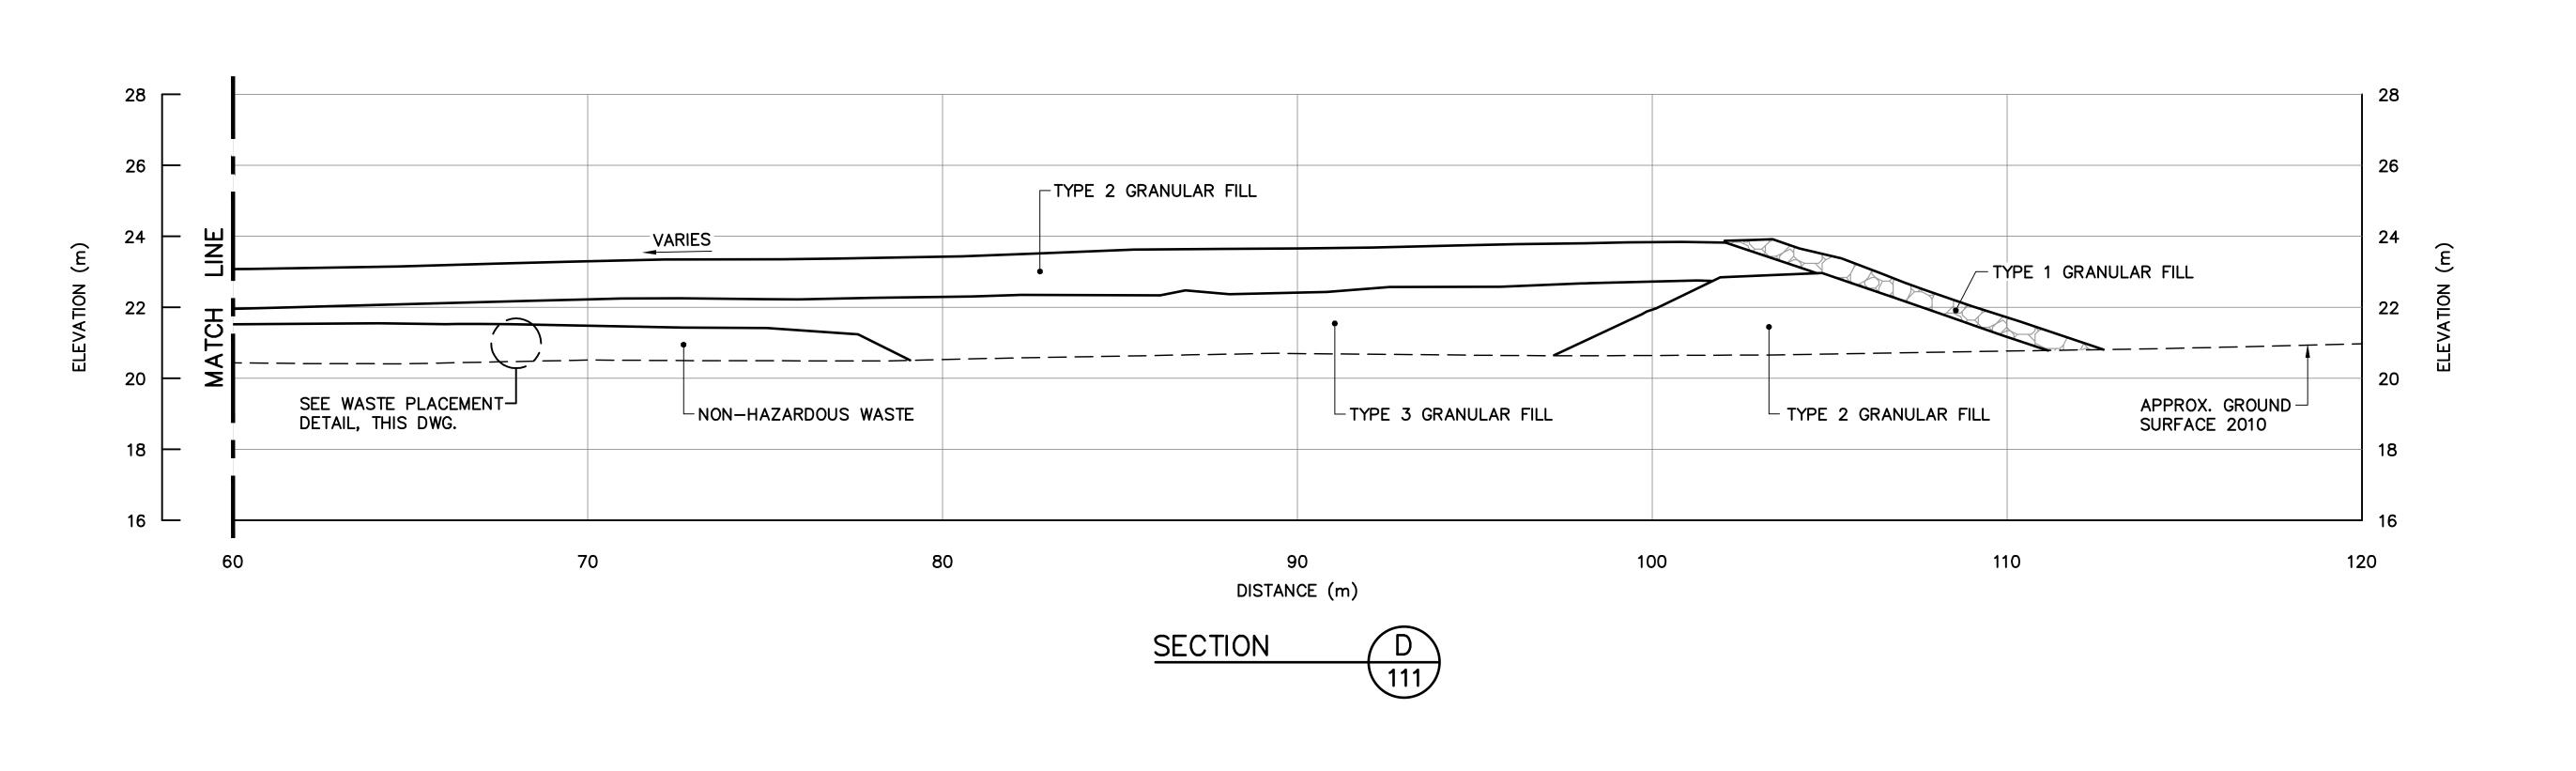



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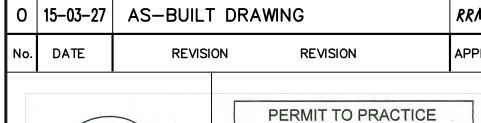
Headquarters Quartier général


General Notes:

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- 2. ALL DIMENSIONS ARE IN METRES UNLESS NOTED OTHERWISE.
- 3. VARIABLE SLOPE ON LANDFILL SURFACE, MINIMUM 2%-MAXIMUM 4%.

Legend:

GENERATED BASED ON AS-BUILT SURVEY INFORMATION



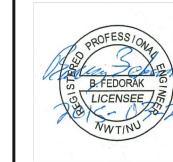

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Signature House March 25, 2015

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SUBJECT - SUJET

NON-HAZARDOUS WASTE LANDFILL

2014-03-24

CROSS SECTION AND DETAIL

DESIGNED BWF
ETUDIE

DESIGNED BWF
ETUDIE

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AGENT CONCEPT

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CHECKED DTM

COORDINATION

CONCURRENCE — ASSENTIMENT

DES OFF
AGENT CONCEPT


AGENT CONCEPT

DES MGR
GEST CONCEPT

REVIEWED — REVU

COORDINATION REV

DWG. NO. - DESSIN NO. H-C76/3-9101-112

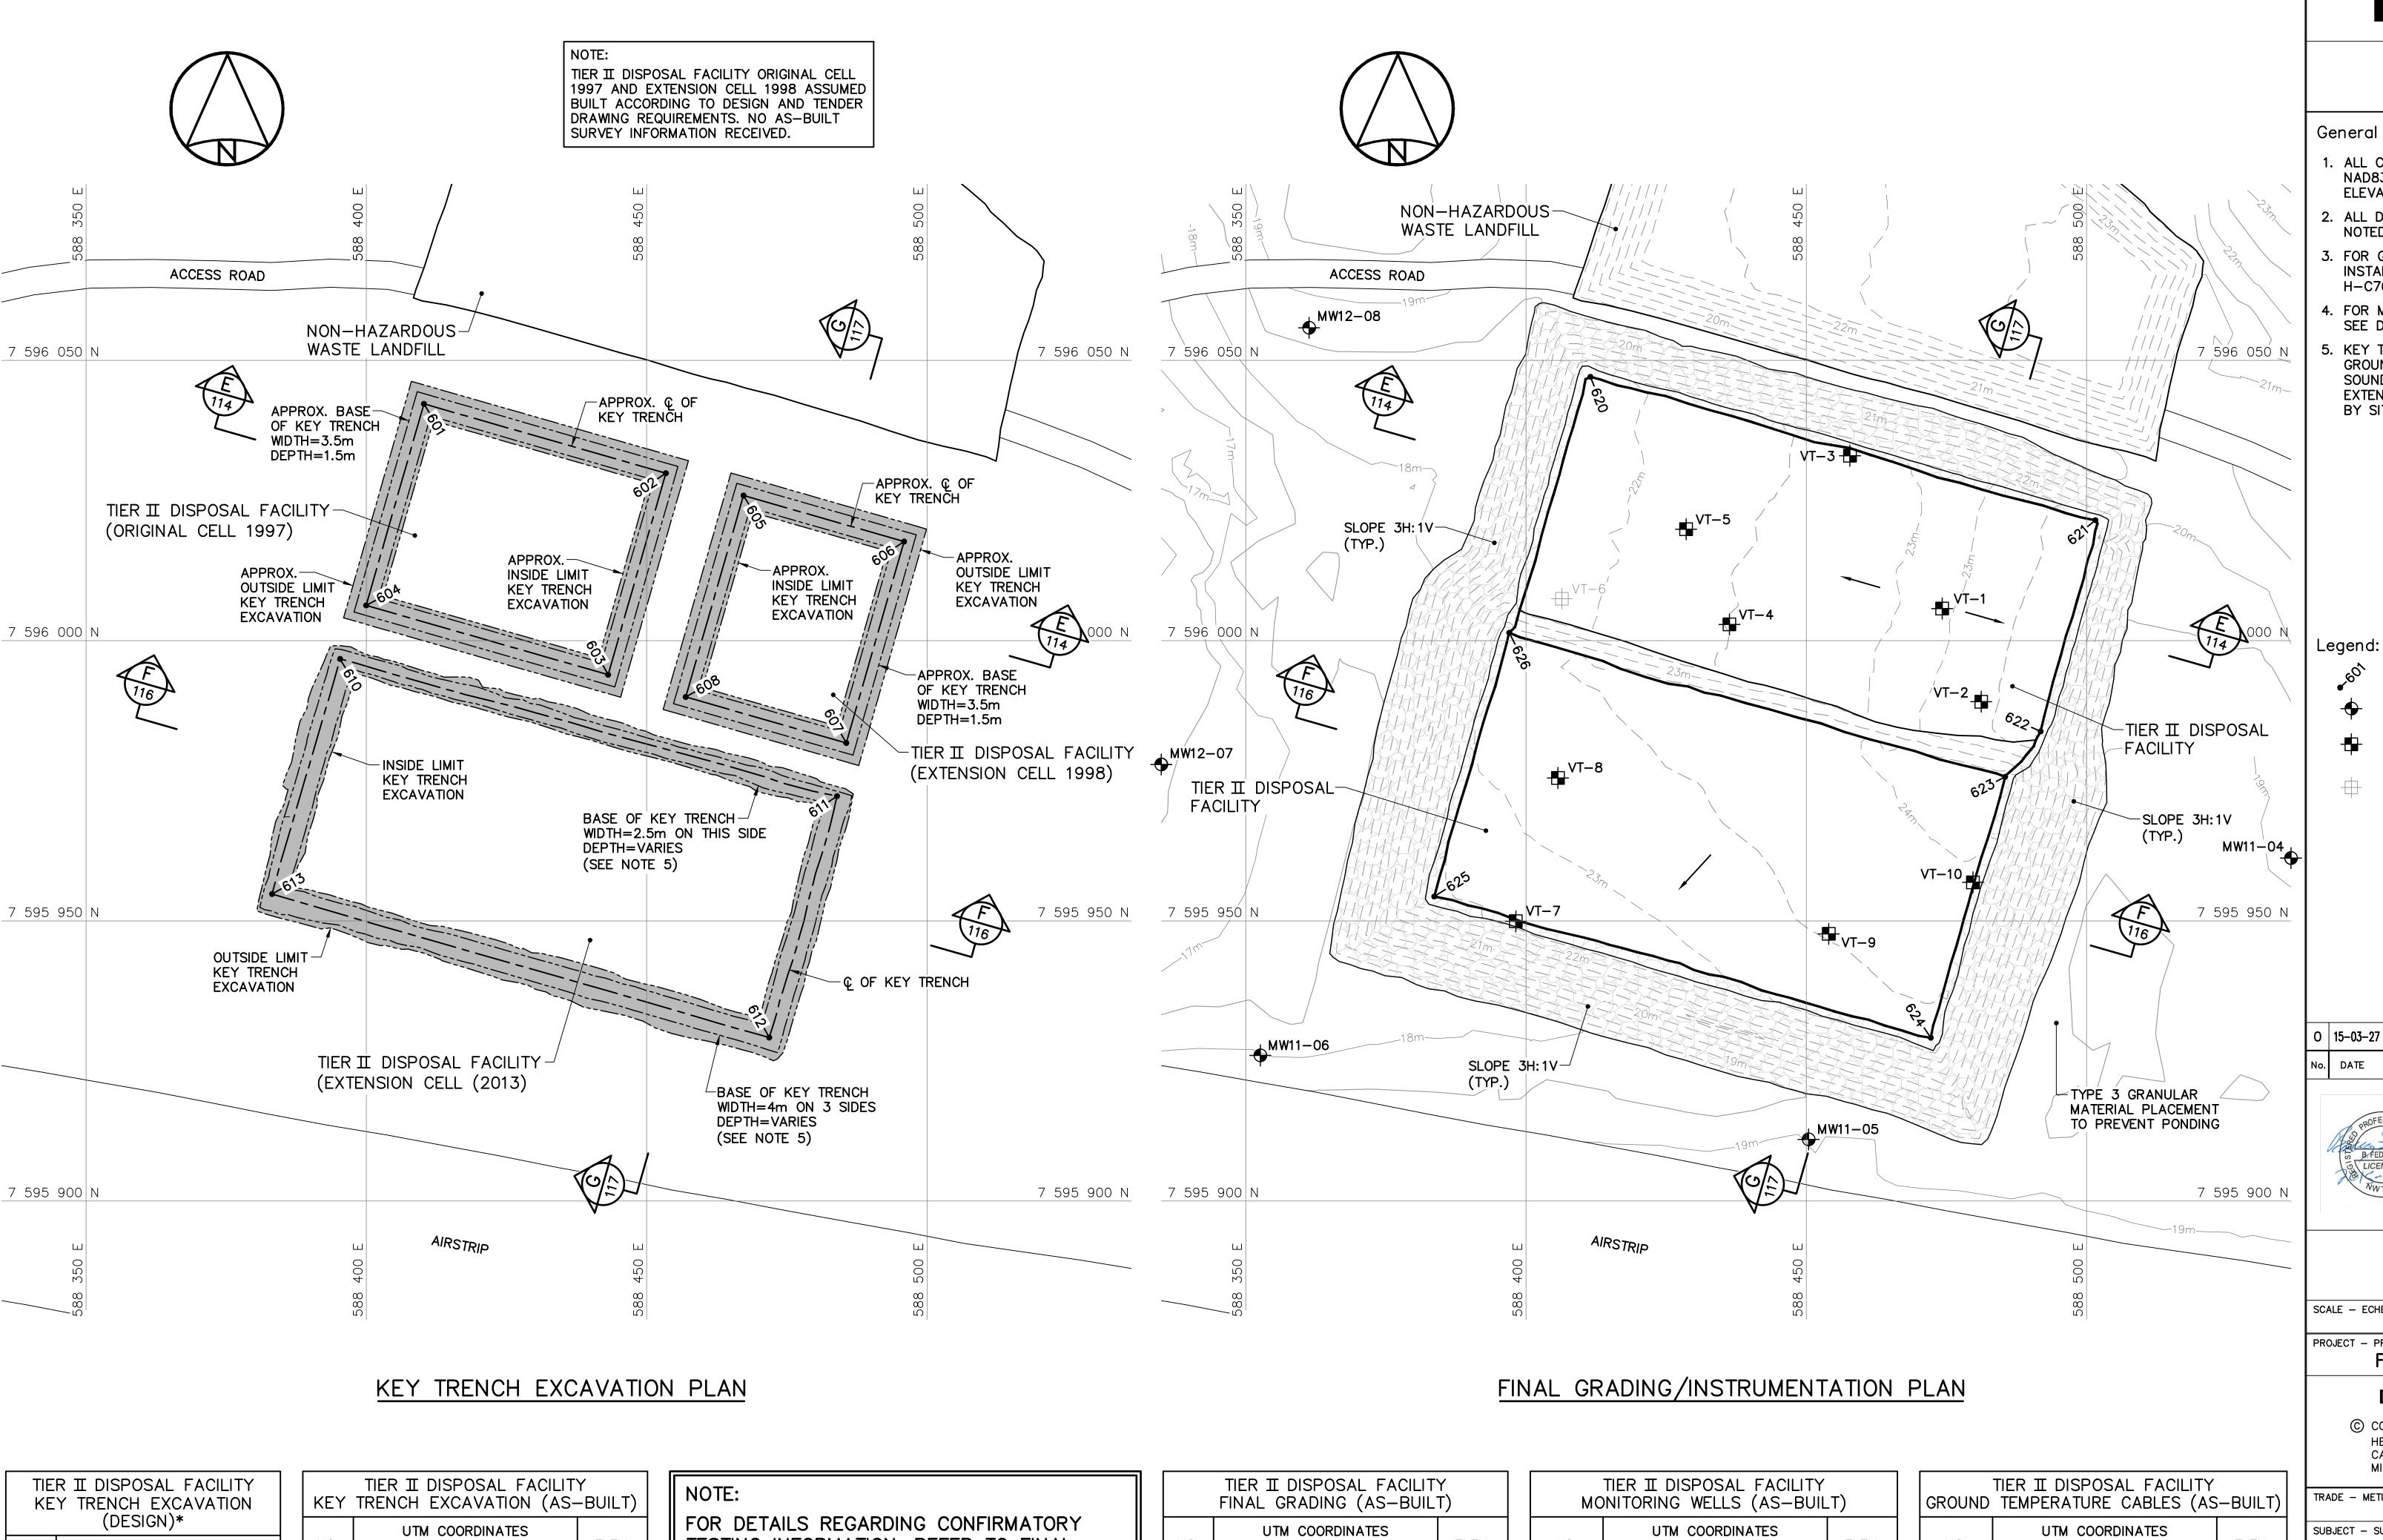

TIER II DISPOSAL FACILITY KEY TRENCH EXCAVATION (DESIGN)*					
	`	Z RDINATES			
NO.	NORTHING	EASTING			
601	7 596 042.2	588 410.3			
602	7 596 029.9	588 453.4			
603	7 595 993.9	588 443.1			
604	7 596 006.3	588 400.0			
605	7 596 025.9	588 467.3			
606	7 596 017.7	588 495.9			
607	7 595 981.7	588 485.6			
608	7 595 989.9	588 457.0			

* NOTE: NO AS-BUILT SURVEY INFORMATION.

RET TRENOTT EXORTERNION (NO BOILT)					
NO.	UTM COO	ELEV.			
	NORTHING EASTING				
610	7 595 996.7	588 395.3	17.5		
611	7 595 972.3	588 484.0	17.7		
612	7 595 929.2	588 471.9	17.4		
613	7 595 954.8	588 383.2	16.4		

TESTING INFORMATION, REFER TO FINAL REPORT PREPARED BY THE ENVIRONMENTAL SCIENCES GROUP, ROYAL MILITARY COLLEGE.

NOTE:

CONTOURS SHOWN AS DASHED LINES WERE GENERATED FROM SURVEY INFORMATION AND REPRESENT FINISHED GROUND SURFACE FOLLOWING REGRADING OR RESHAPING.

TIER II DISPOSAL FACILITY FINAL GRADING (AS-BUILT)					
NO.	UTM COO				
INO.	NORTHING	EASTING	ELEV.		
620	7 596 047.1	588 411.5	21.7		
621	7 596 021.5	588 501.6	22.1		
622	7 595 983.8	588 491.8	22.1		
623	7 595 975.7	588 485.5	24.3		
624	7 595 929.1	588 472.2	23.3		
625	7 595 954.3	588 383.6	22.3		
626	7 596 001.4	588 397.0	23.2		

COORDINATE POINTS AND ELEVATIONS PROVIDED ARE TO THE FINAL GRADE OF THE TYPE 2 GRANULAR FILL CAP PRIOR TO THE PLACEMENT OF

THE TYPE 1 GRANULAR FILL ON THE SIDE SLOPES.

NO	UTM COO		
NO.	NORTHING	EASTING	ELEV.
MW11-04	7 595 961.2	588 536.5	19.2
MW11-05	7 595 911.0	588 450.4	18.6
MW11-06	7 595 926.0	588 352.6	18.0
MW12-07	7 595 977.9	588 334.9	16.4
MW12-08	7 596 055.8	588 361.3	18.7

GROUND	TEMPERATURE CABLES (AS-BUILT)				
NO	UTM COO				
NO.	NORTHING	EASTING	ELEV.		
VT-1	7 596 005.7	588 474.2	23.1		
VT-2	7 595 989.1	588 481.2	22.6		
VT-3	7 596 033.0	588 457.8	22.7		
VT-4	7 596 002.9	588 436.3	22.5		
VT-5	7 596 019.9	588 428.6	22.3		
* VT-6	7 596 007.5	588 406.4	_		
VT-7	7 595 949.9	588 398.2	22.4		
VT-8	7 595 975.5	588 405.7	23.2		
VT-9	7 595 947.7	588 454.0	23.5		
VT-10	7 595 956.9	588 479.7	23.9		

* NOTE: INSTALLATION DECOMMISSIONED IN 2013



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- 3. FOR GROUND TEMPERATURE CABLE INSTALLATION DETAILS, SEE DWG. H-C76/3-9101-118.
- 4. FOR MONITORING WELL INSTALLATION DETAILS, SEE DWG. H-C76/3-9101-119.
- 5. KEY TRENCH EXCAVATED TO SATURATED GROUND, ICE SATURATED PERMAFROST OR SOUND BEDROCK. KEY TRENCH FOR EXTENSION CELL 2013 WAS FIELD CONFIRMED BY SITE ENGINEER.

COORDINATE POINT

MONITORING WELL LOCATION (5)

GROUND TEMPERATURE CABLE LOCATION (9)

GROUND TEMPERATURE CABLE DECOMMISSIONED IN 2013 (1)

0 15-03-27 AS-BUILT DRAWING REVISION

PERMIT TO PRACTICE


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DATE 2014-03-24

Signature Kolly Date March 25, 2015



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TRADE - METIER SITING

SUBJECT - SUJET

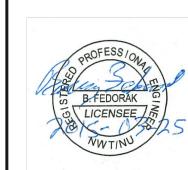TIER II DISPOSAL FACILITY KEY TRENCH EXCAVATION PLAN & GRADING/INSTRUMENTATION PLAN


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DWG. NO. - DESSIN NO.

H-C76/3-9101-113Canadä

REVIEWED - REVU

NOTE: TIER II DISPOSAL FACILITY ORIGINAL CELL 1997 AND EXTENSION CELL 1998 ASSUMED BUILT ACCORDING TO DESIGN AND TENDER DRAWING REQUIREMENTS. NO AS-BUILT SURVEY INFORMATION RECEIVED.



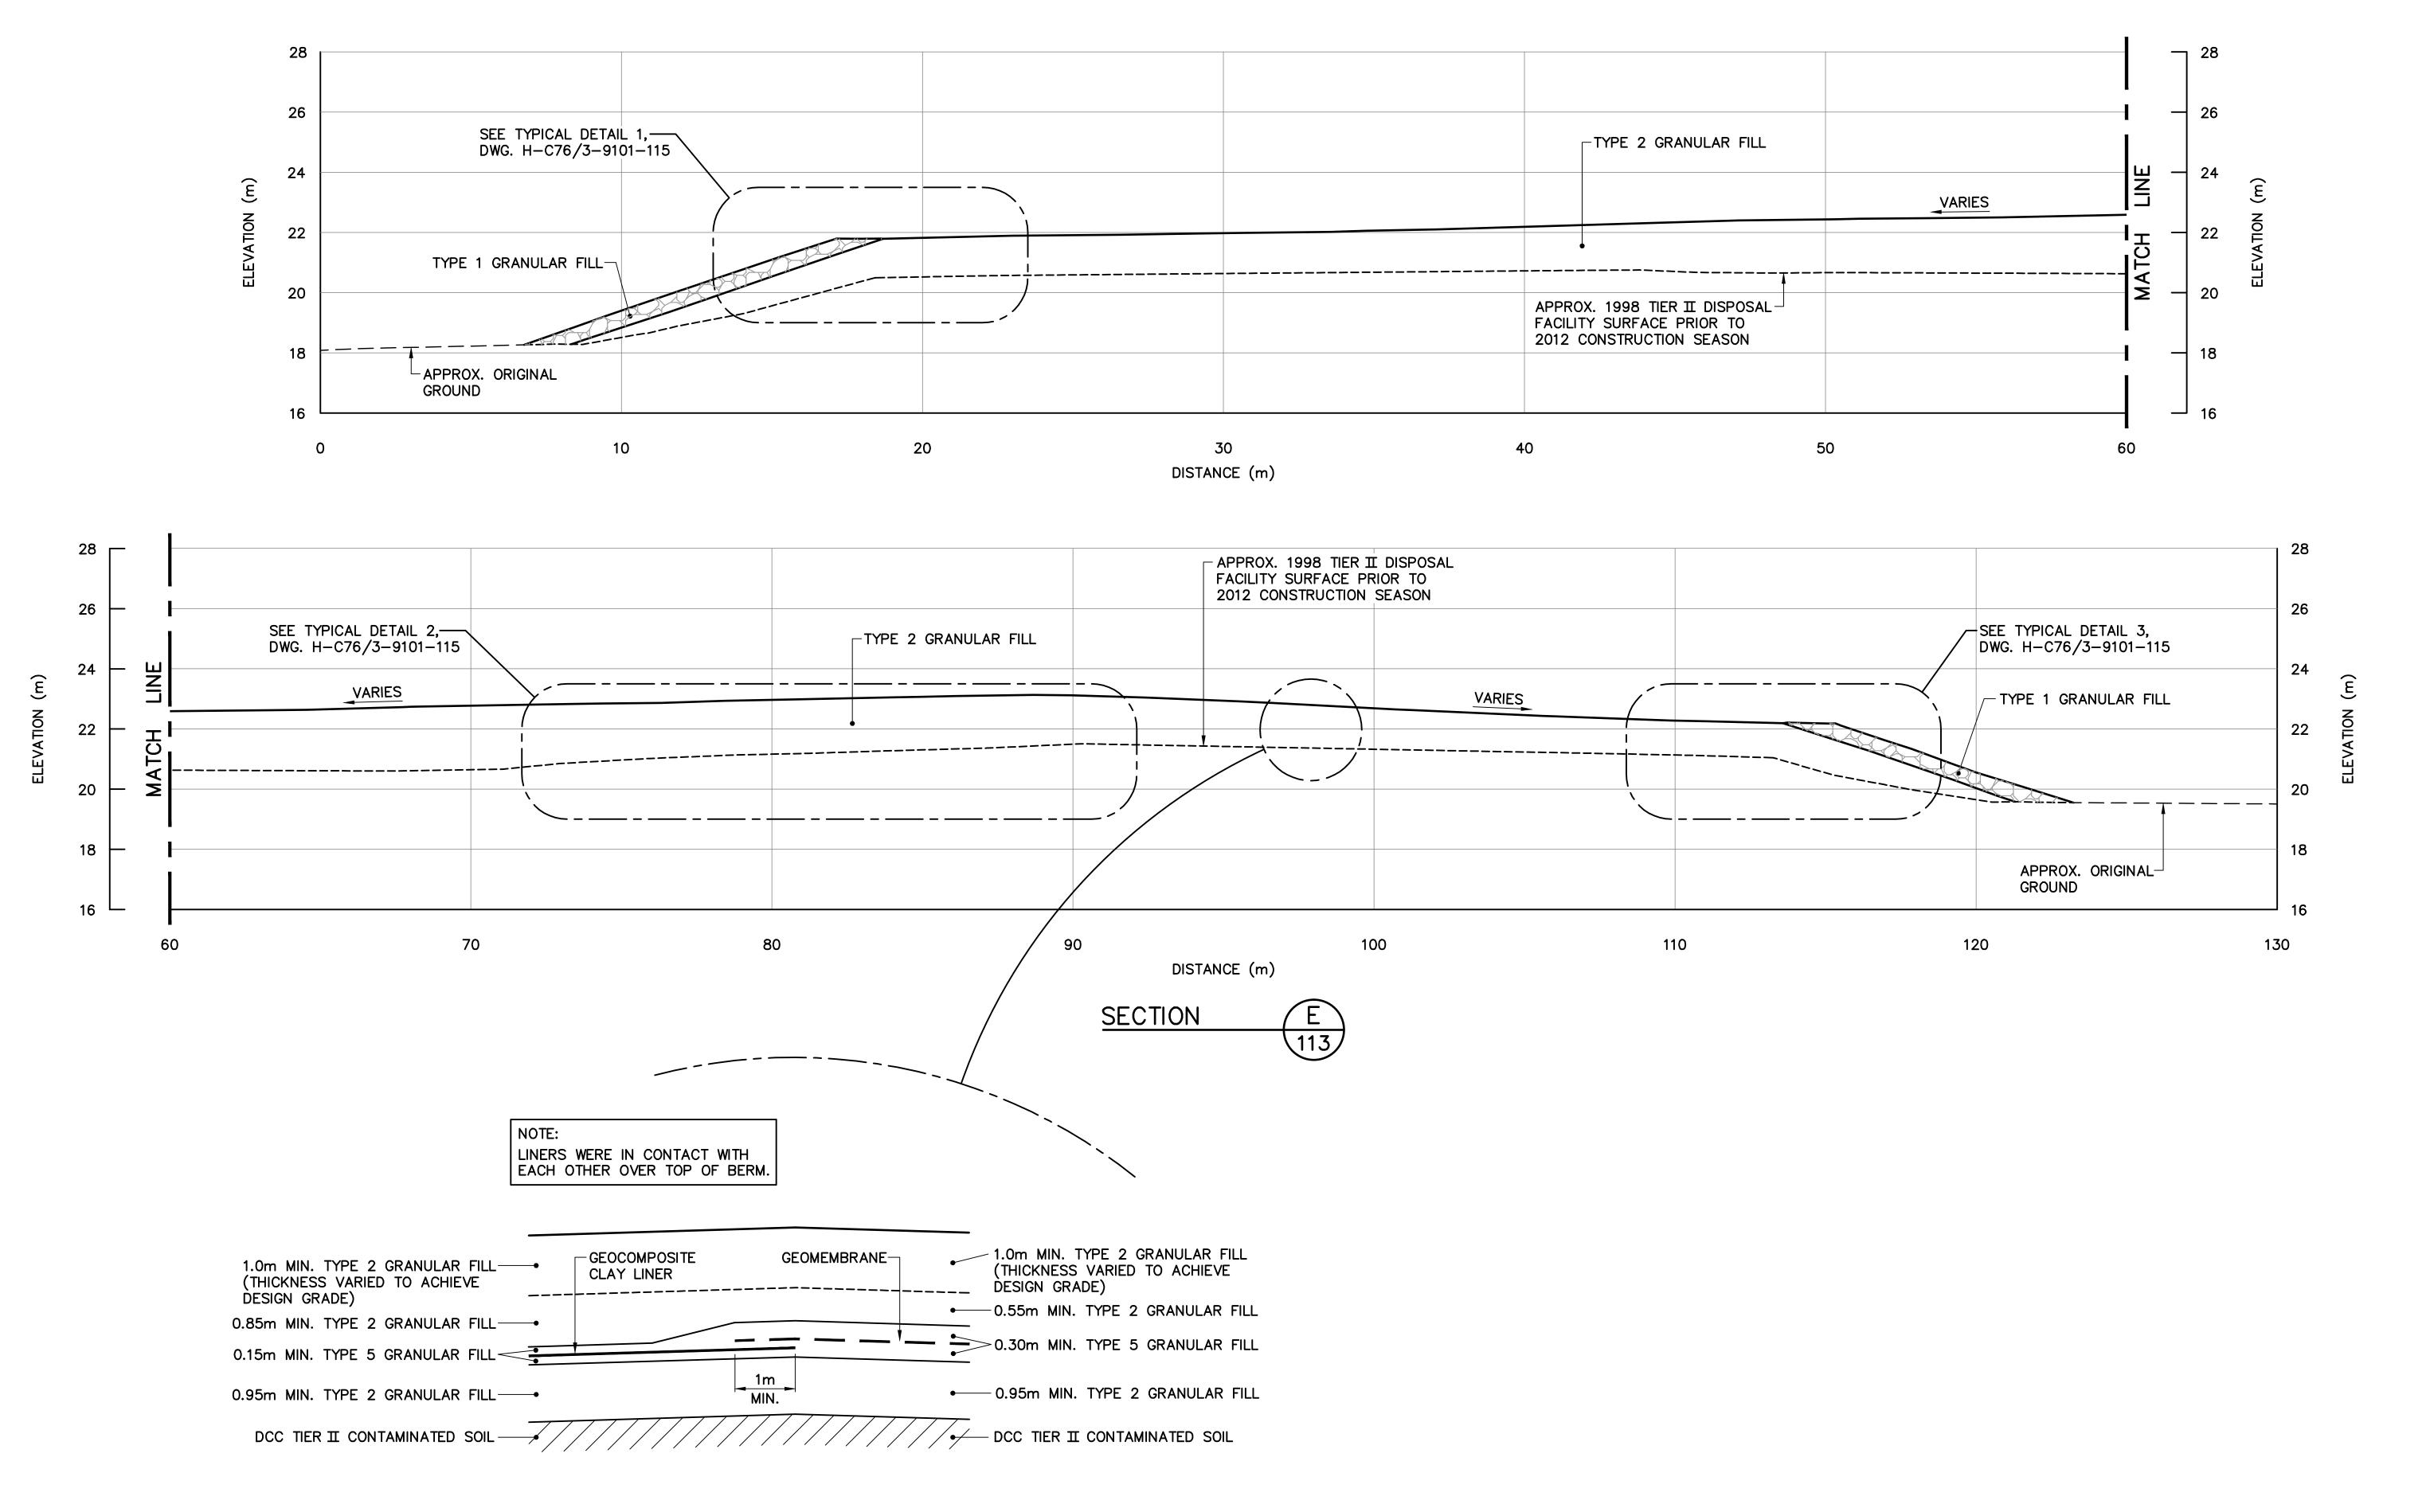

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General Notes:


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- 3. VARIABLE SLOPE ON LANDFILL SURFACE, MINIMUM 2%-MAXIMUM 4%.
- 4. KEY TRENCH EXCAVATED TO SATURATED GROUND, ICE SATURATED PERMAFROST OR SOUND BEDROCK. KEY TRENCH FOR EXTENSION CELL 2013 WAS FIELD CONFIRMED BY SITE ENGINEER.

Legend:

GENERATED BASED ON FINAL AS-BUILT SURVEY INFORMATION

GENERATED BASED ON INTERMEDIATE AS-BUILT SURVEY INFORMATION

0 15-03-27 AS-BUILT DRAWING No. DATE REVISION REVISION

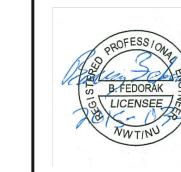

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CANADA 2015, AS REPRESENTED BY THE MINISTER OF NATIONAL DEFENCE. TRADE - METIER 2014-03-24

SUBJECT - SUJET

TIER II DISPOSAL FACILITY CROSS SECTION


CONCURRENCE - ASSENTIMENT PRODUCTION DESIGNED DES OFF ETUDIE AGENT CONCEPT DRAWN SECT HD DESSINE CHEF SECT CHECKED VERIFIE **DTM** DES MGR

COORDINATION REVIEWED - REVU

DWG. NO. - DESSIN NO. H-C76/3-9101-114

Canadä

GEST CONCEPT

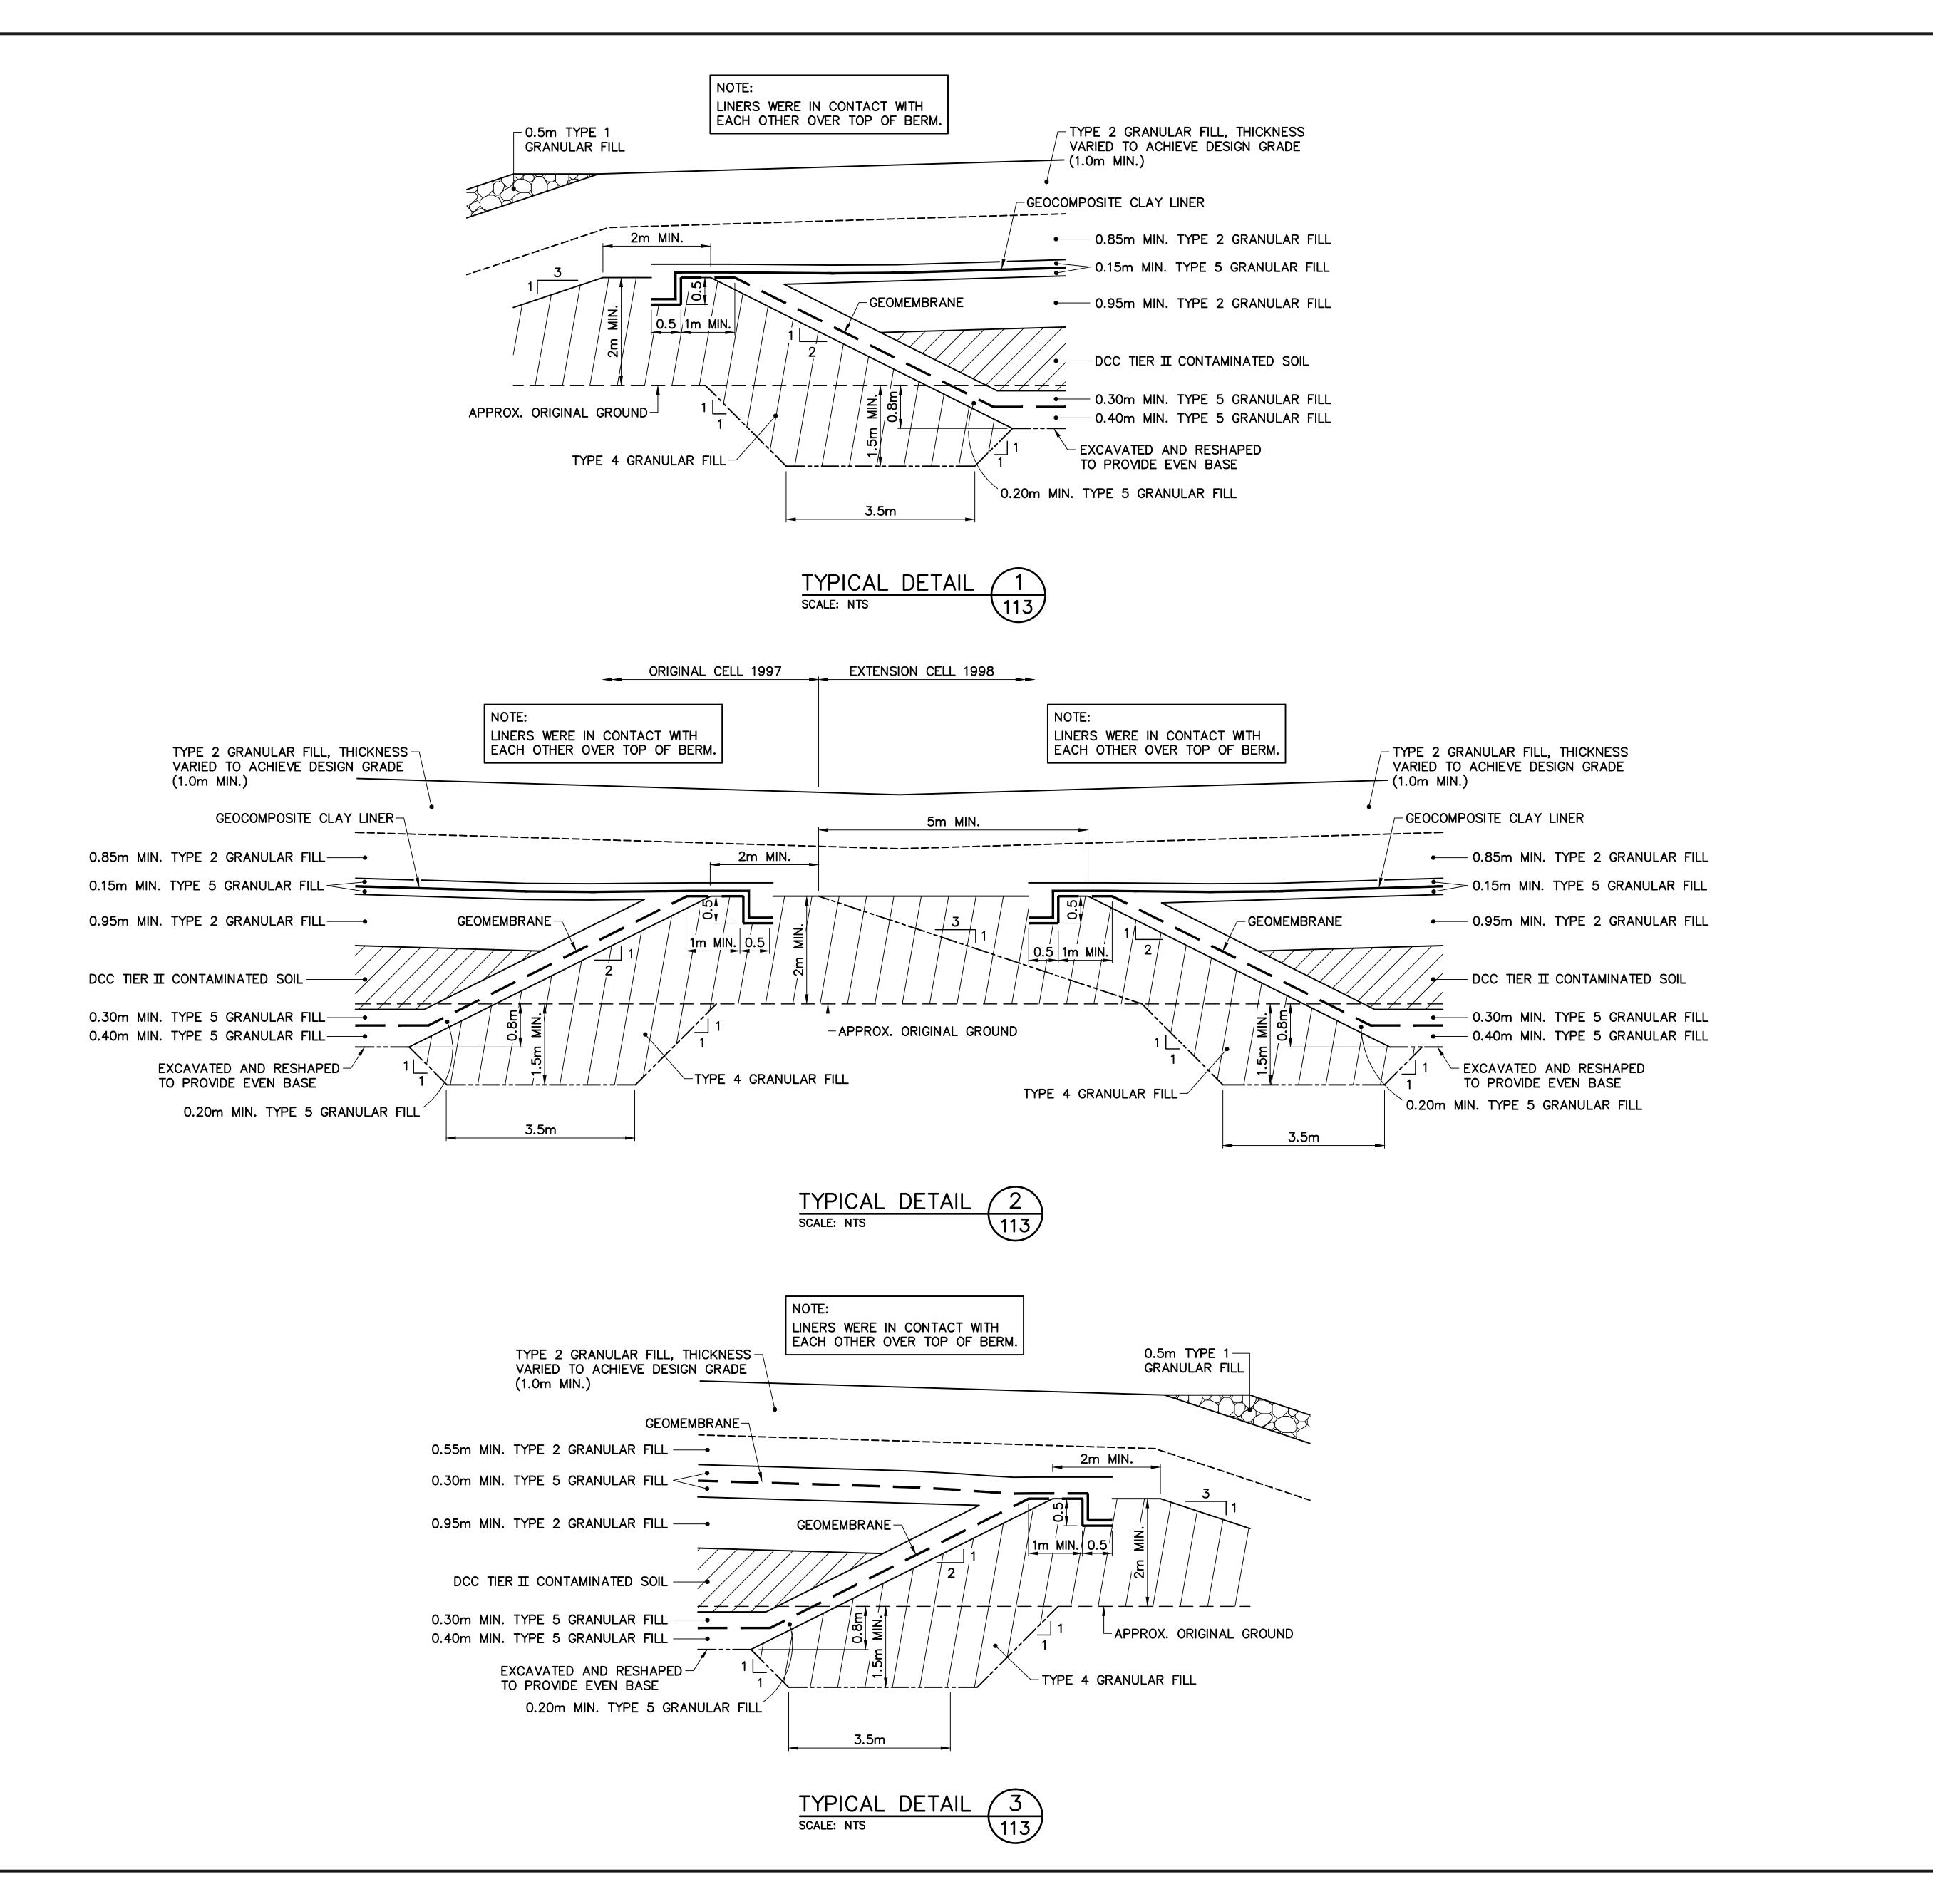


Headquarters Quartier général

General Notes:

- 1. ALL COORDINATES ARE REFERENCED TO NAD83 (CSRS), UTM ZONE 19N. ALL ELEVATIONS REFER TO GEODETIC DATUM.
- 2. ALL DIMENSIONS ARE IN METRES UNLESS NOTED OTHERWISE.
- 3. VARIABLE SLOPE ON LANDFILL SURFACE, MINIMUM 2%-MAXIMUM 4%.
- 4. KEY TRENCH EXCAVATED TO SATURATED GROUND, ICE SATURATED PERMAFROST OR SOUND BEDROCK. KEY TRENCH FOR EXTENSION CELL 2013 WAS FIELD CONFIRMED BY SITE ENGINEER.

Legend:

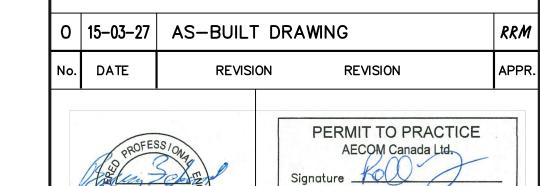

AECOM

Date March 25, 2015 PERMIT NUMBER: P639

NWT/NU Association of Professional Engineers and Geoscientists

2014-03-24

SCALE - ECHELLE 2 1 0 2 4 PROJECT - PROJET

DEW LINE CLEAN UP

FOX-4 CAPE HOOPER

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CANADA 2015, AS REPRESENTED BY THE MINISTER OF NATIONAL DEFENCE. TRADE - METIER

TIER II DISPOSAL FACILITY

TYPICAL DETAILS


SUBJECT - SUJET


SITING

CONCURRENCE - ASSENTIMENT PRODUCTION DESIGNED DES OFF ETUDIE AGENT CONCEPT DRAWN SECT HD DESSINE CHEF SECT

CHECKED VERIFIE **DTM** DES MGR GEST CONCEPT COORDINATION *RRM* REVIEWED - REVU

DWG. NO. - DESSIN NO. H-C76/3-9101-115

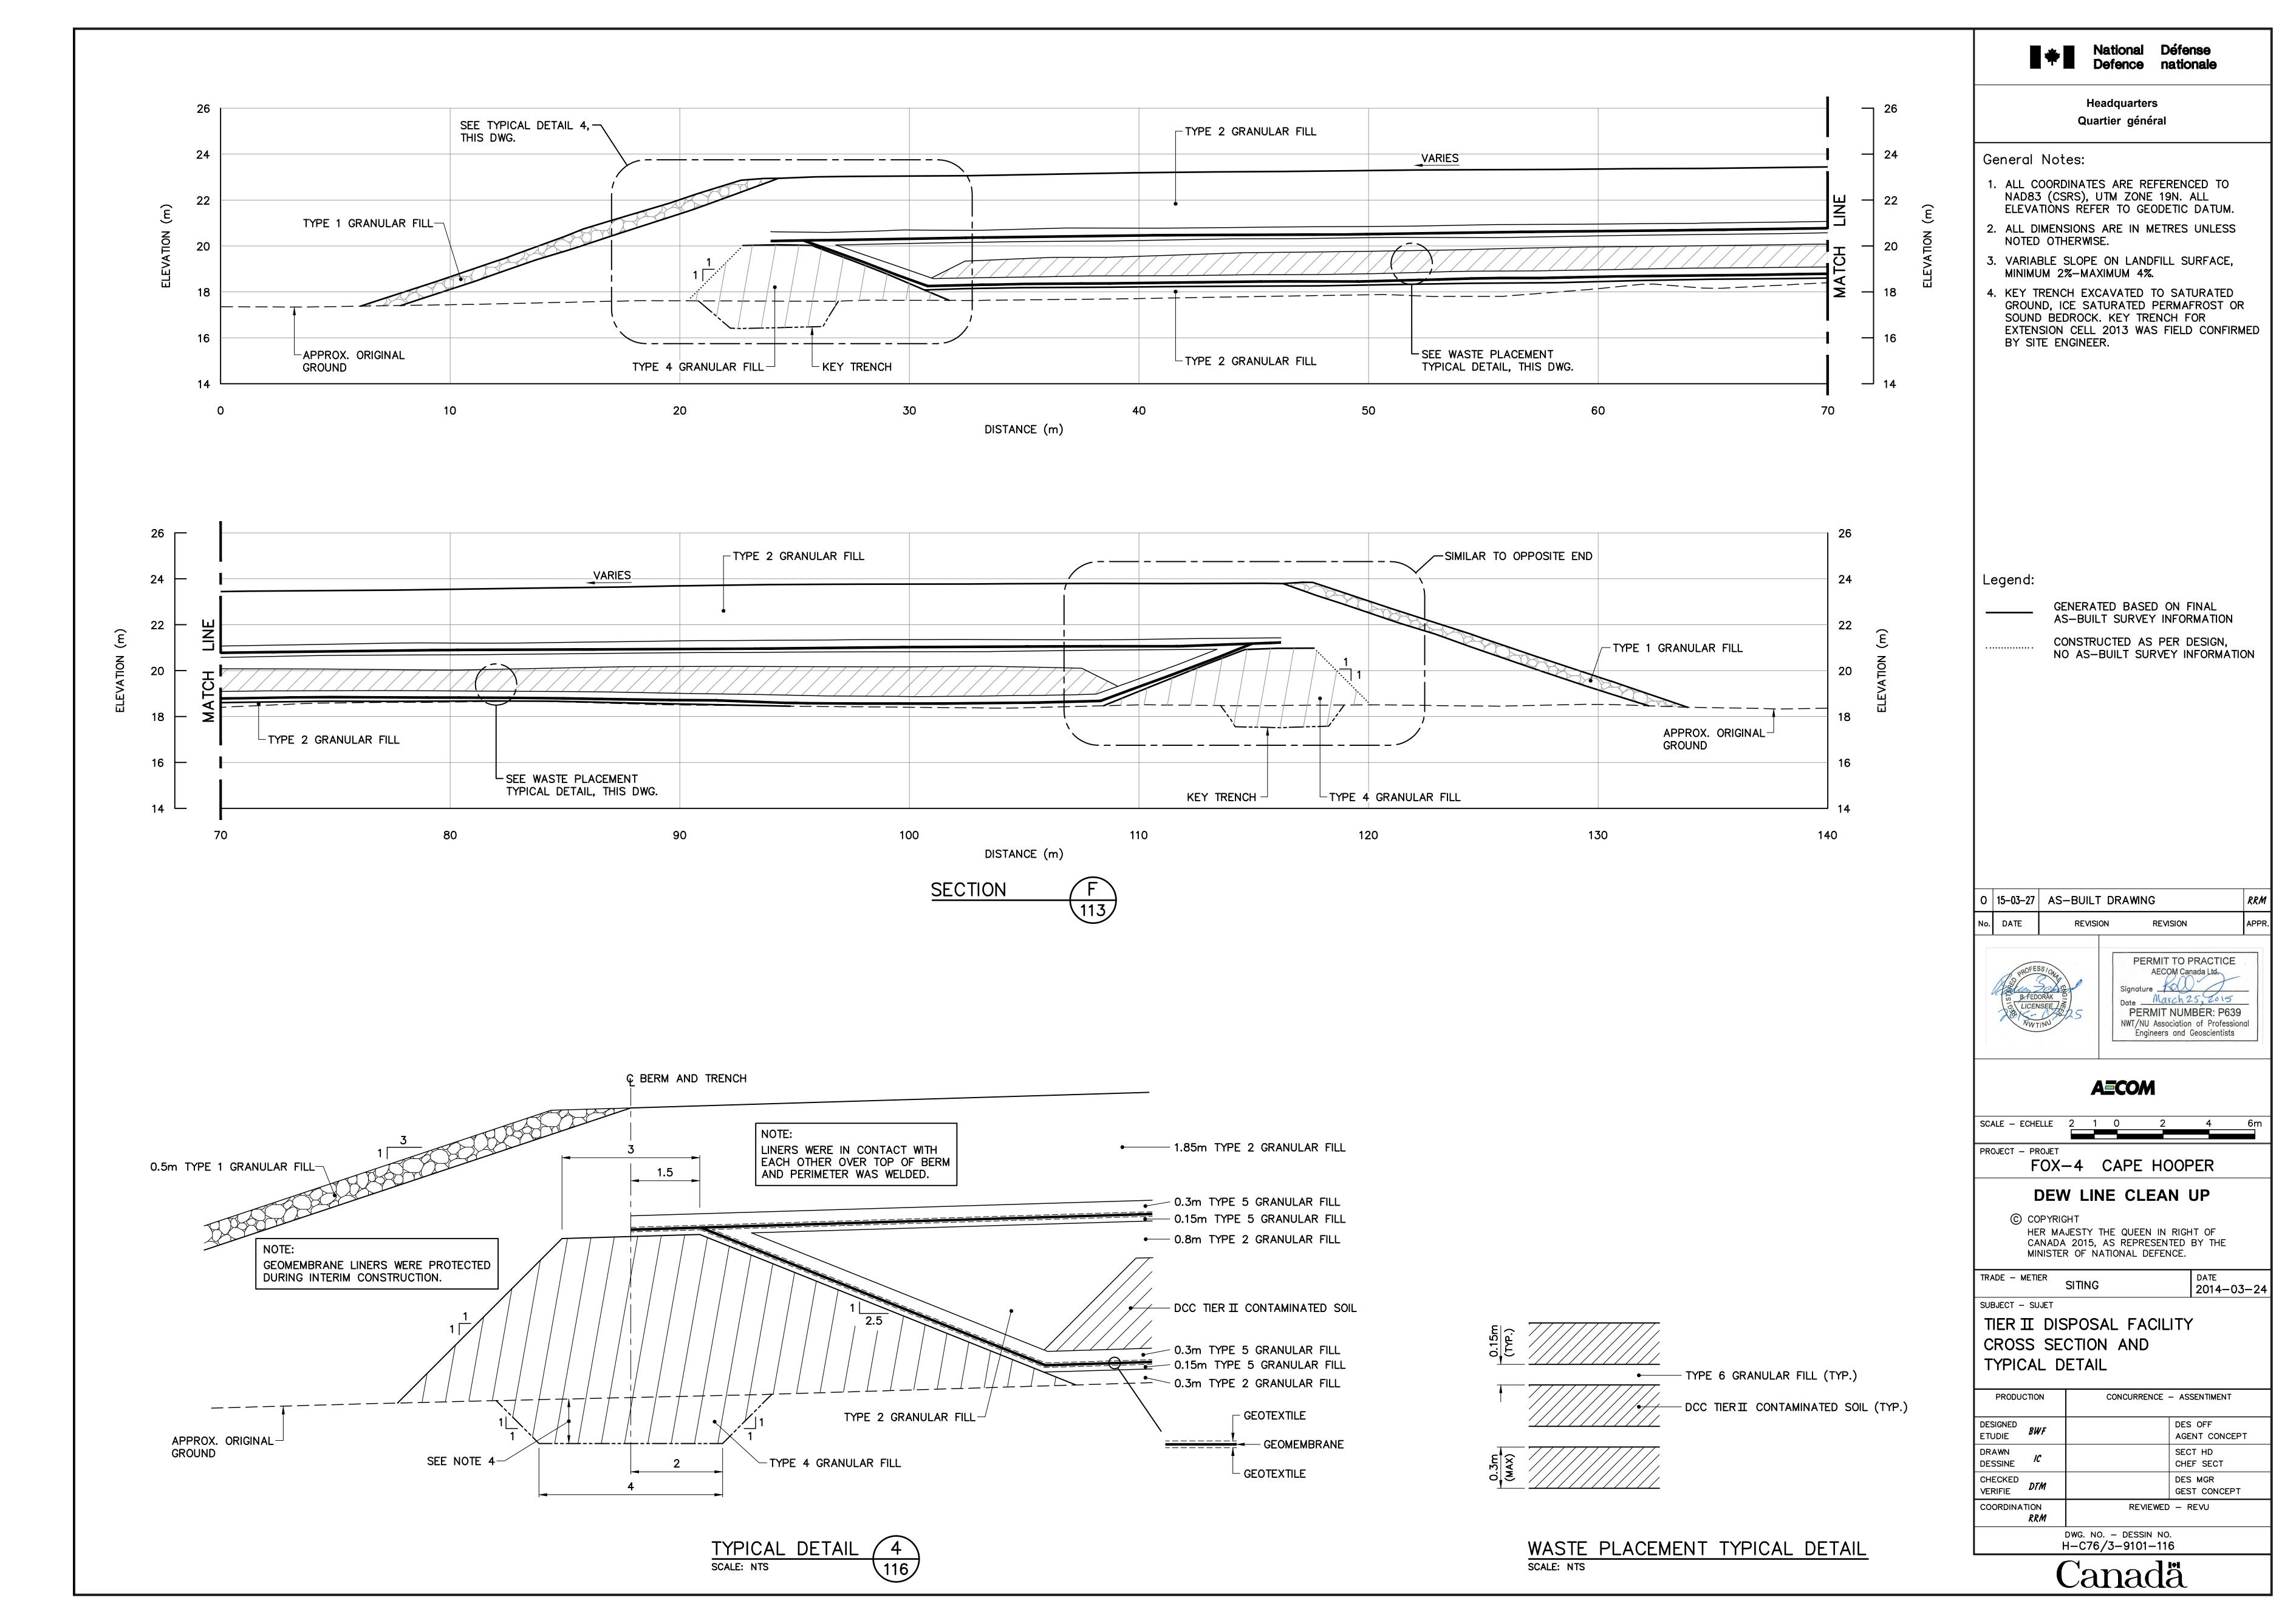

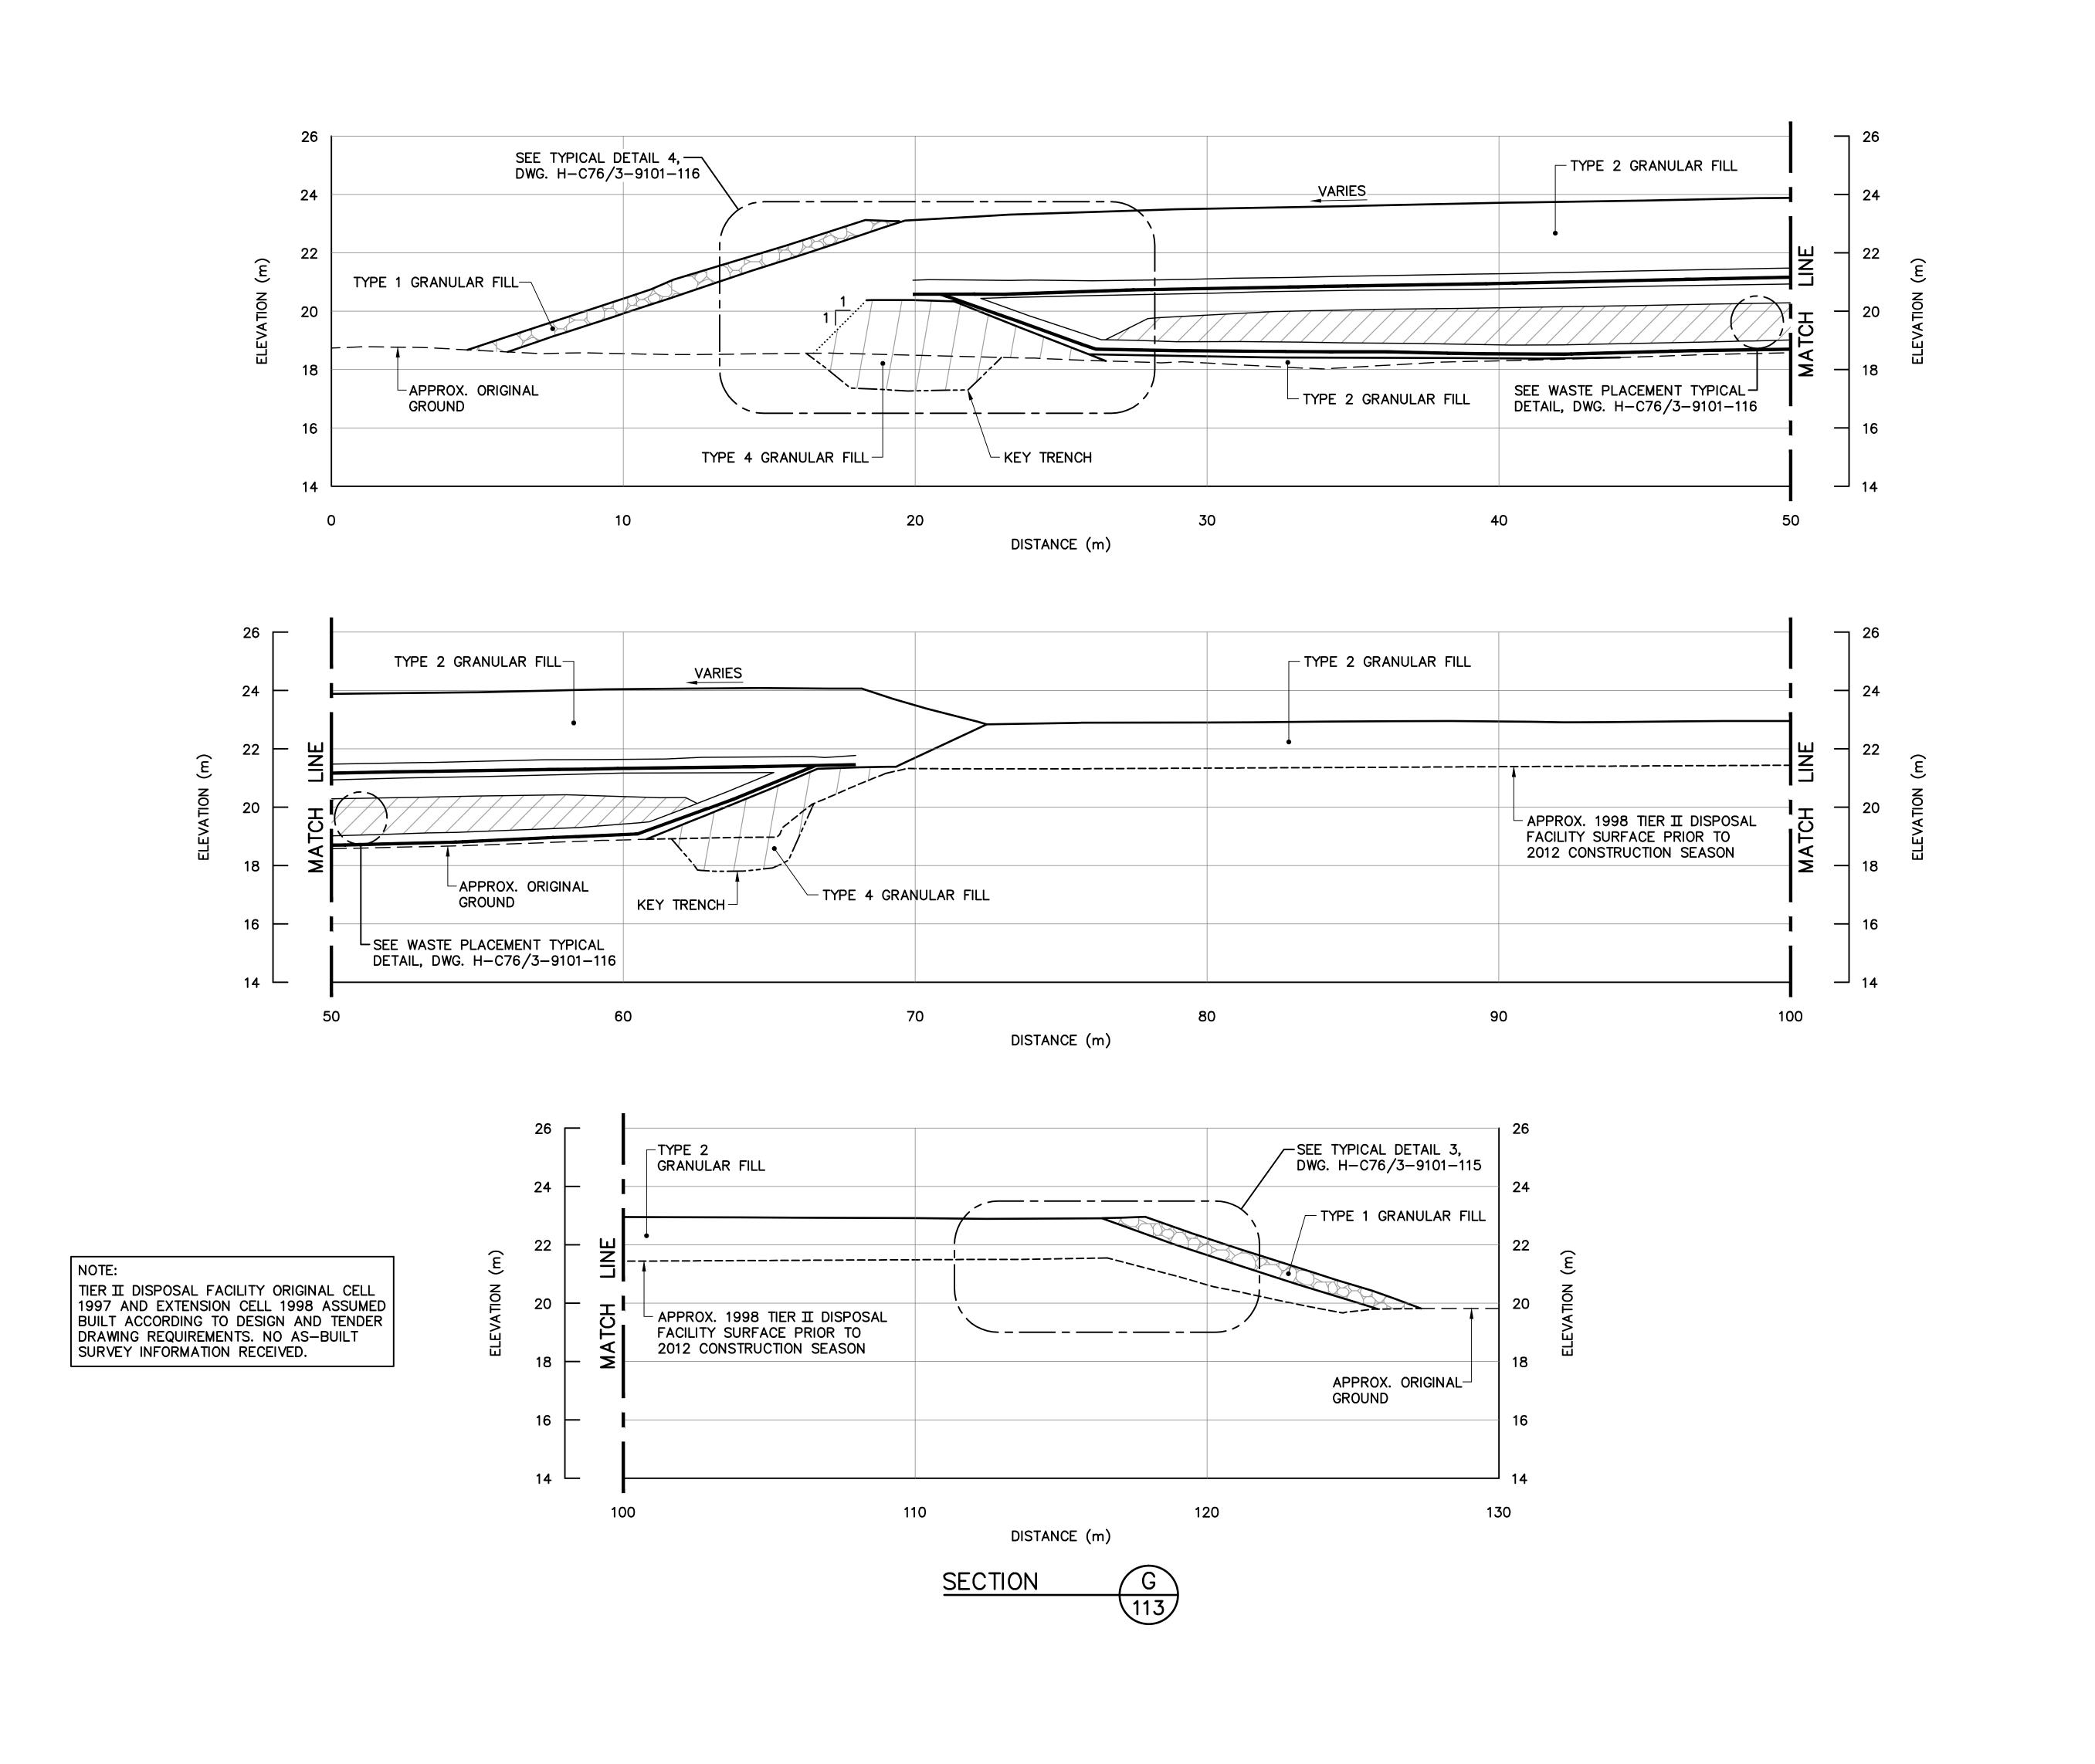



Headquarters Quartier général

General Notes:

- 1. ALL COORDINATES ARE REFERENCED TO NAD83 (CSRS), UTM ZONE 19N. ALL ELEVATIONS REFER TO GEODETIC DATUM.
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- 3. VARIABLE SLOPE ON LANDFILL SURFACE, MINIMUM 2%—MAXIMUM 4%.
- 4. KEY TRENCH EXCAVATED TO SATURATED GROUND, ICE SATURATED PERMAFROST OR SOUND BEDROCK. KEY TRENCH FOR EXTENSION CELL 2013 WAS FIELD CONFIRMED BY SITE ENGINEER.


Legend:

GENERATED BASED ON FINAL AS-BUILT SURVEY INFORMATION

GENERATED BASED ON INTERMEDIATE AS-BUILT SURVEY INFORMATION

CONSTRUCTED AS PER DESIGN, NO AS-BUILT SURVEY INFORMATION

O 15-03-27 AS-BUILT DRAWING REVISION APPR

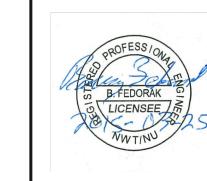

Signature

Date

March 25, 2015

PERMIT NUMBER: P639

NWT/NU Association of Professional Engineers and Geoscientists

PERMIT TO PRACTICE

AECOM

PROJECT - PROJET

FOX-4 CAPE HOOPER

DEW LINE CLEAN UP

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SCALE - ECHELLE 2 1 0 2

TRADE - METIER SITING

SUBJECT - SUJET

2014-03-24

TIER II DISPOSAL FACILITY CROSS SECTION

DESIGNED BWF
ETUDIE

DES OFF
AGENT CONCEPT

DRAWN
DESSINE

C

CHECKED DTM

CONCURRENCE - ASSENTIMENT

DES OFF
AGENT CONCEPT

AGENT CONCEPT

DES MGR
GEST CONCEPT

COORDINATION

REVIEWED - REVU


RRM

DWG. NO. - DESSIN NO. H-C76/3-9101-117

TABLE 1 VERTICAL GROUND TEMPERATURE CABLE INSTALLATION					
INSTRUMENT No.	APPROXIMATE DEPTH BELOW FINAL GRADE (m)	COMMENTS			
TIER II DISPOSAL F	ACILITY				
VT-1	3.99	EXTENDED IN 2013			
VT-2	3.90	EXTENDED IN 2013			
VT-3 4.42		EXTENDED IN 2013			
VT-4	4.34	EXTENDED IN 2013			
VT-5 4.01		EXTENDED IN 2013			
VT-6	_	INSTALLATION DECOMMISSIONED IN 2013			


NOTE:


DEPTH BELOW GROUND SURFACE DERIVED BASED ON HISTORIC LANDFILL MONITORING THERMISTOR DATA AND 2013 EXTENSION MEASUREMENTS.

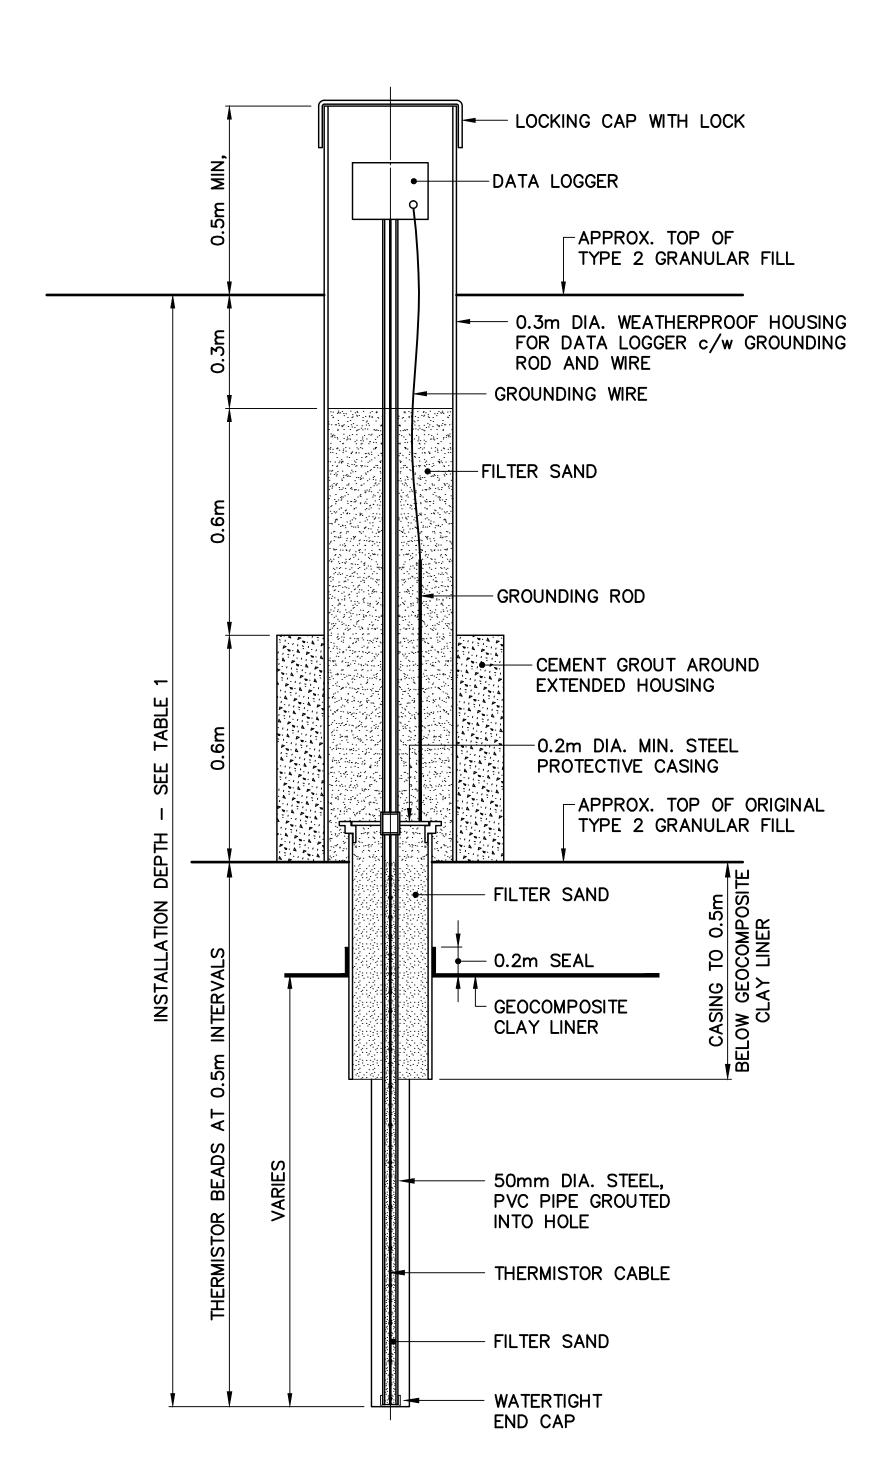

TYPICAL VERTICAL GROUND TEMPERATURE CABLE


SCALE: NTS
VT-1 THROUGH VT-4 (INSTALLED IN 1996, EXTENDED IN 2013)
VT-5 AND VT-6 (INSTALLED IN 1998, EXTENDED IN 2013)

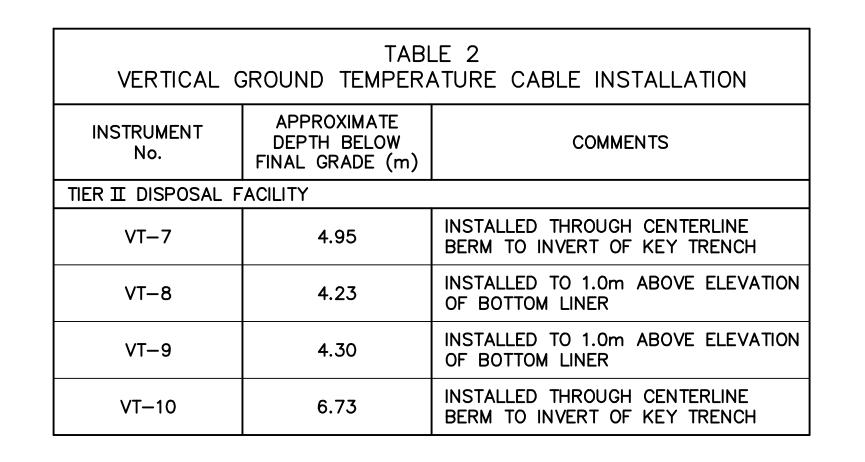

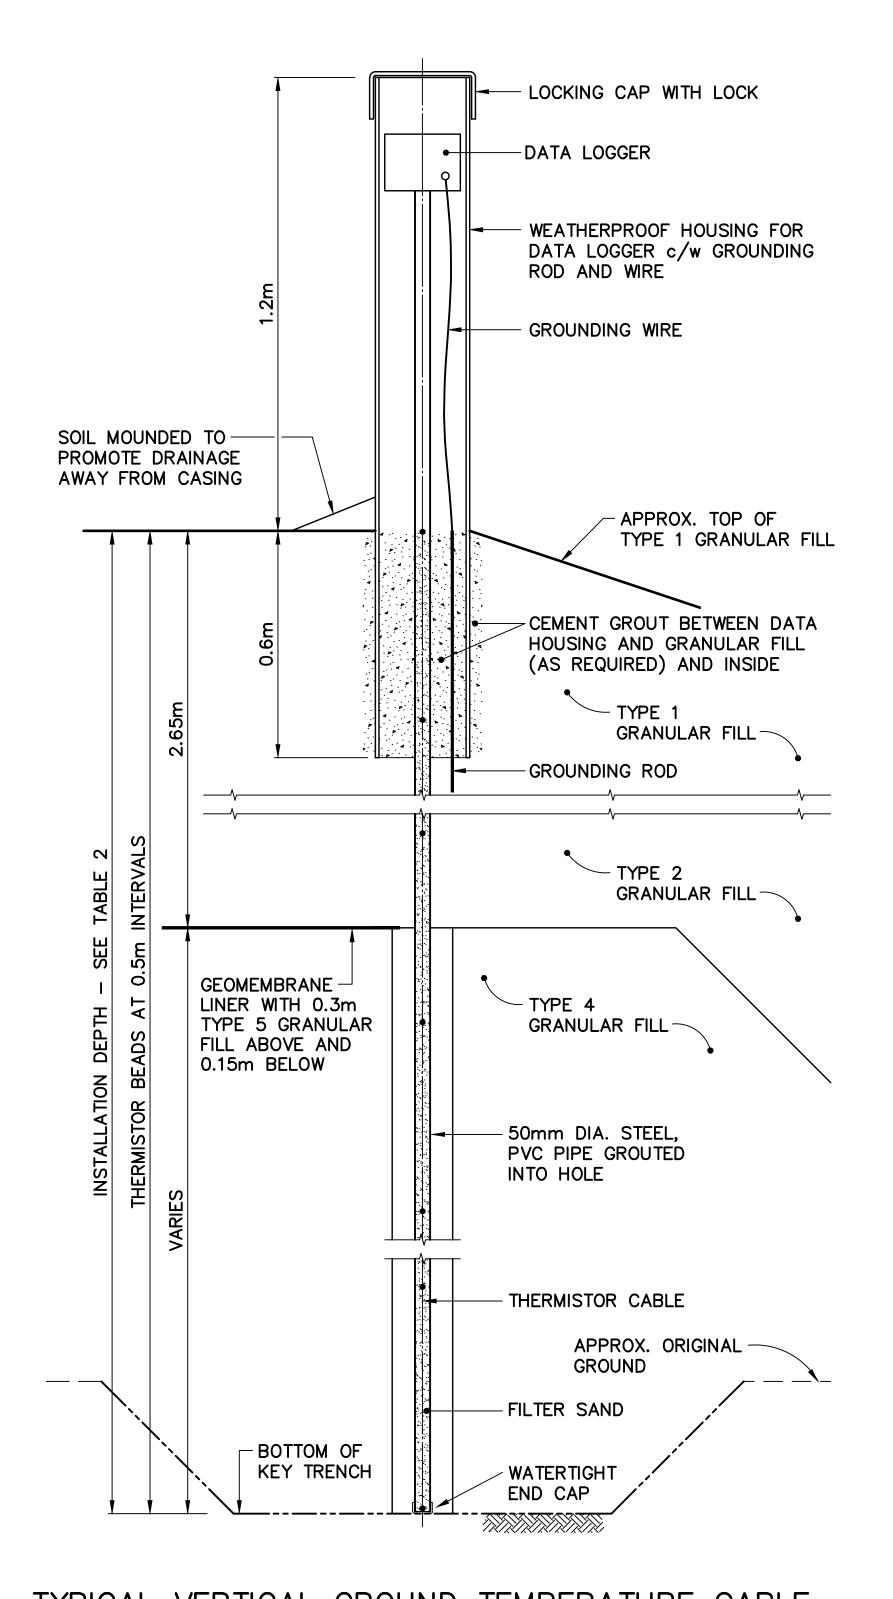

TYPICAL VERTICAL GROUND TEMPERATURE CABLE SCALE: NTS

SCALE: NTS
INSTALLED AT CENTRELINE OF TIER II DISPOSAL FACILITY BERM
VT-7 AND VT-10 (INSTALLED IN 2013)

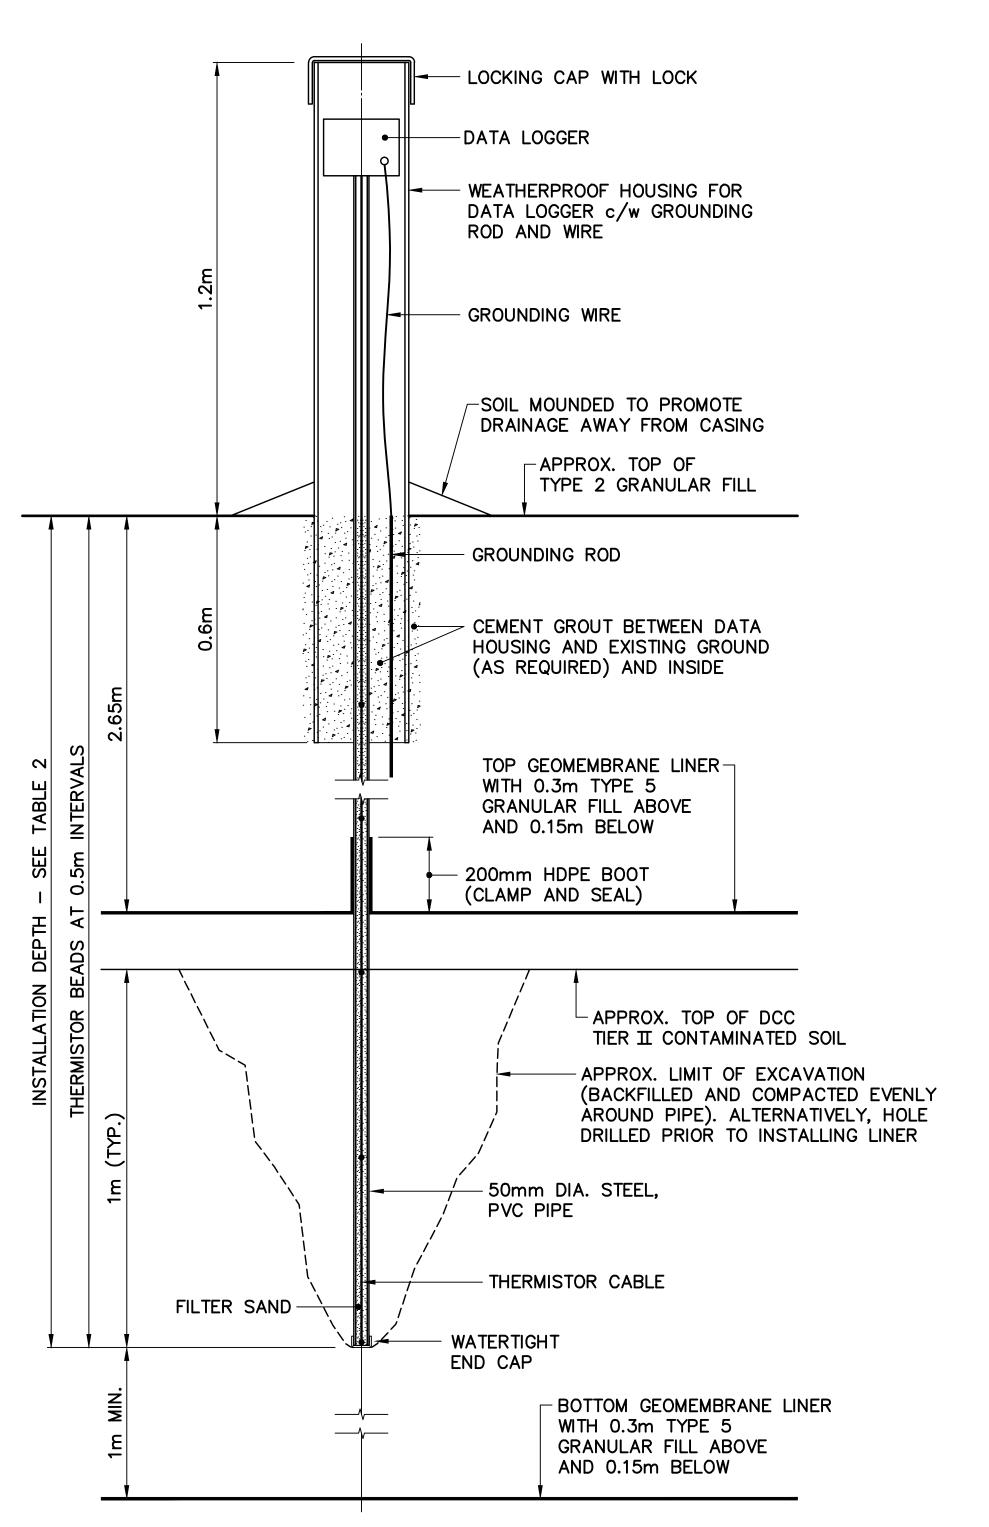

TYPICAL VERTICAL GROUND TEMPERATURE CABLE

SCALE: NTS
INSTALLED WITHIN DCC TIER II CONTAMINATED SOIL
VT-8 AND VT-9 (INSTALLED IN 2013)




National Défense Defence nationale

Headquarters Quartier général

General Notes:

- 1. ALL DIMENSIONS ARE IN METRES UNLESS NOTED OTHERWISE.
- 2. LOCATIONS OF INSTRUMENTATION ARE SHOWN ON THE DRAWINGS, INCLUDING COORDINATE TABLES.

Legend:

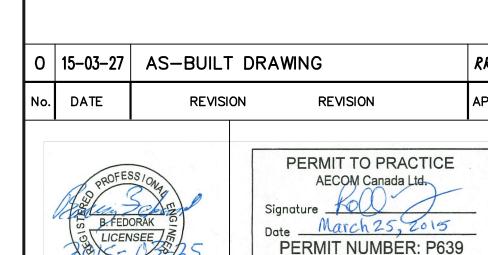

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AS SHOWN

NWT/NU Association of Professional Engineers and Geoscientists

2014-03-24

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DEW LINE CLEAN UP

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SUBJECT - SUJET

MISCELLANEOUS DETAILS

SHEET 1

RRM


SCALE - ECHELLE

PROJECT - PROJET

TRADE - METIER

PRODUCTION		CONCURRENCE - ASSENTIMENT	
DESIGNED ETUDIE	BWF		DES OFF AGENT CONCEPT
DRAWN DESSINE	IC		SECT HD CHEF SECT
CHECKED VERIFIE	DTM		DES MGR GEST CONCEPT
COORDINATION		REVIEWED	- REVU


DWG. NO. - DESSIN NO. H-C76/3-9101-118

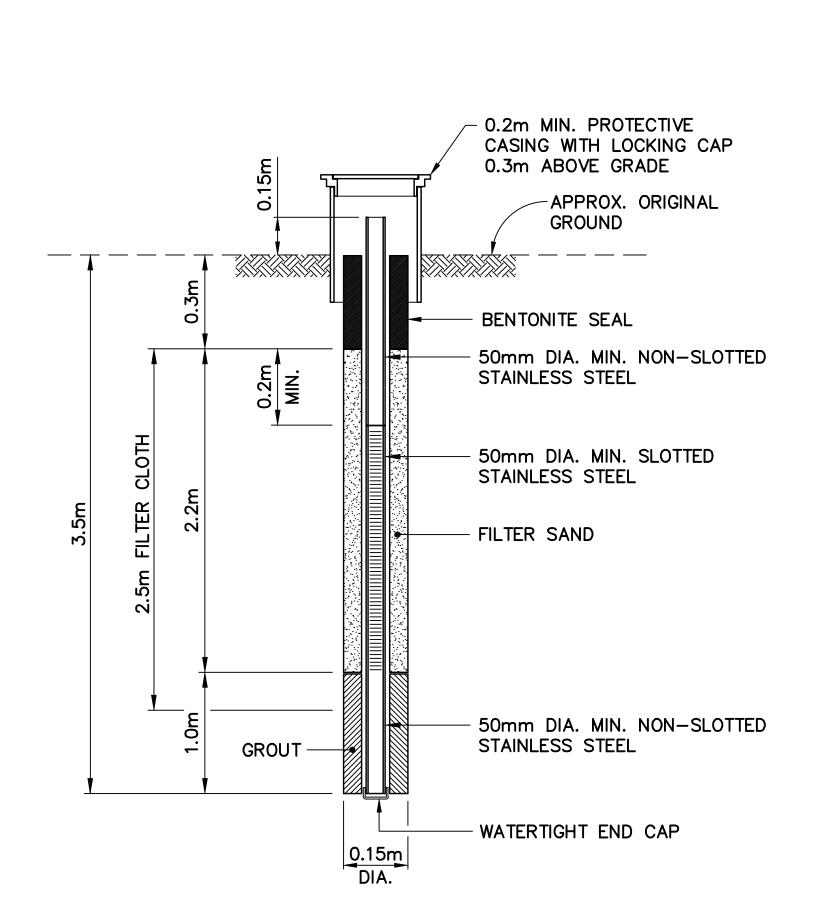

TYPICAL MONITORING WELL SCALE: NTS MONITORING WELLS INSTALLED IN 1998


15 MONITORING WELLS REMAINING. 14 MONITORING WELLS REMOVED.

IF SOUND BEDROCK WAS ENCOUNTERED, A 2.5m MIN. OF SCREEN AND 0.5m MIN. OF EMBEDMENT WAS REQUIRED INTO SOUND BEDROCK.

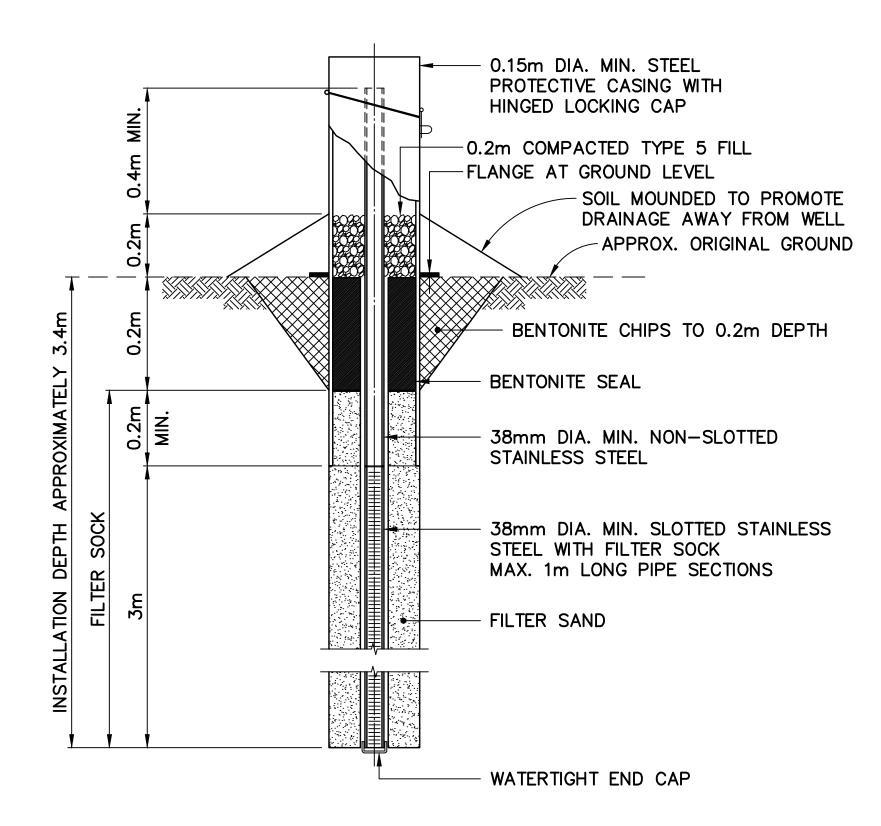

TYPICAL MONITORING WELL SCALE: NTS

FOR BEDROCK DEPTH < 0.7m BELOW GROUND SURFACE INCLUDING TYPICAL BACKGROUND MONITORING WELL INSTALLATION MONITORING WELLS INSTALLED IN 2011 AND 2012

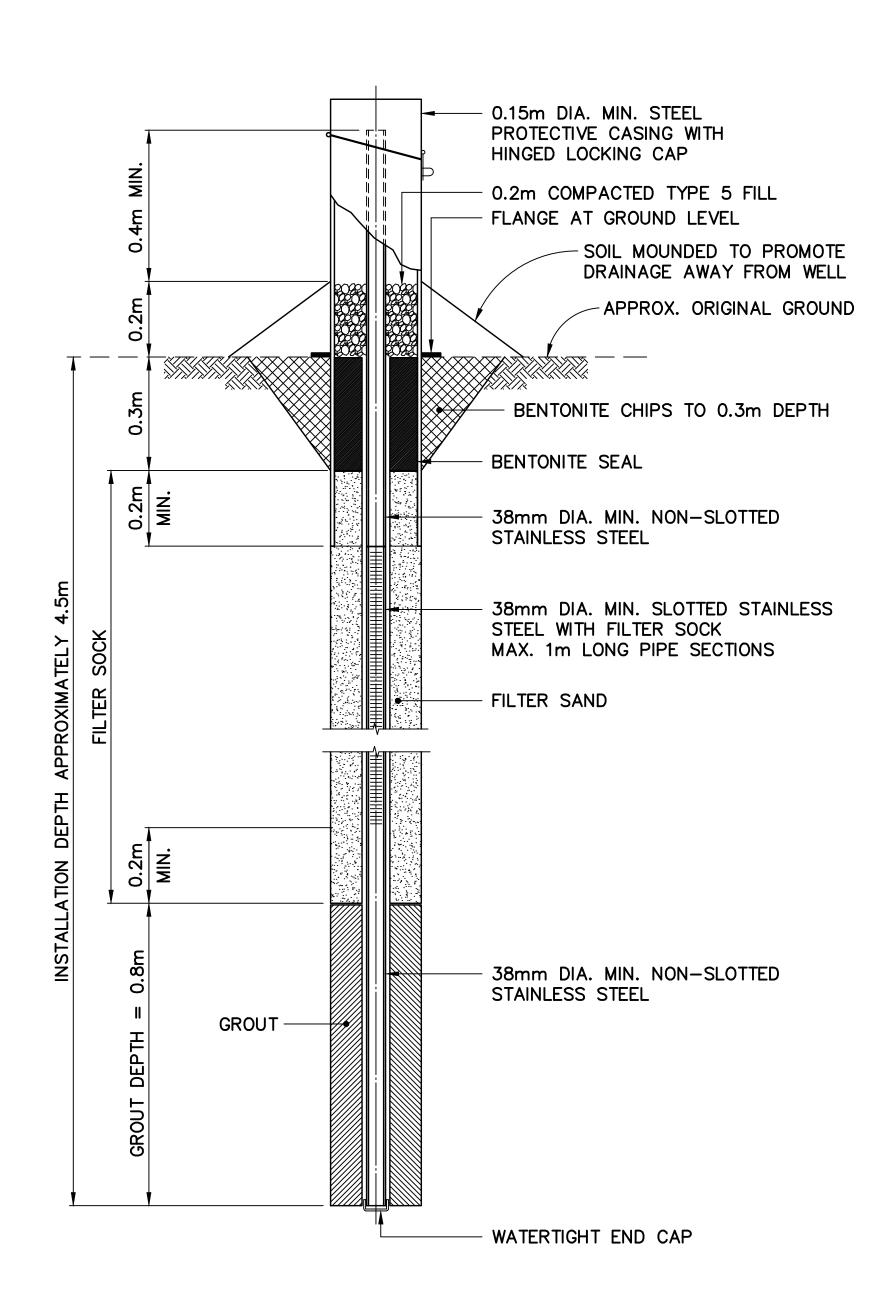

TYPICAL MONITORING WELL

SCALE: NTS FOR BEDROCK DEPTH > 0.7m BELOW GROUND SURFACE INCLUDING TYPICAL BACKGROUND MONITORING WELL INSTALLATION MONITORING WELLS INSTALLED IN 2011 AND 2012




National Défense Defence nationale

Headquarters Quartier général

General Notes:

- 1. ALL DIMENSIONS ARE IN METRES UNLESS NOTED OTHERWISE.
- 2. LOCATIONS OF INSTRUMENTATION ARE SHOWN ON THE DRAWINGS, INCLUDING COORDINATE TABLES.

Legend:

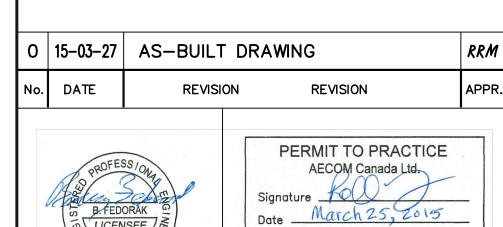

AECOM

PERMIT NUMBER: P639

NWT/NU Association of Professional Engineers and Geoscientists

SCALE - ECHELLE AS SHOWN PROJECT - PROJET

DEW LINE CLEAN UP

FOX-4 CAPE HOOPER

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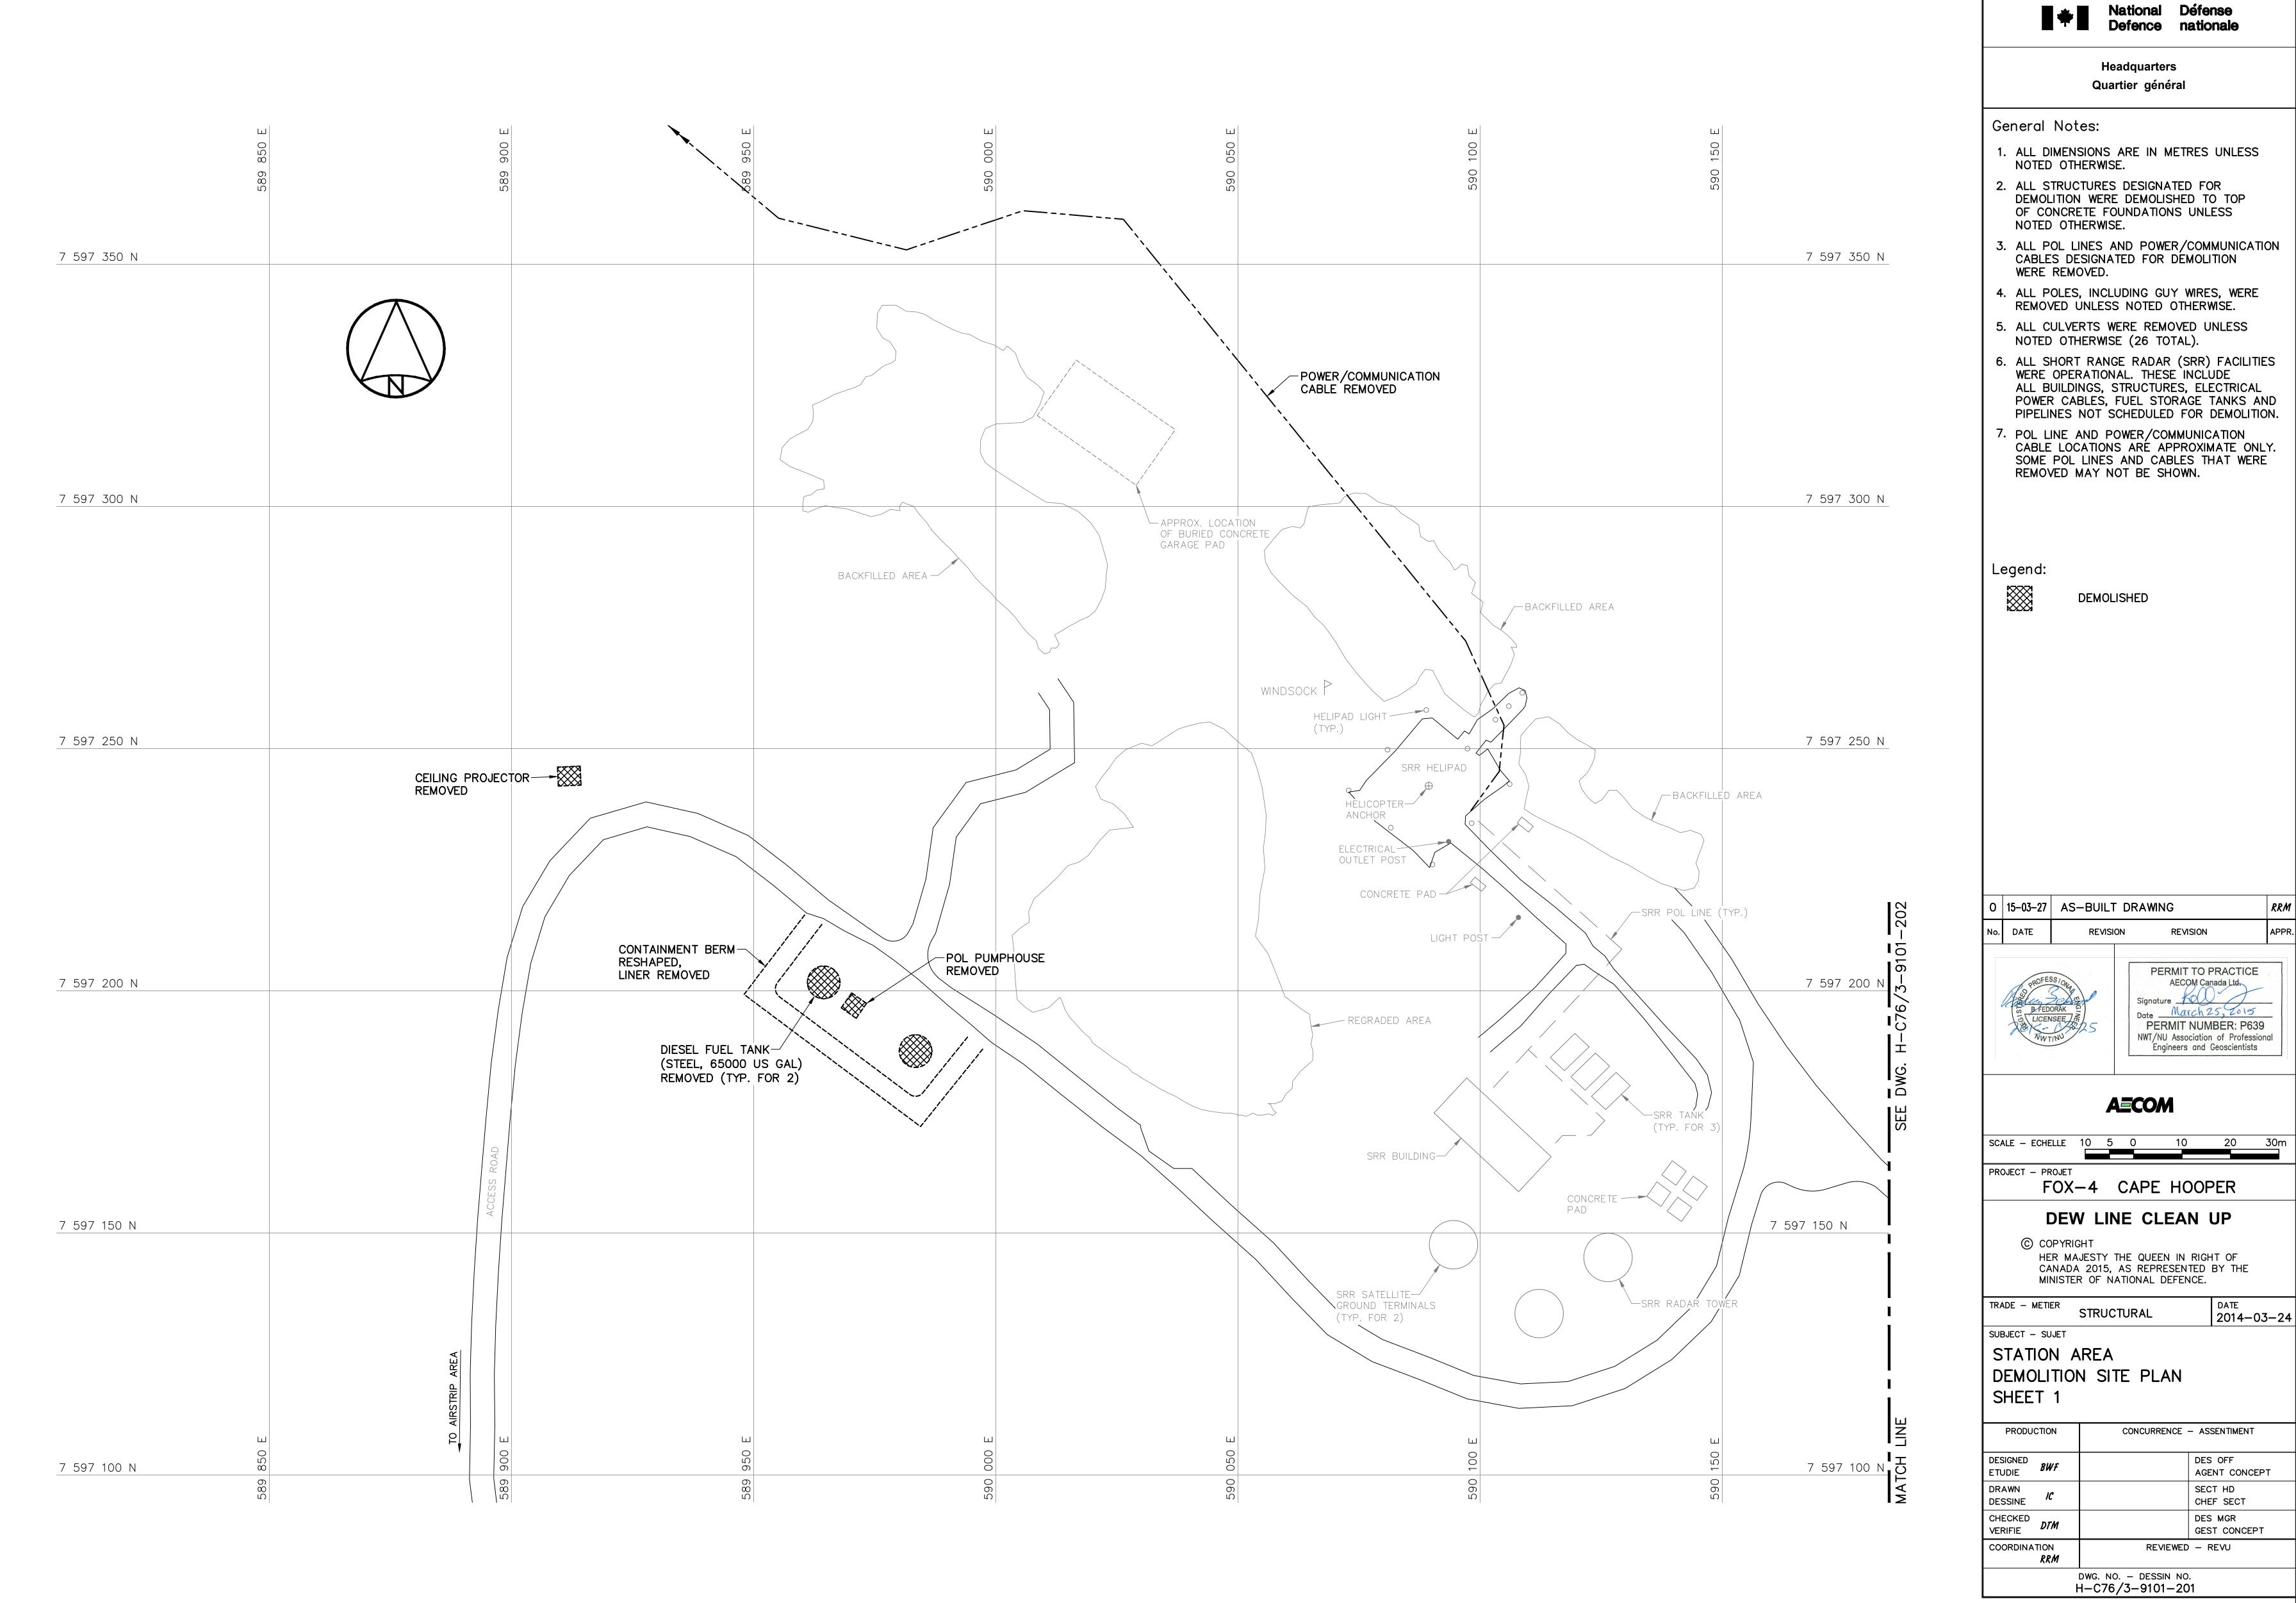
MINISTER OF NATIONAL DEFENCE. TRADE - METIER SITING 2014-03-24


SUBJECT — SUJET

MISCELLANEOUS DETAILS SHEET 2

	PRODUCTION		CONCURRENCE - ASSENTIMENT	
	DESIGNED ETUDIE	<i>BWF</i>		DES OFF AGENT CONCEPT
	DRAWN DESSINE	IC		SECT HD CHEF SECT
	CHECKED VERIFIE	DTM		DES MGR GEST CONCEPT
	COORDINATION		REVIEWED — REVU	

DWG. NO. - DESSIN NO. H-C76/3-9101-119



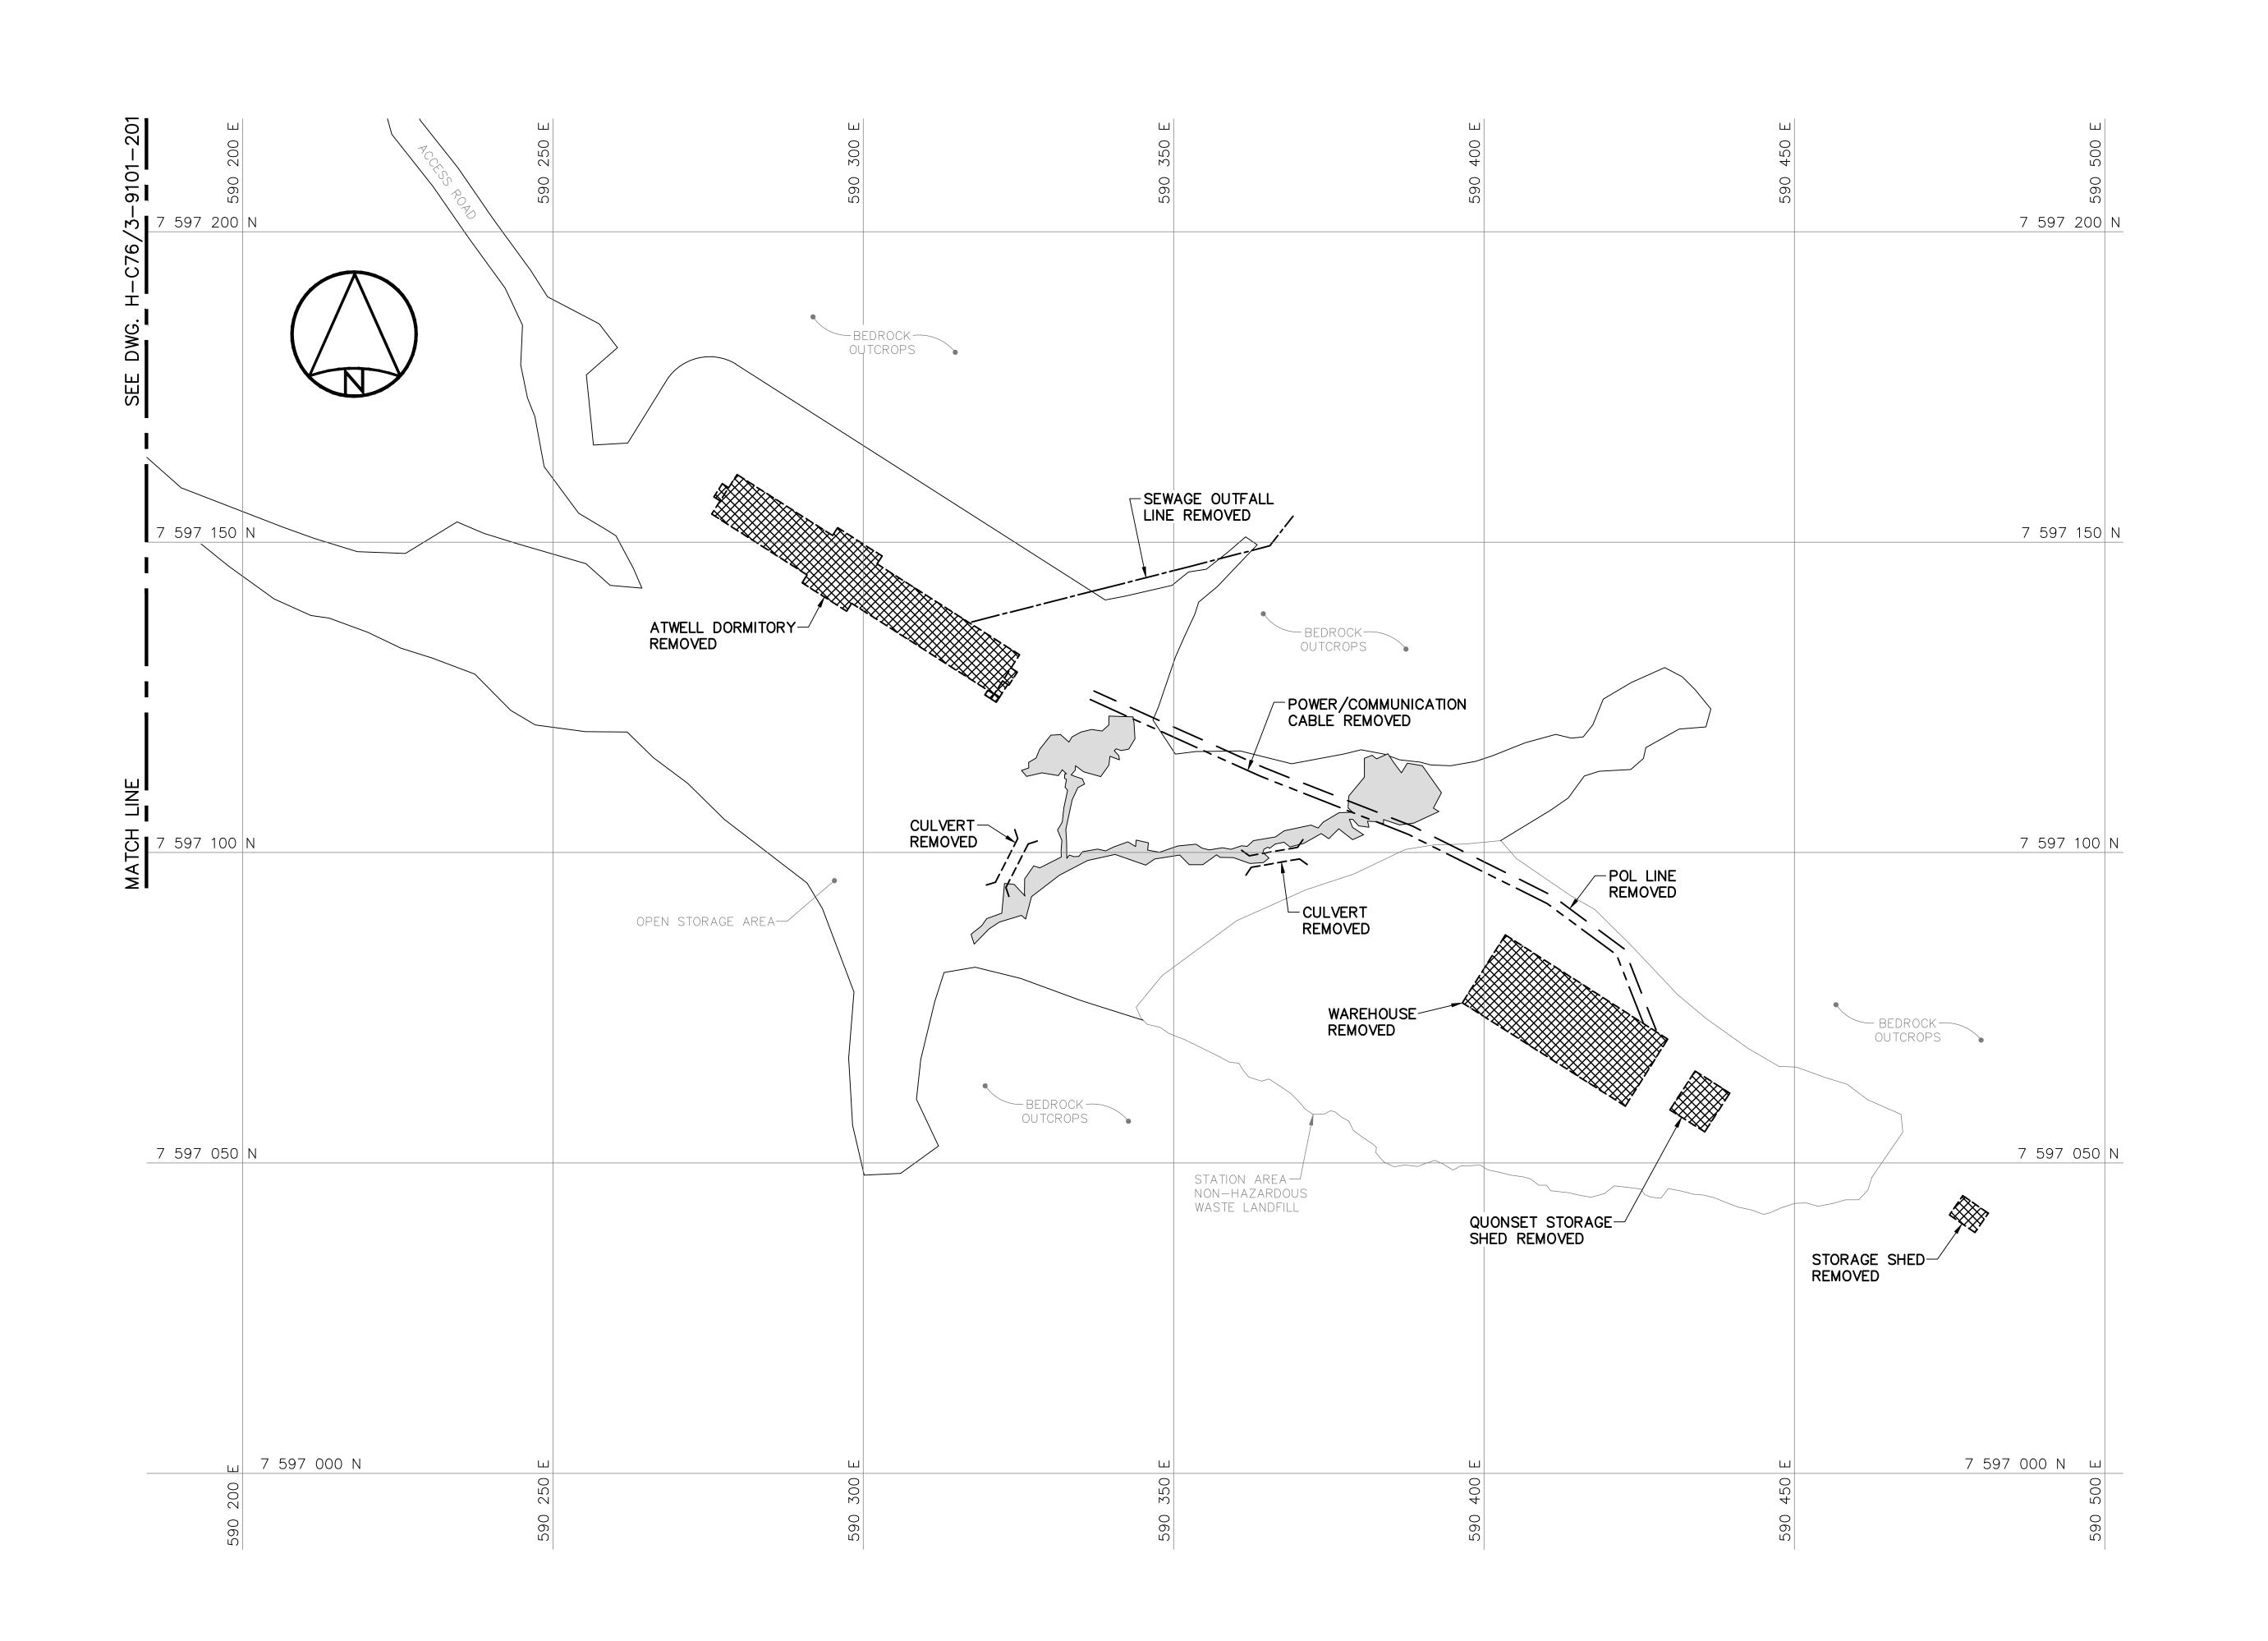



Headquarters Quartier général

General Notes:

- 1. ALL DIMENSIONS ARE IN METRES UNLESS NOTED OTHERWISE.
- 2. ALL STRUCTURES DESIGNATED FOR DEMOLITION WERE DEMOLISHED TO TOP OF CONCRETE FOUNDATIONS UNLESS NOTED OTHERWISE.
- ALL POL LINES AND POWER/COMMUNICATION CABLES DESIGNATED FOR DEMOLITION WERE REMOVED.
- 4. ALL POLES, INCLUDING GUY WIRES, WERE REMOVED UNLESS NOTED OTHERWISE.
- 5. ALL CULVERTS WERE REMOVED UNLESS NOTED OTHERWISE (26 TOTAL).
- 6. ALL SHORT RANGE RADAR (SRR) FACILITIES WERE OPERATIONAL. THESE INCLUDE ALL BUILDINGS, STRUCTURES, ELECTRICAL POWER CABLES, FUEL STORAGE TANKS AND PIPELINES NOT SCHEDULED FOR DEMOLITION.
- 7. POL LINE AND POWER/COMMUNICATION CABLE LOCATIONS ARE APPROXIMATE ONLY. SOME POL LINES AND CABLES THAT WERE REMOVED MAY NOT BE SHOWN.







DEMOLISHED



BODY OF WATER

0	15-03-27	AS-BUILT DRAWING			
No.	DATE	REVISI	ON	REVISION	AF

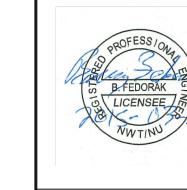

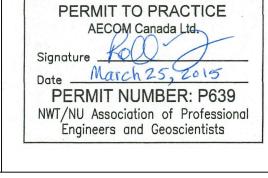

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SCALE - ECHELLE 10 5 0 10 20 30m

PROJECT - PROJET

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DEW LINE CLEAN UP

DEW LINE CLEAN

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MINISTER OF NATIONAL DEFENCE.

TRADE - METIER STRUCTURAL DATE 2014-03-24

SUBJECT - SUJET

STATION AREA
DEMOLITION SITE PLAN
SHEET 2

PRODUCTION

CONCURRENCE - ASSENTIMENT

DESIGNED BWF
ETUDIE

DRAWN
DESSINE

CHECKED

DES OFF
AGENT CONCEPT

SECT HD
CHEF SECT

DES MGR

CHECKED DTM
VERIFIE DTM
COORDINATION
RRM

GEST CONCEPT

REVIEWED — REVU

DWG. NO. - DESSIN NO. H-C76/3-9101-202

