


Sheet Size: B1 (100mm x 707mm)
PLOT: Monday, February 06, 2017 2:23:44 PM
Saved by: Eros, Craig
AECOM FILE NO.: P:\60509545\900-WORK\916-CAD\20-SHEETS\CF\FOX-D_C00-RX.DWG

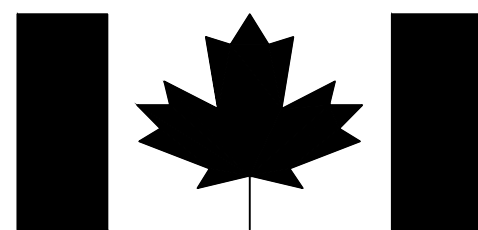

Public Works and
Government Services
Canada

Travaux publics et
Services gouvernementaux
Canada



Indigenous and
Northern Affairs
Canada

Affaires autochtones
et du Nord Canada

REAL PROPERTY SERVICES
Western Region

Canada


REMEDIATION PROJECT


DRAWING INDEX					
SHEET No.		TITLE	SHEET No.		TITLE
R.083399	C00	COVER SHEET	R.083399	C07	APEC 9 SITE PLAN
R.083399	C01	OVERALL SITE PLAN	R.083399	C08	APEC 10 REGRADING PLAN
R.083399	C02	UPPER SITE SITE PLAN	R.083399	C09	APEC 11B SITE PLAN
R.083399	C03	LOWER SITE SITE PLAN	R.083399	C10	APEC 11C SITE PLAN
R.083399	C04	APEC 1A, 1B, 2, 3 AND 4 SITE PLAN	R.083399	C11	APEC 12 SITE PLAN
R.083399	C05	APEC 5 AND 8 SITE PLAN	R.083399	C12	TYPICAL SOIL TREATMENT FACILITY PLAN, SECTIONS AND DETAILS
R.083399	C06	APEC 6 AND 7 SITE PLAN	R.083399	C13	MISCELLANEOUS DETAILS



FOX-D - KIVITOO, NU
Issued for Construction
February, 2017



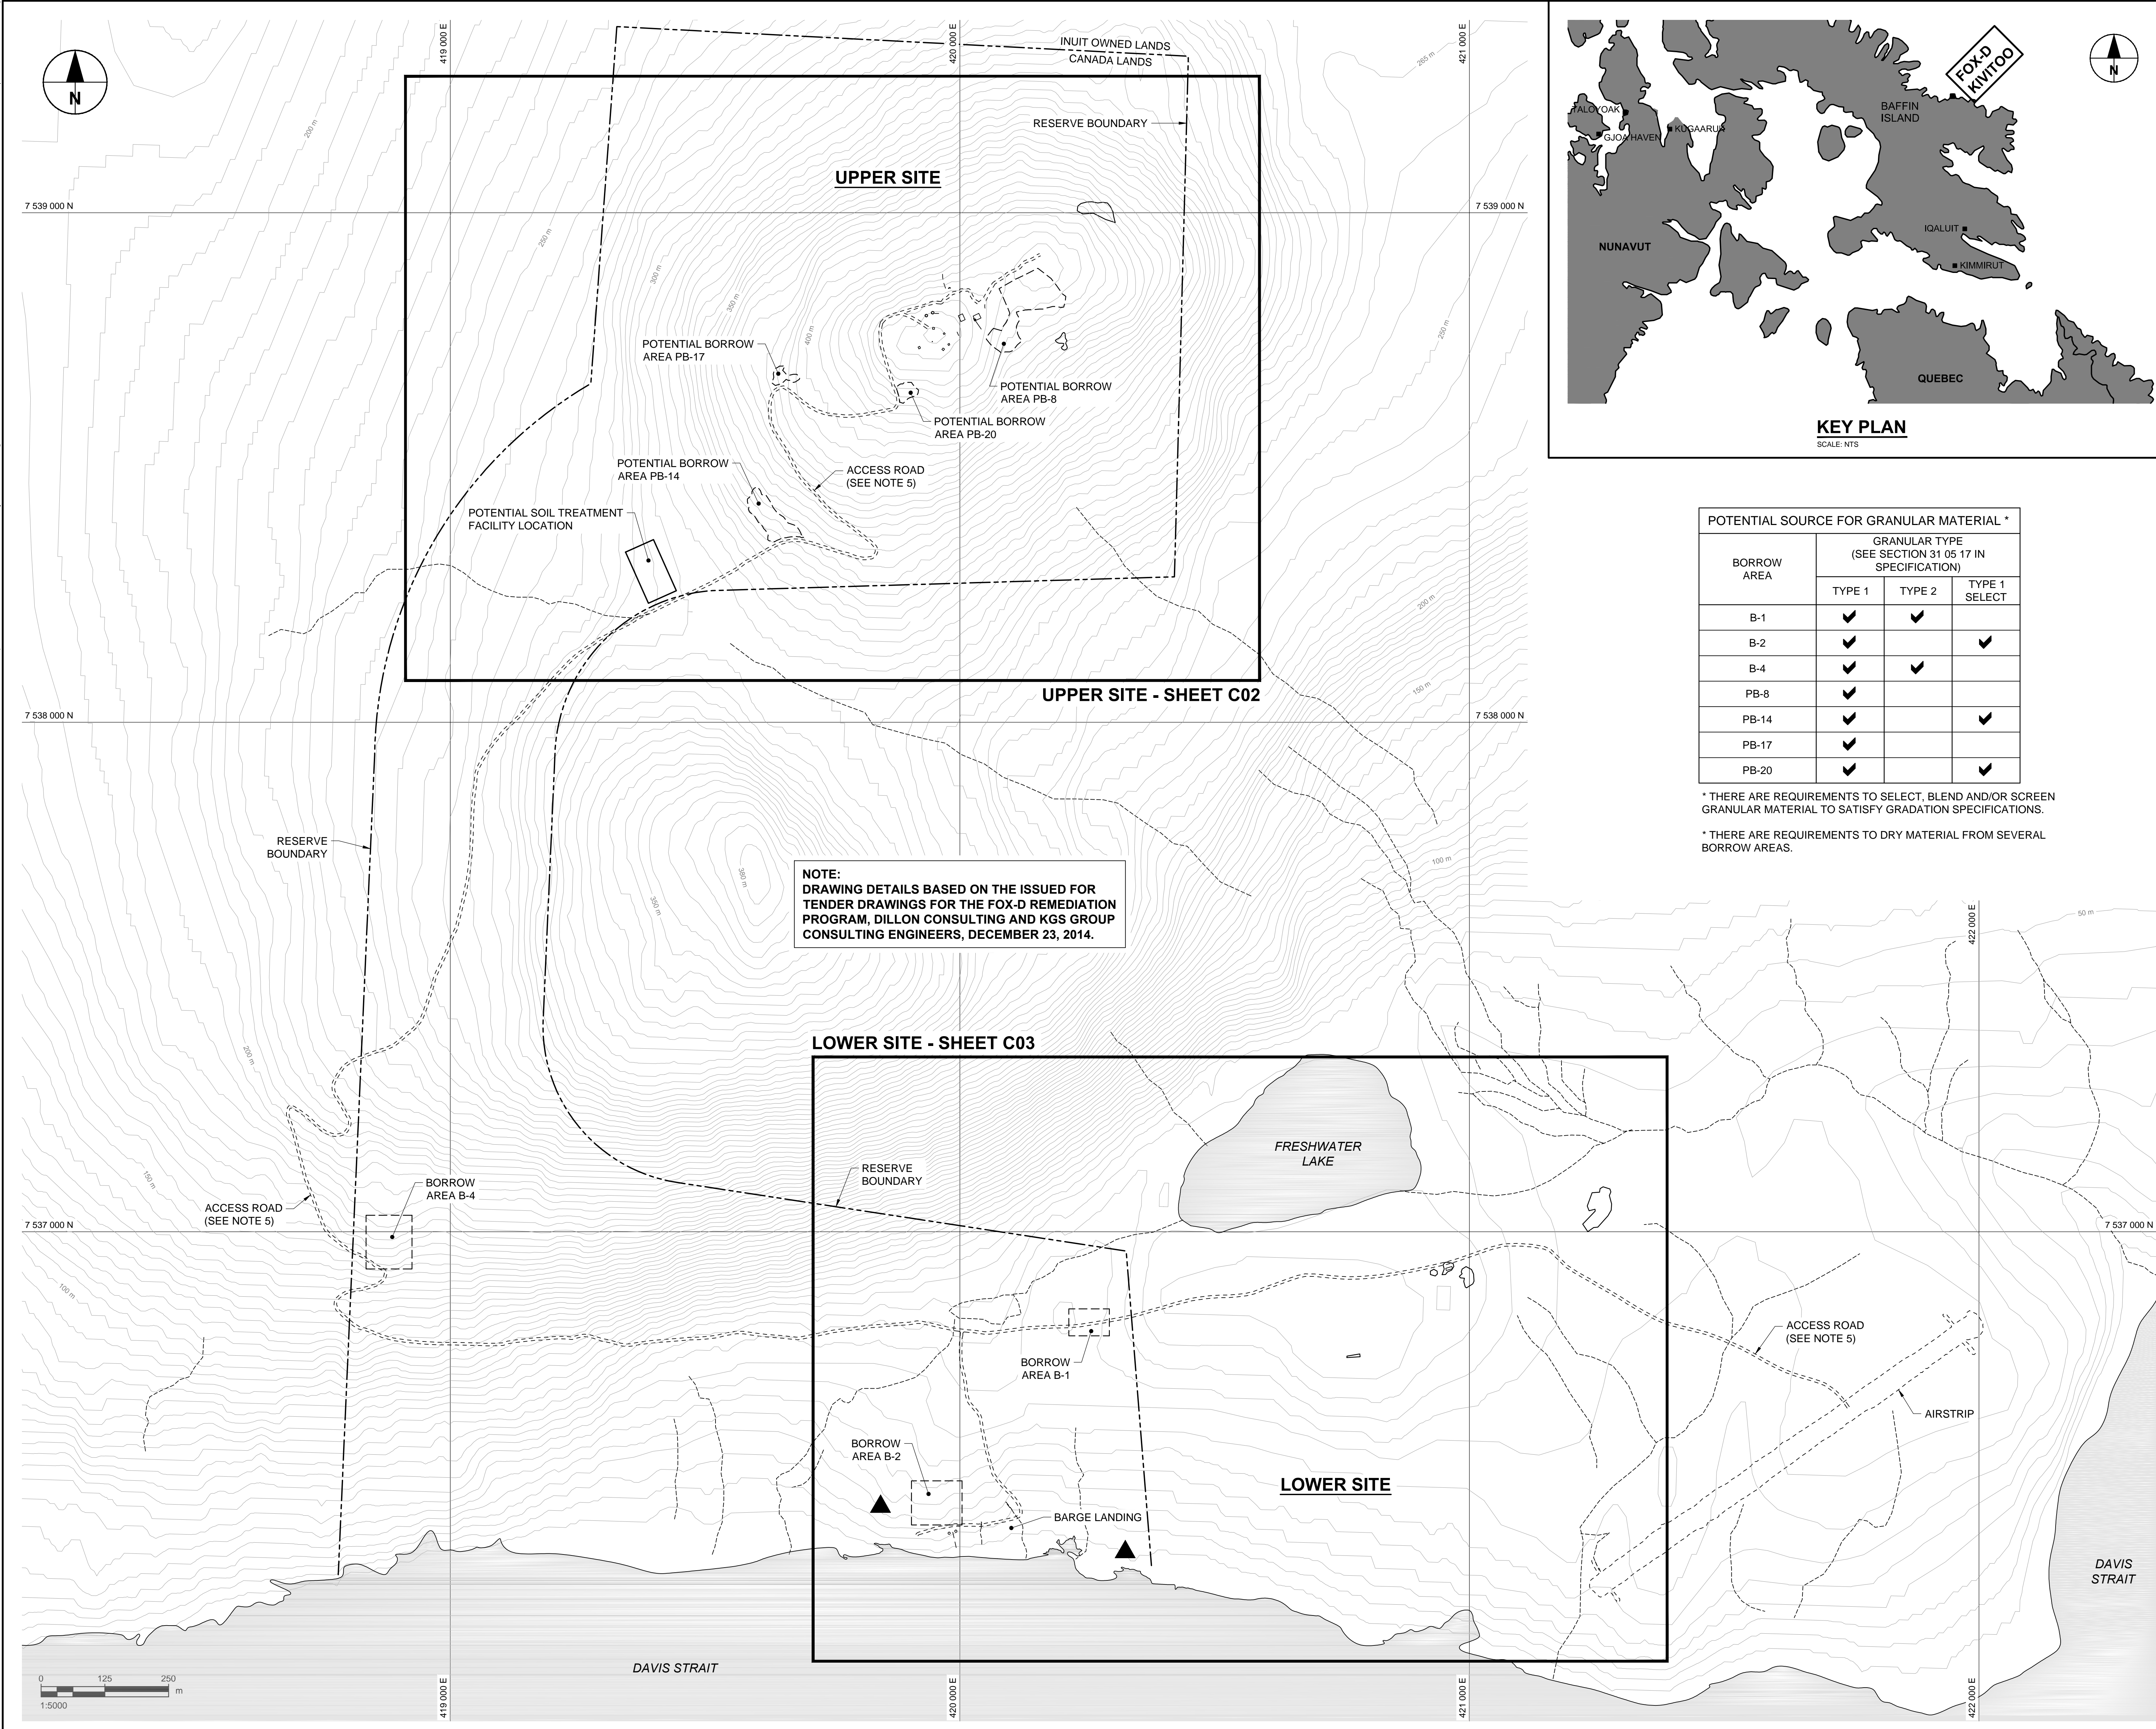



Public Works and
Government Services
Canada


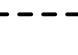





Travaux publics et
Services gouvernementaux
Canada

REAL PROPERTY SERVICES
Western Region
SERVICES IMMOBILIERS
Région de l'ouest

AECOM

This drawing has been prepared for the use of AECOM's client and may not be used, reproduced or relied upon by third parties, except as agreed by AECOM and its client. It is required by law or for use by governmental reviewing agencies. AECOM accepts no responsibility, and denies any liability, whatsoever, to any party that modifies the drawing without AECOM's written consent. All measurements must be obtained from stated dimensions. Do not scale this document.

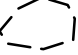GENERAL NOTES:
1. ALL DIMENSIONS ARE IN METRES, UNLESS NOTED OTHERWISE. ALL COORDINATES ARE REFERENCED TO NAD83 (CSRS), UTM ZONE 20N. ALL ELEVATIONS ARE IN METRES ABOVE SEA LEVEL (MSL).
2. CONTOURS ARE SUPPLIED FROM NRCAN, DERIVED FROM 1:60,000 STEREO PAIR IMAGERY.
3. CONTRACTOR SHALL NOT TRAVEL OFF EXISTING ROADS AND MUST STAY WITHIN THE DISTURBED LIMITS.
4. ENVIRONMENTAL RESTRICTED AREAS SHALL BE AVOIDED BY THE CONTRACTOR'S SITE ACTIVITIES.
5. CONTRACTOR IS RESPONSIBLE FOR UPGRADE OF ROAD AS DEEMED ACCEPTABLE BY DEPARTMENTAL REPRESENTATIVE.
6. AREA TO BE EXCAVATED MUST BE FIELD VERIFIED BY DEPARTMENTAL REPRESENTATIVE.
7. TWO (2) PERMANENT SURVEY CONTROL MONUMENTS TO BE INSTALLED. LOCATIONS OF PERMANENT SURVEY MONUMENTS TO BE DETERMINED BY DEPARTMENTAL REPRESENTATIVE.

LEGEND:
 WATER
 CROWN LAND
 ROAD
 DRAINAGE PATHWAYS
 CONTOUR (5 m INTERVAL)
 BORROW AREA
 ENVIRONMENTALLY RESTRICTED AREA

Professional: Seals / Sceaux

DO NOT SCALE DRAWINGS

0	ISSUED FOR CONSTRUCTION	1702206
Revision/ Révision	Description/Description	Date/Date

Client/client

PUBLIC WORKS
GOVERNMENT SERVICES
CANADA

Project title/Titre du projet

FOX-D
REMEDIATION PROJECT

Approved by/Approuvé par
R. MERKOSKY

Designed by/Concepté par
R. STUDER-HALBACH

Drawn by/Dessiné par
C. EROS

PWSSC Project Manager/Administrateur de Projets TPSGC
J. LEE

PWSSC Architectural and Engineering Resources Manager/
Ressources Architectural et de Directeur d'ingénierie, TPSGC

Client/client
PUBLIC WORKS AND GOVERNMENT SERVICES CANADA

Drawing title/Titre du dessin
OVERALL SITE PLAN

Project No./No. du projet
R.083399.001


Sheet/Feuille
C01
OF 13

Revision no./
La Révision no.
0

B1 - 1000 x 707

0 10 20 30 40 50 60 70 80 90 100 mm

R.083399_C01-RX.dwg

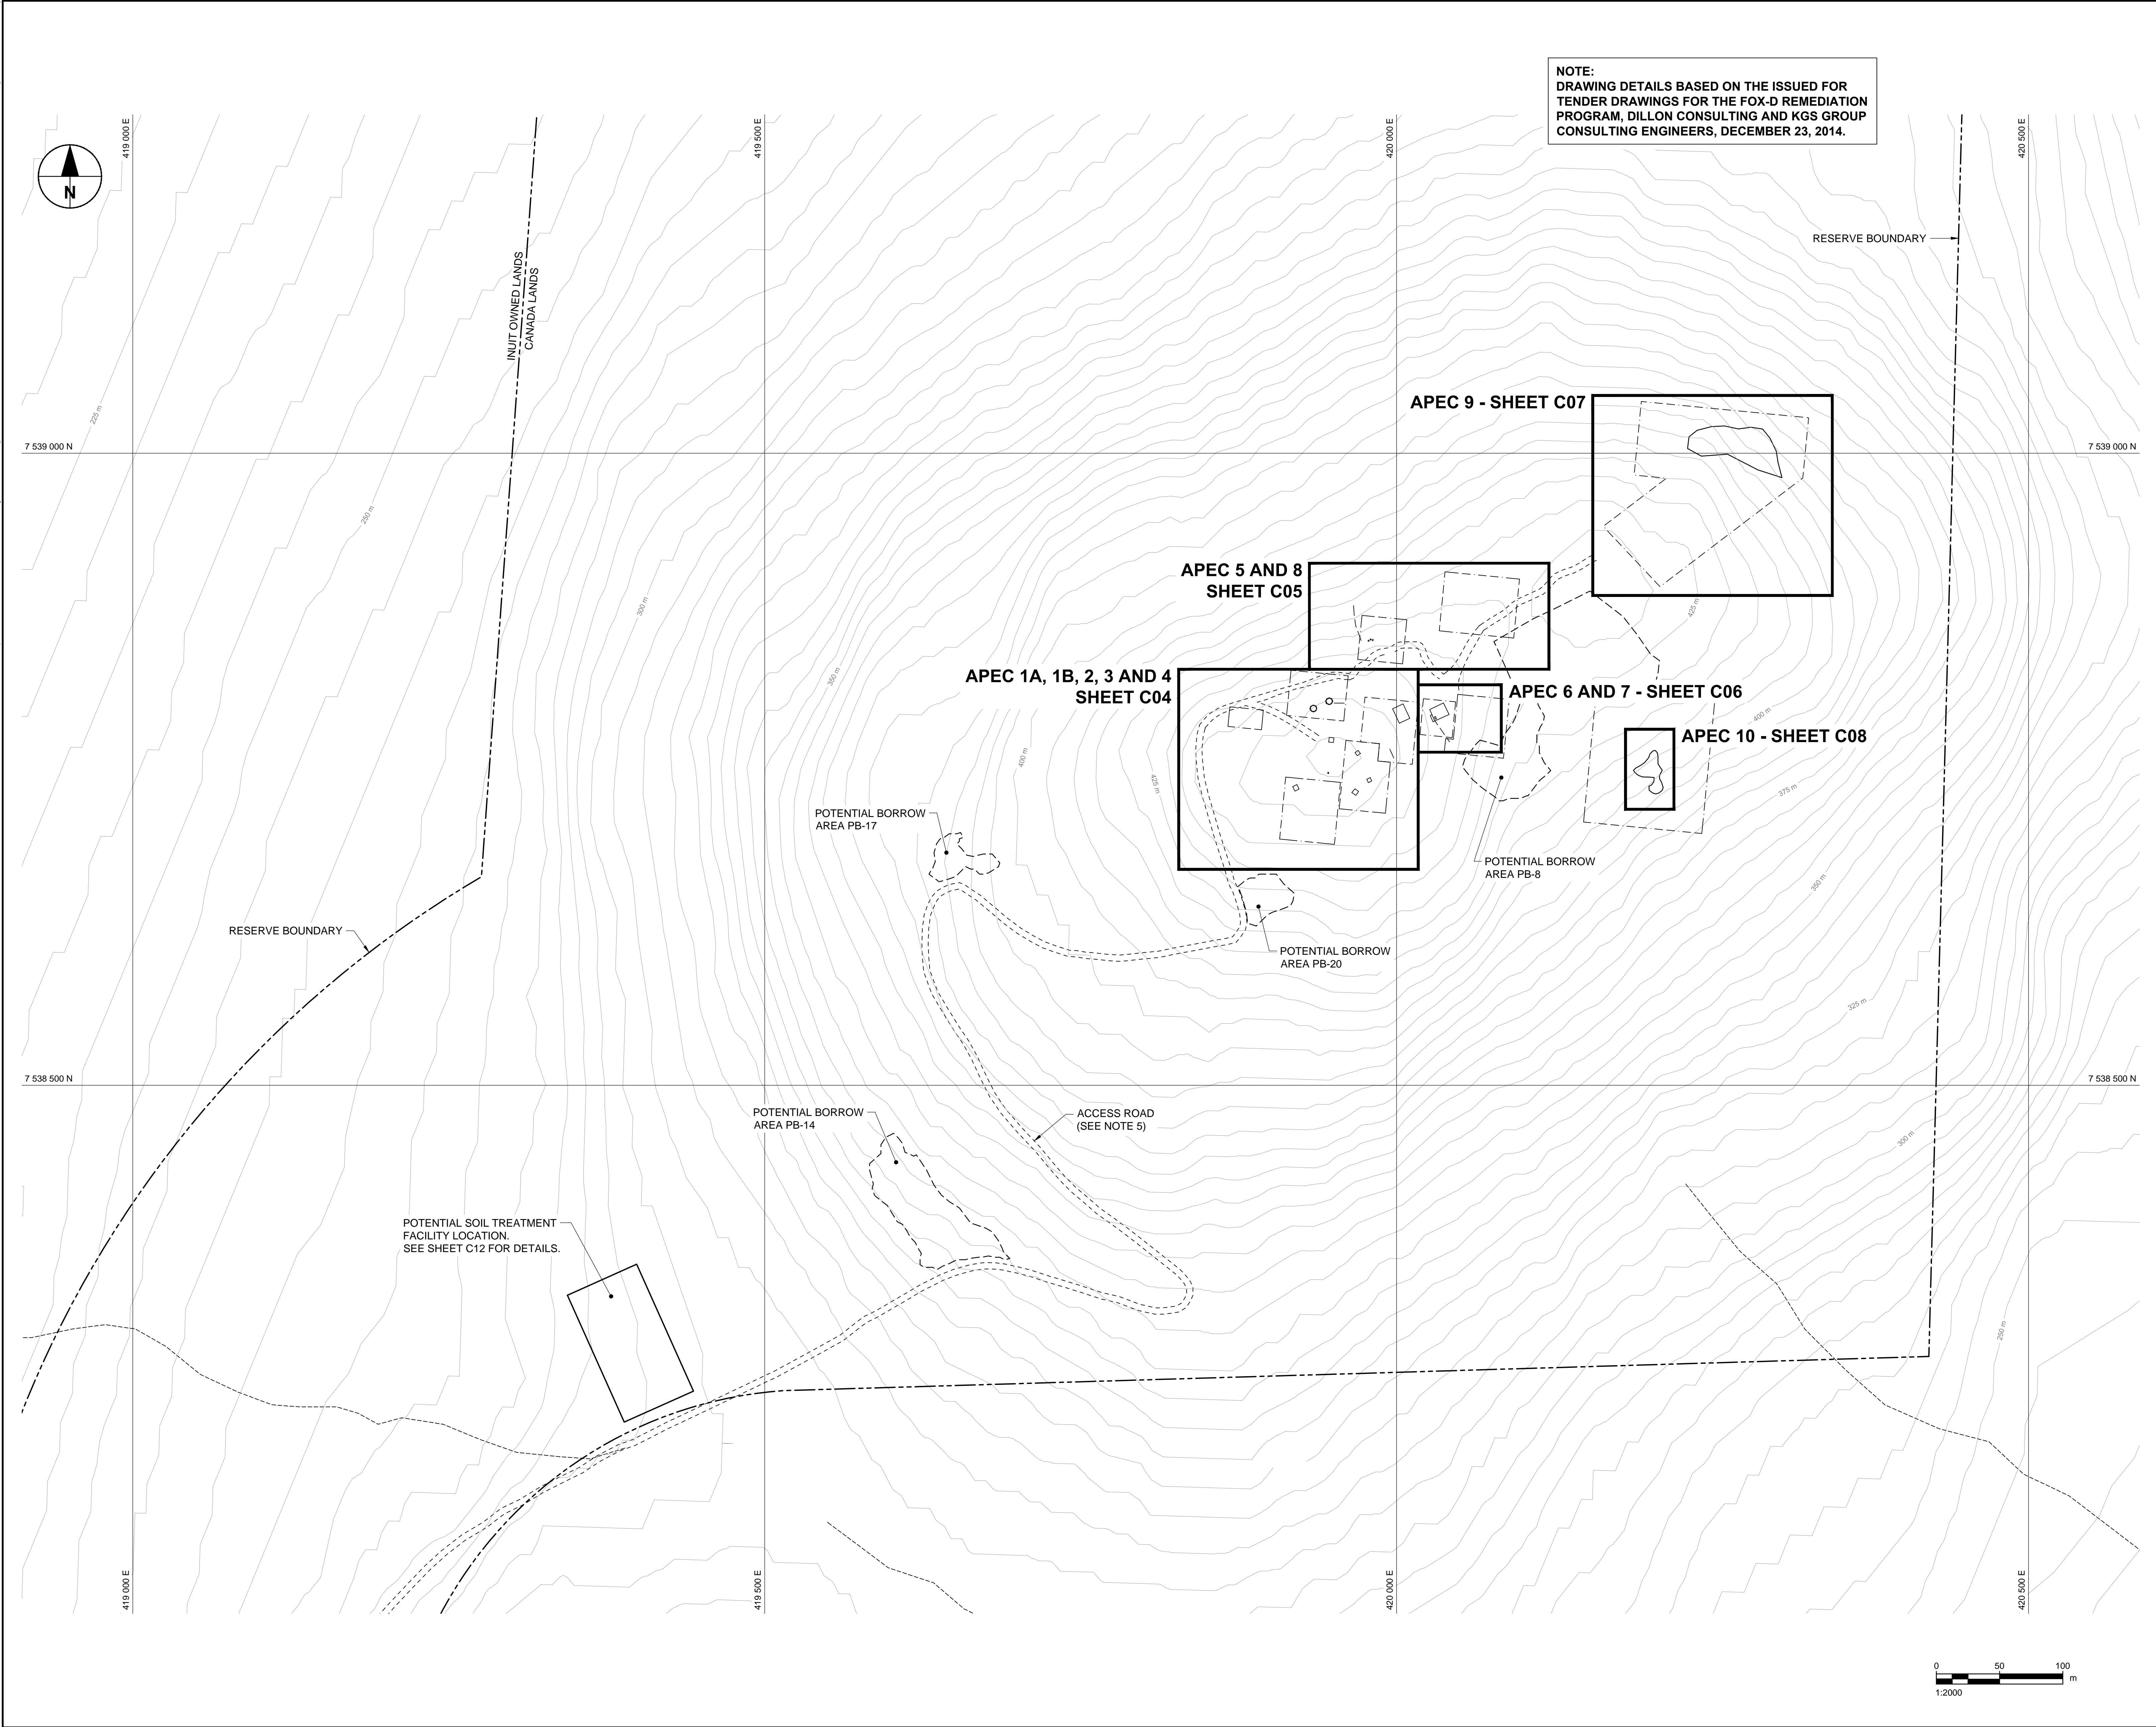

NOTE:
DRAWING DETAILS BASED ON THE ISSUED FOR
TENDER DRAWINGS FOR THE FOX-D REMEDIATION
PROGRAM, DILLON CONSULTING AND KGS GROUP
CONSULTING ENGINEERS, DECEMBER 23, 2014.

This drawing has been prepared for the use of AECOM's client and may not be used,
reproduced or relied upon by third parties, except as agreed by AECOM and its client.
As required by law or for use by governmental reviewing agencies.
AECOM accepts no responsibility, and denies any liability whatsoever, to any party that modifies
this drawing without AECOM's written consent. Measurements must be obtained from stated dimensions.
Do not scale this document.

GENERAL NOTES:

1. ALL DIMENSIONS ARE IN METRES, UNLESS NOTED OTHERWISE. ALL COORDINATES ARE REFERENCED TO NAD83 (CSRS), UTM ZONE 20N. ALL ELEVATIONS ARE IN METRES ABOVE SEA LEVEL (MSL).
2. CONTOURS ARE SUPPLIED FROM NRCAN, DERIVED FROM 1:60,000 STEREO PAIR IMAGERY.
3. CONTRACTOR SHALL NOT TRAVEL OFF EXISTING ROADS AND MUST STAY WITHIN THE DISTURBED LIMITS.
4. ENVIRONMENTAL RESTRICTED AREAS SHALL BE AVOIDED BY THE CONTRACTOR'S SITE ACTIVITIES.
5. CONTRACTOR IS RESPONSIBLE FOR UPGRADE OF ROAD AS DEEMED ACCEPTABLE BY DEPARTMENTAL REPRESENTATIVE.
6. AREA TO BE EXCAVATED MUST BE FIELD VERIFIED BY DEPARTMENTAL REPRESENTATIVE.
7. TWO (2) PERMANENT SURVEY CONTROL MONUMENTS TO BE INSTALLED. LOCATIONS OF PERMANENT SURVEY MONUMENTS TO BE DETERMINED BY DEPARTMENTAL REPRESENTATIVE AND VERIFIED IN THE FIELD BY THE CONSULTANT.

LEGEND:

- WATER
- CROWN LAND
- ROAD
- DRAINAGE PATHWAYS
- CONTOUR (5 m INTERVAL)
- BORROW AREA
- ENVIRONMENTALLY RESTRICTED AREA

Professional Seals / Sceaux

DO NOT SCALE DRAWINGS

0	ISSUED FOR CONSTRUCTION	1702206
Revision/ Revision	Description/Description	Date/Date

Client/client

PUBLIC WORKS
GOVERNMENT SERVICES
CANADA

Project title/Titre du projet

FOX-D
REMEDIATION PROJECT

Approved by/Approuvé par

R. MERKOSKY

Designed by/Concept par

R. STUDER-HALBACH

Drawn by/Dessiné par

C. EROS

PWSSC Project Manager/Administrateur de Projets TPSSC

J. LEE

PWSSC Architectural and Engineering Resources Manager/
Ressources Architectural et de Directeur d'ingénierie, TPSSC

Client/client

PUBLIC WORKS AND GOVERNMENT SERVICES CANADA

Drawing title/Titre du dessin

UPPER SITE
SITE PLAN

Project No./No. du projet


R.083399.001

Sheet/Feuille

C02
OF 13

Revision no./
La Révision no.

0

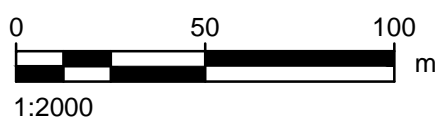


Sheet Size: B1 (1000mm x 707mm)

Saved by: Eros, Craig

Plotted on: February 6, 2017

CADD FILE LOCN: P:\050545900-WORK\910-CAD\20-SHEETS\C\FOX-D_C03-C03-RX.DWG

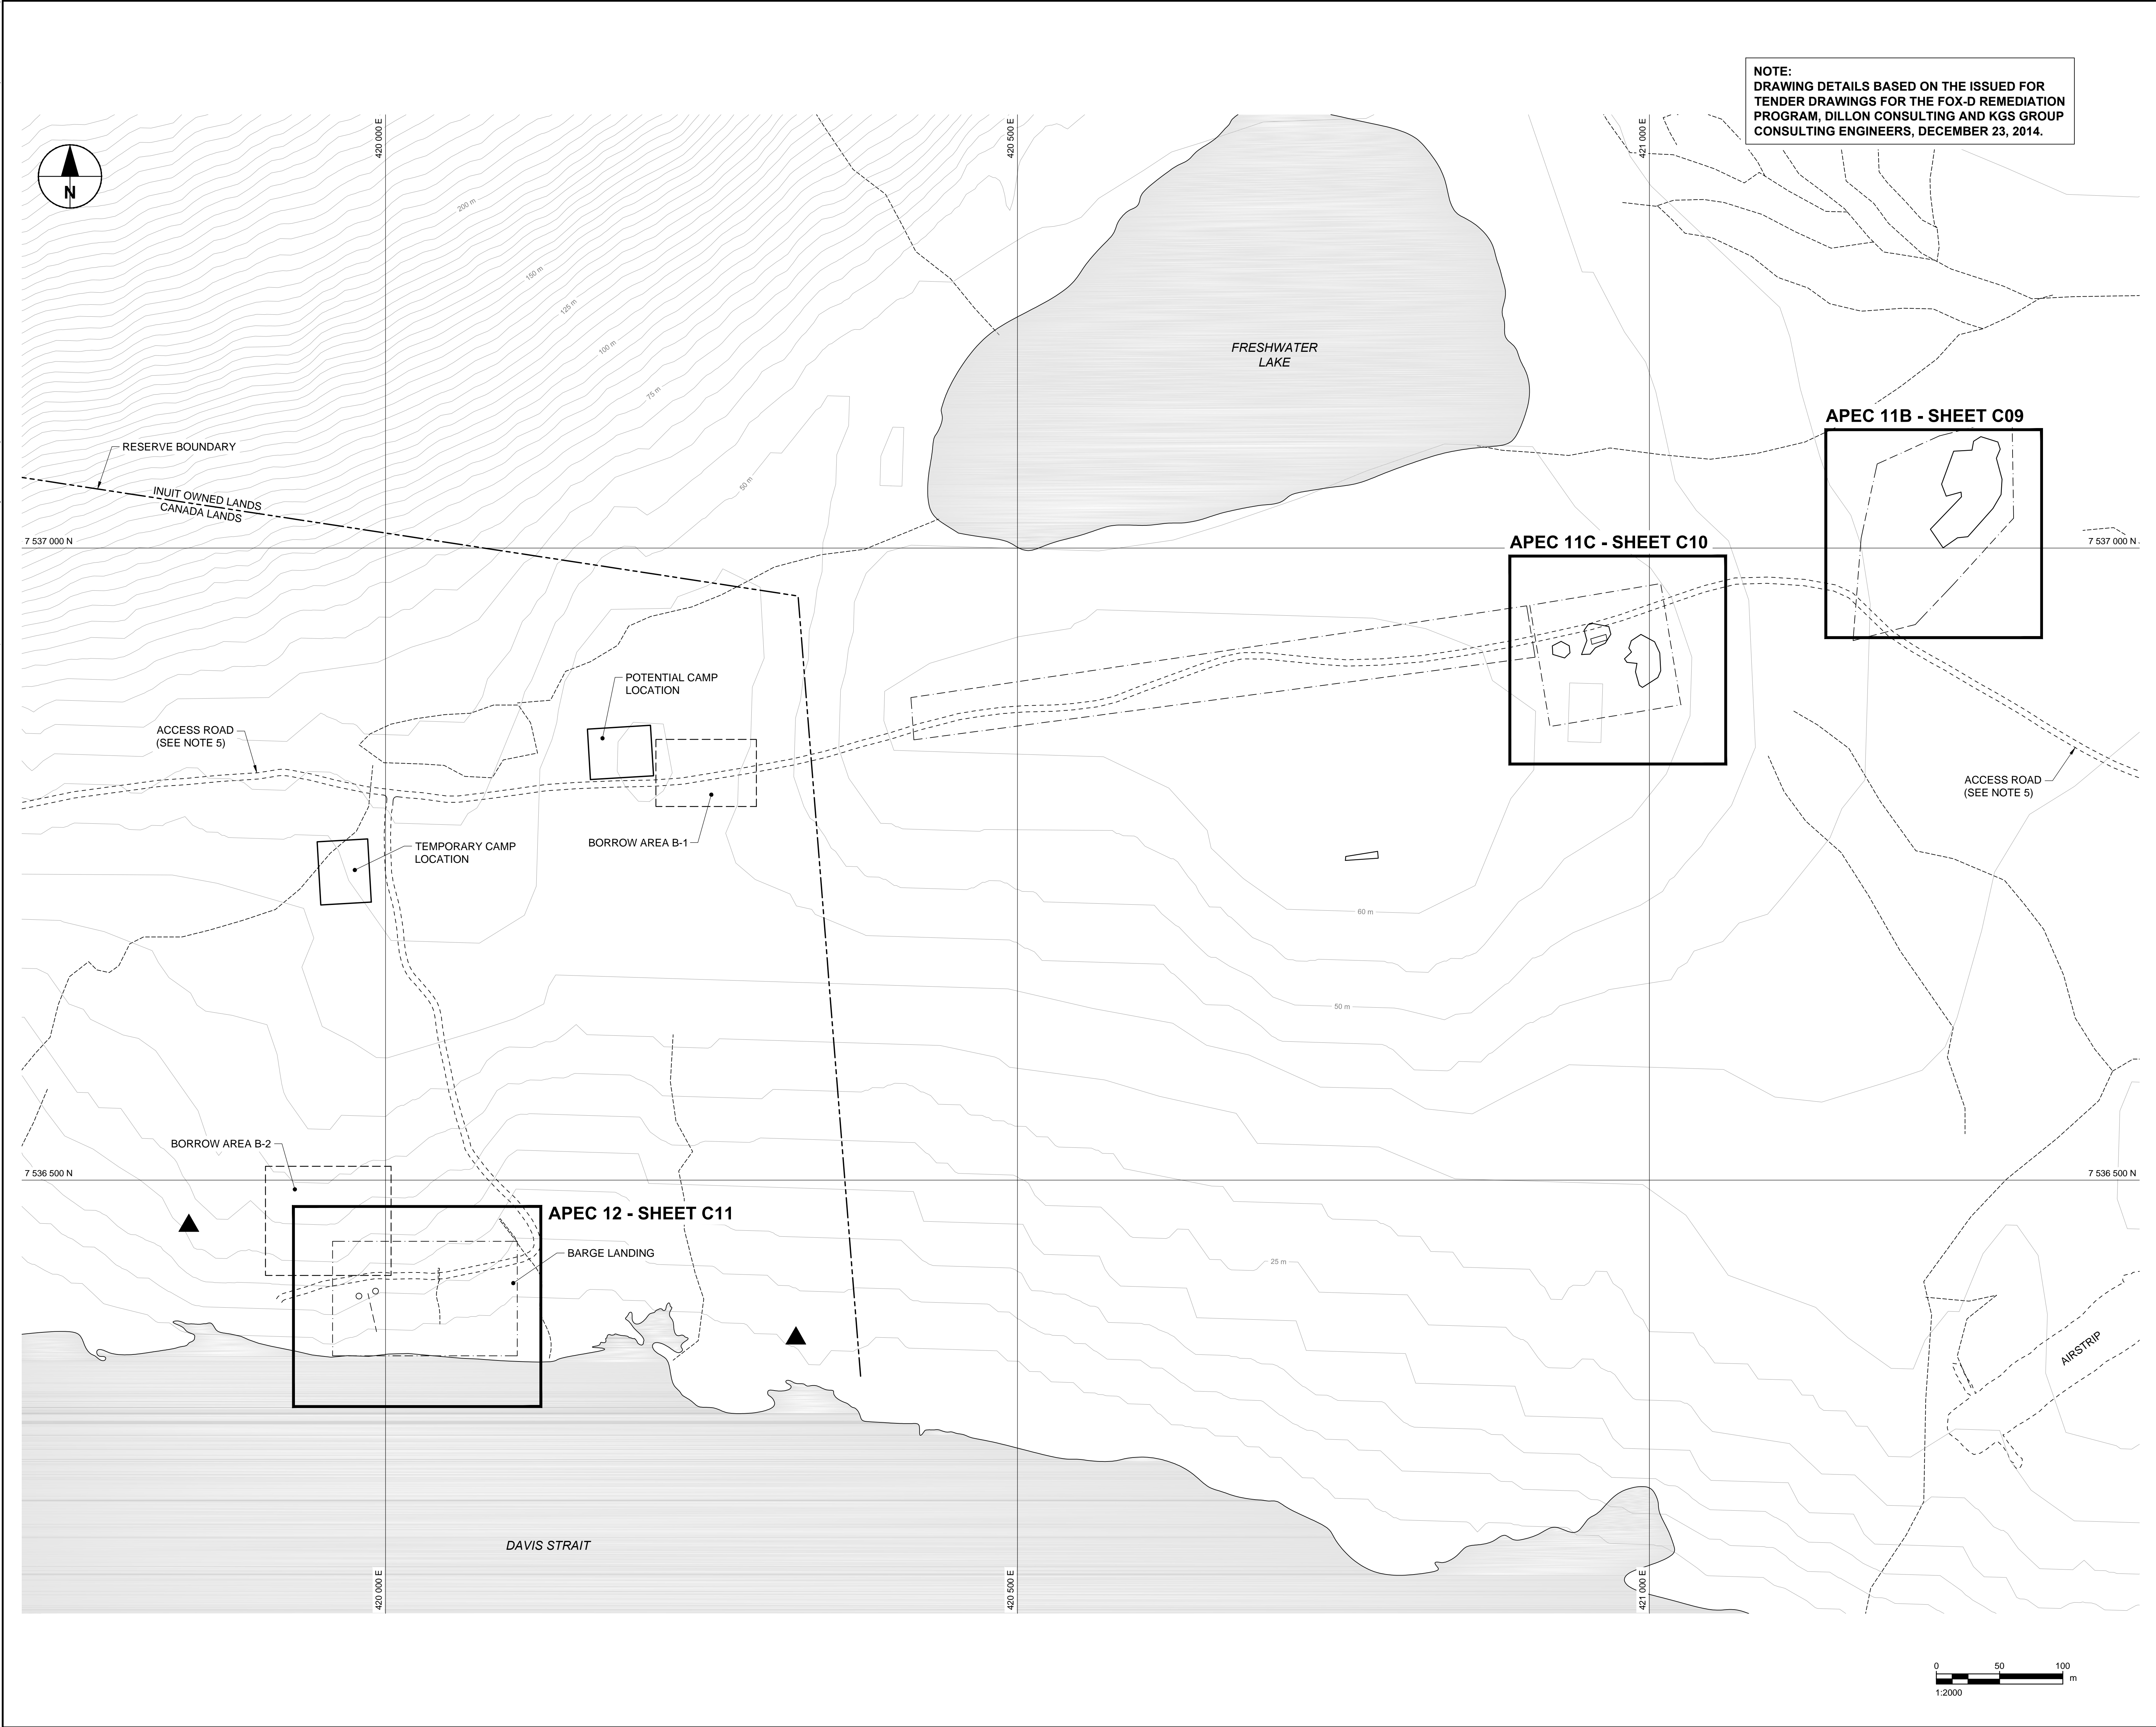


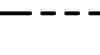





NOTE:
DRAWING DETAILS BASED ON THE ISSUED FOR
TENDER DRAWINGS FOR THE FOX-D REMEDIATION
PROGRAM, DILLON CONSULTING AND KGS GROUP
CONSULTING ENGINEERS, DECEMBER 23, 2014.

This drawing has been prepared for the use of AECOM's client and may not be used,
reproduced or relied upon by third parties, except as agreed by AECOM and its client.
As required by law or for use by governmental reviewing agencies.
AECOM accepts no responsibility, and denies any liability, whatsoever, to any party that modifies
this drawing without AECOM's written consent. All measurements must be obtained from stated dimensions.
Do not scale this document.

GENERAL NOTES:

1. ALL DIMENSIONS ARE IN METRES, UNLESS NOTED OTHERWISE. ALL COORDINATES ARE REFERENCED TO NAD83 (CSRS), UTM ZONE 20N. ALL ELEVATIONS ARE IN METRES ABOVE SEA LEVEL (MSL).
2. CONTOURS ARE SUPPLIED FROM NRCAN, DERIVED FROM 1:60,000 STEREO PAIR IMAGERY.
3. CONTRACTOR SHALL NOT TRAVEL OFF EXISTING ROADS AND MUST STAY WITHIN THE DISTURBED LIMITS.
4. ENVIRONMENTAL RESTRICTED AREAS SHALL BE AVOIDED BY THE CONTRACTOR'S SITE ACTIVITIES.
5. CONTRACTOR IS RESPONSIBLE FOR UPGRADE OF ROAD AS DEEMED ACCEPTABLE BY DEPARTMENTAL REPRESENTATIVE.
6. AREA TO BE EXCAVATED MUST BE FIELD VERIFIED BY DEPARTMENTAL REPRESENTATIVE.
7. TWO (2) PERMANENT SURVEY CONTROL MONUMENTS TO BE INSTALLED. LOCATIONS OF PERMANENT SURVEY MONUMENTS TO BE DETERMINED BY DEPARTMENTAL REPRESENTATIVE AND VERIFIED IN THE FIELD BY THE CONSULTANT.

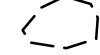LEGEND:

-  WATER
-  CROWN LAND
-  ROAD
-  DRAINAGE PATHWAYS
-  CONTOUR (5 m INTERVAL)
-  BORROW AREA
-  ENVIRONMENTALLY RESTRICTED AREA

Professional Seals / Sceaux

DO NOT SCALE DRAWINGS

0	ISSUED FOR CONSTRUCTION	1702206
Revision/ Revision	Description/Description	Date/Date

Client/client

**PUBLIC WORKS
GOVERNMENT SERVICES
CANADA**

Project title/Titre du projet

**FOX-D
REMEDIATION PROJECT**

Approved by/Approuvé par

R. MERKOSKY

Designed by/Concept par

R. STUDER-HALBACH

Drawn by/Dessiné par

C. EROS

PWSSC Project Manager/Administrateur de Projets TPSGC

J. LEE

PWSSC Architectural and Engineering Resources Manager/
Ressources Architectural et de Directeur d'ingénierie, TPSGC

Client/client

PUBLIC WORKS AND GOVERNMENT SERVICES CANADA

Drawing title/Titre du dessin

**LOWER SITE
SITE PLAN**

Project No./No. du projet

R.083399.001

Sheet/Feuille

C03
OF 13



Revision no./
La Révision no.

0

TYPE B CONTAMINATED SOIL EXCAVATION AT APEC 1B		
COORDINATE POINTS		
NO.	NORTHING	EASTING
101	7538808.5	419944.2
102	7538806.2	419955.8
103	7538797.3	419956.5
104	7538791.3	419936.2
105	7538804.9	419932.2
106	7538825.2	419925.8
107	7538825.2	419928.8
108	7538822.2	419928.8
109	7538822.2	419925.8
110	7538819.3	419930.3
111	7538819.3	419936.0
112	7538816.3	419936.0
113	7538816.3	419930.3

TIER II - TYPE B CONTAMINATED SOIL EXCAVATION AT APEC 3		
COORDINATE POINTS		
NO.	NORTHING	EASTING
301	7538766.3	419961.8
302	7538772.6	419976.8
303	7538738.2	419991.2
304	7538732.0	419976.5

TYPE B CONTAMINATED SOIL EXCAVATION AT APEC 4		
COORDINATE POINTS		
NO.	NORTHING	EASTING
401	7538785.4	419977.6
402	7538776.5	419989.9
403	7538769.6	419993.0
404	7538773.5	420001.7
405	7538764.0	420006.0
406	7538754.8	419985.5
407	7538757.6	419984.2
408	7538769.2	419984.6
409	7538778.3	419972.3
410	7538787.9	419998.2
411	7538789.2	420000.9
412	7538786.5	420002.2
413	7538785.2	419999.5

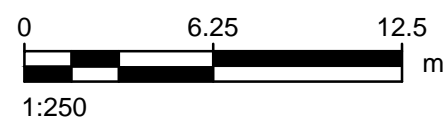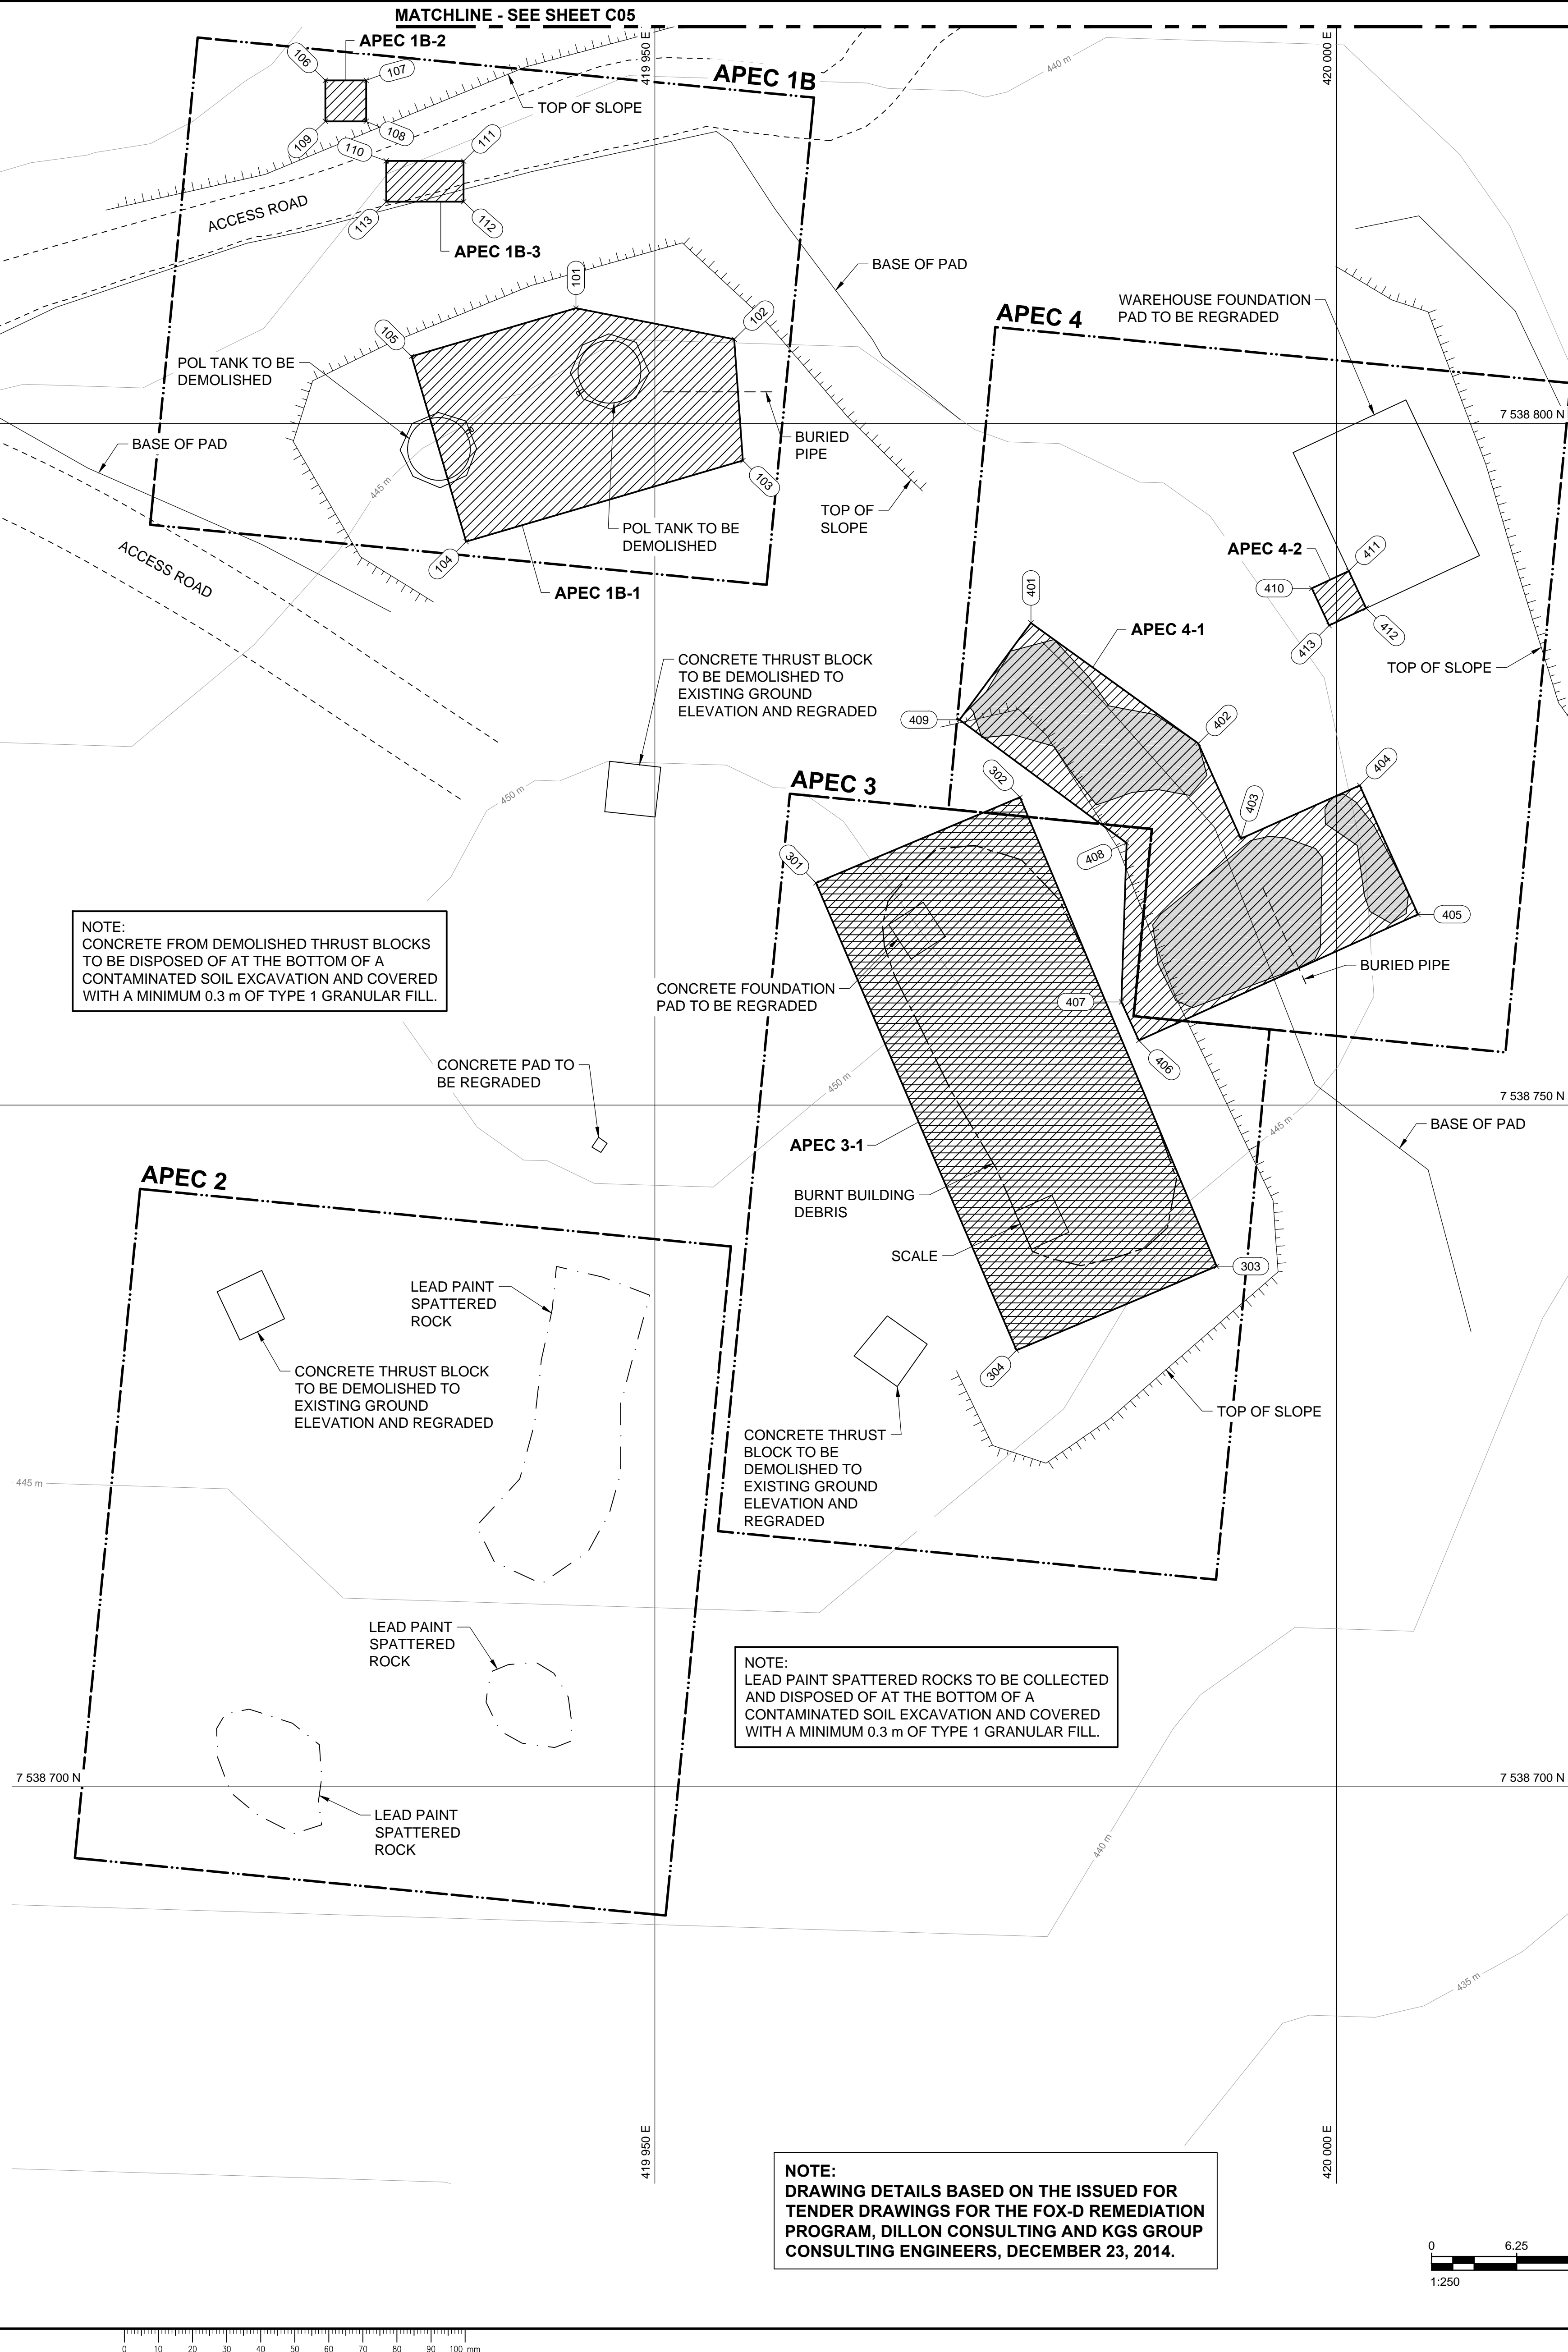

GENERAL NOTES:

1. ALL DIMENSIONS ARE IN METRES, UNLESS NOTED OTHERWISE. ALL COORDINATES ARE REFERENCED TO NAD83 (CSRS), UTM ZONE 20N. ALL ELEVATIONS ARE IN METRES ABOVE SEA LEVEL (MSL).
2. CONTOURS ARE SUPPLIED FROM NRCAN, DERIVED FROM 1:60,000 STEREO PAIR IMAGERY.
3. ALL SURFACE DEBRIS IS TO BE REMOVED FROM ALL CONTAMINATED SOIL AREAS AND EXISTING BURIED DEBRIS AREAS PRIOR TO EXCAVATION OR FILL PLACEMENT.
4. REGRADED SIDE SLOPES TO BE 6H:1V UNLESS NOTED OTHERWISE.

LEGEND:

- ROAD
- CONTOUR (5 m INTERVAL)
- APEC BOUNDARY
- STAINING
- ESTIMATED EXTENTS OF TYPE A PHC CONTAMINATED SOIL
- ESTIMATED EXTENTS OF TYPE B PHC CONTAMINATED SOIL
- ESTIMATED EXTENTS OF TIER I CONTAMINATED SOIL
- ESTIMATED EXTENTS OF TIER II CONTAMINATED SOIL
- COORDINATE POINT

Professional: Seals / Scaus

DO NOT SCALE DRAWINGS

0	ISSUED FOR CONSTRUCTION	17/02/06
Revision/Revision	Description/Description	Date/Date

Client/client

PUBLIC WORKS
GOVERNMENT SERVICES
CANADA

Project title/Titre du projet

FOX-D
REMEDATION PROJECT

Approved by/Approuvé par

R. MERKOSKY

Designed by/Concept par

R. STUDER-HALBACH

Drawn by/Dessiné par

C. EROS

PWSSC Project Manager/Administrateur de Projets TPSSC

J. LEE

PWSSC: Architectural and Engineering Resources Manager/
Ressources Architectural et de Directeur d'ingénierie, TPSSC

Client/client

PUBLIC WORKS AND GOVERNMENT SERVICES CANADA

Drawing title/Titre du dessin

APEC 1A, 1B, 2, 3 AND 4
SITE PLAN

Project No./No. du projet

R.083399.001


Sheet/Feuille

C04

OF 13

Revision no./
La Révision no.

0

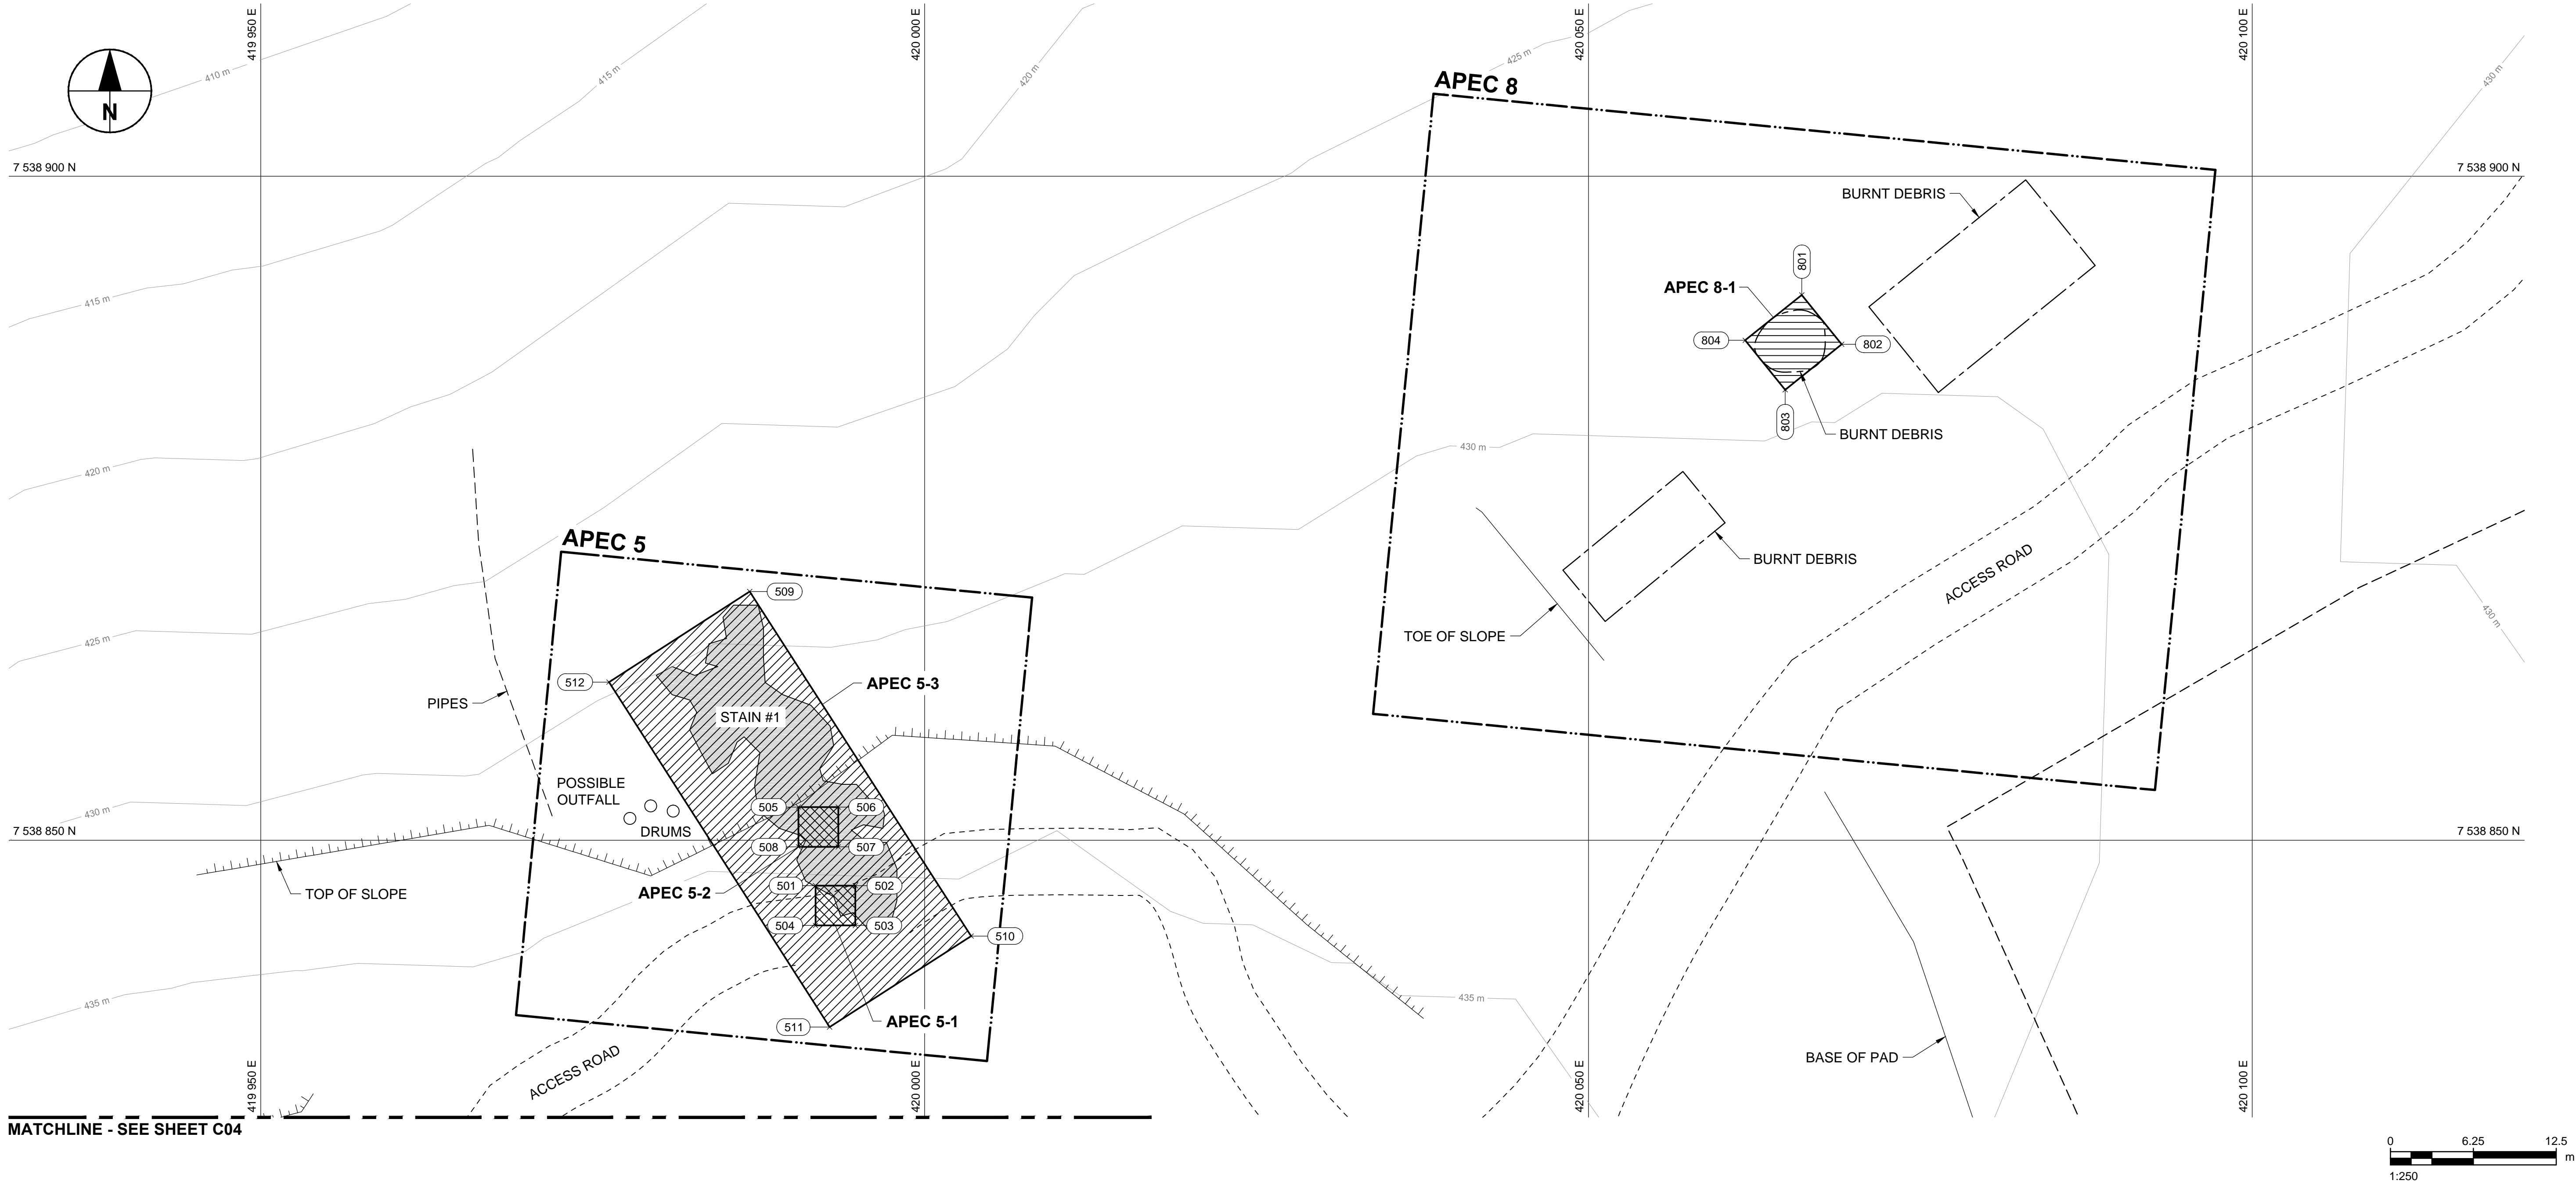

NOTE:
DRAWING DETAILS BASED ON THE ISSUED FOR
TENDER DRAWINGS FOR THE FOX-D REMEDIATION
PROGRAM, DILLON CONSULTING AND KGS GROUP
CONSULTING ENGINEERS, DECEMBER 23, 2014.

This drawing has been prepared for the use of AECOM's client and may not be used, reproduced or relied upon by third parties, except as agreed by AECOM and its client. AECOM accepts no responsibility, and denies any liability whatsoever, to any party that modifies this drawing without AECOM's express written consent. Do not scale this document. All measurements must be obtained from stated dimensions.

GENERAL NOTES:

1. ALL DIMENSIONS ARE IN METRES, UNLESS NOTED OTHERWISE. ALL COORDINATES ARE REFERENCED TO NAD83 (CSRS), UTM ZONE 20N. ALL ELEVATIONS ARE IN METRES ABOVE SEA LEVEL (MSL).
2. CONTOURS ARE SUPPLIED FROM NRCAN, DERIVED FROM 1:60,000 STEREO PAIR IMAGERY.
3. ALL SURFACE DEBRIS IS TO BE REMOVED FROM ALL CONTAMINATED SOIL AREAS AND EXISTING BURIED DEBRIS AREAS PRIOR TO EXCAVATION OR FILL PLACEMENT.
4. REGRADED SIDE SLOPES TO BE 6H:1V UNLESS NOTED OTHERWISE.

LEGEND:

- ROAD
- CONTOUR (5 m INTERVAL)
- APEC BOUNDARY
- STAINING
- ESTIMATED EXTENTS OF TYPE A PHC CONTAMINATED SOIL
- ESTIMATED EXTENTS OF TYPE B PHC CONTAMINATED SOIL
- ESTIMATED EXTENTS OF TIER I CONTAMINATED SOIL
- ESTIMATED EXTENTS OF TIER II CONTAMINATED SOIL
- COORDINATE POINT

Professional Seals / Sceaux

DO NOT SCALE DRAWINGS

0	ISSUED FOR CONSTRUCTION	17/02/06
Revision/ Revision	Description/Description	Date/Date

Client/client

PUBLIC WORKS
GOVERNMENT SERVICES
CANADA

Project title/Titre du projet

FOX-D
REMEDIATION PROJECT

Approved by/Approuvé par

R. MERKOSKY

Designed by/Conçu par

R. STUDER-HALBACH

Drawn by/Dessiné par

C. EROS

PWSSC Project Manager/Administrateur de Projets TPSSC

J. LEE

PWSSC Architectural and Engineering Resources Manager/
Ressources Architectural et de Directeur d'ingénierie, TPSSC

Client/client

PUBLIC WORKS AND GOVERNMENT SERVICES CANADA

Drawing title/Titre du dessin

APEC 5 AND 8
SITE PLAN

Project No./No. du projet

R.083399.001

Sheet/Feuille

C05
OF 13

Revision no./
La Revision no.

0





TIER I - TYPE B AND TYPE B CONTAMINATED SOIL EXCAVATION AT APEC 4		
COORDINATE POINTS		
NO.	NORTHING	EASTING
601	7538788.2	420030.2
602	7538789.4	420032.9
603	7538786.7	420034.2
604	7538785.5	420031.4
605	7538793.3	420041.5
606	7538789.6	420045.8
607	7538788.0	420046.0
608	7538776.6	420037.0
609	7538780.2	420026.7
610	7538779.5	420027.2
611	7538782.9	420025.7

TIER II - TYPE B, TYPE A AND TYPE B CONTAMINATED SOIL EXCAVATION AT APEC 7		
COORDINATE POINTS		
NO.	NORTHING	EASTING
701	7538796.3	420049.1
702	7538796.3	420052.1
703	7538793.3	420052.1
704	7538793.3	420049.1
705	7538796.9	420056.8
706	7538796.9	420059.8
707	7538793.9	420059.8
708	7538793.9	420056.8
709	7538793.5	420062.5
710	7538793.5	420065.5
711	7538790.5	420065.5
712	7538790.5	420062.5
713	7538802.2	420058.1
714	7538798.8	420072.2
715	7538794.1	420069.1
716	7538783.9	420076.1
717	7538774.1	420069.7
718	7538780.0	420060.7
719	7538772.4	420050.1
720	7538772.2	420047.5
721	7538790.1	420057.1
722	7538790.1	420062.1
723	7538785.1	420062.1
724	7538785.1	420057.1
725	7538811.8	420070.3
726	7538811.8	420073.3
727	7538808.8	420073.3
728	7538808.8	420070.3

NOTE:
DRAWING DETAILS BASED ON THE ISSUED FOR
TENDER DRAWINGS FOR THE FOX-D REMEDIATION
PROGRAM, DILLON CONSULTING AND KGS GROUP
CONSULTING ENGINEERS, DECEMBER 23, 2014.

CONTAMINATED SOIL EXCAVATION				
AREA NAME	APPROX. AREA (m2)	ESTIMATED DEPTH OF CONTAMINATION (m)	CONTAMINANT TYPE	DISPOSAL COMMENTS
APEC 6-1	9	0.3	TIER I - TYPE B PHC	OFF SITE DISPOSAL
APEC 6-2	162	1.5	TYPE B PHC	ON SITE TREATMENT
APEC 7-1	9	0.3	TYPE A PHC	OFF SITE DISPOSAL
APEC 7-2	9	0.3	TIER II - TYPE B PHC	OFF SITE DISPOSAL
APEC 7-3	9	0.3	TYPE A PHC	OFF SITE DISPOSAL
APEC 7-4	667	0.5	TYPE B PHC	ON SITE TREATMENT
APEC 7-5	25	1.5	TYPE B PHC	ON SITE TREATMENT
APEC 7-6	9	0.5	TYPE B PHC	ON SITE TREATMENT

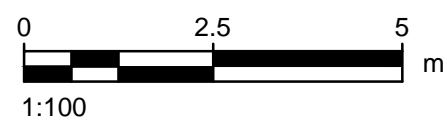

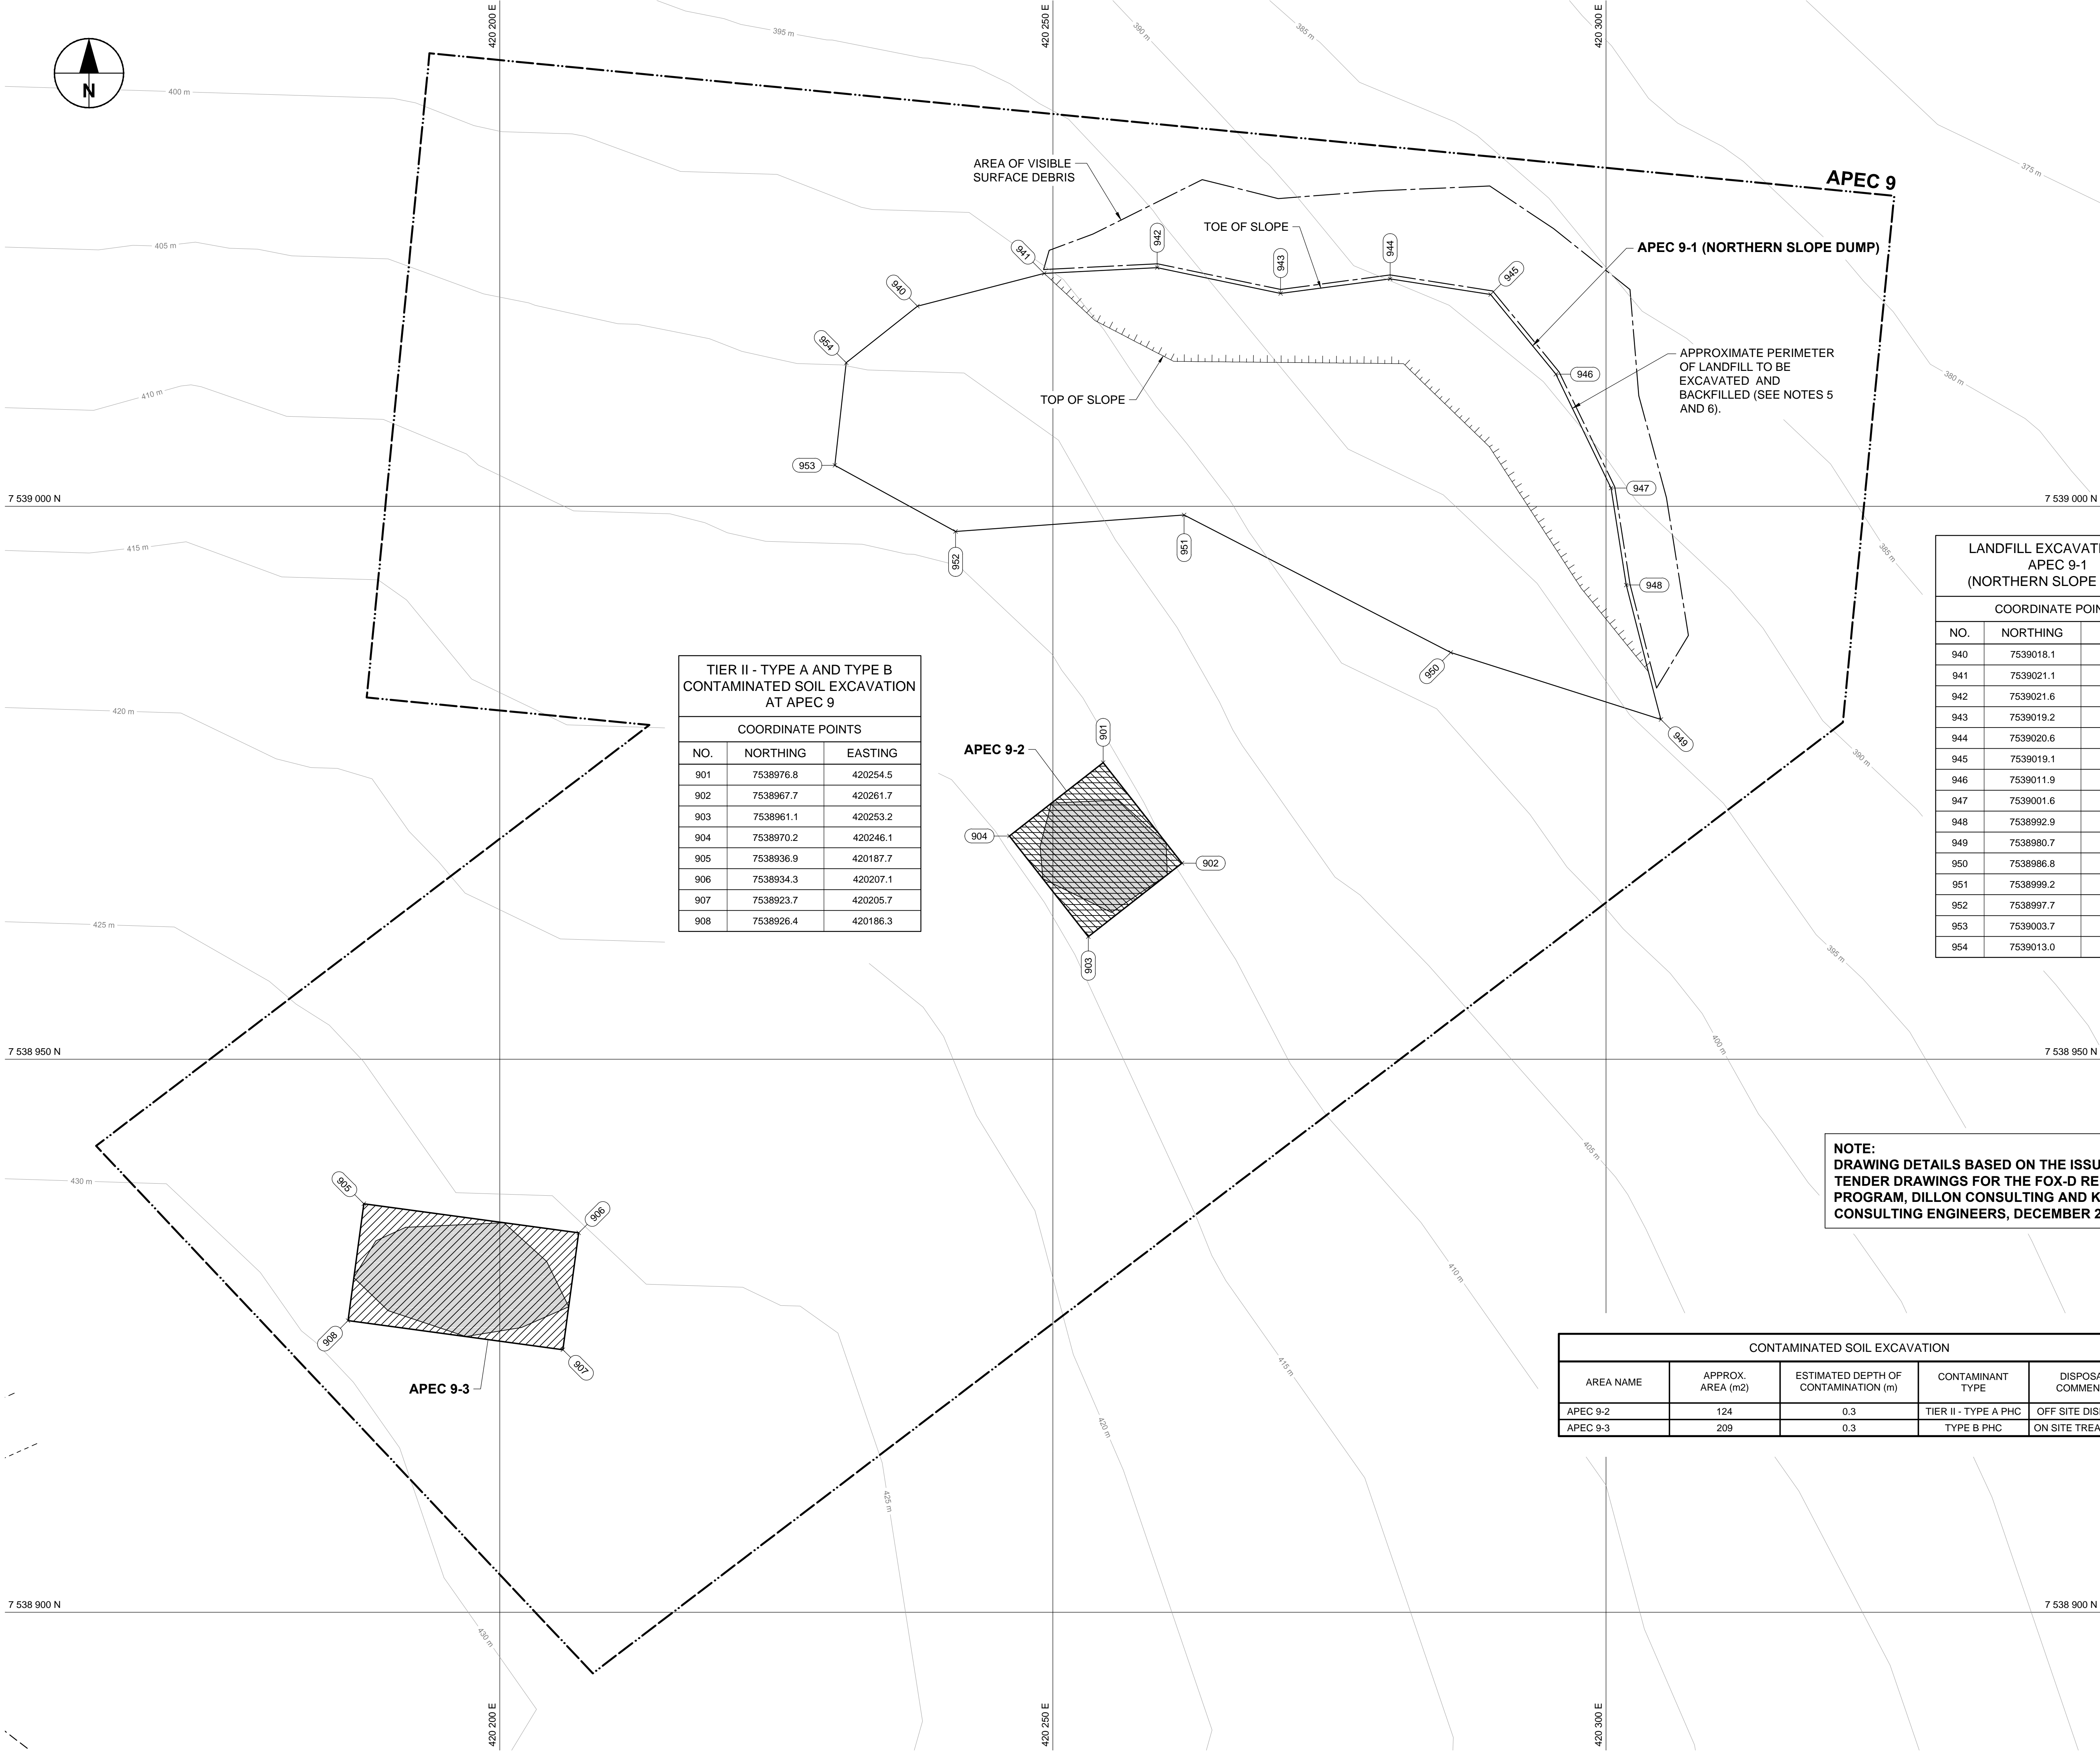

TIER II - TYPE A AND TYPE B CONTAMINATED SOIL EXCAVATION AT APEC 9		
COORDINATE POINTS		
NO.	NORTHING	EASTING
901	7538976.8	420254.5
902	7538967.7	420261.7
903	7538961.1	420253.2
904	7538970.2	420246.1
905	7538936.9	420187.7
906	7538934.3	420207.1
907	7538923.7	420205.7
908	7538926.4	420186.3

LANDFILL EXCAVATION AT APEC 9-1 (NORTHERN SLOPE DUMP)		
COORDINATE POINTS		
NO.	NORTHING	EASTING
940	7539018.1	420237.8
941	7539021.1	420249.2
942	7539021.6	420259.4
943	7539019.2	420270.6
944	7539020.6	420280.5
945	7539019.1	420289.6
946	7539011.9	420295.5
947	7539001.6	420300.5
948	7538992.9	420301.8
949	7538980.7	420305.0
950	7538986.8	420286.0
951	7538999.2	420261.9
952	7538997.7	420241.2
953	7539003.7	420230.3
954	7539013.0	420231.3

NOTE:
DRAWING DETAILS BASED ON THE ISSUED FOR
TENDER DRAWINGS FOR THE FOX-D REMEDIATION
PROGRAM, DILLON CONSULTING AND KGS GROUP
CONSULTING ENGINEERS, DECEMBER 23, 2014.

CONTAMINATED SOIL EXCAVATION				
AREA NAME	APPROX. AREA (m2)	ESTIMATED DEPTH OF CONTAMINATION (m)	CONTAMINANT TYPE	DISPOSAL COMMENTS
APEC 9-2	124	0.3	TIER II - TYPE A PHC	OFF SITE DISPOSAL
APEC 9-3	209	0.3	TYPE B PHC	ON SITE TREATMENT

This drawing has been prepared for the use of AECOM's client and may not be used, reproduced or relied upon by third parties, except as agreed by AECOM and its client. AECOM accepts no responsibility, and denies any liability whatsoever, to any party that modifies this drawing without AECOM's express written consent. All measurements must be obtained from stated dimensions.

GENERAL NOTES:

1. ALL DIMENSIONS ARE IN METRES, UNLESS NOTED OTHERWISE. ALL COORDINATES ARE REFERENCED TO NAD83 (CSRS), UTM ZONE 20N. ALL ELEVATIONS ARE IN METRES ABOVE SEA LEVEL (MSL).
2. CONTOURS ARE SUPPLIED FROM NRCAN, DERIVED FROM 1:60,000 STEREO PAIR IMAGERY.
3. ALL SURFACE DEBRIS IS TO BE REMOVED FROM ALL CONTAMINATED SOIL AREAS AND EXISTING BURIED DEBRIS AREAS PRIOR TO EXCAVATION OR FILL PLACEMENT.
4. REGRADED SIDE SLOPES TO BE 6H:1V UNLESS NOTED OTHERWISE.
5. REPLACE CLEAN BURIED DEBRIS EXCAVATION SOILS AS BACKFILL. CAP AREAS WITH 0.3 m OF TYPE 1 GRANULAR FILL OVER THE CLEAN BACKFILL.
6. DEPTH OF BURIED DEBRIS EXCAVATION TO EXTEND TO BASE OF DEBRIS. LIMIT AND DEPTH OF EXCAVATION TO BE VERIFIED BY EXCAVATION OF TESTPITS.

LEGEND:

- ROAD
- CONTOUR (5 m INTERVAL)
- APEC BOUNDARY
- STAINING
- ESTIMATED EXTENTS OF TYPE A PHC CONTAMINATED SOIL
- ESTIMATED EXTENTS OF TYPE B PHC CONTAMINATED SOIL
- ESTIMATED EXTENTS OF TIER I CONTAMINATED SOIL
- ESTIMATED EXTENTS OF TIER II CONTAMINATED SOIL
- COORDINATE POINT

Professional: Seals / Sceaux

DO NOT SCALE DRAWINGS

0	ISSUED FOR CONSTRUCTION	1702206
Revision/ Revision	Description/Description	Date/Date

Client/client

PUBLIC WORKS
GOVERNMENT SERVICES
CANADA

Project title/Titre du projet

FOX-D
REMEDATION PROJECT

Approved by/Approuvé par
R. MERKOSKY

Designed by/Concepté par
R. STUDER-HALBACH

Drawn by/Dessiné par
C. EROS

PWSSC Project Manager/Administrateur de Projets TPSGC

J. LEE

PWSSC: Architectural and Engineering Resources Manager/
Ressources Architectural et de Directeur d'ingénierie, TPSGC


Client/client

PUBLIC WORKS AND GOVERNMENT SERVICES CANADA

Drawing title/Titre du dessin

APEC 9
SITE PLAN

Project No./No. du projet	Sheet/Feuille	Revision no./ La Revision no.
R.083399.001	C07 OF 13	0

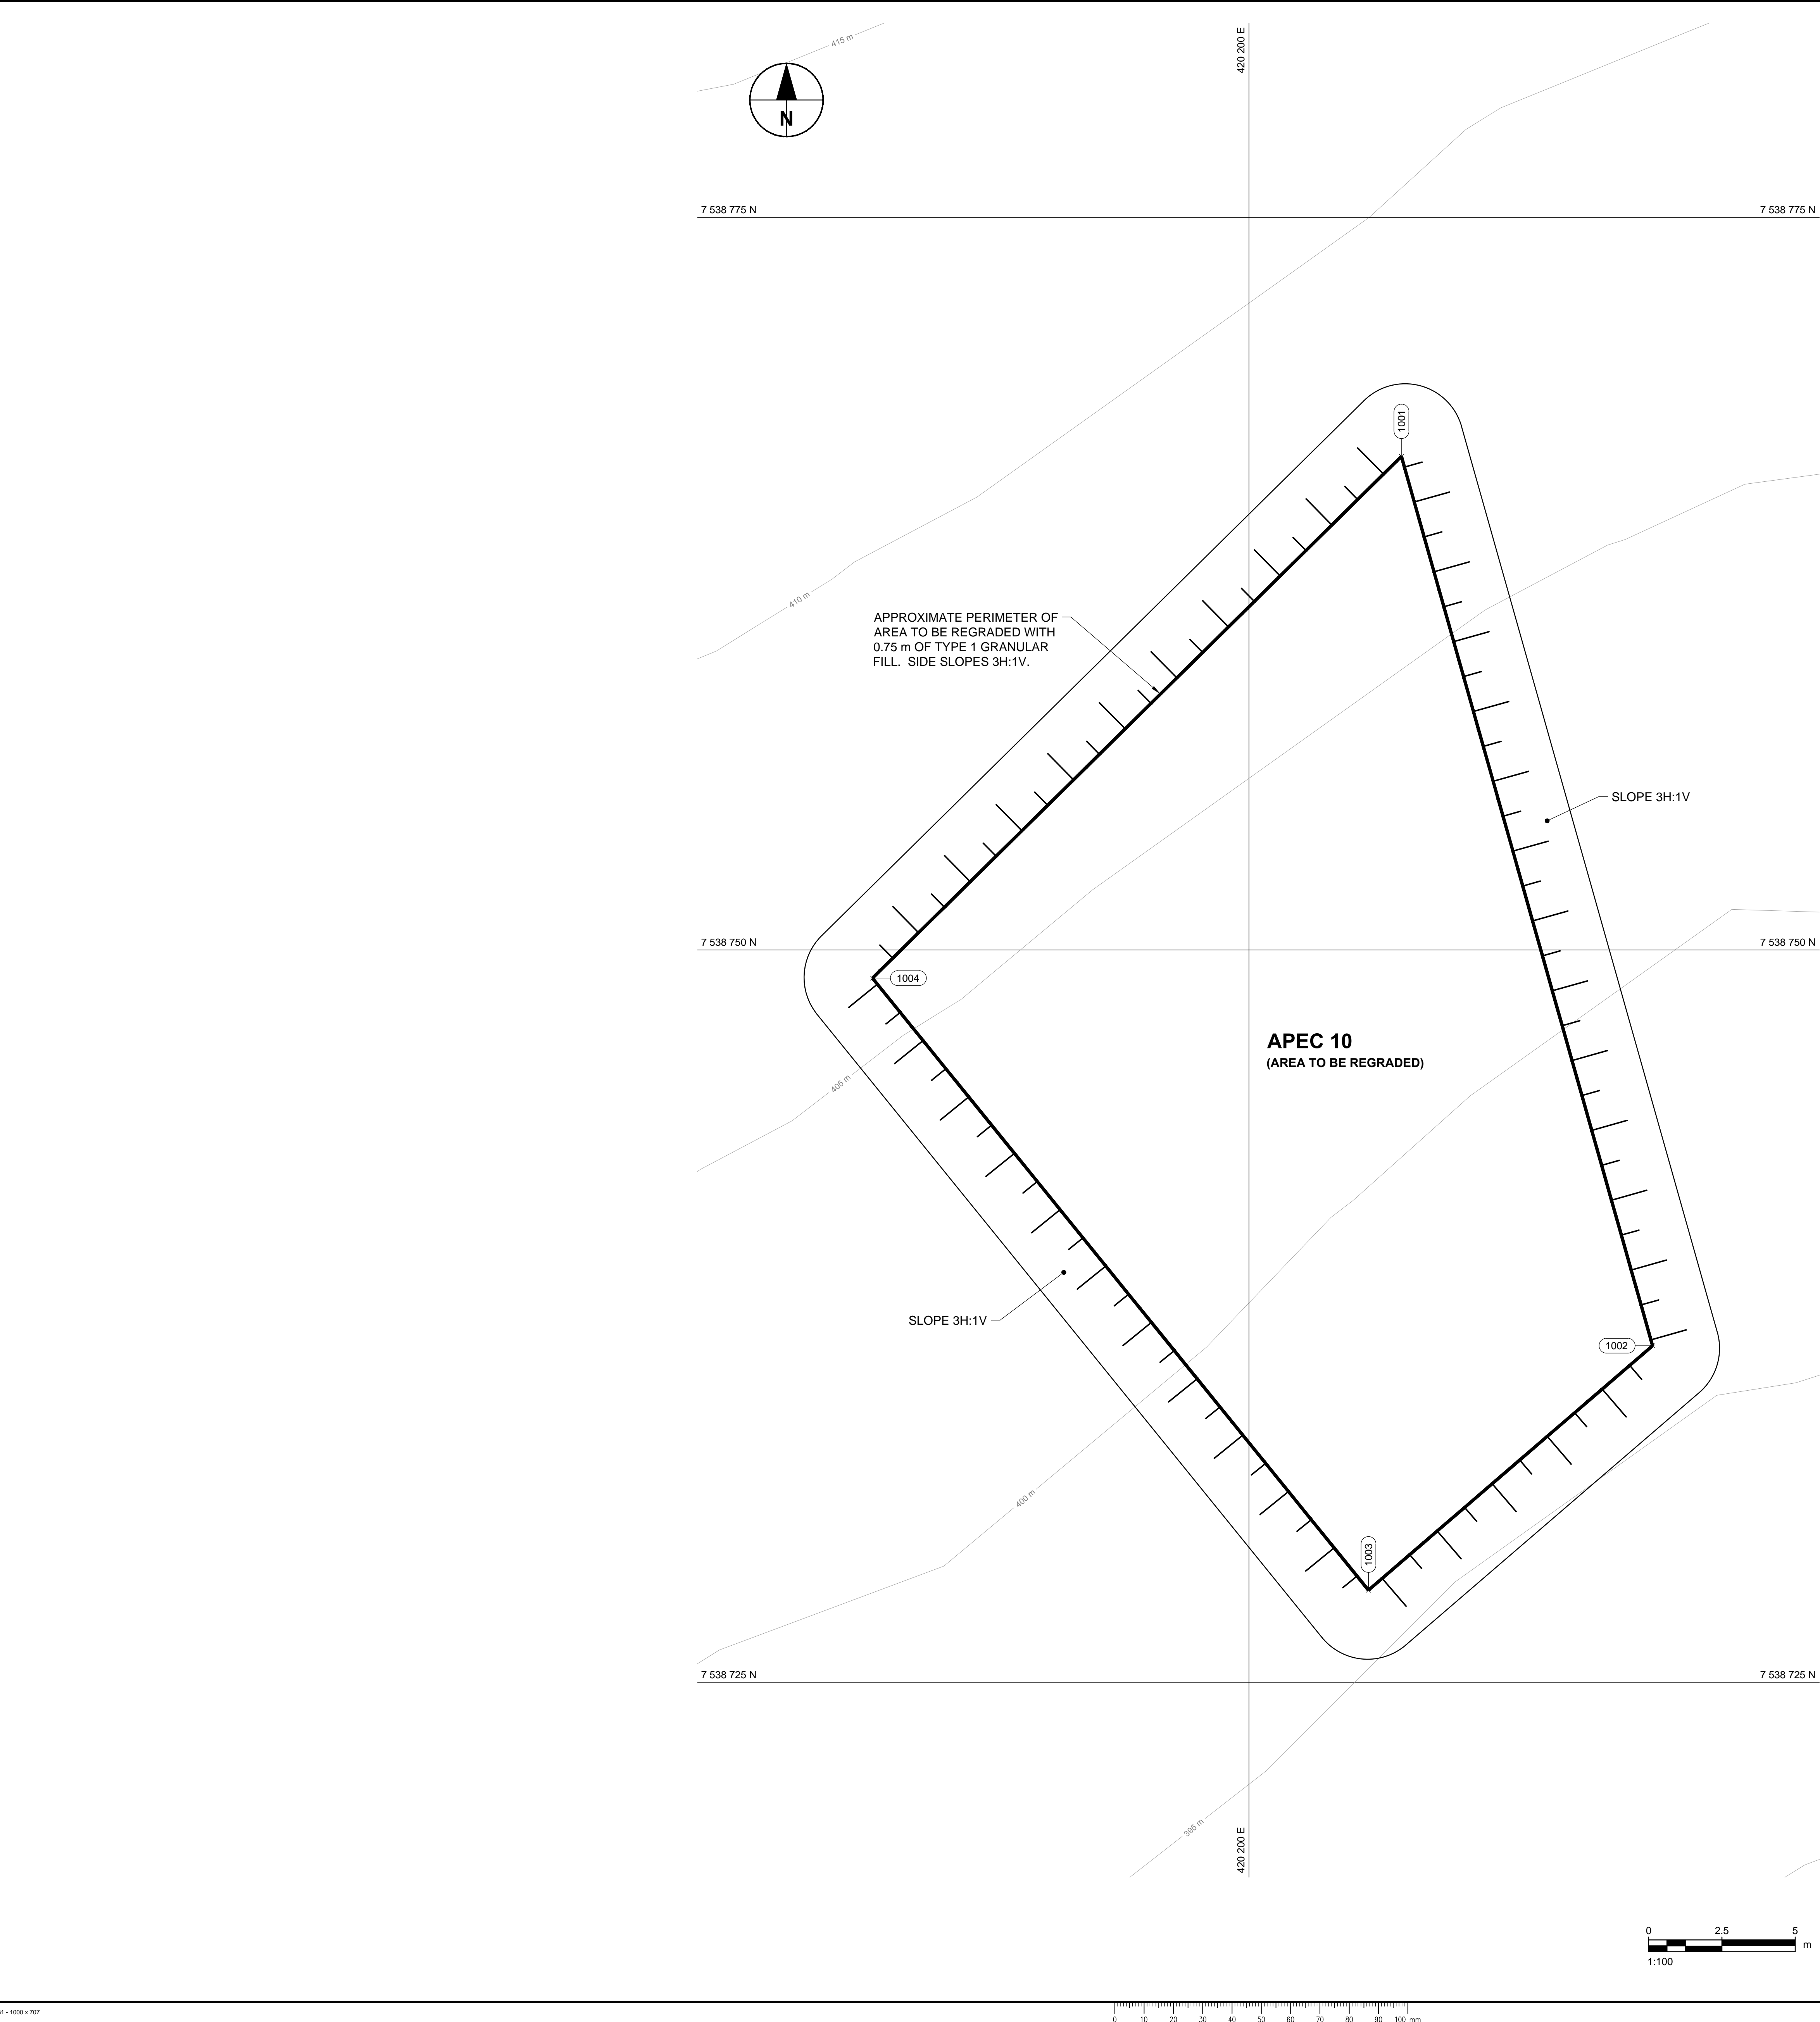

APEC 10 REGRADE		
COORDINATE POINTS		
NO.	NORTHING	EASTING
1001	7538766.9	420205.2
1002	7538736.5	420213.8
1003	7538728.2	420204.1
1004	7538749.0	420187.2



NOTE:
DRAWING DETAILS BASED ON THE ISSUED FOR
TENDER DRAWINGS FOR THE FOX-D REMEDIATION
PROGRAM, DILLON CONSULTING AND KGS GROUP
CONSULTING ENGINEERS, DECEMBER 23, 2014.

This drawing has been prepared for the use of AECOM's client and may not be used, reproduced or relied upon by third parties, except as agreed by AECOM and its client. It is required by law or for use by governmental reviewing agencies. AECOM accepts no responsibility, and denies any liability whatsoever, to any party that modifies this drawing without AECOM's express written consent. Do not scale this document. All measurements must be obtained from stated dimensions.

GENERAL NOTES:

1. ALL DIMENSIONS ARE IN METRES, UNLESS NOTED OTHERWISE. ALL COORDINATES ARE REFERENCED TO NAD83 (CSRS), UTM ZONE 20N. ALL ELEVATIONS ARE IN METRES ABOVE SEA LEVEL (MSL).
2. CONTOURS ARE SUPPLIED FROM NRCAN, DERIVED FROM 1:60,000 STEREO PAIR IMAGERY.
3. ALL SURFACE DEBRIS IS TO BE REMOVED FROM ALL CONTAMINATED SOIL AREAS AND EXISTING BURIED DEBRIS AREAS PRIOR TO EXCAVATION OR FILL PLACEMENT.

LEGEND:

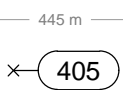- ROAD
- COORDINATE POINT

Professional Seals / Sceaux

DO NOT SCALE DRAWINGS

0	ISSUED FOR CONSTRUCTION	17/02/06
Revision/ Revision	Description/Description	Date/Date

Client/client

PUBLIC WORKS
GOVERNMENT SERVICES
CANADA

Project title/Titre du projet

FOX-D
REMEDICATION PROJECT

Approved by/Approuvé par

R. MERKOSKY

Designed by/Concept par

R. STUDER-HALBACH

Drawn by/Dessiné par

C. EROS

PWSSC Project Manager/Administrateur de Projets TPSGC

J. LEE

PWSSC Architectural and Engineering Resources Manager/
Ressources Architectural et de Directeur d'ingénierie, TPSGC

Client/client

PUBLIC WORKS AND GOVERNMENT SERVICES CANADA

Drawing title/Titre du dessin

APEC 10
REGRAIDING PLAN

Project No./No. du projet


R.083399.001

Sheet/Feuille

C08
OF 13

Revision no./
La Révision no.

0

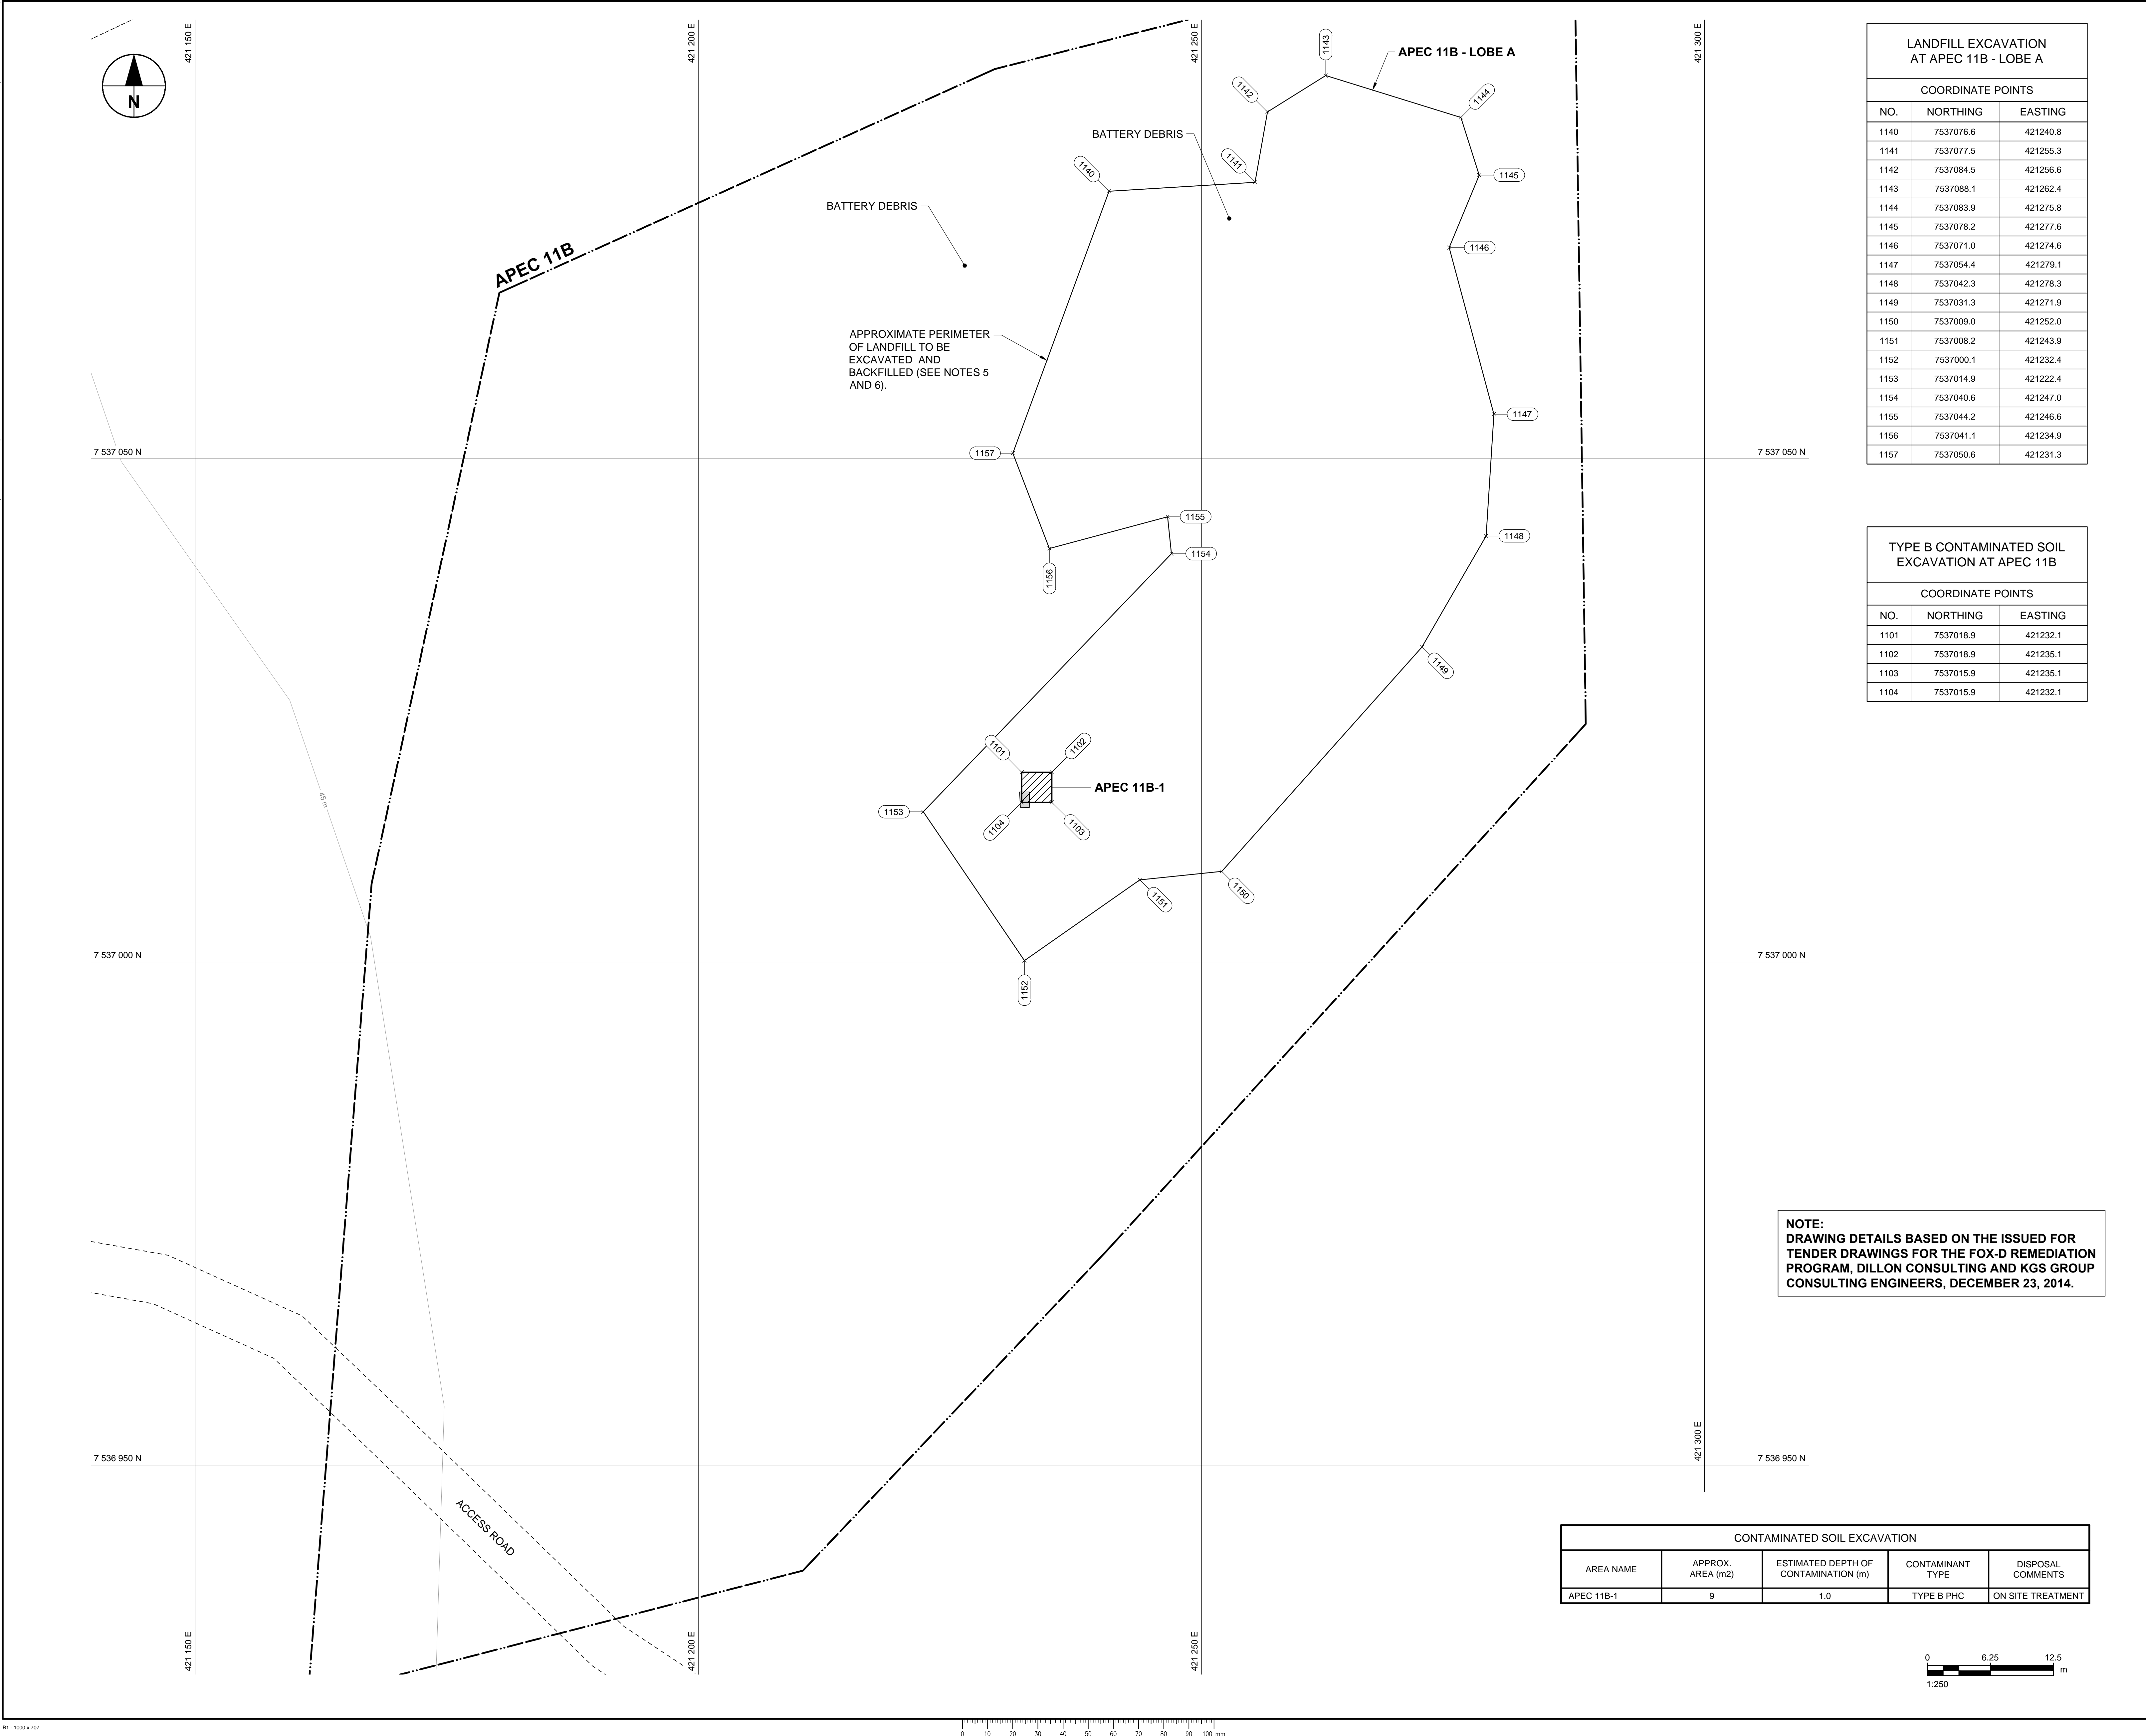


LANDFILL EXCAVATION AT APEC 11B - LOBE A		
COORDINATE POINTS		
NO.	NORTHING	EASTING
1140	7537076.6	421240.8
1141	7537077.5	421255.3
1142	7537084.5	421256.6
1143	7537088.1	421262.4
1144	7537083.9	421275.8
1145	7537078.2	421277.6
1146	7537071.0	421274.6
1147	7537054.4	421279.1
1148	7537042.3	421278.3
1149	7537031.3	421271.9
1150	7537009.0	421252.0
1151	7537008.2	421243.9
1152	7537000.1	421232.4
1153	7537014.9	421222.4
1154	7537040.6	421247.0
1155	7537044.2	421246.6
1156	7537041.1	421234.9
1157	7537050.6	421231.3

TYPE B CONTAMINATED SOIL EXCAVATION AT APEC 11B		
COORDINATE POINTS		
NO.	NORTHING	EASTING
1101	7537018.9	421232.1
1102	7537018.9	421235.1
1103	7537015.9	421235.1
1104	7537015.9	421232.1

NOTE:
DRAWING DETAILS BASED ON THE ISSUED FOR
TENDER DRAWINGS FOR THE FOX-D REMEDIATION
PROGRAM, DILLON CONSULTING AND KGS GROUP
CONSULTING ENGINEERS, DECEMBER 23, 2014.

CONTAMINATED SOIL EXCAVATION				
AREA NAME	APPROX. AREA (m2)	ESTIMATED DEPTH OF CONTAMINATION (m)	CONTAMINANT TYPE	DISPOSAL COMMENTS
APEC 11B-1	9	1.0	TYPE B PHC	ON SITE TREATMENT

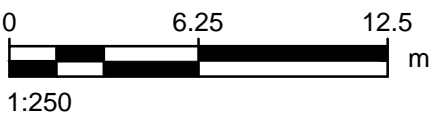

This drawing has been prepared for the use of AECOM's client and may not be used, reproduced or relied upon by third parties, except as agreed by AECOM and its client. AECOM accepts no responsibility, and denies any liability whatsoever, to any party that modifies this drawing without AECOM's express written consent. Do not scale this document. All measurements must be obtained from stated dimensions.

GENERAL NOTES:

- ALL DIMENSIONS ARE IN METRES, UNLESS NOTED OTHERWISE. ALL COORDINATES ARE REFERENCED TO NAD83 (CSRS), UTM ZONE 20N. ALL ELEVATIONS ARE IN METRES ABOVE SEA LEVEL (MSL).
- CONTOURS ARE SUPPLIED FROM NRCAN, DERIVED FROM 1:60,000 STEREO PAIR IMAGERY.
- ALL SURFACE DEBRIS IS TO BE REMOVED FROM ALL CONTAMINATED SOIL AREAS AND EXISTING BURIED DEBRIS AREAS PRIOR TO EXCAVATION OR FILL PLACEMENT.
- REGRADED SIDE SLOPES TO BE 6H:1V UNLESS NOTED OTHERWISE.
- REPLACE CLEAN BURIED DEBRIS EXCAVATION SOILS AS BACKFILL. CAP AREAS WITH 0.3 m OF TYPE 1 GRANULAR FILL OVER THE CLEAN BACKFILL.
- DEPTH OF BURIED DEBRIS EXCAVATION TO EXTEND TO BASE OF DEBRIS LIMIT AND DEPTH OF EXCAVATION TO BE VERIFIED BY EXCAVATION OF TESTPITS.

LEGEND:

- ROAD
- CONTOUR (5 m INTERVAL)
- APEC BOUNDARY
- STAINING
- ESTIMATED EXTENTS OF TYPE A PHC CONTAMINATED SOIL
- ESTIMATED EXTENTS OF TYPE B PHC CONTAMINATED SOIL
- ESTIMATED EXTENTS OF TIER I CONTAMINATED SOIL
- ESTIMATED EXTENTS OF TIER II CONTAMINATED SOIL
- COORDINATE POINT

Professional: Sedis / Scaux

DO NOT SCALE DRAWINGS

0	ISSUED FOR CONSTRUCTION	17/02/06
Revision/ Revision	Description/Description	Date/Date

Client/client

PUBLIC WORKS
GOVERNMENT SERVICES
CANADA

Project title/Titre du projet

FOX-D
REMEDIATION PROJECT

Approved by/Approuvé par

R. MERKOSKY

Designed by/Concepté par

R. STUDER-HALBACH

Drawn by/Dessiné par

C. EROS

PWSSC Project Manager/Administrateur de Projets TPSGC

J. LEE

PWSSC Architectural and Engineering Resources Manager/
Ressources Architectural et de Directeur d'ingénierie, TPSGC

Client/client

PUBLIC WORKS AND GOVERNMENT SERVICES CANADA

Drawing title/Titre du dessin

APEC 11B
SITE PLAN

Project No./No. du projet



R.083399.001

Sheet/Feuille

C09
OF 13

Revision no./
La Révision no.

0

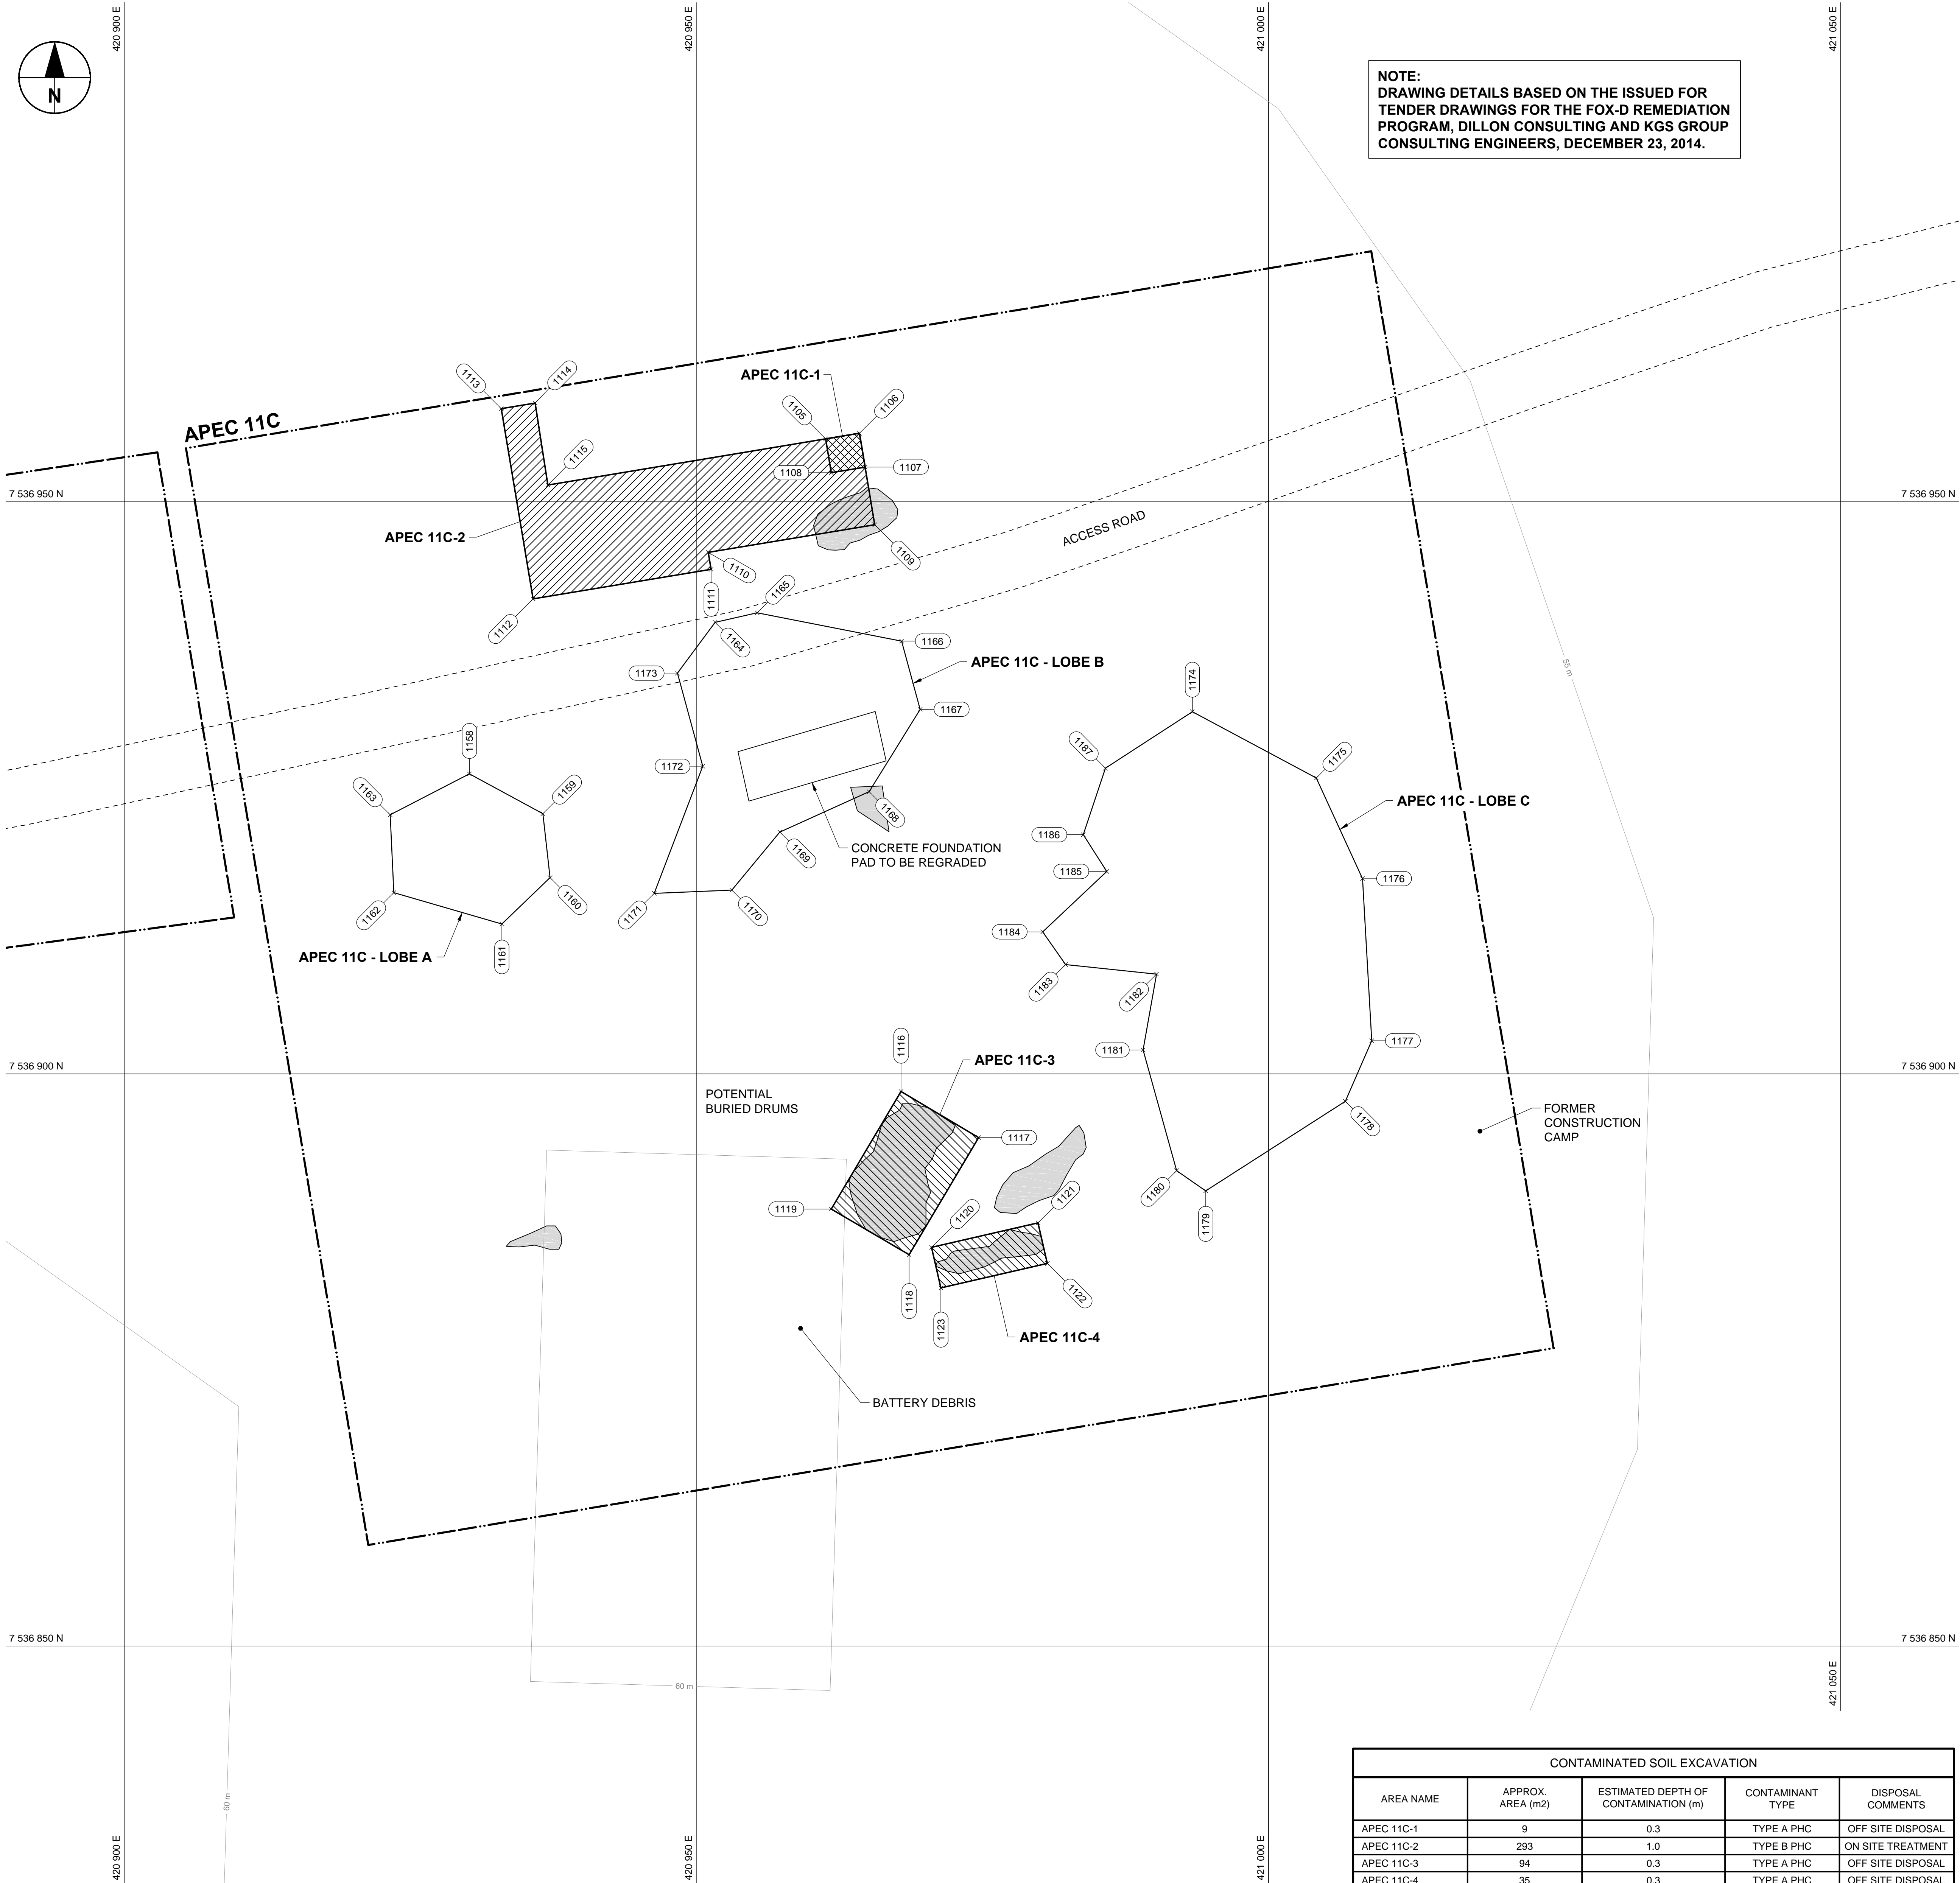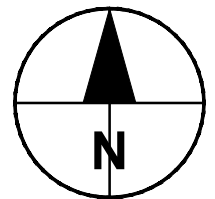

NOTE:
DRAWING DETAILS BASED ON THE ISSUED FOR
TENDER DRAWINGS FOR THE FOX-D REMEDIATION
PROGRAM, DILLON CONSULTING AND KGS GROUP
CONSULTING ENGINEERS, DECEMBER 23, 2014.


TYPE A AND TYPE B CONTAMINATED SOIL EXCAVATION AT APEC 11C		
COORDINATE POINTS		
NO.	NORTHING	EASTING
1105	7536955.5	420961.3
1106	7536956.0	420964.3
1107	7536953.0	420964.7
1108	7536952.5	420961.8
1109	7536948.0	420965.6
1110	7536945.6	420951.0
1111	7536944.1	420951.3
1112	7536941.5	420935.7
1113	7536958.1	420932.9
1114	7536958.6	420935.9
1115	7536951.5	420937.0
1116	7536898.5	420967.9
1117	7536894.4	420974.7
1118	7536884.2	420968.6
1119	7536888.2	420961.8
1120	7536884.8	420970.6
1121	7536887.0	420979.9
1122	7536883.4	420980.7
1123	7536881.3	420971.4

BURIED DEBRIS EXCAVATION AT APEC 11C - LOBE A		
COORDINATE POINTS		
NO.	NORTHING	EASTING
1158	7536926.2	420930.2
1159	7536922.7	420936.6
1160	7536917.2	420937.2
1161	7536913.1	420933.0
1162	7536915.8	420923.6
1163	7536922.6	420923.2

BURIED DEBRIS EXCAVATION AT APEC 11C - LOBE B		
COORDINATE POINTS		
NO.	NORTHING	EASTING
1164	7536939.5	420951.6
1165	7536940.3	420955.3
1166	7536937.8	420967.9
1167	7536931.9	420969.6
1168	7536924.7	420965.1
1169	7536921.1	420957.3
1170	7536916.1	420953.1
1171	7536915.8	420946.3
1172	7536926.9	420950.6
1173	7536935.0	420948.3

BURIED DEBRIS EXCAVATION AT APEC 11C - LOBE C		
COORDINATE POINTS		
NO.	NORTHING	EASTING
1174	7536931.6	420993.3
1175	7536925.9	421004.2
1176	7536917.1	421008.2
1177	7536902.9	421009.0
1178	7536897.6	421006.7
1179	7536889.8	420994.5
1180	7536891.5	420992.0
1181	7536902.1	420989.0
1182	7536908.7	420990.2
1183	7536909.5	420982.3
1184	7536912.4	420980.3
1185	7536917.7	420985.9
1186	7536920.9	420983.8
1187	7536926.7	420985.7

CONTAMINATED SOIL EXCAVATION				
AREA NAME	APPROX. AREA (m2)	ESTIMATED DEPTH OF CONTAMINATION (m)	CONTAMINANT TYPE	DISPOSAL COMMENTS
APEC 11C-1	9	0.3	TYPE A PHC	OFF SITE DISPOSAL
APEC 11C-2	293	1.0	TYPE B PHC	ON SITE TREATMENT
APEC 11C-3	94	0.3	TYPE A PHC	OFF SITE DISPOSAL
APEC 11C-4	35	0.3	TYPE A PHC	OFF SITE DISPOSAL

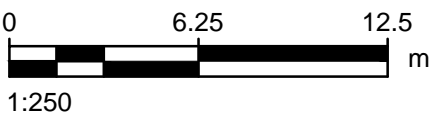

This drawing has been prepared for the use of AECOM's client and may not be used,
reproduced or relied upon by third parties, except as agreed by AECOM and its client.
As required by law or for use by governmental reviewing agencies.
AECOM accepts no responsibility, and denies any liability whatsoever, to any party that modifies
this drawing without AECOM's express written consent.
Do not scale this document. All measurements must be obtained from stated dimensions.

GENERAL NOTES:

1. ALL DIMENSIONS ARE IN METRES, UNLESS NOTED OTHERWISE. ALL COORDINATES ARE REFERENCED TO NAD83 (CSRS), UTM ZONE 20N. ALL ELEVATIONS ARE IN METRES ABOVE SEA LEVEL (MSL).
2. CONTOURS ARE SUPPLIED FROM NRCAN, DERIVED FROM 1:60,000 STEREO PAIR IMAGERY.
3. ALL SURFACE DEBRIS IS TO BE REMOVED FROM ALL CONTAMINATED SOIL AREAS AND EXISTING BURIED DEBRIS AREAS PRIOR TO EXCAVATION OR FILL PLACEMENT.
4. REGRADED SIDE SLOPES TO BE 6H:1V UNLESS NOTED OTHERWISE.
5. REPLACE CLEAN BURIED DEBRIS EXCAVATION SOILS AS BACKFILL. CAP AREAS WITH 0.3 m OF TYPE 1 GRANULAR FILL OVER THE CLEAN BACKFILL.
6. DEPTH OF BURIED DEBRIS EXCAVATION TO EXTEND TO BASE OF DEBRIS. LIMIT AND DEPTH OF EXCAVATION TO BE VERIFIED BY EXCAVATION OF TESTPITS.

LEGEND:

- ROAD
- CONTOUR (5 m INTERVAL)
- APEC BOUNDARY
- STAINING
- ESTIMATED EXTENTS OF TYPE A PHC CONTAMINATED SOIL
- ESTIMATED EXTENTS OF TYPE B PHC CONTAMINATED SOIL
- ESTIMATED EXTENTS OF TIER I CONTAMINATED SOIL
- ESTIMATED EXTENTS OF TIER II CONTAMINATED SOIL
- COORDINATE POINT

Professional Seals / Sceaux

DO NOT SCALE DRAWINGS

0	ISSUED FOR CONSTRUCTION	1702206
Revision/ Revision	Description/Description	Date/Date

Client/client

PUBLIC WORKS
GOVERNMENT SERVICES
CANADA

Project title/Titre du projet

FOX-D
REMEDIATION PROJECT

Approved by/Approuvé par

R. MERKOSKY

Designed by/Conçu par

R. STUDER-HALBACH

Drawn by/Dessiné par

C. EROS

PWSSC Project Manager/Administrateur de Projets TPSSC

J. LEE

PWSSC Architectural and Engineering Resources Manager/
Ressources Architectural et de Directeur d'ingénierie, TPSSC

Client/client

PUBLIC WORKS AND GOVERNMENT SERVICES CANADA

Drawing title/Titre du dessin

APEC 11C
SITE PLAN

Project No./No. du projet

R.083399.001


Sheet/Feuille

C10

OF 13

Revision no./
La Révision no.

0

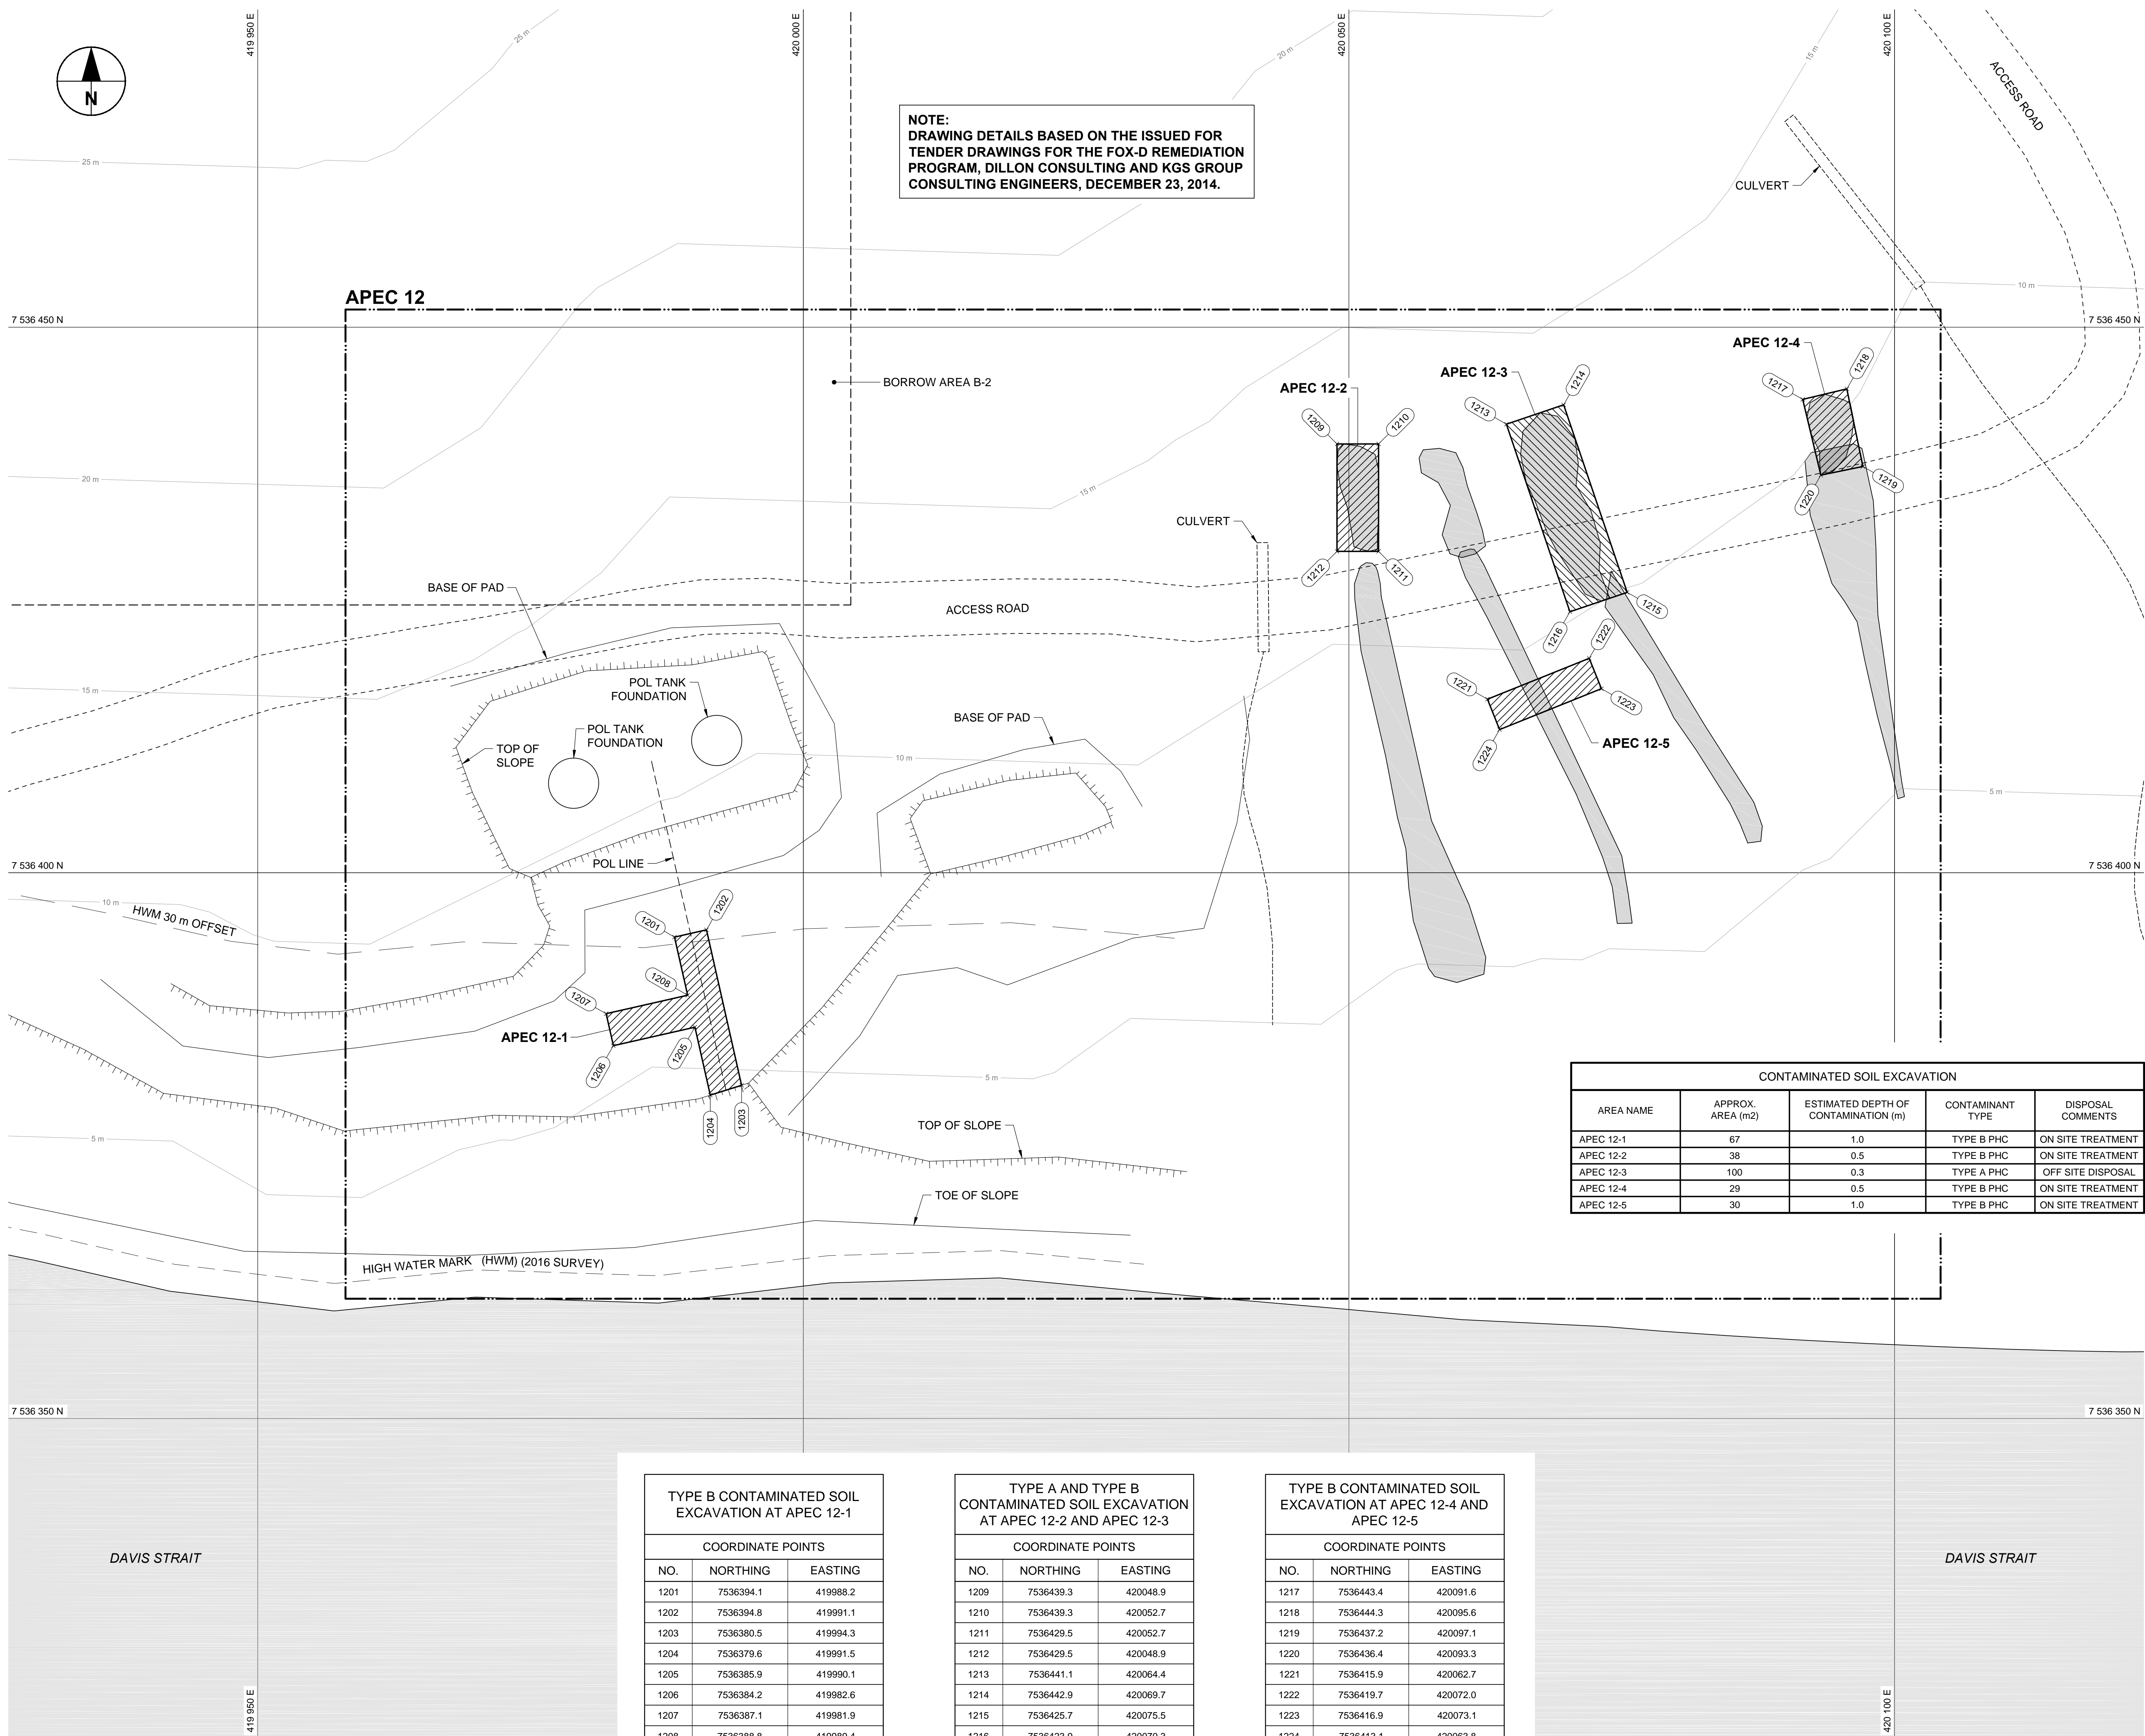

GENERAL NOTES:

- ALL DIMENSIONS ARE IN METRES, UNLESS NOTED OTHERWISE. ALL COORDINATES ARE REFERENCED TO NAD83 (CSRS), UTM ZONE 20N. ALL ELEVATIONS ARE IN METRES ABOVE SEA LEVEL (MSL).
- CONTOURS ARE SUPPLIED FROM NRCAN, DERIVED FROM 1:60,000 STEREO PAIR IMAGERY.
- ALL SURFACE DEBRIS IS TO BE REMOVED FROM ALL CONTAMINATED SOIL AREAS AND EXISTING BURIED DEBRIS AREAS PRIOR TO EXCAVATION OR FILL PLACEMENT.
- REGRADED SIDE SLOPES TO BE 6H:1V UNLESS NOTED OTHERWISE.

LEGEND:

- ROAD
- CONTOUR (5 m INTERVAL)
- APEC BOUNDARY
- STAINING
- ESTIMATED EXTENTS OF TYPE A PHC CONTAMINATED SOIL
- ESTIMATED EXTENTS OF TYPE B PHC CONTAMINATED SOIL
- ESTIMATED EXTENTS OF TIER I CONTAMINATED SOIL
- ESTIMATED EXTENTS OF TIER II CONTAMINATED SOIL
- COORDINATE POINT

Professional Seals / Sceaux

DO NOT SCALE DRAWINGS

0 ISSUED FOR CONSTRUCTION 17/02/06
Revision/ Revision Description Date/Date

Client/client

PUBLIC WORKS
GOVERNMENT SERVICES
CANADA

Project title/Titre du projet

FOX-D
REMEDIATION PROJECTApproved by/Approuvé par
R. MERKOSKYDesigned by/Concepté par
R. STUDER-HALBACHDrawn by/Dessiné par
C. EROS

PWSC Project Manager/Administrateur de Projets TPSCG

J. LEE
PWSC Architectural and Engineering Resources Manager/
Ressources Architectural et de Directeur d'ingénierie, TPSCGClient/client
PUBLIC WORKS AND GOVERNMENT SERVICES CANADA

Drawing title/Titre du dessin

APEC 12
SITE PLAN

Project No./No. du projet



R.083399.001

Sheet/Feuille


C11
OF 13Revision no./
La Revision no.

0


0 6.25 12.5
1:250 m

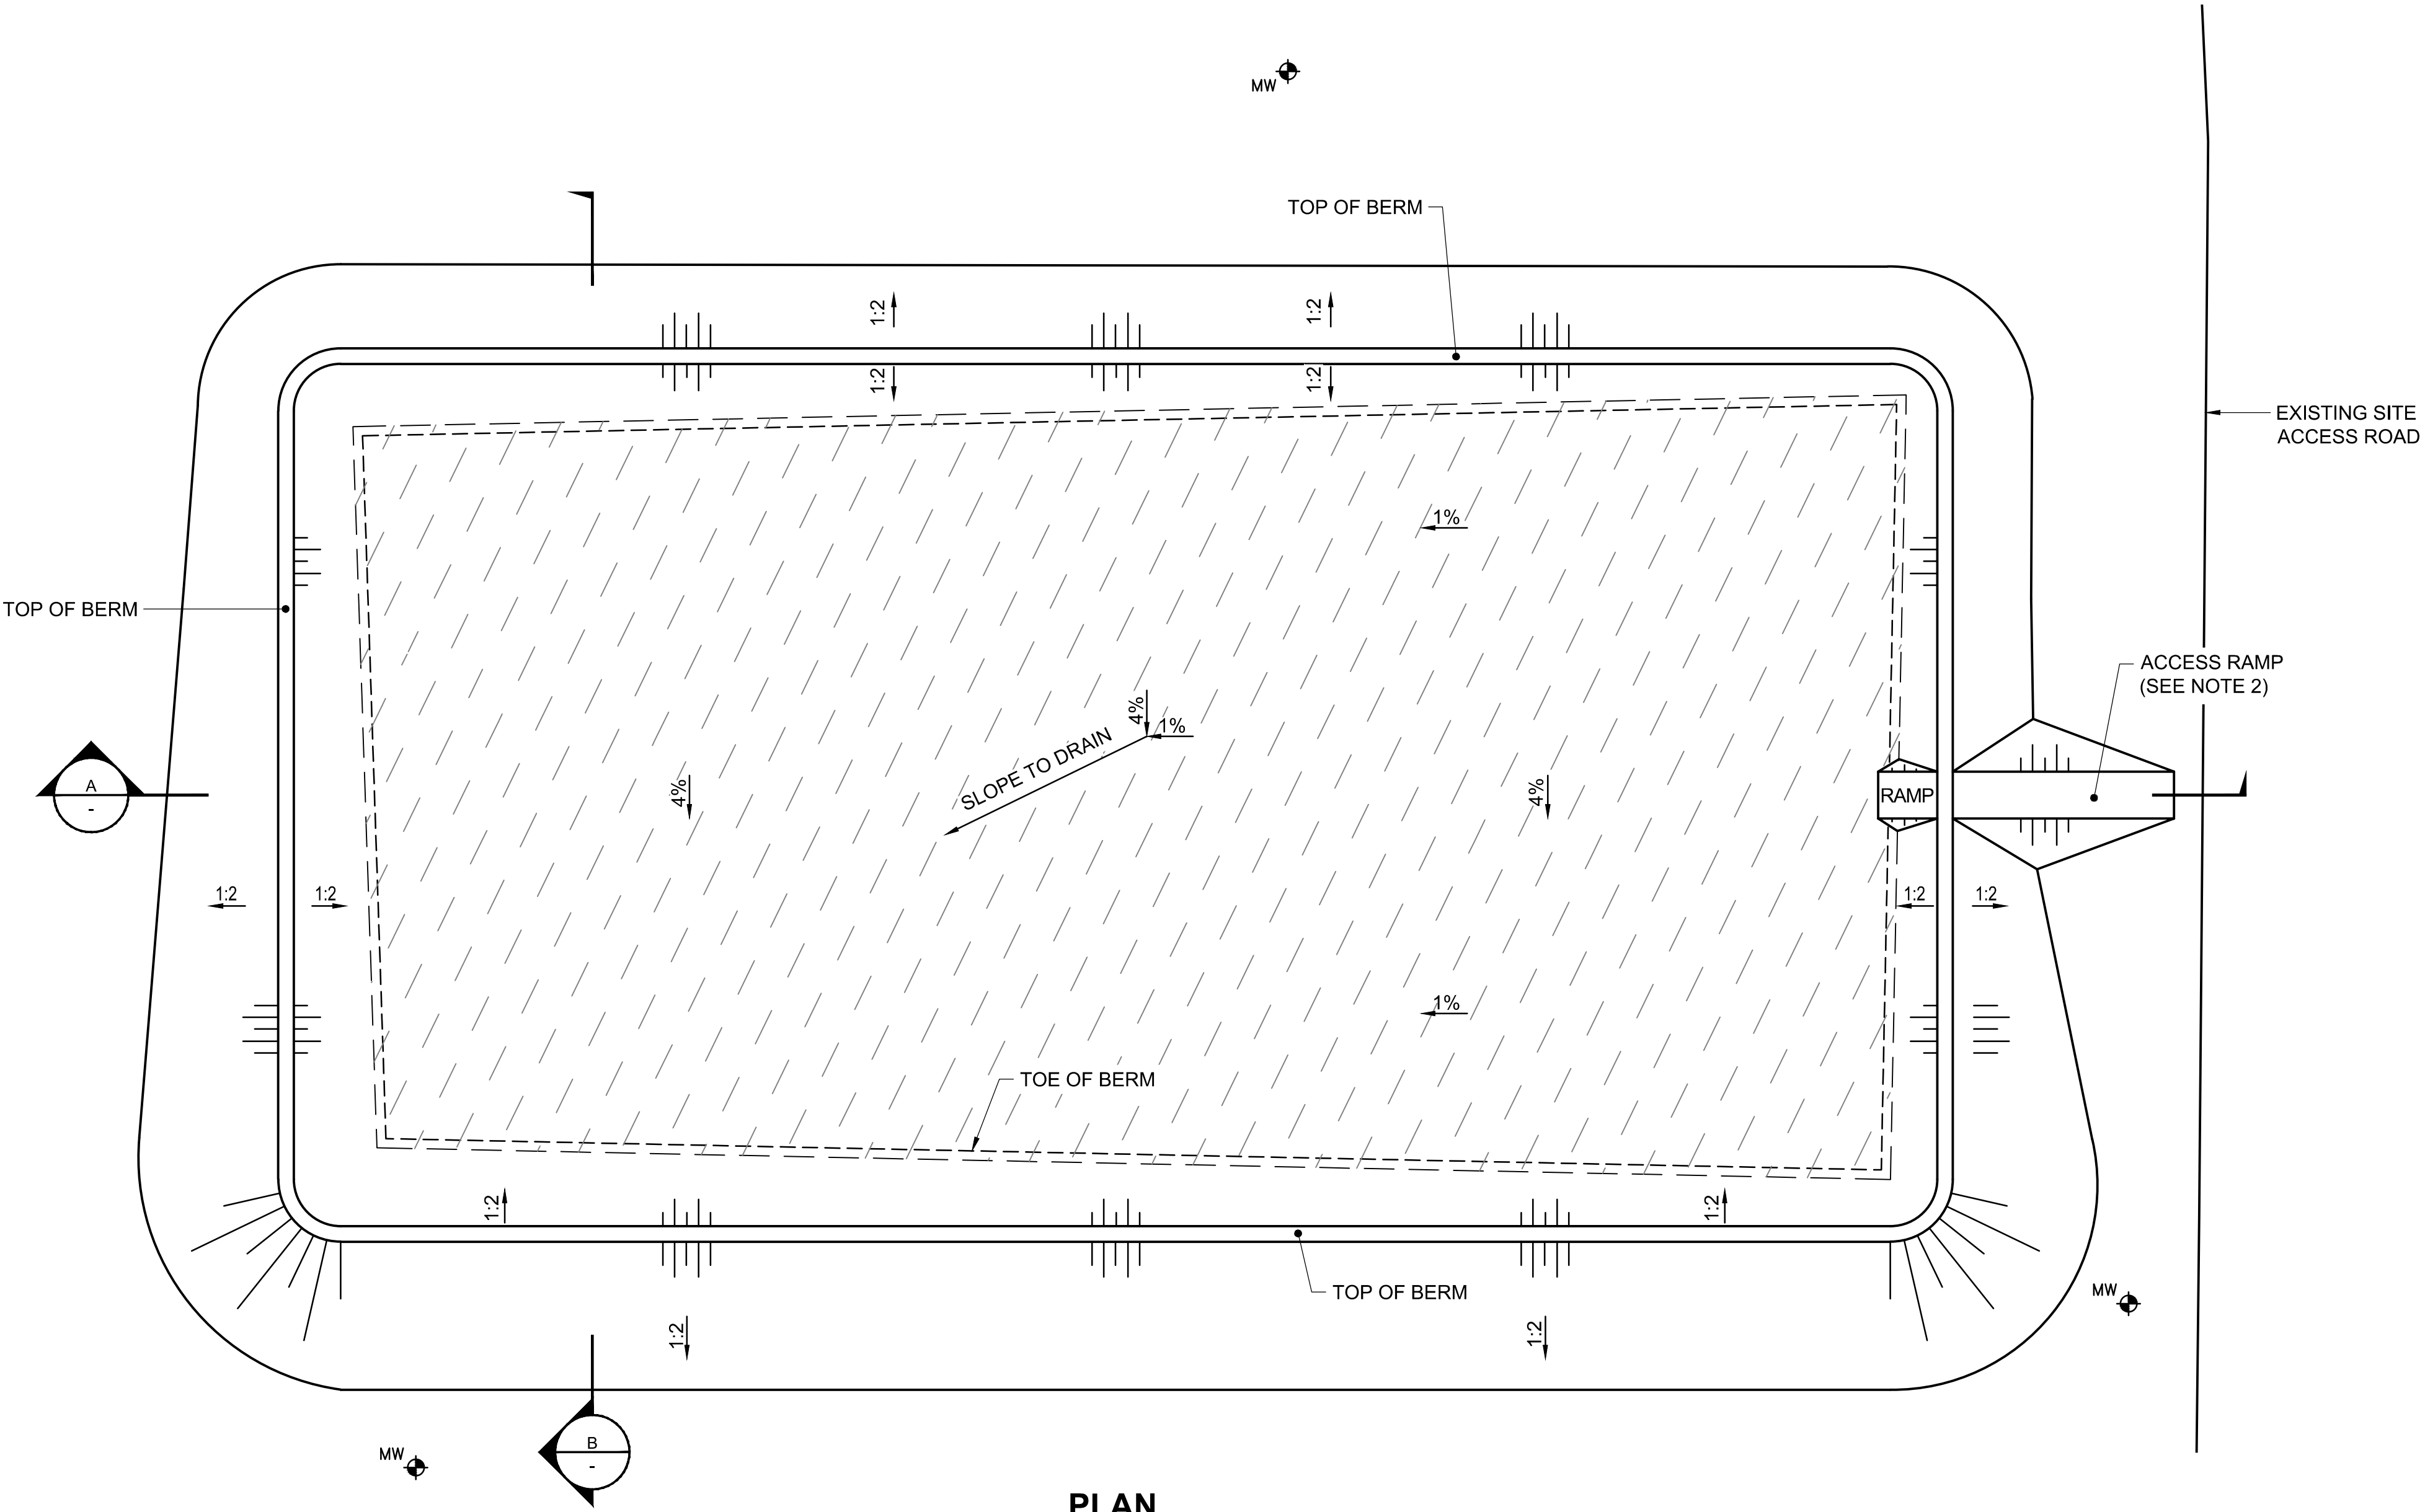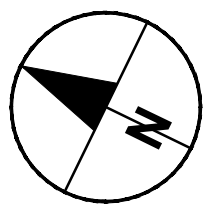


PLAN
Scale 1:300

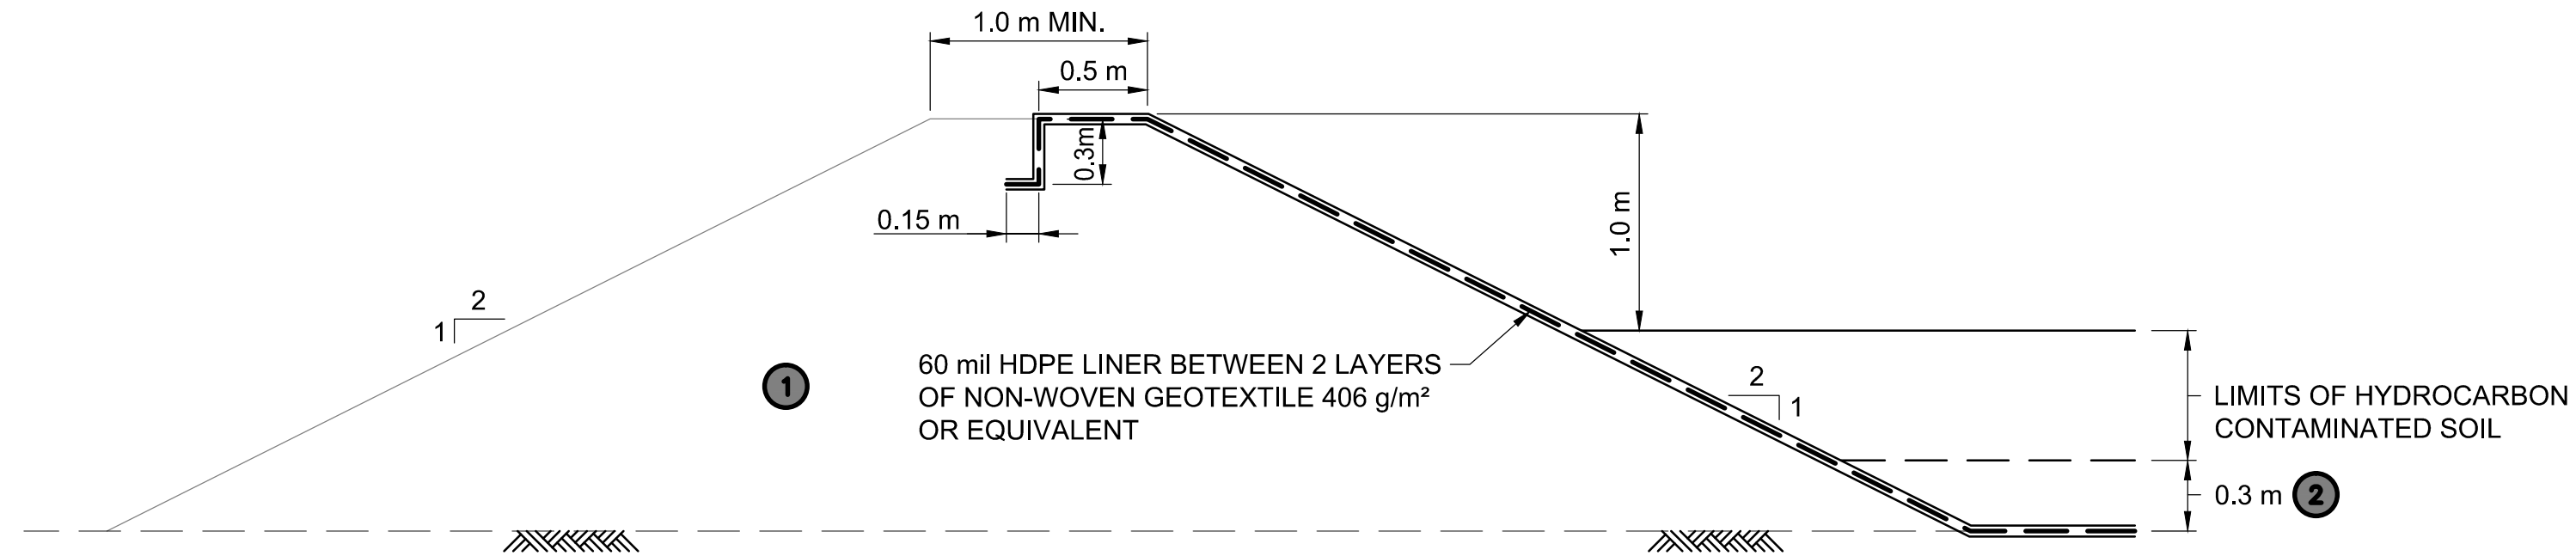


1 | DETAIL
Scale 1:30
DOWN GRADIENT

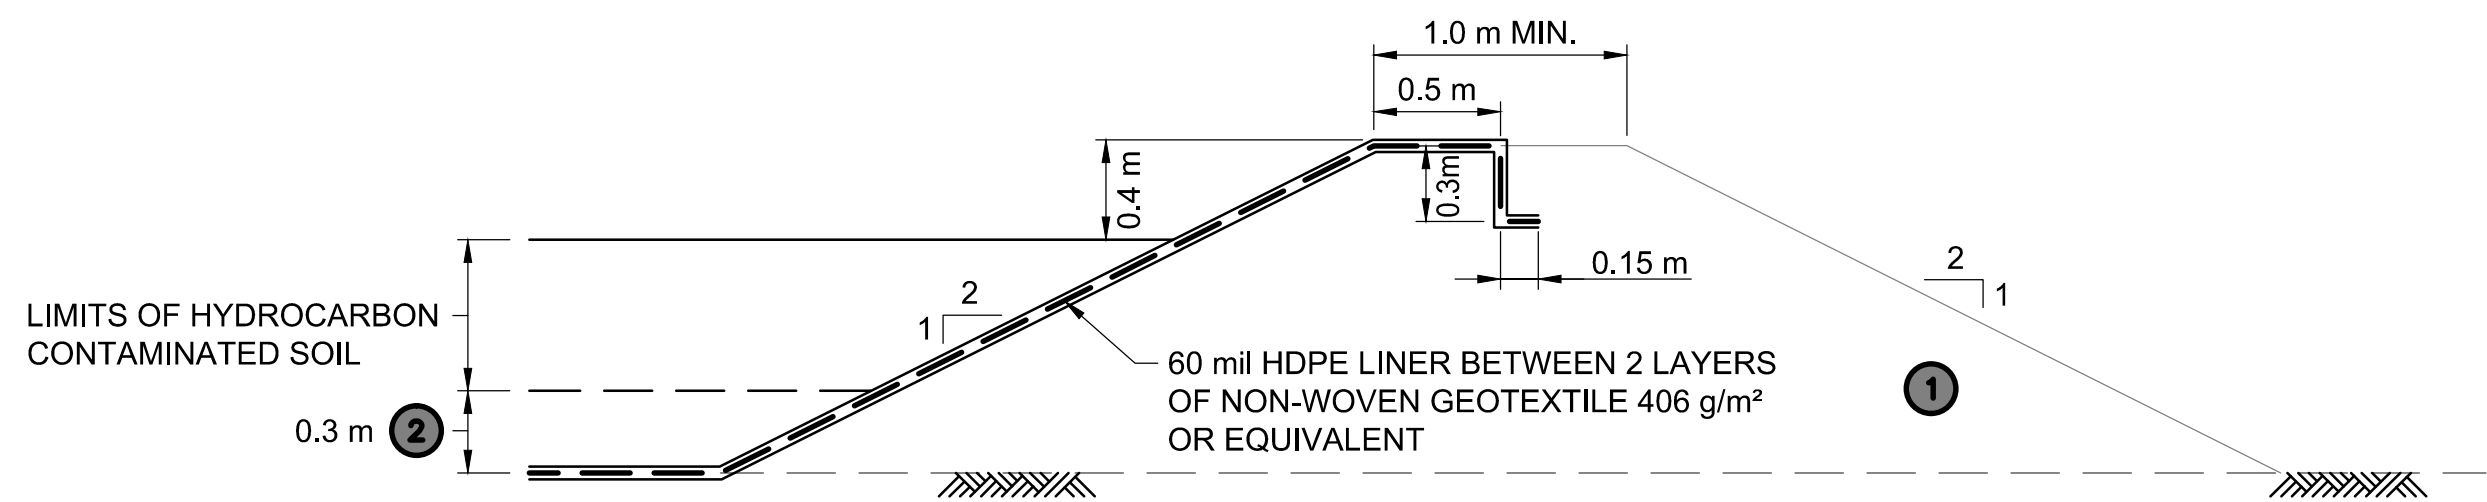

2 | DETAIL
Scale 1:30
UP GRADIENT

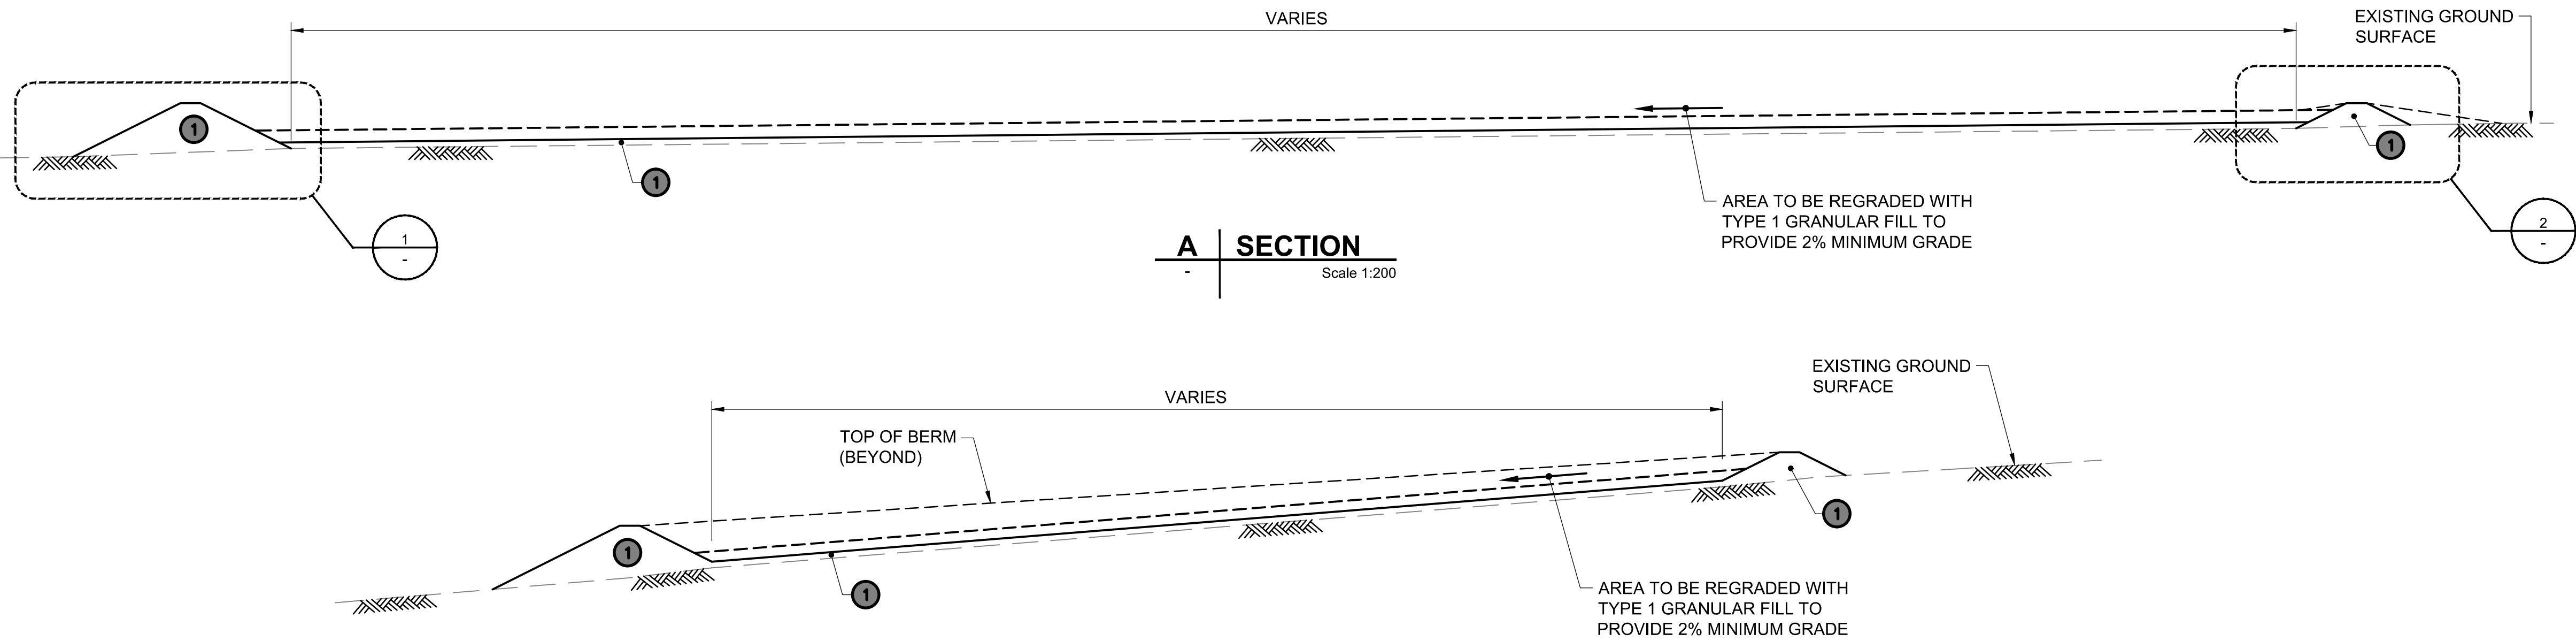

A | SECTION
Scale 1:200

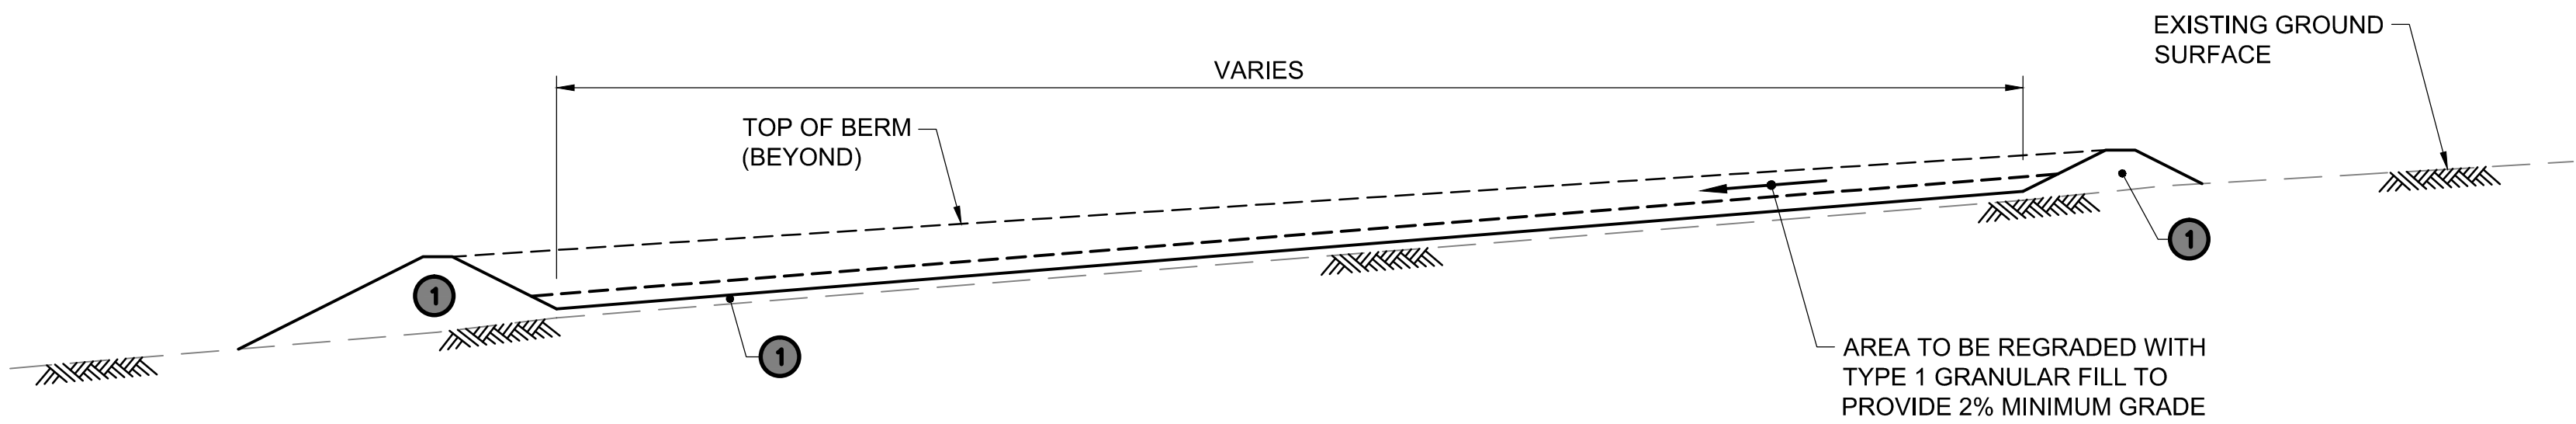

B | SECTION
Scale 1:200

NOTE:
DRAWING DETAILS BASED ON THE ISSUED FOR
TENDER DRAWINGS FOR THE FOX-D REMEDIATION
PROGRAM, DILLON CONSULTING AND KGS GROUP
CONSULTING ENGINEERS, DECEMBER 23, 2014.

This drawing has been prepared for the use of AECOM's client and may not be used, reproduced or relied upon by third parties, except as agreed by AECOM and its client. AECOM accepts no responsibility, and denies any liability whatsoever, to any party that modifies this drawing without AECOM's express written consent. Do not scale this document. All measurements must be obtained from stated dimensions.

GENERAL NOTES:

1. ORIENTATE FACILITY TO ALLOW FOR NATURAL DRAINAGE ON ALL SIDES.
2. LOCATION OF ACCESS RAMP TO BE SELECTED BY CONTRACTOR AND MUST BE UP-GRADIENT OF SUMP. THE CONTRACTOR IS RESPONSIBLE FOR CONSTRUCTING THE RAMP FOR ACCESS INTO AND OUT OF THE FACILITY THAT SATISFIES THE REQUIREMENTS OF THEIR EQUIPMENT.
3. ACTUAL LOCATION OF MONITORING WELL INSTALLATION TO BE FIELD VERIFIED BY DEPARTMENTAL REPRESENTATIVE.
4. COORDINATES ARE BASED ON SURVEY/GRADE GPS SURVEY COMPLETED ON SITE BY KGS GROUP AND ARE HORIZONTALLY ACCURATE TO THE NEAREST 40 mm±, VERTICALLY ACCURATE TO THE NEAREST 60 mm±.

LEGEND:

MW MONITORING WELL (LOCATION APPROXIMATE)
(4 REQUIRED, SEE NOTE 3)

MATERIAL TYPES

- 1 - TYPE 1 GRANULAR FILL
- 2 - TYPE 2 GRANULAR FILL

Professional Seals / Sceaux

DO NOT SCALE DRAWINGS

0	ISSUED FOR CONSTRUCTION	17/02/06
Revision/	Description/Description	Date/Date
Revision		

Client/client

**PUBLIC WORKS
GOVERNMENT SERVICES
CANADA**

Project title/Titre du projet

**FOX-D
REMEDATION PROJECT**

Approved by/Approuvé par
R. MERKOSKY

Designed by/Concept par
R. STUDER-HALBACH

Drawn by/Dessiné par
C. EROS

PWSSC Project Manager/Administrateur de Projets TPSGC
J. LEE

PWSSC Architectural and Engineering Resources Manager/
Ressources Architectural et de Directeur d'ingénierie, TPSGC

Client/client
PUBLIC WORKS AND GOVERNMENT SERVICES CANADA


Drawing title/Titre du dessin

**TYPICAL SOIL TREATMENT FACILITY
PLAN, SECTIONS AND DETAILS**

Project No./No. du projet	Sheet/Feuille	Revision no./ La Révision no.
R.083399.001	C12 OF 13	0

MINIMUM EMBEDMENT CAN BE REDUCED IF ROCK IS ENCOUNTERED. INSTALLATION TO PENETRATE A MINIMUM OF 2 m INTO SOUND BEDROCK.

NOTE:
2 PERMANENT SURVEY CONTROL MONUMENTS TO BE INSTALLED.
SEE NOTE 2.

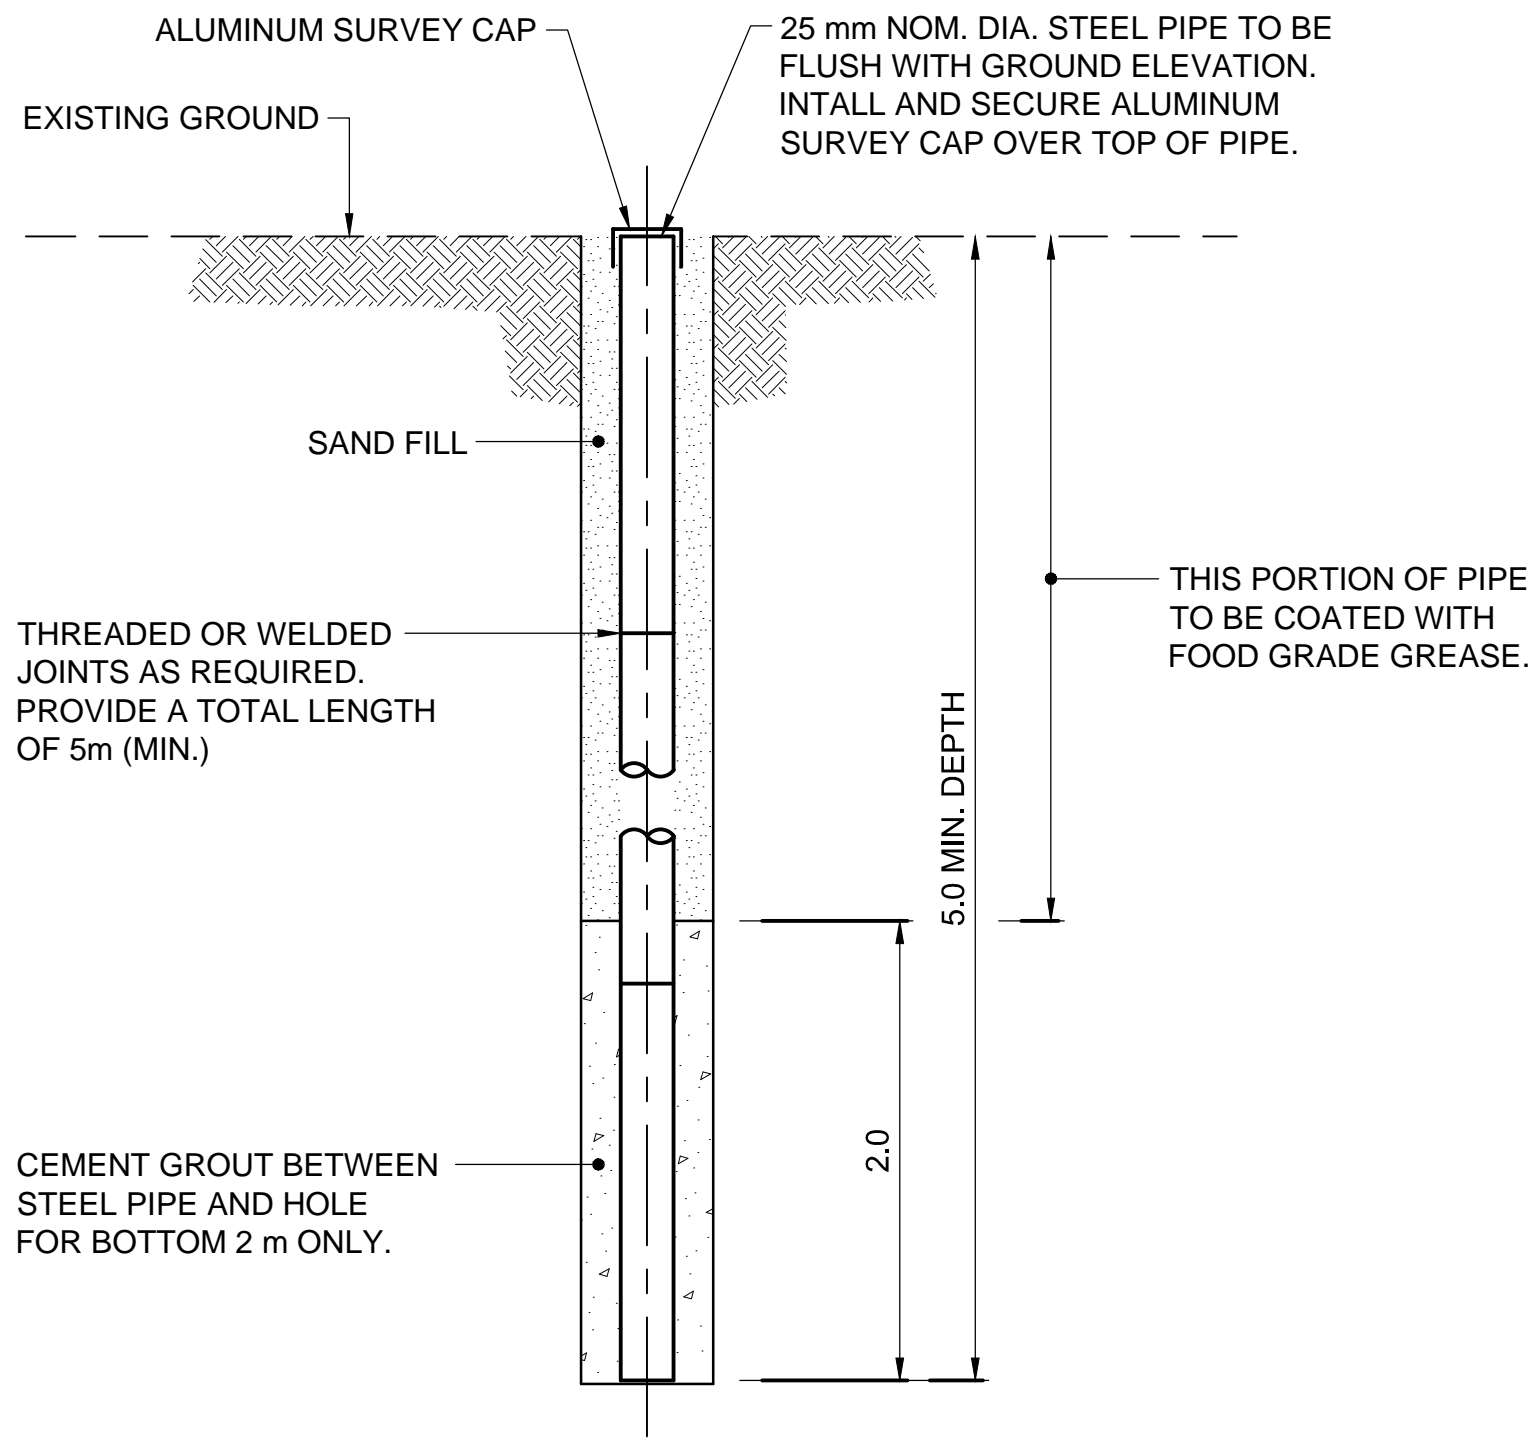


TYPICAL PERMANENT SURVEY CONTROL MONUMENT

Scale: NTS


NOTE:
MINIMUM 2.5 m OF SCREEN AND 0.5 m EMBEDMENT INTO SOUND BEDROCK IF SOUND BEDROCK IS ENCOUNTERED.

NOTE:
4 MONITORING WELLS TO BE INSTALLED.
SEE NOTE 2. 4 MONITORING WELLS TO BE DECOMMISSIONED.

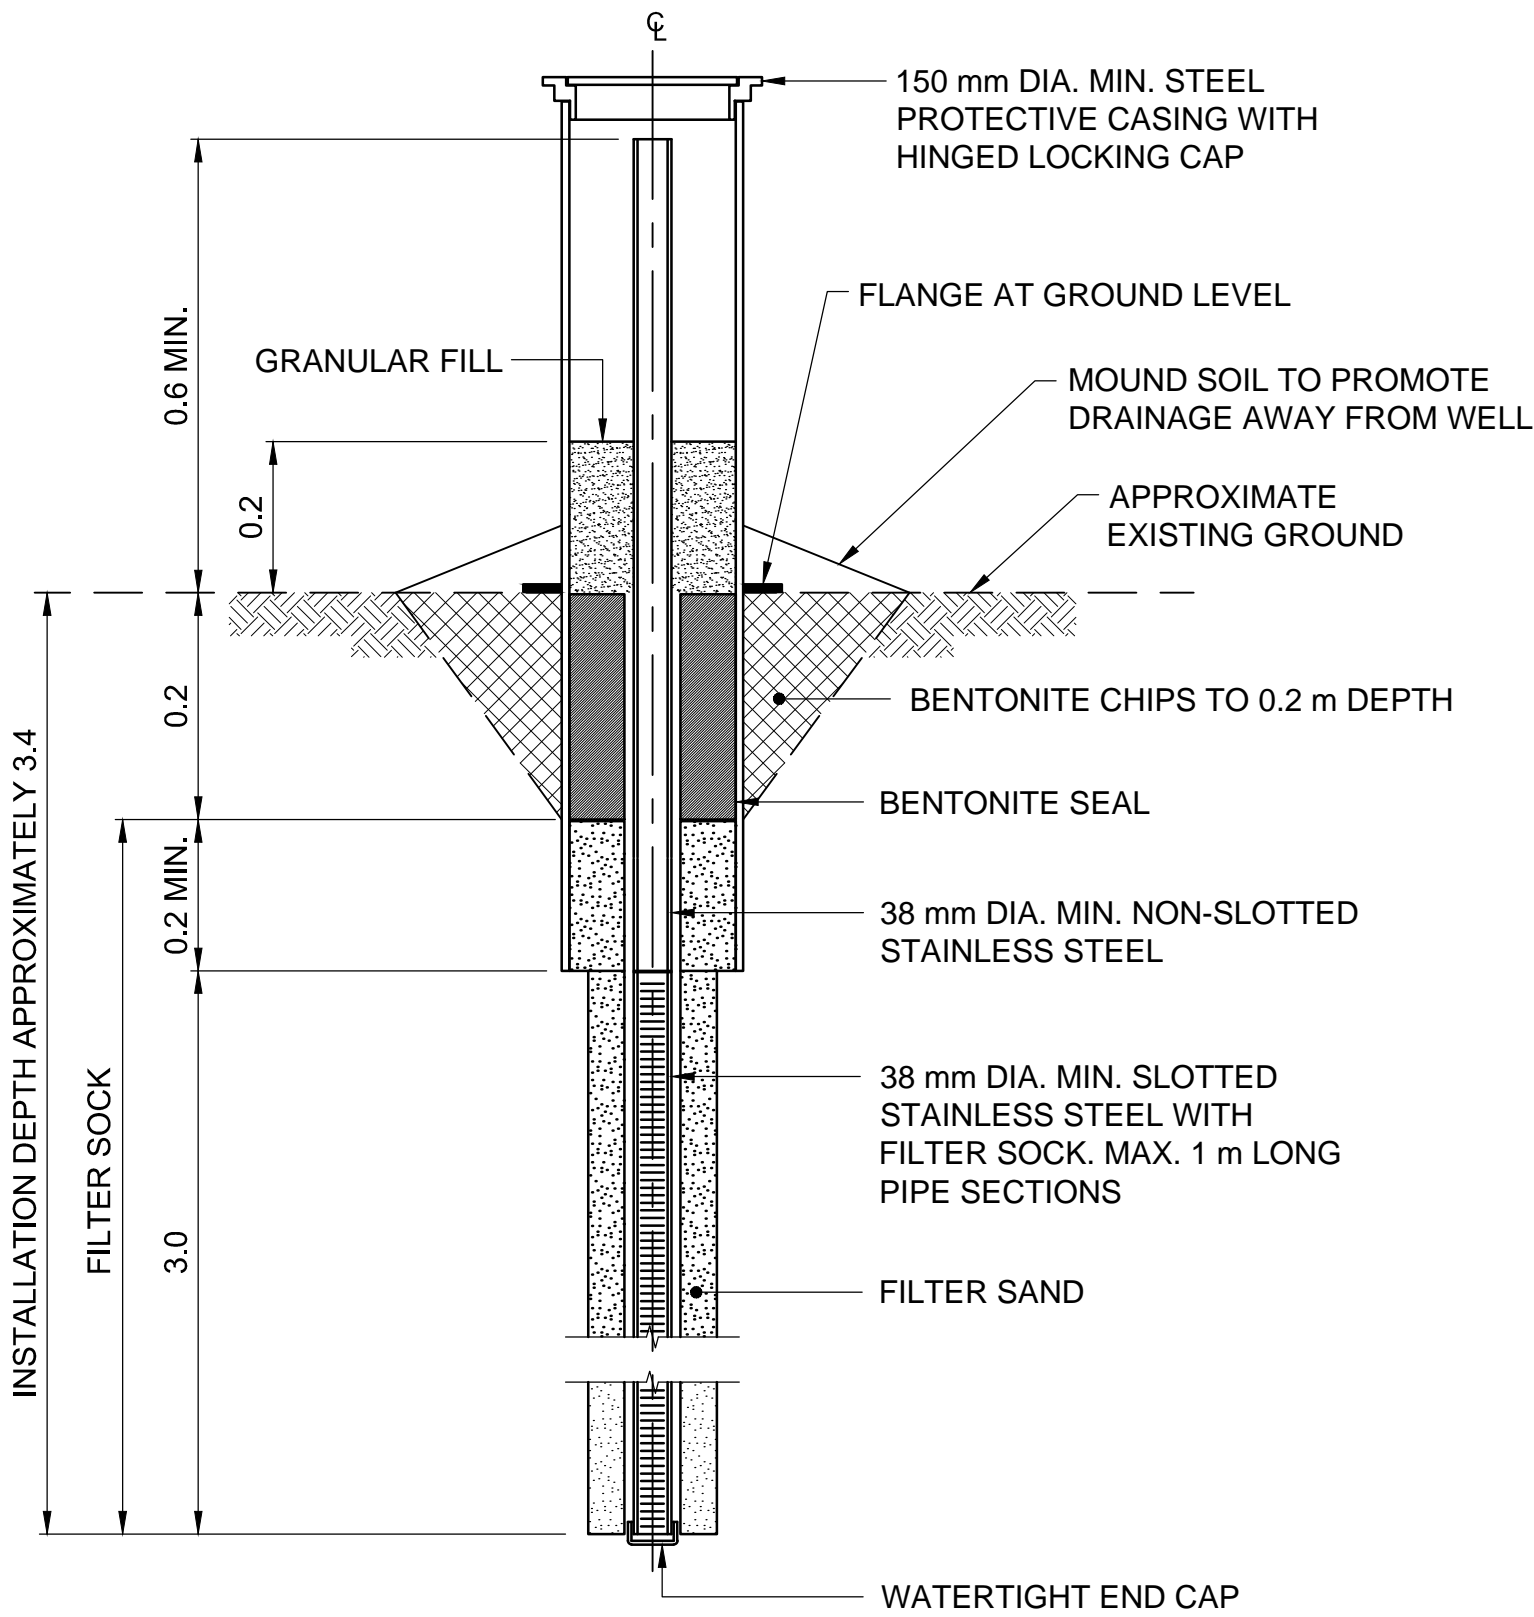

TYPICAL MONITORING WELL / BACKGROUND MONITORING WELL

Scale: NTS

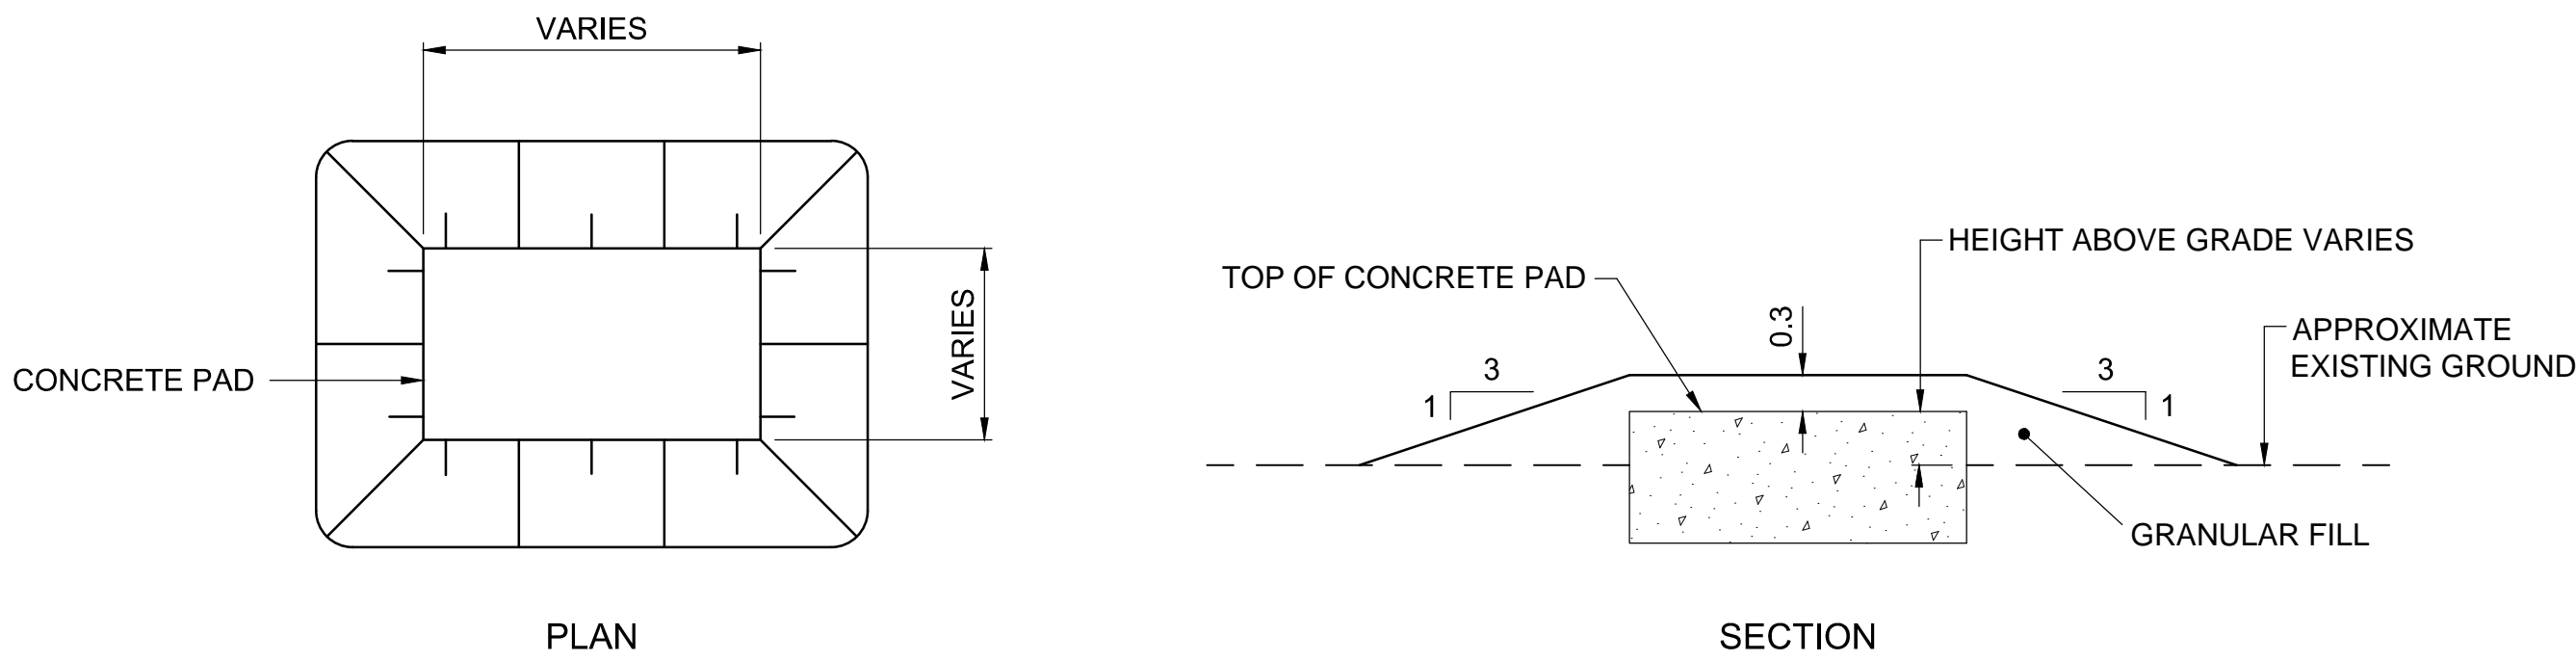

TYPICAL CONCRETE PAD REGRADING DETAIL

Scale: NTS

NOTE:
DRAWING DETAILS BASED ON THE ISSUED FOR TENDER DRAWINGS FOR THE FOX-D REMEDIATION PROGRAM, DILLON CONSULTING AND KGS GROUP CONSULTING ENGINEERS, DECEMBER 23, 2014.

This drawing has been prepared for the use of AECOM's client and may not be used, reproduced or relied upon by third parties, except as agreed by AECOM and its client. AECOM accepts no responsibility, and denies any liability whatsoever, to any party that modifies this drawing without AECOM's express written consent. Do not scale this document. All measurements must be obtained from stated dimensions.

GENERAL NOTES:

1. ALL DIMENSIONS ARE IN METRES, UNLESS NOTED OTHERWISE.
2. APPROXIMATE LOCATIONS FOR INSTRUMENTATION ARE SHOWN ON THE DRAWINGS. ALL LOCATIONS TO BE FIELD CONFIRMED BY DEPARTMENTAL REPRESENTATIVE.

LEGEND:

Professional / Seals / Sceaux

DO NOT SCALE DRAWINGS

0	ISSUED FOR CONSTRUCTION	17/02/06
Revision/	Description/Description	Date/Date
Revision		

Client/client

PUBLIC WORKS
GOVERNMENT SERVICES
CANADA

Project title/Titre du projet

FOX-D
REMEDATION PROJECT

Approved by/Approuvé par

R. MERKOSKY

Designed by/Concept par

R. STUDER-HALBACH

Drawn by/Dessiné par

C. EROS

PWSSC Project Manager/Administrateur de Projets TPSGC

J. LEE

PWSSC Architectural and Engineering Resources Manager
Ressources Architectural et de Directeur d'ingénierie, TPSGC

Client/client

PUBLIC WORKS AND GOVERNMENT SERVICES CANADA

Drawing title/Titre du dessin

MISCELLANEOUS DETAILS

Project No./No. du projet

R.083399.001

Sheet/Feuille

C13
OF 13

Revision no./

0