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February 4, 2010

Nunavut Water Board P.O. Box 119 Gjoa Haven NU X0B 1JO

Attn: Dionne Filiatrault, Executive Director

Dear Dionne,

Status of Doris North Project Designs Referenced in 2AM-DOH0713 ("Type A Water Licence")

During Hope Bay Mining Ltd.'s ("HBML") meetings with you and Ms. Stephanie Autut (NIRB) on January 14th related to HBML plans for Doris North Project (the "Project") infrastructure, you requested further information relating to the current as built status of facilities illustrated in drawings submitted with the 2007 Miramar Type A Water Licence Application.

Please find enclosed a bound package of materials which includes current Project site arrangement drawings, as well as proposed, issued for construction and as-built drawings for each of the site facilities that have been constructed and for which there are specific engineering drawings listed in the Type A Water Licence. HBML has also assembled a table (attached as Appendix A to this letter) which briefly describes as built changes from original designs submitted to the NWB.

Generally, with respect to the current site layout and facilities:

- All existing site facilities are within the area assessed by NIRB and within the boundaries
 of the Commercial Lease issued by the KIA;
- Changes to the width and alignment of the Roberts Bay-Doris North all weather access road proceeded following NIRB's determination of May 22, 2008 that the changes did not significantly alter the Project as reviewed under the NIRB assessment process;
- Modifications to the Fresh Water Intake were completed with prior notification and approval dated May 11, 2009 by the NWB as per Part H of the Type A Water Licence;
- Changes to the camp/mill site, beach laydown area and Quarry #2 were completed with prior notification and approval by the KIA as landowner; and

The updated Doris North Water Management Plan (which will be submitted to the Nunavut Water Board for approval during 2010) will be based on the as built site arrangement.

HBML wishes to take all steps necessary to ensure that all Project construction proceeds appropriately. To that end, HBML recently amended its planning, engineering construction review and approval process to ensure the highest standard of care is followed in the construction of the Project and notification of design revisions.

In addition to the materials referenced above, we will be providing you with materials that outline our current Project plans, which have been revised to take into account the comments that you and Ms. Stephanie Autut provided to us on January 14th. These materials will replace and supersede the Project plan discussed on January 14th.

We have asked Maritz Rykaart, Principal, Geotechnical Engineering of SRK Consulting (Canada) Inc. and Engineer of Record on the Doris North Site Arrangement Drawings to attend our meeting in Calgary of February 5th in order to answer any questions that you may have in respect of the enclosed materials. I look forward to our meeting of February 5th and I am available at your convenience to discuss these matters further with you in advance of our meeting.

Sincerely.

Christopher C. Hanks

Object ally signed by Christopher C. Hanks

DN: cn=Christopher C. Hanks, o=Hope Bay Mining Company,
ou=Environment and Social Responsibility,
email=chris.hanks@newmont.com, c=US Date: 2010.02.04 09:21:58 -08'00'

Chris Hanks Director, Environmental & Social Responsibility Hope Bay Mining Ltd.

cc: Stephanie Autut, Nunavut Impact Review Board

Appendix A: Table Summarizing Doris North Infrastructure Constructed to Date

Note the enclosed package of engineering drawings provides copies of proposed, issued for construction and as built drawings for each of the facilities listed below.

Facilities constructed to date	Comments
All weather access road Note: Only Roberts Bay- Doris North section of all weather access road has been constructed to date.	 Description of Revisions: Road widened from 6m to 8m to meet safety requirements with respect to width of surface haulage roads under the <i>Mine Health and Safety Regulations</i>, NWT Reg. 125-095. Pumphouse section of Roberts Bay-Doris North Road re-aligned to better align water intake line and road. Notification of Revisions: On May 22, 2008, NIRB approved changes without further screening (cc to NWB). As built drawing showing final design submitted to NWB and placed on public registry (see SNC-Lavalin Area 0000, Dwg. 0003, Rev. 1 – General Site Plan Plan View). Note: HBML has not been able to confirm that the NWB was provided with updated for construction drawings, in accordance with Part D, Subsection 14 of the Type A Water Licence.
Beach Laydown Area	 Description of Revisions: Widening of the Roberts Bay lay-down area (see Roberts Bay Area General Arrangement Drawing No. 2, Rev. IV and as-built drawings for Beach Laydown Area). Notification of Revisions: Verbal notification to KIA and KIA approval. The widening of the Beach Laydown Area is a minor change to the Beach Laydown Area as illustrated in the drawings referenced in the definition included at Schedule A of the Type A Water Licence.
Fresh Water Intake	 Description of Revisions: Installation of 2 inch intake line to separate potable water intake from fire water intake. Notification of Revisions: On May 11, 2009 NWB approved changes as a "Modification" under the Type A Water Licence.

Fuel Storage and	Description of Revisions:
Containment Facility	Revision to fuel storage tank location at Roberts Bay laydown area to ensure tank located on bedrock.
Note: only one fuel tank has been constructed to date	Notification of Revisions: As built drawings submitted to NWB and placed on public registry - see: SNC-Lavalin Area 1320, Dwg. 0003, Rev. 6 – Roberts Bay Tank Farm Final Grading Plan SNC-Lavalin Area 1320, Dwg. 0004, Rev. 4 – Roberts Bay Diesel Fuel Tank Final Grading Section SNC-Lavalin Area 1320, Dwg. 0005, Rev. 5 – Roberts Bay Diesel Fuel Tank Final Grading Sections and Details) HBML plans to submit Construction Summary Report as per Part D, s.26 of 2AM-DOH0713 in respect of the Fuel Storage and Containment Facility on or before April 1, 2010, Preparation of this Report is currently underway.
Quarries As-Built for Quarry #3 has not been produced, as development of	Description of Revisions:
Quarry #3 has not yet commenced	 Dwg. 0005, Rev. 1 – Doris Camp General Arrangement Plan. As built limits of Quarry #4 as it stands today is shown on SNC-Lavalin Area 1000, Dwg. 0005, Rev. 1 – Doris Camp General Arrangement Plan.
	Notification of Revisions: • In June 2008 and following an HBML evaluation of the blasting pattern for Quarry #2, KIA approved new crusher site adjacent to the access road to Quarry #2 at the intersection with the road between Roberts Bay and the new Doris Camp.
Camp	Description of Revisions:
	registry - see: SNC-Lavalin Area 1320, Dwg. 0015, Rev. 3 – Doris Camp Final Grading SNC-Lavalin Area 1000, Dwg. 0004, Rev. 2 – Doris Camp Site Services Plan SNC-Lavalin Area 1000, Dwg. 0005, Rev. 2 – Doris Camp Site Services Section and Details SNC-Lavalin Area 1320, Dwg. 0014, Rev. 3 – Doris Camp Site Services Section and Details
Airstrip	Description of Revisions: No substantial changes.

Jetty	Description of Revisions:
	No substantial changes.

Proposed / IFC / As-built Drawings, Doris North Project, Nunavut, Canada





PROJECT NO: 1CH008.027 FEBRUARY 2010

Doris North Project: Proposed/IFC/As Built Drawings

Site Arrangement

- 1. Doris North Site Arrangement Drawings (prepared on February 1, 2010 by SRK Engineering)
 - a. Drawing 1: Belt Wide General Arrangement
 - b. Drawing 2: Roberts Bay Area General Arrangement
 - c. Drawing 3: Doris Airstrip Area General Arrangement
 - d. Drawing 4: Doris North Area General Arrangement

Facilities Described in 2AM-DOH0713 and Constructed to Date

- 2. All Weather Access Road (note to date HBML has only constructed portion from Roberts Bay to Doris North camp site)
 - a. Relevant Drawings Submitted with Original Water License Application:
 - Drawings S15 thru S26, Engineering Drawings for Surface Infrastructure Components and Tailings Containment Area, Supporting Document S4 to the Revised Water License Application Support Document, April 2007
 - Typical plan and cross section of the caribou crossings are presented in Drawing S-10, Engineering Drawings for Surface Infrastructure Components and Tailings Containment Area, Supporting Document S4 to the Revised Water License Application Support Document, April 2007
 - iii. Typical culvert installation details are shown on Drawing S-11, Engineering Drawings for Surface Infrastructure Components and Tailings Containment Area, Supporting Document S4 to the Revised Water License Application Support Document, April 2007
 - iv. Road turnout installation details are shown on Drawing S-11, Engineering Drawings for Surface Infrastructure Components and Tailings Containment Area, Supporting Document S4 to the Revised Water License Application Support Document, April 2007
 - b. Issued for Construction Drawings
 - i. SRK Dwg. S-03, Rev. D Airstrip and Apron Plan, Typical Sections and Details
 - SRK Dwg. S-10, Rev. C Caribou Crossing Typical Plan and Sections
 - iii. SRK Dwg. S-11, Rev. C Culvert and Road Turnout Typical Plan, Sections and Details
 - iv. SRK Dwg. S-15, Rev. C North Primary Road Plan and Profile (Station 00+00 11+79) and Typical Section
 - v. SRK Dwg. S-16, Rev. D South Primary Road and Plan Profile (Station 0+000 2+000)
 - vi. SRK Dwg. S-17, Rev. D South Primary Road Plan and Profile (Station 2+000 3+337)
 - vii. SRK Dwg. S-18, Rev. C Secondary Road Plan and Profile (Station 0+000 0+851)
 - viii. SRK Dwg. S-21, Rev. E South Primary, Secondary, Float Plane and Explosives Access Secondary Stake Out Points

- ix. SRK Dwg. S-24, Rev. C Float Plane Dock and Portal Access Road Plan and Profile
- x. SRK Dwg. S-27, Rev. B South Primary Road and Turnout Typical Section and Detail
- xi. SRK Dwg. S-28, Rev. A New Thermistor Installation for Pads/Roads
- xii. SNC-Lavalin Area 0000, Dwg. 0008, Rev. PB Rock Drain Details
- c. As-Built Drawings for Constructed Facilities
 - SNC-Lavalin Area 0000, Dwg. 0003, Rev. 1 General Site Plan Plan View
 - SNC-Lavalin Area 0000, Dwg. 0005, Rev. 1 Doris Camp General Arrangement Plan
 - SNC-Lavalin Area 1550, Dwg. 0002, Rev. 1 Roberts Bay Airstrip and Apron Plan and Section

3. Beach Laydown Area

- a. Relevant Drawings Submitted with Original Water License Application
 - SRK Dwg. S-01, Rev B Beach Laydown Area and Fuel Transfer Station Plan
 - ii. SRK Dwg. S-02, Rev B Beach Laydown Area and Fuel Transfer Station Section and Details
- b. Issued for Construction Drawings
 - SRK Dwg. S-01, Rev. C Beach Laydown Area and Fuel Transfer Station Plan
 - ii. SRK Dwg. G-02b, Rev. B Roberts Bay temporary Fuel Tank Farm Layout.
 - SRK Dwg. J-04, Rev. B Jetty Laydown Area and Emergency Shelter Pad Plan
- c. As-Built Drawings for Constructed Facilities
 - SNC-Lavalin Area 0000, Dwg. 0005, Rev. 1 Roberts Bay Laydown Area 2008 General Arrangement Plan
 - SNC-Lavalin Area 0000, Dwg. 0012, Rev. 1 Roberts Bay Jetty General Arrangement Plan
 - iii. SNC-Lavalin Area 1320, Dwg. 0001, Rev. 2 Roberts Bay Tank Farm General Arrangement

4. Fresh Water Intake

- a. Drawings Submitted with Original Water License Application:
 - SRK Dwg. T-11, Rev. B. Tailings Slurry, Reclaim, fresh-Water Make-up and Decant Pipelines Layout
 - ii. SRK Dwg. T-12, Rev. B Typical Pipeline Details. See Detail #7
- b. Issued for Construction Drawings
 - SNC-Lavalin Area 1330, Dwg. 0002, Rev. 0 Doris Lake Intake Pump House General Arrangement Plan & Profile
 - ii. SNC-Lavalin Area 1330, Dwg. 0003, Rev. 0 Fresh Water Supply Pipeline (Permanent) Plan. Profile & Section
- c. As-Built Drawings for Constructed Facilities
 - i. SNC-Lavalin Area 0000, Dwg. 0003, Rev. 1 General Site Plan
 - ii. SNC-Lavalin Area 1330, Dwg. 0002, Rev. 1 Doris Lake Intake Pump House General Arrangement Plan & Profile

 SNC-Lavalin Area 1330, Dwg. 0003, Rev. 2 – Fresh Water Supply Pipeline (Permanent) Plan, Profile & Section

5. Fuel Storage and Containment Facility

- a. Drawings Submitted with Original Water License Application:
 - Drawings S-01, Engineering Drawings for Surface Infrastructure Components and Tailings Containment Area, Supporting Document S4 to the Revised Water License Application Support Document, April 2007
 - Drawing S-02, Engineering Drawings for Surface Infrastructure Components and Tailings Containment Area, Supporting Document S4 to the Revised Water License Application Support Document, April 2007
 - Drawing S-05, Engineering Drawings for Surface Infrastructure Components and Tailings Containment Area, Supporting Document S4 to the Revised Water License Application Support Document, April 2007
 - Drawing S-06, Engineering Drawings for Surface Infrastructure Components and Tailings Containment Area, Supporting Document S4 to the Revised Water License Application Support Document, April 2007
 - Water Licence Pre-Hearing Technical Information Supplement Figure 1, Project No. 334499

b. Issued for Construction Drawings

- i. SNC-Lavalin Area 1320, Dwg. 0002, Rev. 0 Doris Camp Tank Farm Plan and Sections
- SNC-Lavalin Area 1320, Dwg. 0003, Rev. 0 Roberts Bay Tank Farm Final Grading Plan
- iii. SNC-Lavalin Area 1320, Dwg. 0004, Rev. 0 Roberts Bay Diesel Fuel Tank Final Grading Section
- iv. SNC-Lavalin Area 1320, Dwg. 0005, Rev. 0 Roberts Bay Diesel Fuel Tank Final Grading Sections and Details
- v. SNC-Lavalin Area 1320, Dwg. 0004, Rev. 0 Roberts Bay Tank Farm Pipe Bench Plan and Profile
- vi. SNC-Lavalin Area 1320, Dwg. 0009, Rev. 0 Doris Camp Tank Farm General Arrangement

c. As-Built Drawings for Constructed Facilities

- SNC-Lavalin Area 1320, Dwg. 0001, Rev. 2 Roberts Bay Tank Farm General Arrangement
- ii. SNC-Lavalin Area 1320, Dwg. 0002, Rev. 3 Doris Camp Tank Farm Plan and Sections
- iii. SNC-Lavalin Area 1320, Dwg. 0003, Rev. 6 Roberts Bay Tank Farm Final Grading Plan
- iv. SNC-Lavalin Area 1320, Dwg. 0004, Rev. 4 Roberts Bay Diesel Fuel Tank Final Grading Section
- v. SNC-Lavalin Area 1320, Dwg. 0005, Rev. 6 Roberts Bay Diesel Fuel Tank Final Grading Sections and Details
- vi. SNC-Lavalin Area 1320, Dwg. 0006, Rev. 1 Roberts Bay Diesel Fuel Tank Quarry 1 As-Built Information Plan

6. Quarries

- a. Drawings Submitted with Original Water License Application
 - i. SRK Dwg. G-02, Rev. A General Arrangement. The following two notes are of relevance:
 - Note #3: "The Contractor is responsible to develop rock quarries within the general designated boundaries shown on this drawing. Prior to quarry development, the Contractor must provide the Construction Manager with a detailed quarry development plan for approval."
 - Note #5: "Rock quarry #4 is in the same location as the Mill pad. Rock excavated in this location can be used as general fill."

b. Issued for Construction Drawings

- i. IFC drawings were not issued and are not required as indicated on SRK IFC Dwg. G-02a, Rev. C – General Arrangement, Note #3: "The Contractor is responsible to develop rock quarries within the general designated boundaries shown on this drawing. Prior to quarry development, the Contractor must provide the Construction Manager with a detailed guarry development plan for approval."
- c. As-Built Drawings for Constructed Facilities
 - SNC-Lavalin Area 1320, Dwg. 0006, Rev. 1 Roberts Bay Diesel Fuel Tank Quarry 1 As-Built Information Plan
 - Quarry #2 is still an active quarry and therefore a final as-built has not yet been produced. The as-built limits of the quarry as it stands today is shown on SNC-Lavalin Area 1000, Dwg. 0005, Rev. 1 — Doris Camp General Arrangement Plan.
 - iii. The Mill pad area has not been constructed and therefore the quarry #4 as-built drawing has not been produced. The as-built limits of the quarry as it stands today is shown on SNC-Lavalin Area 1000, Dwg. 0005, Rev. 1 Doris Camp General Arrangement Plan..

7. Sewage Treatment Plant

- a. Drawings Submitted with Original Water License Application
 - i. None were submitted
- b. Issued for Construction Drawings
 - SNC-Lavalin Area 1000, Dwg. 0004, Rev. 0 Doris Camp Site Services Plan.
 - ii. SNC-Lavalin Area 1000, Dwg. 0005, Rev. 0 Doris Camp Site Services Sections & Details Sheet 1.
 - SNC-Lavalin Area 1000, Dwg. 0006, Rev. 1 Doris Camp Site Services Sections & Details – Sheet 2
 - iv. SNC-Lavalin Area 1000, Dwg. 0007, Rev. 0 Doris Camp Site Services Sections & Details Sheet 3
 - v. SNC-Lavalin Area 1330, Dwg. 0004, Rev. 0 Treated Sewage Effluent Pipeline (Permanent and Temporary) Plan, Profile & Section
- c. As-Built Drawings for Constructed Facilities
 - SNC-Lavalin Area 1000, Dwg. 0004, Rev. 2 Doris Camp Site Services Plan.
 - SNC-Lavalin Area 1000, Dwg. 0005, Rev. 2 Doris Camp Site Services Sections & Details – Sheet 1.

- SNC-Lavalin Area 1000, Dwg. 0006, Rev. 2 Doris Camp Site Services Sections & Details – Sheet 2
- iv. SNC-Lavalin Area 1000, Dwg. 0007, Rev. 1 Doris Camp Site Services Sections & Details – Sheet 3
- v. SNC-Lavalin Area 1330, Dwg. 0004, Rev. 2 Treated Sewage Effluent Pipeline (Permanent and Temporary) Plan, Profile & Section

8. Airstrip

- a. Relevant Drawings Submitted with Original Water License Application:1
 - SRK Dwg. S-03, Rev B Airstrip and Apron Plan, Typical Sections and Details
- b. Issued for Construction Drawings
 - i. SRK Dwg. S-03, Rev D Airstrip and Apron Plan, Typical Sections and Details
- c. As-Built Drawings for Constructed Facilities
 - SNC-Lavalin Area 1550 Dwg. 002, Rev 1 Roberts Bay, Airstrip and Apron Plan and Section

9. Camp

- a. Relevant Drawings Submitted with Original Water License Application
 - i. SRK Dwg. S-07, Rev B Camp and Mill Pad Plan
 - ii. SRK Dwg. S-08, Rev B Camp and Mill Pad, Typical Sections and Detail
- b. Issued for Construction Drawings
 - SNC-Lavalin Area 1000, Dwg. 0004, Rev 0 Doris Camp Site Services, Plan
 - ii. SNC-Lavalin Area 1320, Dwg. 0010, Rev 0 Doris Camp Site Layout, Plan Sheet 1
 - iii. SNC-Lavalin Area 1320, Dwg. 0011, Rev 0 Doris Camp Site Layout, Plan - Sheet 2
 - iv. SNC-Lavalin Area 1320, Dwg. 0014, Rev 0 Doris Camp Final Grading, Plan - Sheet 1
 - v. SNC-Lavalin Area 1320, Dwg, 0015, Rev 0 Doris Camp Final Grading, Plan Sheet 2
- c. As-Built Drawings for Constructed Facilities
 - i. SNC-Lavalin Area 0000, Dwg. 0027, Rev 1 Control Points
 - SNC-Lavalin Area 1000, Dwg. 0005, Rev 1 Doris Camp General Arrangement Plan
 - SNC Lavalin Area 1000, Dwg. 0006, Rev 0 Matrix Camp.
 Temporary Campsite as Built
 - SNC-Lavalin Area 1000, Dwg. 0004, Rev 2 Doris Camp Site Services. Plan
 - v. SNC-Lavalin Area 1320, Dwg. 0010, Rev 7 Doris Camp Site Layout, Plan Sheet 1
 - vi. SNC-Lavalin Area 1320, Dwg. 0011, Rev 5 Doris Camp Site Layout, Plan Sheet 2

vii. SNC-Lavalin Area 1320, Dwg. 0014, Rev 4 - Doris Camp Final Grading, Plan - Sheet 1

 SNC-Lavalin Area 1320, Dwg. 0015, Rev 3 - Doris Camp Final Grading, Plan - Sheet 2

10. Jetty


- a. Relevant Drawings Submitted with Original Water License Application
 - i. SRK Dwg. J-01, Rev. B Jetty Plan
 - ii. SRK Dwg. J-02, Rev. B Jetty Typical Section and Details Sheet
 - ii. SRK Dwg. J-03, Rev. B Jetty Typical Section and Details Sheet 2 of 2
- b. Issued for Construction Drawings
 - i. SRK Dwg. J-01, Rev. D Jetty Plan
 - ii. SRK Dwg. J-02, Rev. D Jetty Typical section and Details Sheet 1 of 2
 - SRK Dwg. J-03, Rev. D Jetty Typical Section and Details Sheet 2 of 2
 - iv. SRK Dwg. J-05, Rev. A Geogrid Panel Layout
 - v. SRK Dwg. J-06, Rev. A Fish Habitat Compensation Jetty Spur Design by Golder Associates
 - vi. SRK Dwg. J-07, Rev. C Fish Habitat Compensation Shorefast Spur Design by Golder Associates
- c. As-Built Drawings for Constructed Facilities
 - SNC-Lavalin Area 0000, Dwg. 0012, Rev. 1 Roberts Bay Jetty General Arramgement Plan
 - SNC-Lavalin Area 1315, Dwg. 0001, Rev. 1 Roberts Bay Habitat Fisheries Compensation Plans and Sections


¹ Note these drawings are not specifically referenced in 2AM-DOH0713


Doris North Project: Proposed/IFC/As Built Drawings


Site Arrangement

1. Doris North Site Arrangement Drawings (prepared on January 22, 2010 by SRK Engineering)

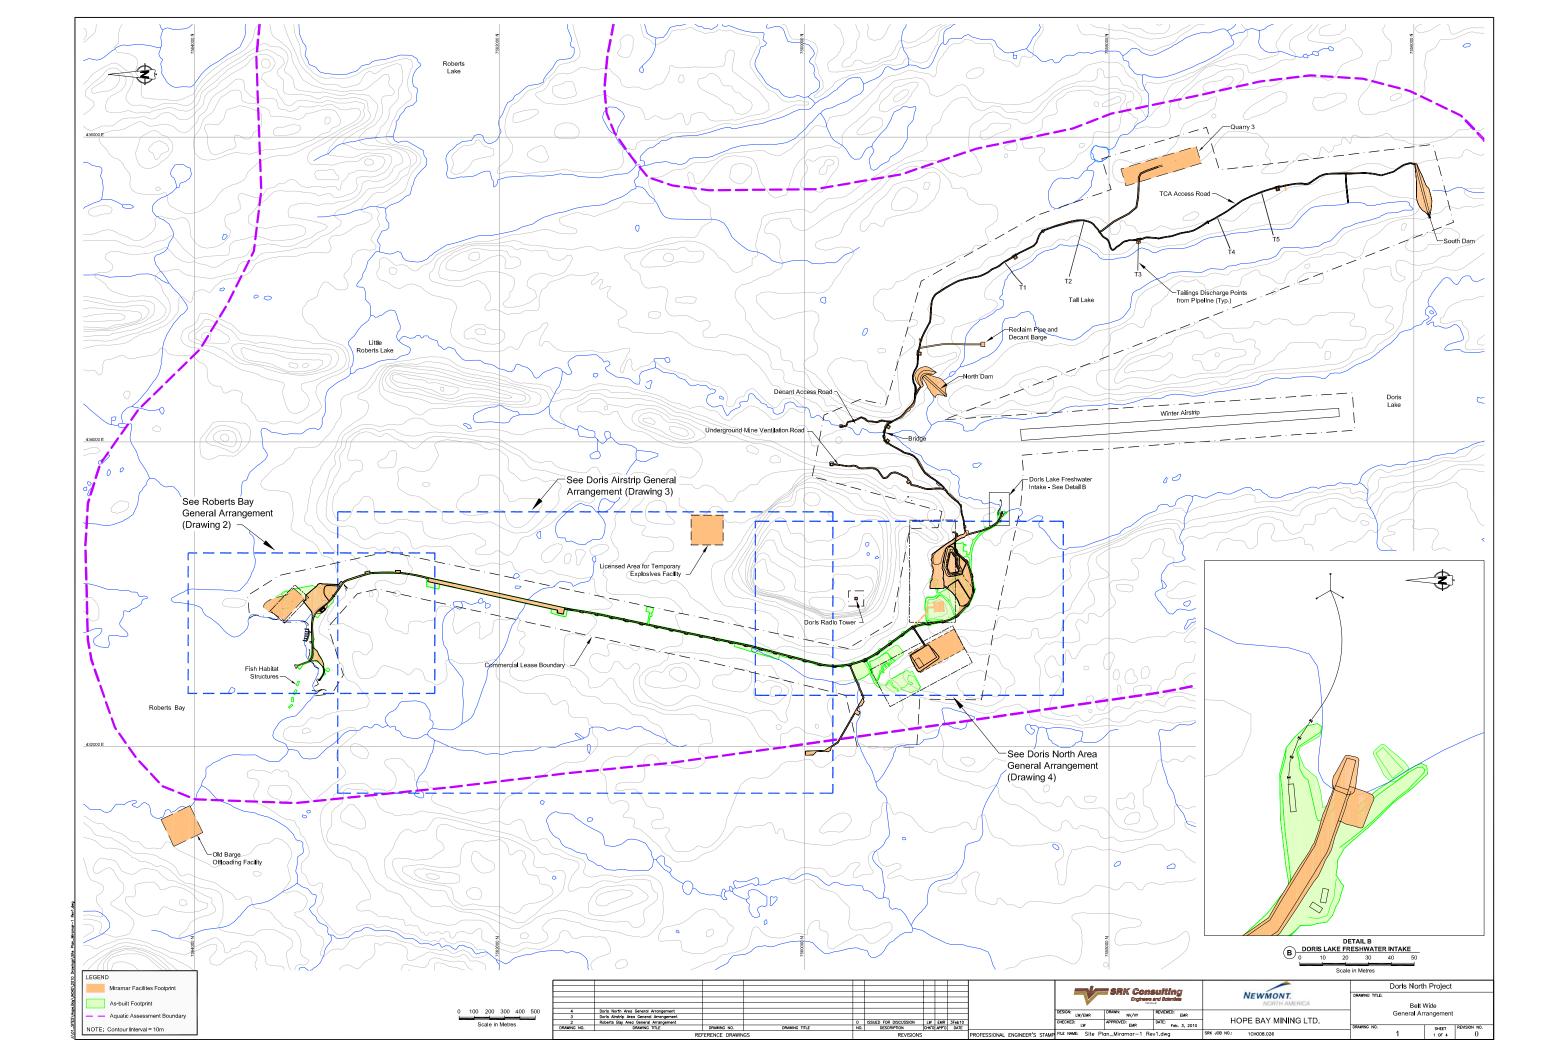

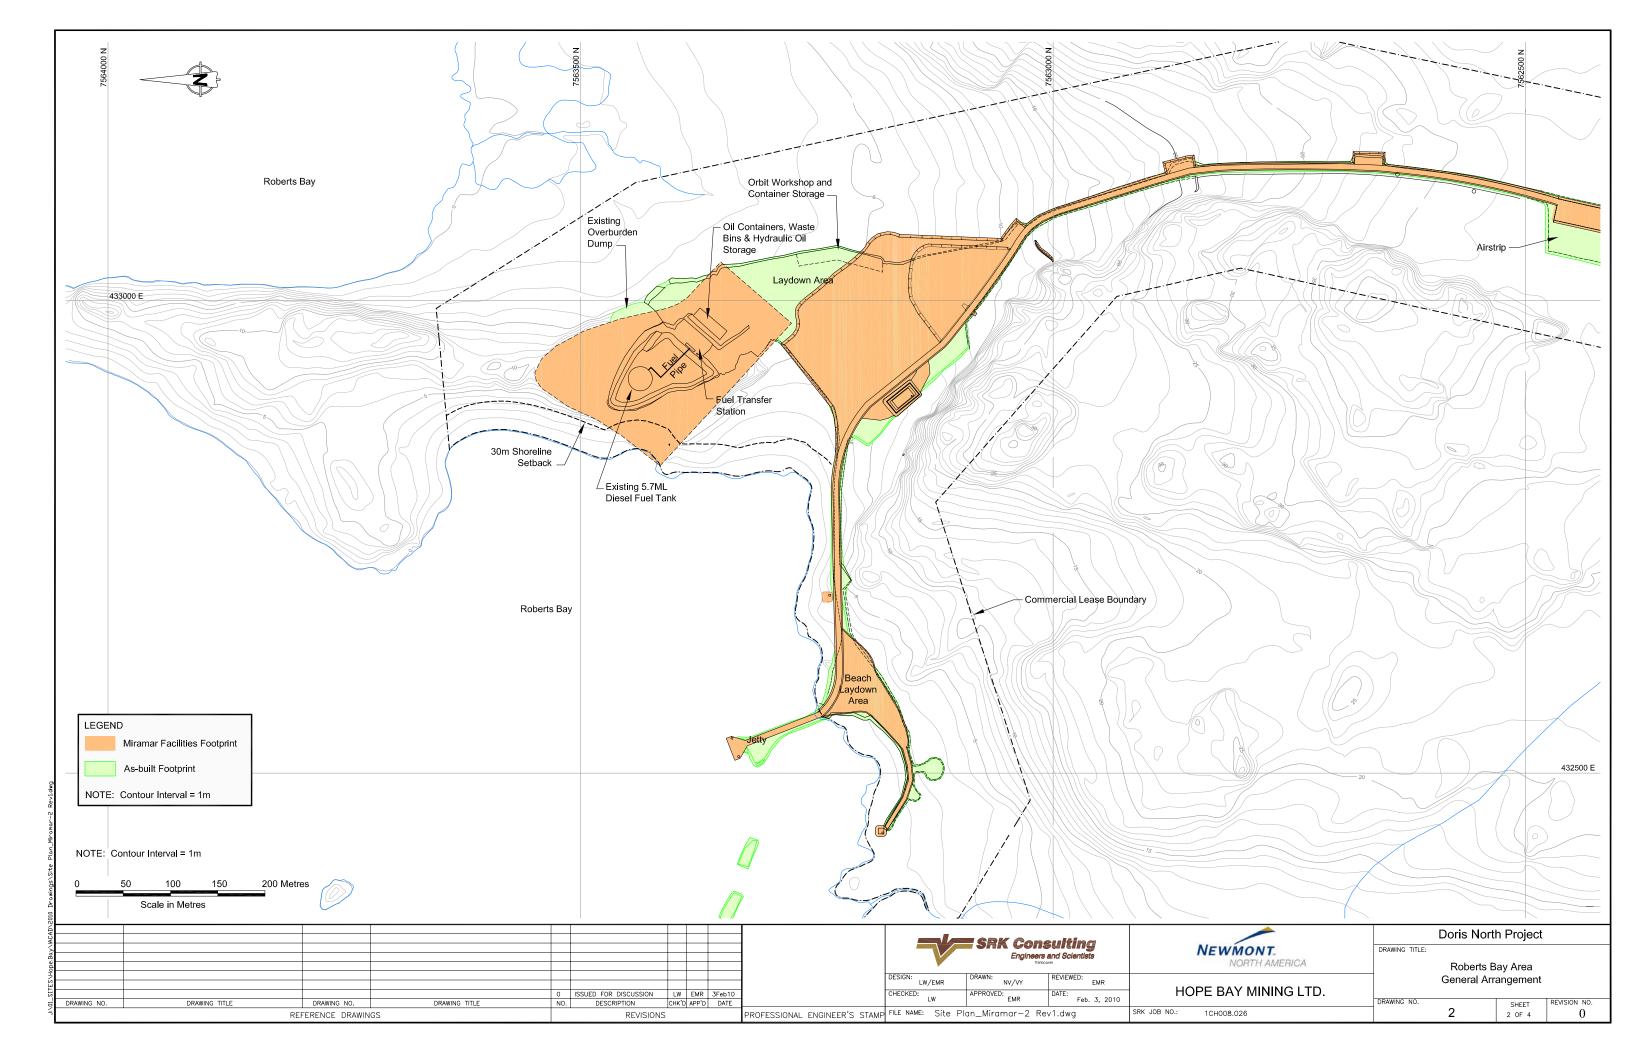


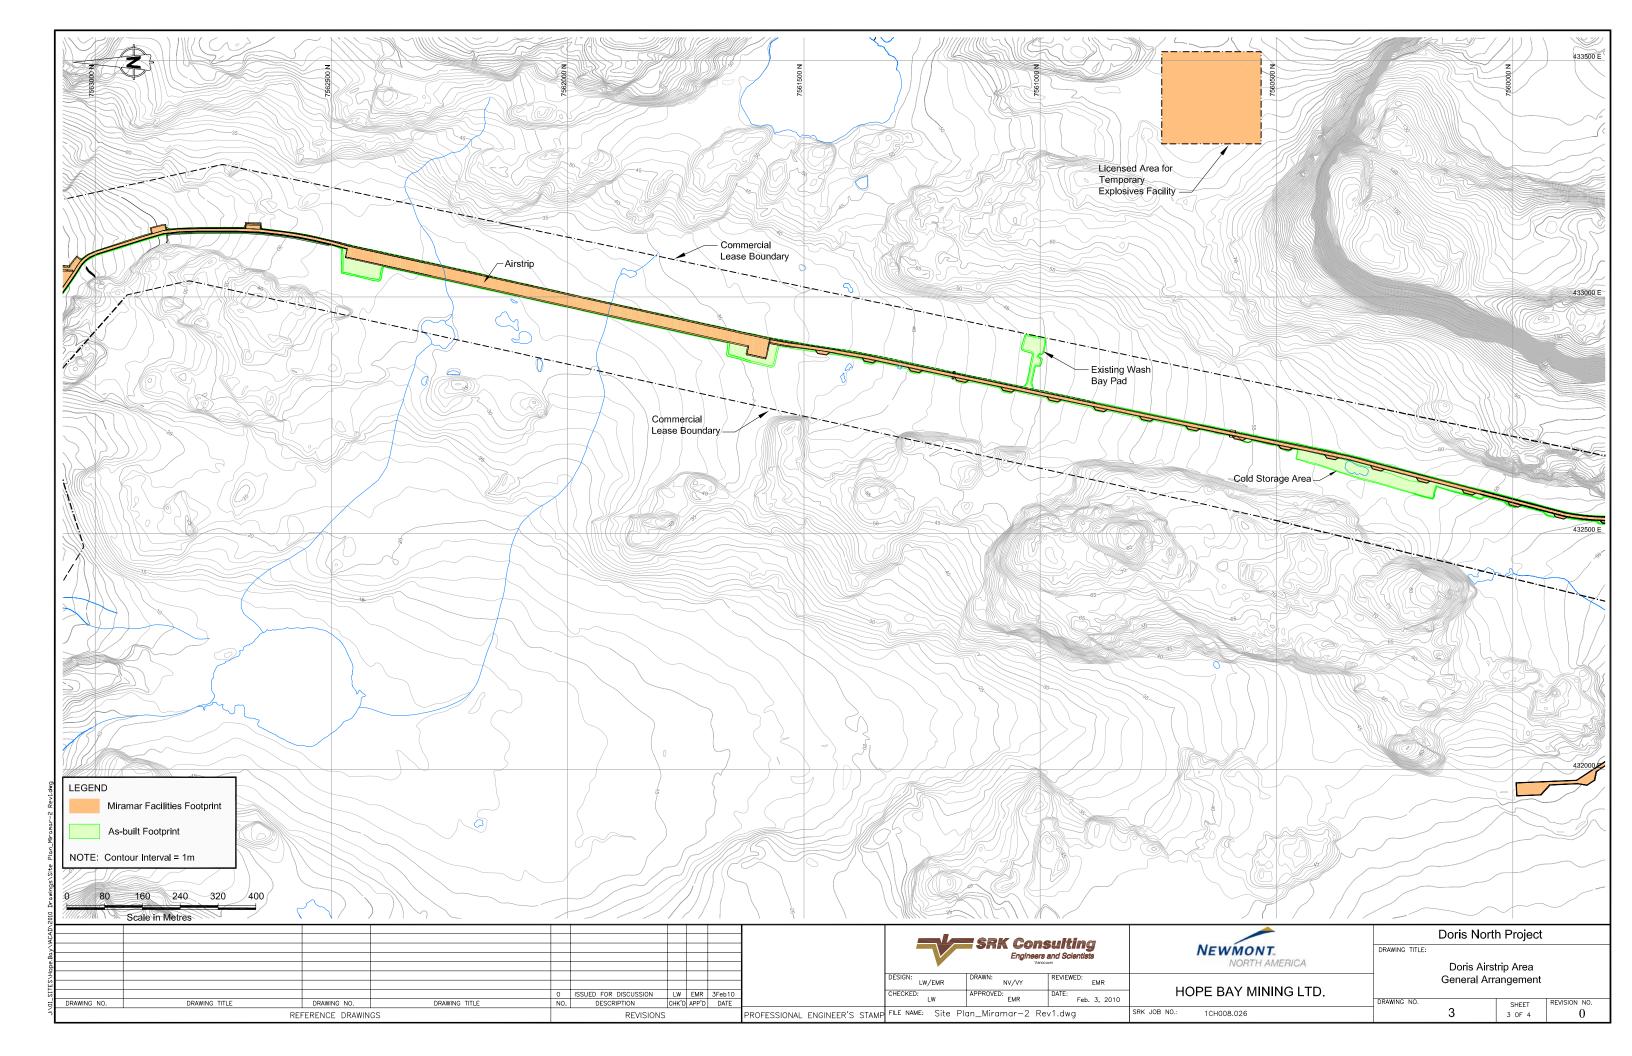

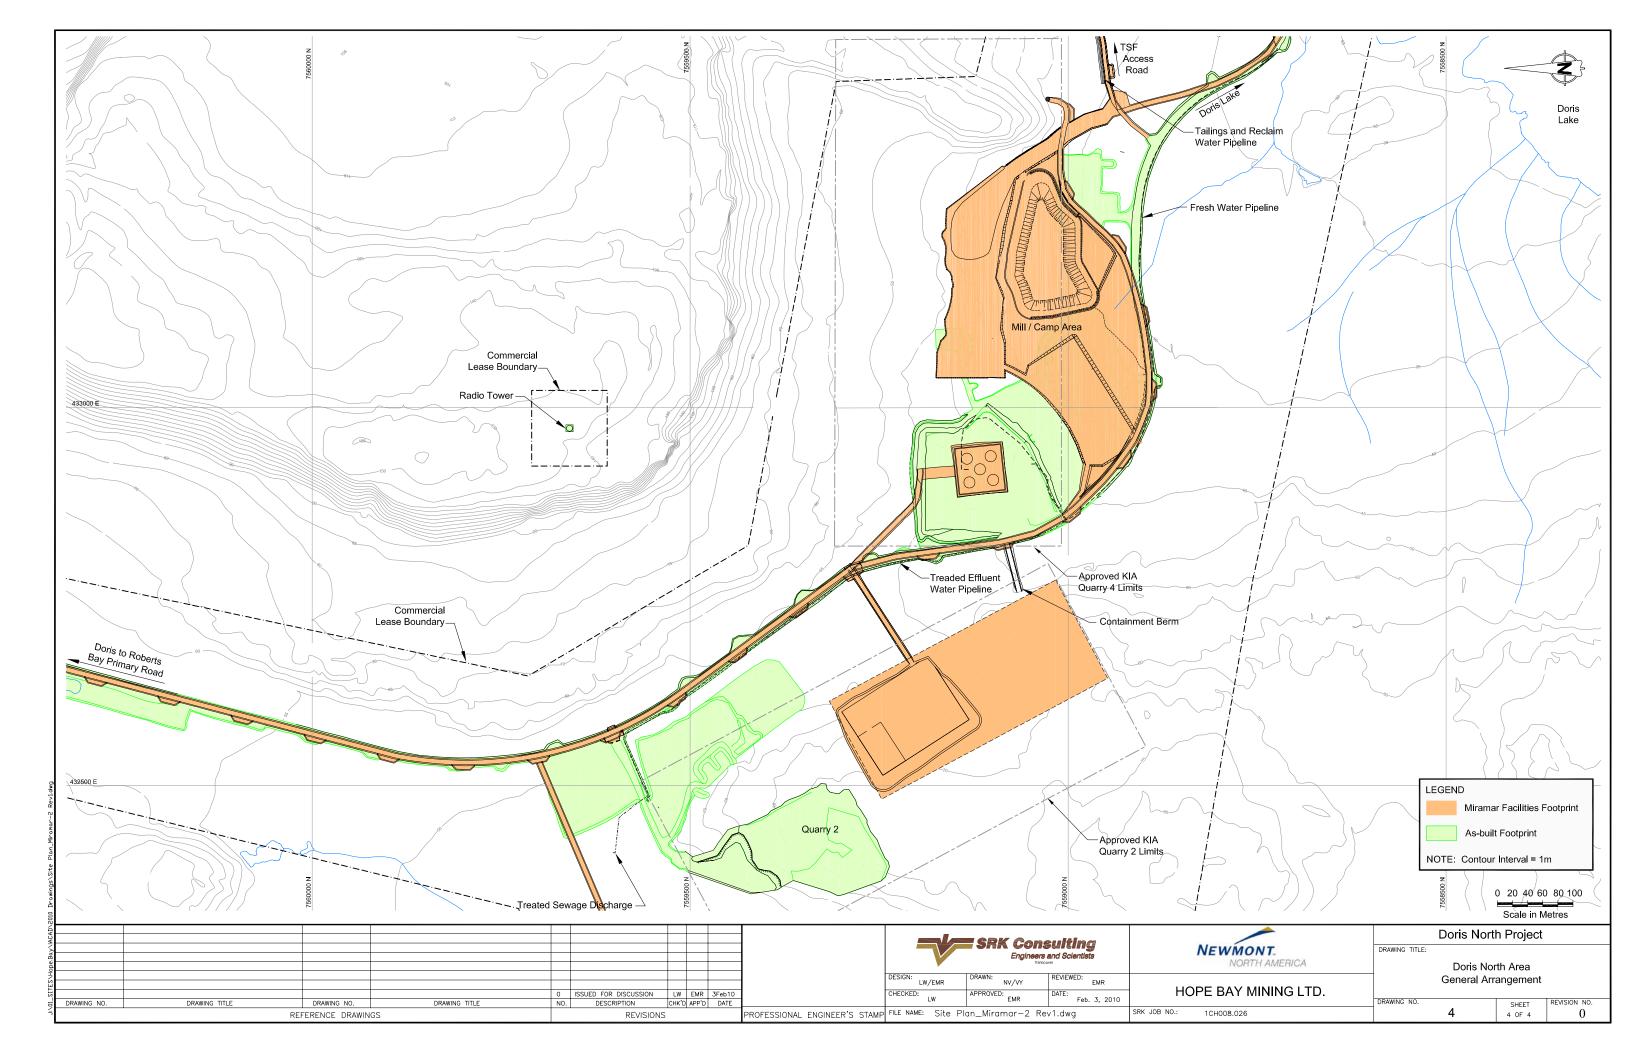


Facilities Described in 2AM-DOH0713 and Constructed to Date 2. All Weather Access Road (note to date HBML has only constructed portion from Roberts Bay to Doris North camp site)

2a Relevan	nt Drawings Submitted wi	th Original Water Licens	se Application	
	-			

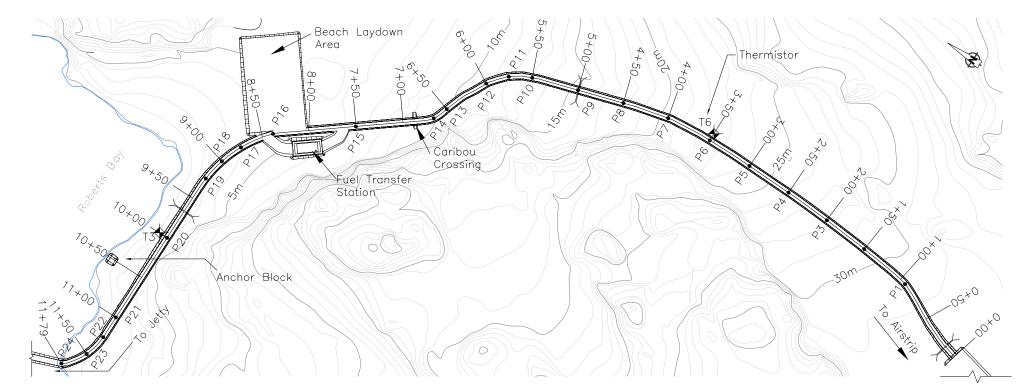

NORTH PRIMARY ROAD PLAN LAYOUT



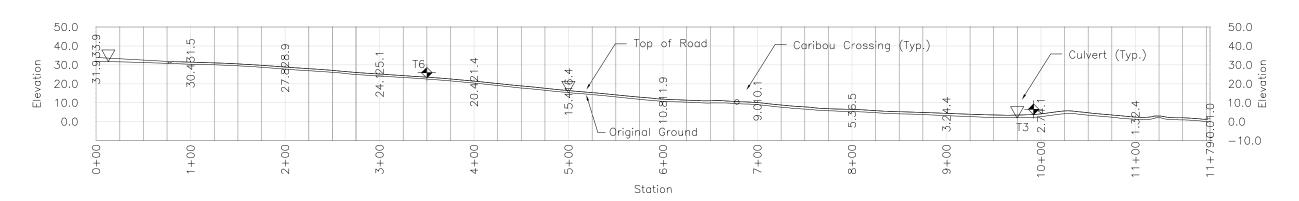

NORTH PRIMARY ROAD PROFILE

0 20 40 60 80 100 m

Legend:





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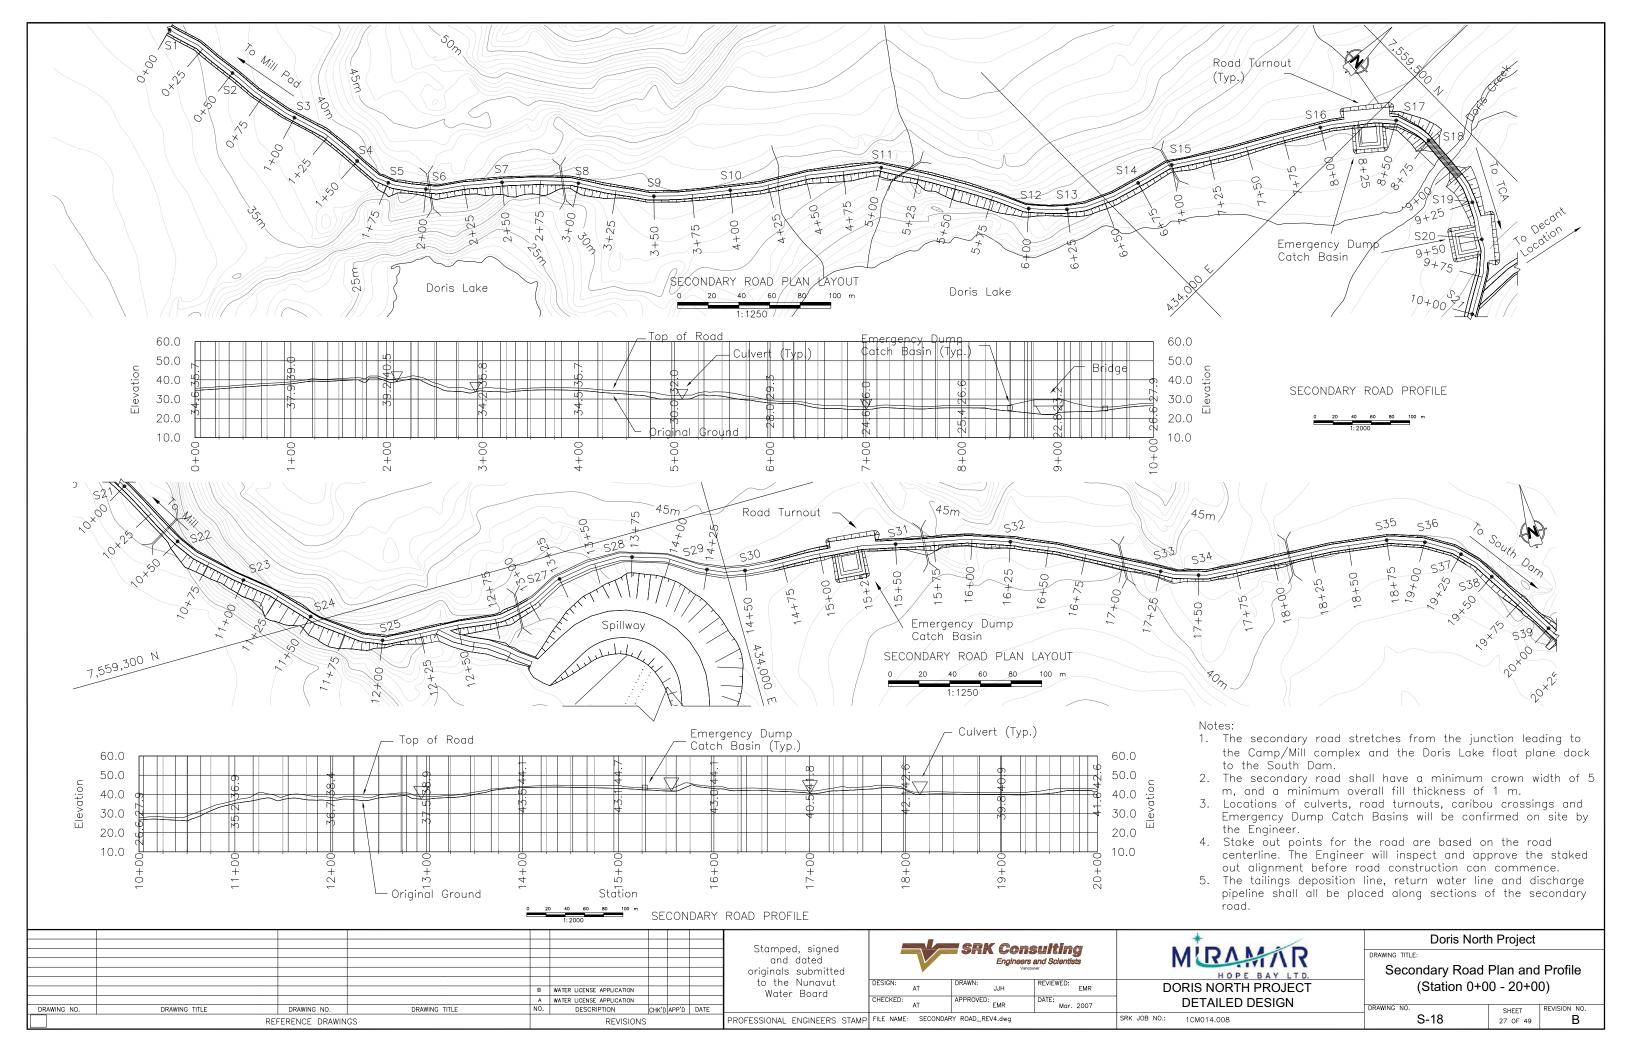
- 1. The north primary road stretches from the Jetty to the northern end of the airstrip.
- 2. The primary road shall have a minimum crown width of 6 m, and a minimum overall fill thickness of 1 m.
- 3. Locations of culverts, road turnouts and caribou crossings will be confirmed on site by the Engineer.
- 4. Stake out points for the road are based on the road centerline. The Engineer will inspect and approve the staked out alignment before road construction can commence.
- 5. Stake out points are listed on drawing S-21.


Note: Drawings plotted to half scale


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										*	Doris Nort	th Project
						Stamped, signed and dated		SRK Coi	nsulting ers and Scientists	MIRAMINR	DRAWING TITLE:	
						originals submitted to the Nunavut	DECICNI	L DDAWN.	/ancouver	HOPE BAY LTD.	North Primary Roa	
				B WATER LICENCE APPLICATION		Water Board	DESIGN: AT	JJH	REVIEWED: EMR	DORIS NORTH PROJECT	(Station 00+	·00 - 11+79)
DRAWING NO.	DRAWING TITLE	DRAWING NO.	DRAWING TITLE	NO. DESCRIPTION	CHK'D APP'D DATE		AT	APPROVED: EMR	DATE: Mar. 2007	DETAILED DESIGN	DRAWING NO.	SHEET REVISION NO.
		REFERENCE DRAWIN	GS	REVISION	S	PROFESSIONAL ENGINEERS STAME	FILE NAME: PRIMARY F	ROAD_rev4(black_lines	i).dwg	SRK JOB NO.: 1CM014.008	S-15	24 OF 49 B



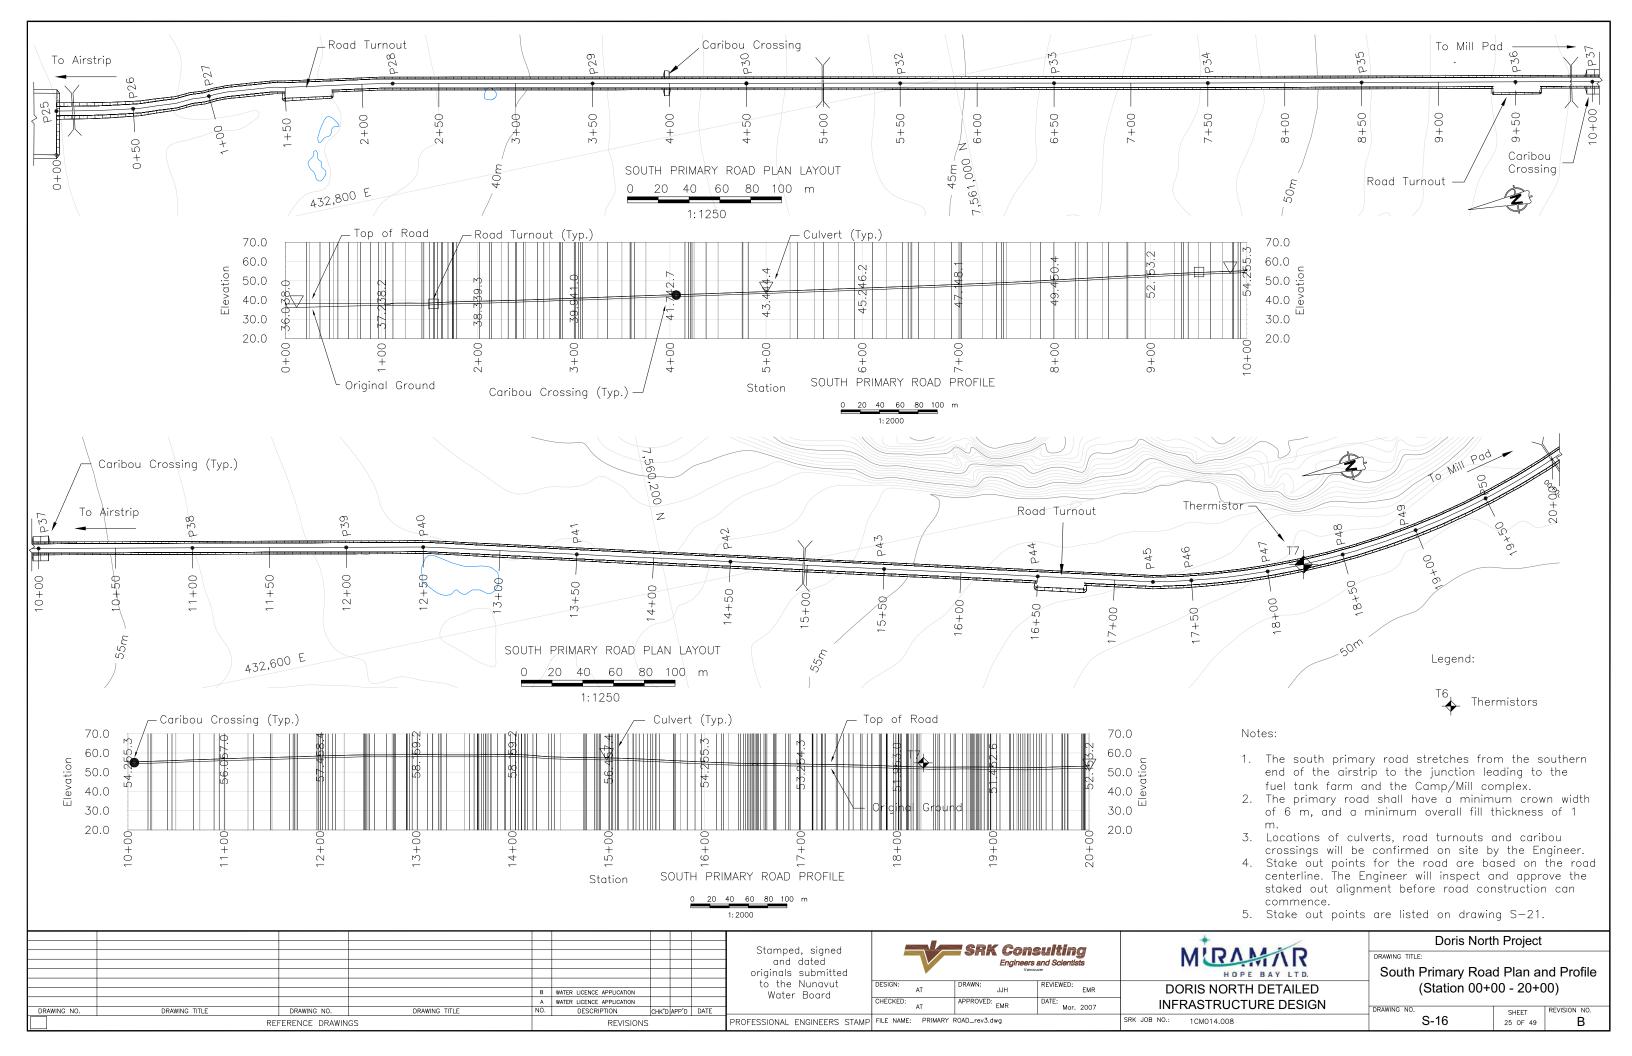

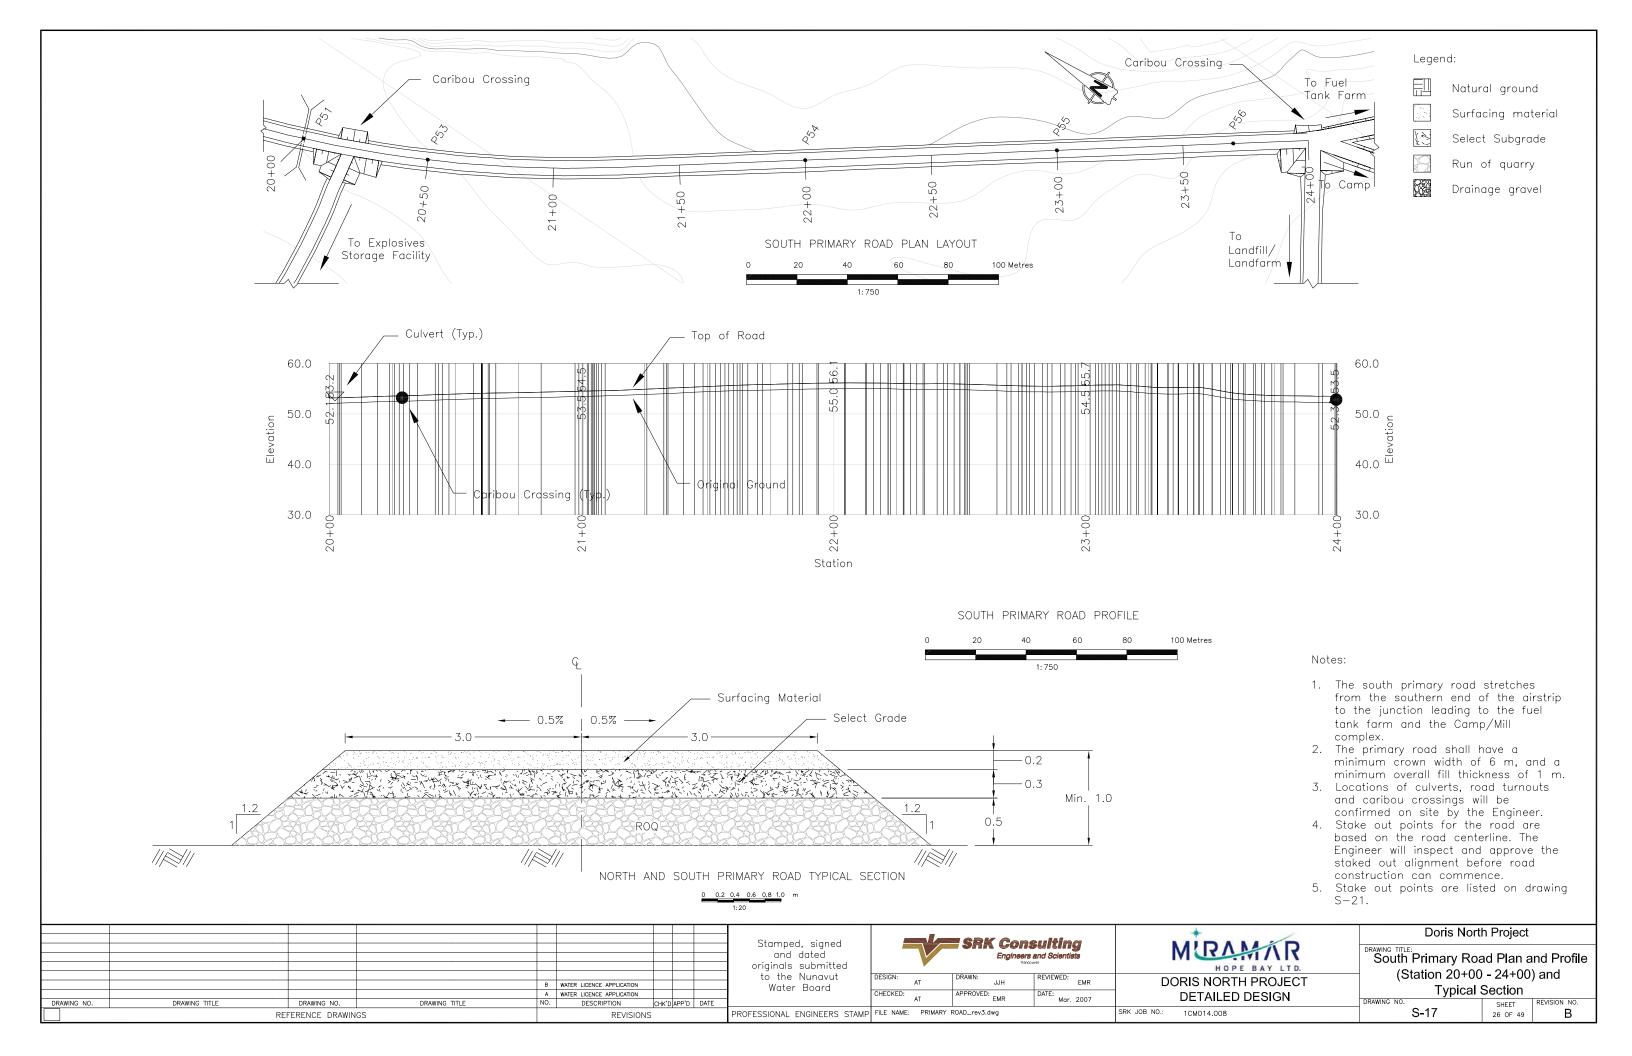

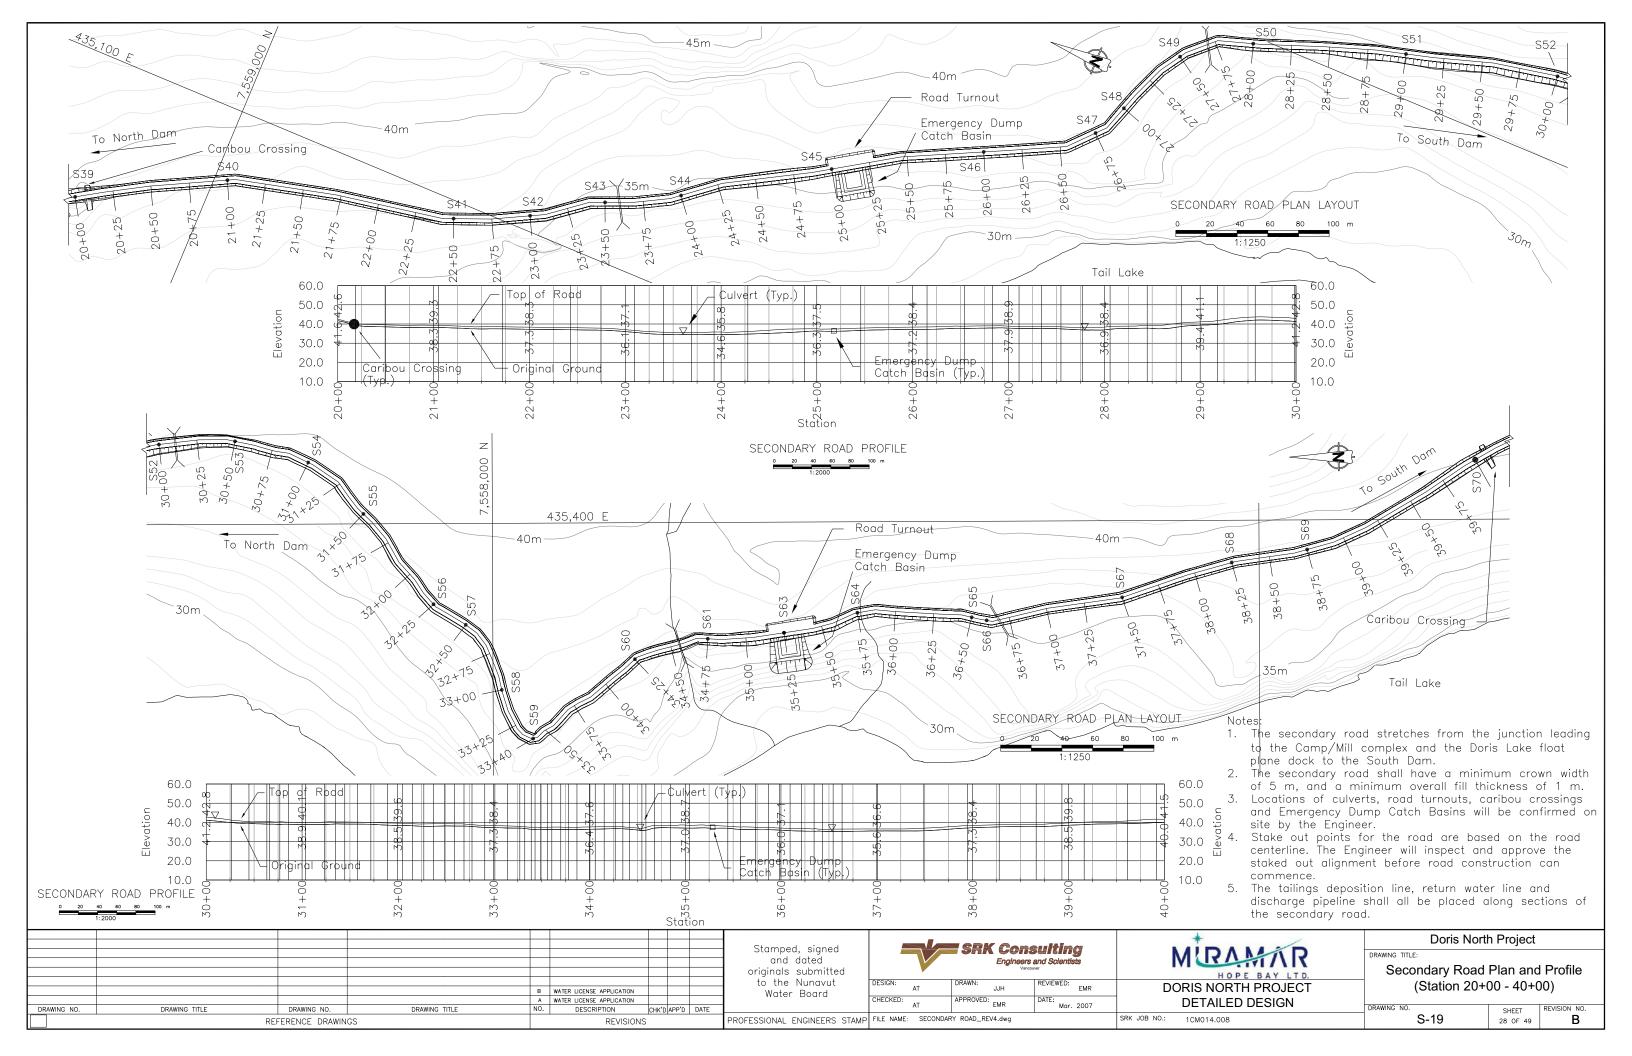

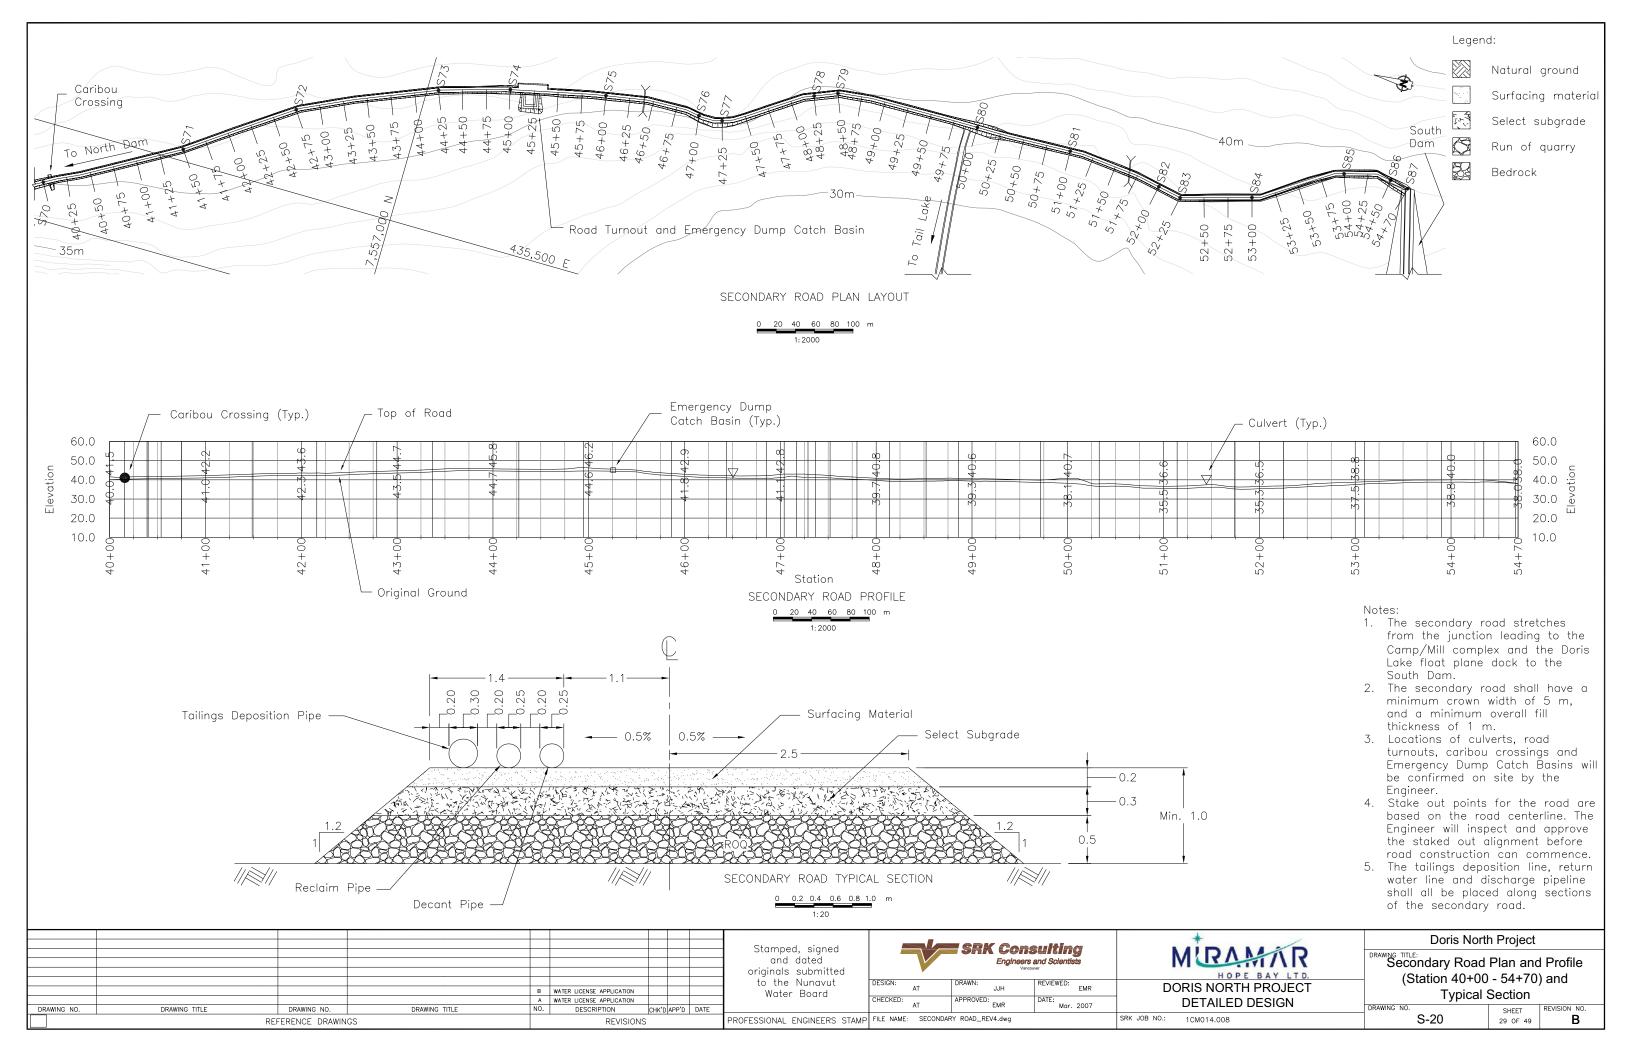

STAKE OUT TABLE						
Primary Road North 0+00-11+79						
Point	Easting	Northing				
P1	433130.7	7562553.7				
P2	433137.3	7562610.2				
P3	433140.5	7562660.1				
P4	433142.1	7562710.1				
P5	433142.3	7562760.1				
P6	433141.3	7562810.1				
P7	433136.2	7562859.7				
P8	433122.8	7562907.9				
P9	433107.3	7562955.4				
P10	433091.2	7563002.7				
P11	433078.3	7563024.0				
P12	433059.0	7563039.7				
P13	433013.2	7563059.3				
P14	432997.3	7563065.2				
P15	432944.2	7563128.8				
P16	432888.7	7563197.1				
P17	432857.8	7563217.2				
P18	432834.4	7563225.7				
P19	432809.7	7563229.7				
P20	432734.7	7563228.6				
P21	432634.8	7563226.4				
P22	432609.8	7563225.8				
P23	432585.4	7563230.4				
P24	432562.1	7563247.0				

J1.	AKE OUT TAB	LE						
Primary Road South 0+00-24+00								
Point	Easting	Northing						
P25	432898.9	7561575.5						
P26	432890.0	7561526.3						
P27	432887.9	7561476.5						
P28	432871.1	7561357.9						
P29	432844.2	7561230.7						
P30	432823.6	7561132.8						
P31	432823.6	7561132.8						
P32	432803.0	7561035.0						
P33	432782.3	7560937.1						
P34	432761.7	7560839.3						
P35	432741.3	7560741.4						
P36	432721.0	7560643.5						
P37	432710.8	7560594.5						
P38	432690.4	7560496.6						
P39	432670.1	7560398.7						
P40	432659.9	7560349.8						
P41	432634.6	7560253.0						
P42	432609.2	7560156.3						
P43	432583.9	7560059.5						
P44	432558.5	7559962.8						
P45	432539.5	7559890.3						
P46	432535.3	7559865.6						
P47	432530.7	7559815.9						
P48	432531.4	7559765.9						
P49	432537.0	7559716.2						
P50	432547.9	7559667.4						
P51	432563.6	7559620.0						
P52	430722.2	7558603.6						
P53	432584.2	7559574.5						
P54	432667.8	7559450.2						
P55	432726.9	7559369.5						
P56	432768.2	7559313.0						


STAKE OUT TABLE							
	Secondary Road 0+00-28+00						
Point	Easting	Northing					
S1	433409.3	7558941.7					
		7558951.2					
S2 S3	433458.2						
	433507.3	7558959.7					
S4	433556.1	7558969.1					
S5	433580.4	7558973.7					
S6	433600.6	7558988.3					
S7	433632.2	7559026.8					
S8	433667.5	7559062.0					
S9	433708.0	7559091.2					
S10	433748.1	7559123.2					
S11	433798.7	7559210.1					
S12	433885.1	7559260.1					
S13	433902.9	7559277.5					
S14	433923.2	7559322.7					
S15	433930.1	7559346.6					
S16	433980.6	7559432.8					
S17	434012.0	7559471.4					
S18	434035.9	7559477.4					
S19	434084.9	7559469.5					
S20	434106.4	7559457.0					
S21	434136.8	7559418.3					
S22	434160.6	7559374.3					
S23	434195.2	7559338.5					
S24	434231.0	7559303.8					
S25	434262.5	7559253.1					
S26	434345.3	7559244.7					
	434393.9						
S27	434443.3	7559283.7					
S28		7559284.8					
S29	434488.3	7559263.7					
S30	434512.0	7559256.5					
S31	434611.2	7559246.6					
S32	434683.7	7559227.9					
S33	434773.0	7559183.0					
S34	434796.1	7559174.0					
S35	434920.5	7559162.9					
S36	434944.1	7559155.0					
S37	434964.7	7559141.1					
S38	434980.1	7559121.5					
S39	435006.7	7559079.2					
S40	435055.1	7558991.8					
S41	435088.9	7558846.0					
S42	435109.8	7558800.6					
S43	435136.8	7558758.9					
S44	435160.1	7558714.9					
S45	435213.8	7558630.9					
S46	435262.4	7558543.7					
S47	435301.9	7558481.1					
S48	435324.0	7558470.3					
S49	435369.1	7558449.5					
S50	435395.4	7558408.8					
350	400090.4	/ / / / / / / / / / / / / / / / / / / /					

STAKE OUT TABLE								
	Secondary Road 28+00-57+00							
Point	Easting	Northing						
S51	435427.6	7558314.2						
S52	435452.3	7558217.4						
S53	435454.2	7558167.7						
S54	435440.2	7558120.0						
S55	435406.5	7558084.1						
S56	435347.4	7558038.6						
S57	435333.9	7558017.7						
S58	435291.3	7557994.4						
S59	435259.5	7557974.0						
S60	435311.0	7557907.4						
S61	435324.1	7557859.9						
S62	435327.8	7557810.1						
S63	435327.8	7557810.1						
S64	435340.7	7557762.2						
S65	435337.4	7557687.7						
S66	435335.4	7557677.9						
S67	435350.0	7557589.4						
S68	435372.4	7557517.9						
S69	435380.7	7557468.6						
S70	435438.8	7557358.8						
S71	435511.9	7557227.8						
S72	435584.1	7557125.8						
S73	435644.3	7556988.6						
S74	435665.7	7556916.7						
S75	435687.0	7556819.0						
S76	435693.6	7556719.9						
S77	435695.2	7556695.3						
S78	435746.5	7556610.0						
S79	435755.9	7556586.8						
S80	435761.8	7556437.2						
S81	435764.5	7556337.3						
S82	435754.2	7556238.1						
S83	435749.3	7556213.6						
S84	435770.2	7556141.5						
S85	435820.4	7556056.0						
S86	435827.3	7556007.3						
S87	435823.8	7555987.7						

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				В	WATER LICENSE APPLICATION			1	1
				A	WATER LICENSE APPLICATION]
DRAWING NO.	DRAWING TITLE	DRAWING NO.	DRAWING TITLE	NO.	DESCRIPTION	CHK'D	APP'D	DATE	L
	REFERENCE DRAWINGS					3			Pf

Stamped, signed and dated originals submitted to the Nunavut Water Board




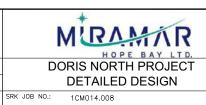

Doris North Project DRAWING TITLE: Primary and Secondary Road

Stake Out Points DRAWING NO.


SHEET REVISION NO.
30 OF 49 S-21

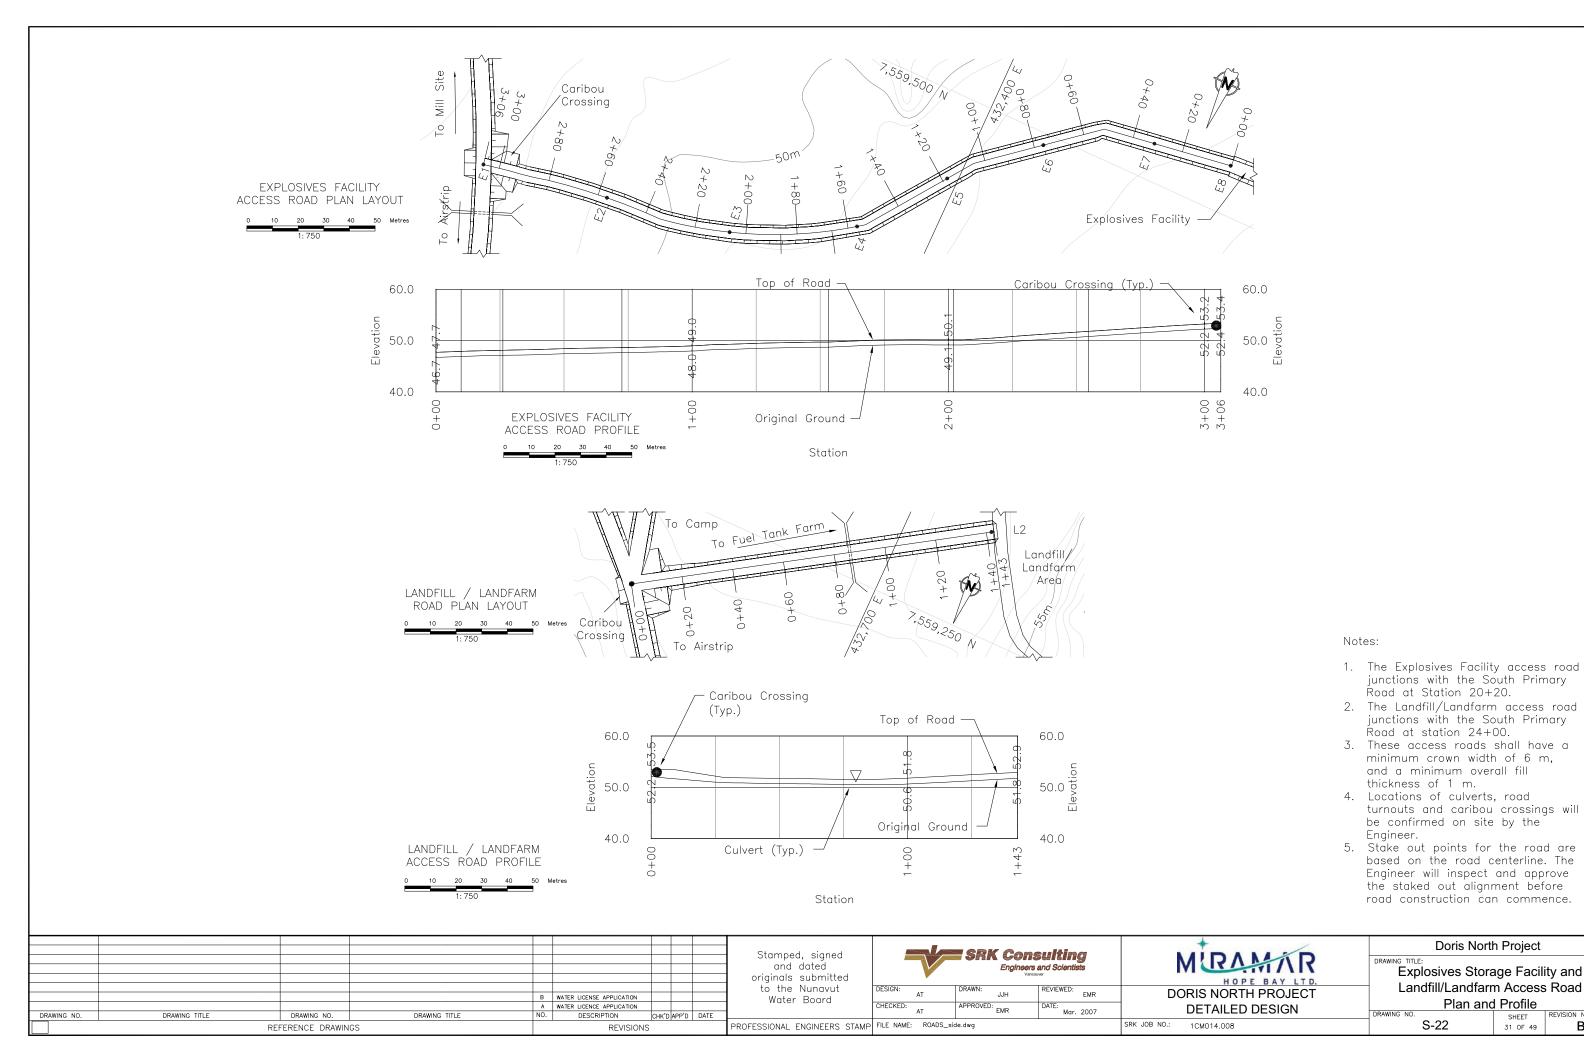



SHEET

31 OF 49

В

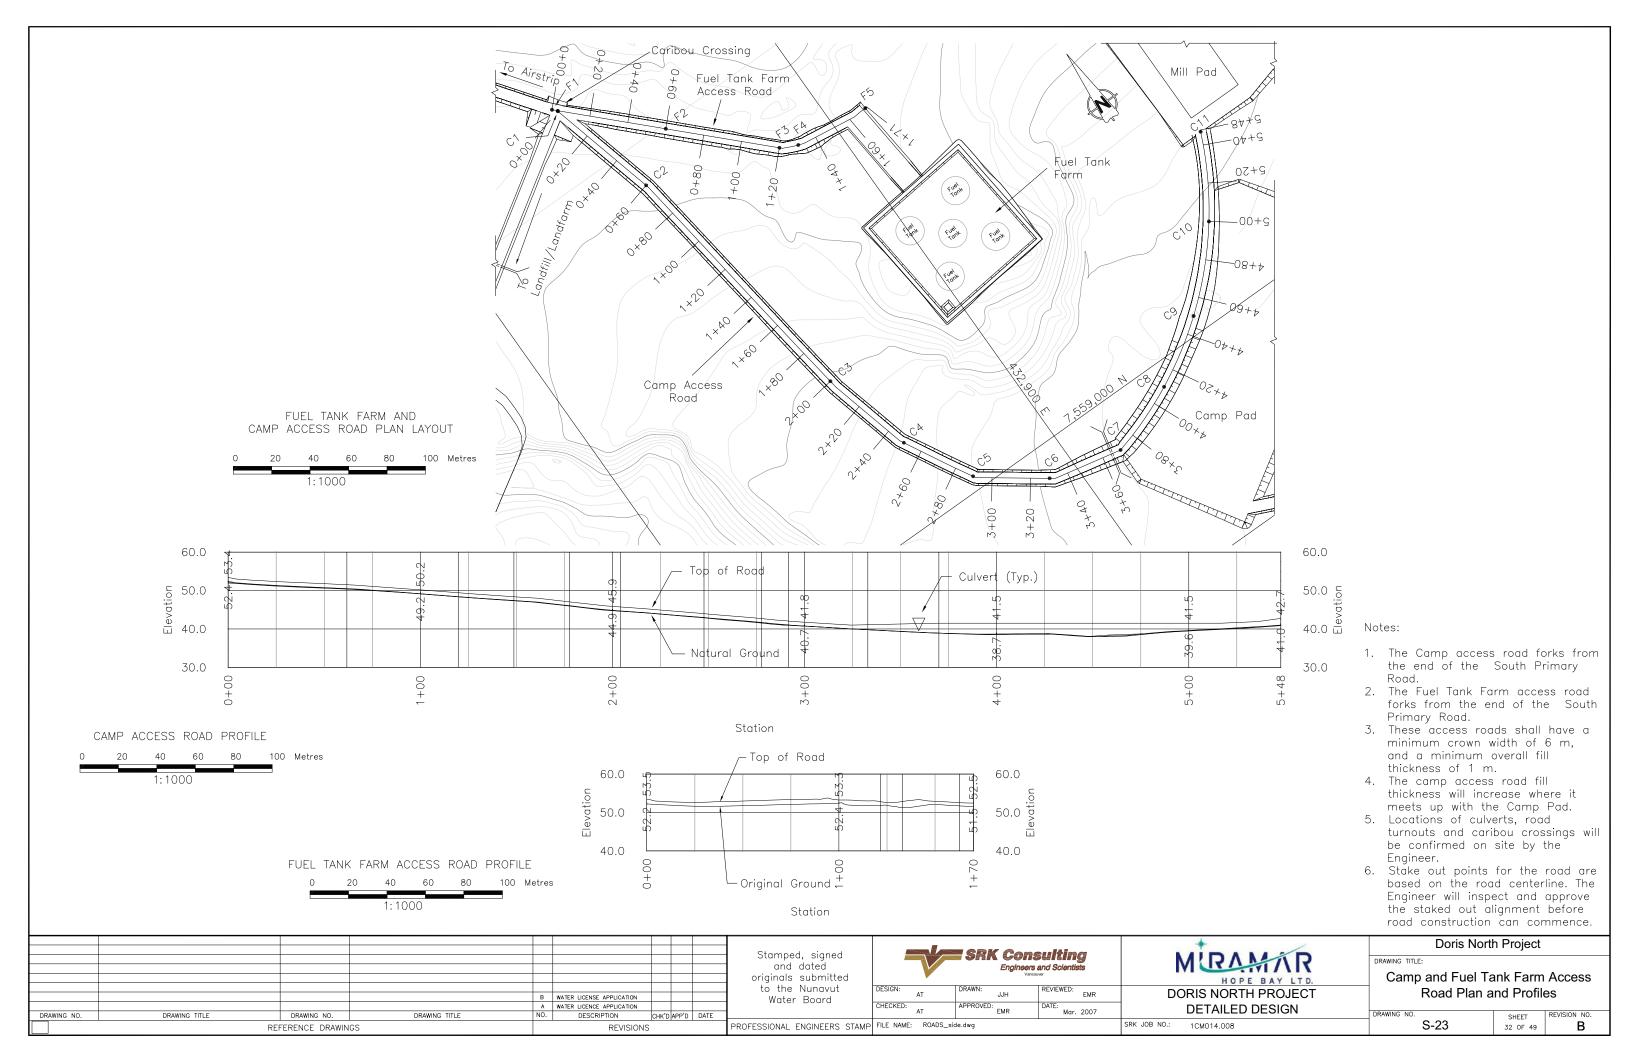

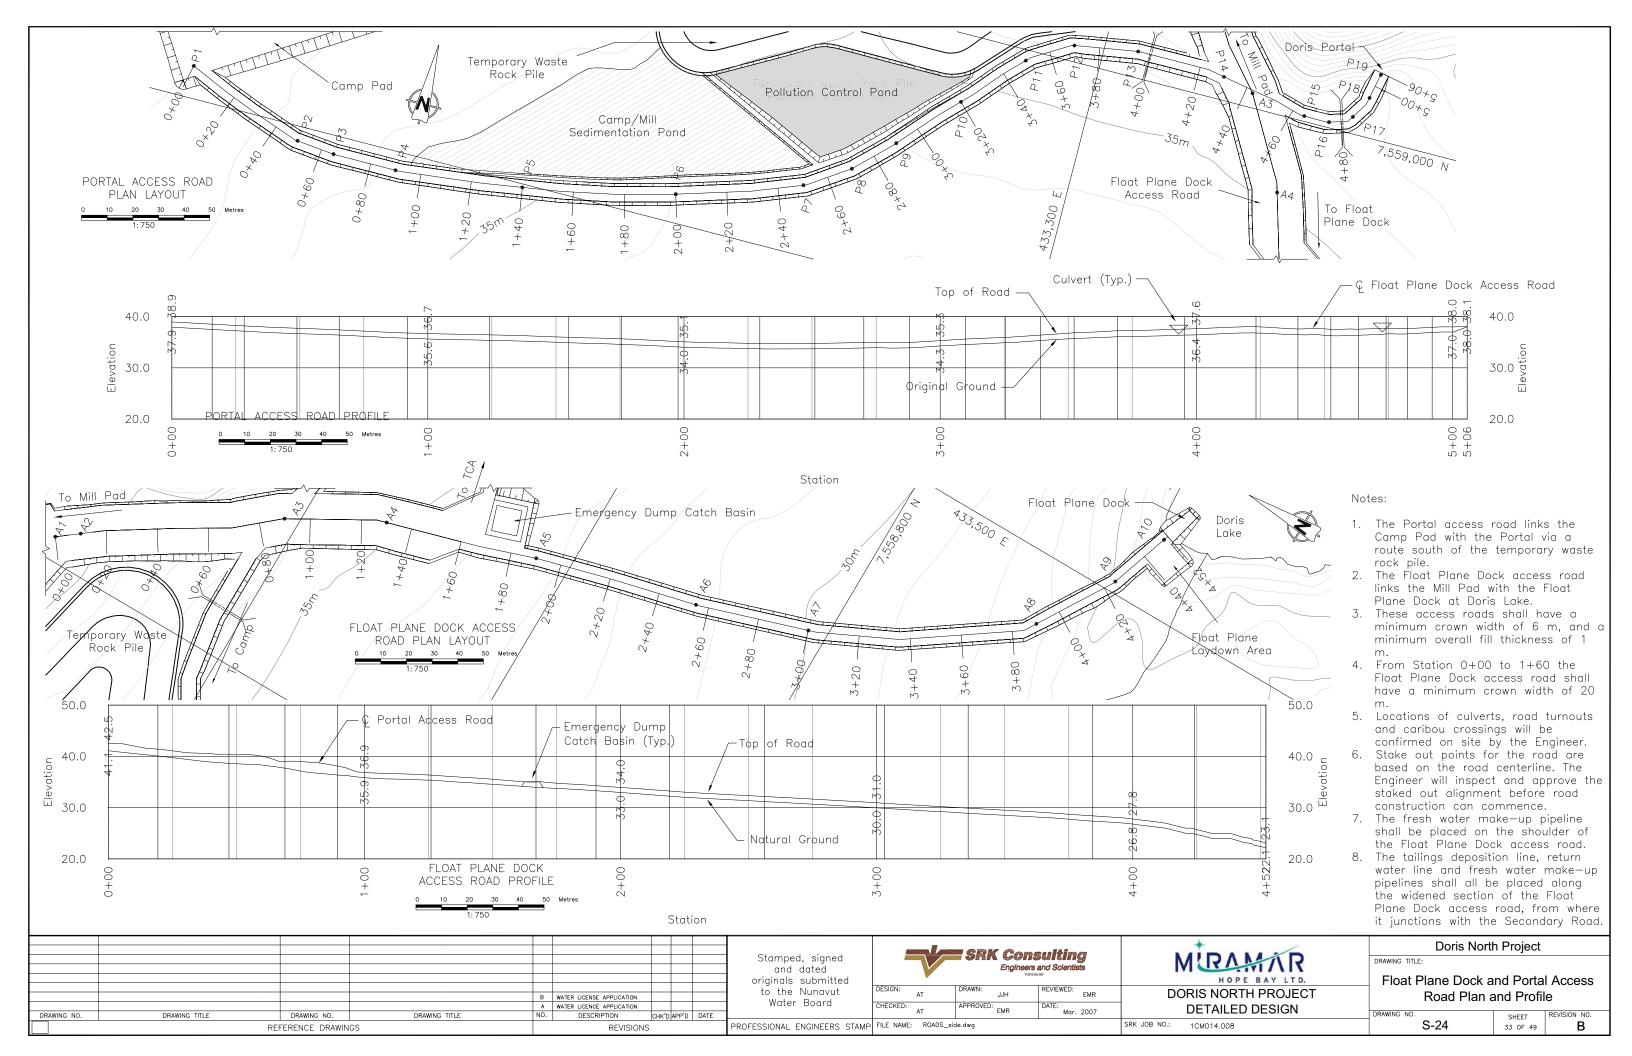

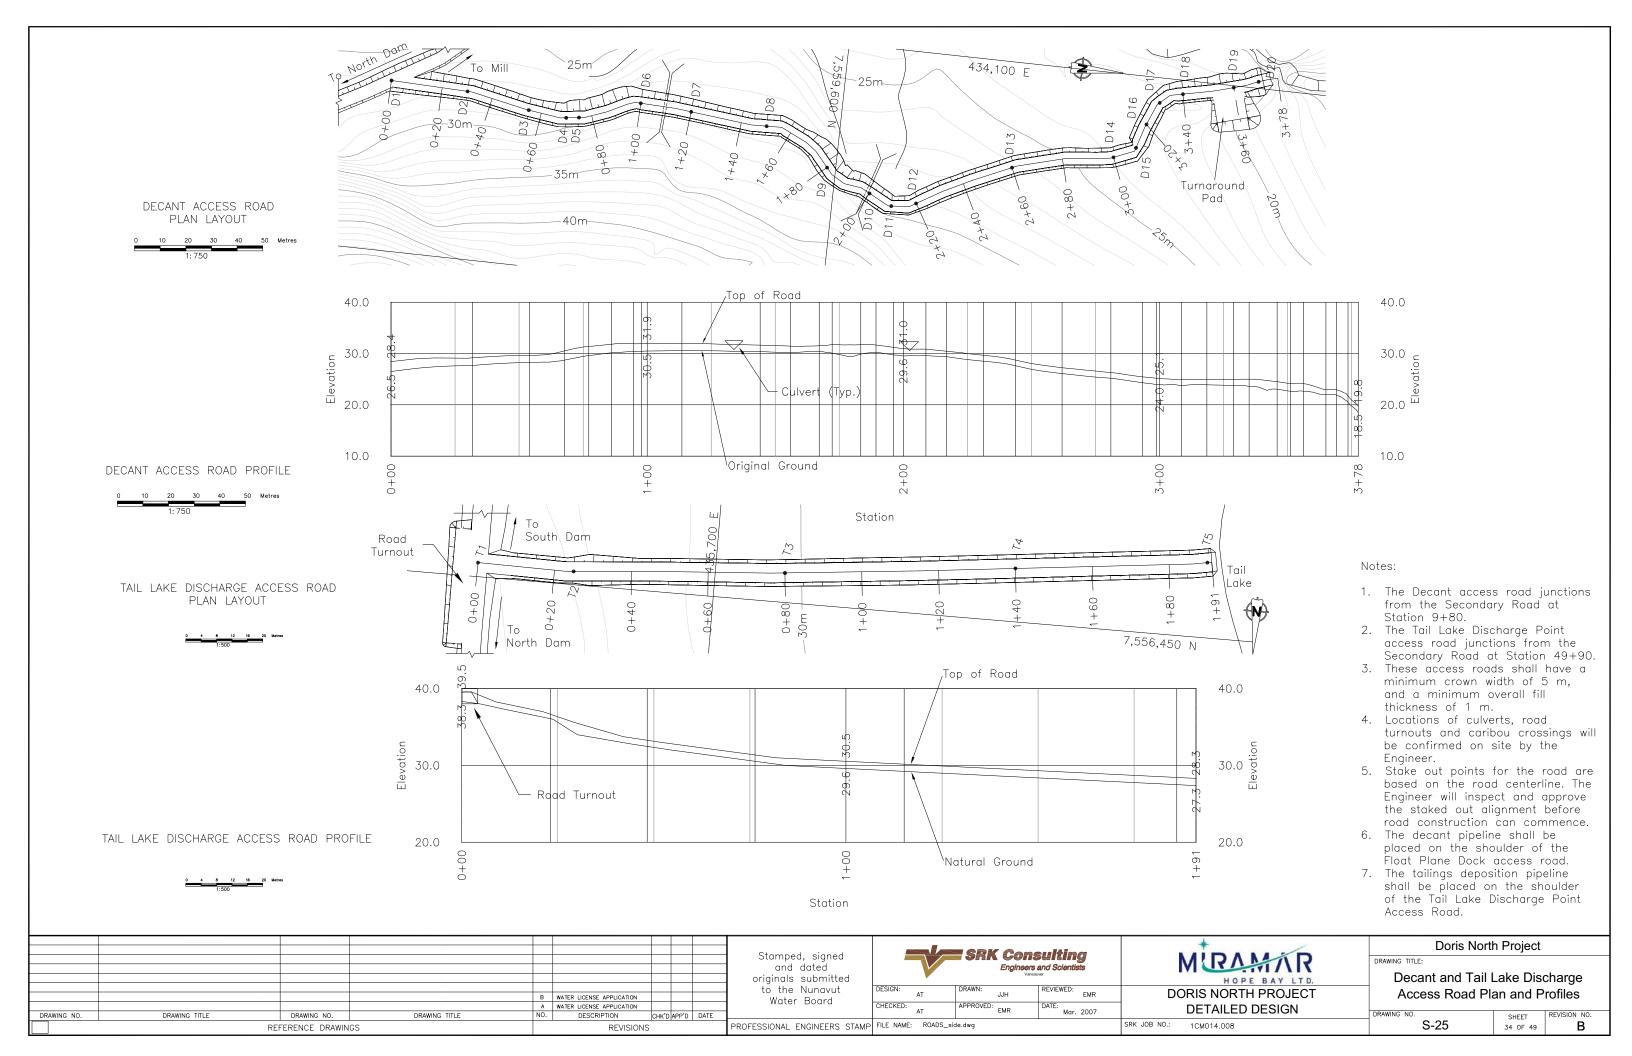

STAKE OUT TABLE								
Explos	Explosive Facility Access Road							
Point	Easting	Northing						
E1	432570.9	7559602.5						
E2	432521.6	7559594.2						
E3	432472.5	7559586.5						
E4	432428.2	7559563.7						
E5	432404.0	7559532.0						
E6	432375.3	7559504.5						
E7	432336.1	7559485.9						
E8	432305.5	7559481.4						

STAKE OUT TABLE							
Explosive Facility Access Road							
Point	Easting Northing						
L1	432787.4 7559287.6						
L2	432668.1 7559210						

STAKE OUT TABLE							
Car	np Pad Acce	ss Road					
Point	Easting	Northing					
C1	432787.3	7559287.4					
C2	432802.4	7559229.4					
С3	432821.6	7559090.7					
C4	432834.2	7559042.4					
C5	432853.5	7559007.4 7558983.4					
C6	432885.3						
C7	432924.0	7558974.1					
C8	432961.5	7558987.8					
C9	432995.3	7559008.9					
C10	433030.3	7559044.4					
C11	433053.9	7559085.0					

STAKE OUT TABLE								
Fuel Tank Farm Access Road								
Point Easting Northing								
F1	432785.3	7559289.8						
F2	432827.8	7559247.5						
F3	432870.3	7559205.2						
F4	432879.1	7559200.6						
F5	432918.7	7559196.1						


	STAKE OUT T	ADIE						
STAKE OUT TABLE								
	ecant Access							
Point	Easting	Northing						
D1	434133.5	7559423.9						
D2	434134.5	7559453.9						
D3	434139.2	7559478.4						
D4	434140.6	7559493.3						
D5	434140.0	7559498.2						
D6	434131.9	7559521.6						
D7	434133.0	7559541.6						
D8	434135.4	7559571.4						
D9	434148.9	7559596.6						
D10	434157.2	7559614.2						
D11	434161.2	7559623.1						
D12	434159.1	7559632.7						
D13	434141.1	7559668.4						
D14	434132.9	7559707.4						
D15	434128.2	7559715.7						
D16	434118.7	7559718.7						
D17	434109.7	7559723.0						
D18	434105.4	7559731.6						
D19	434100.7	7559751.1						
D20	434097.4	7559760.5						


STAKE OUT TABLE							
Decant Point Access Road							
Point Easting Northing							
T1	435761.8	7556446.3					
T2	435736.8	7556446.5					
Т3	435681.9	7556442.3					
T4	435622.2	7556436.1					
T5	435572.6	7556430.4					

STAKE OUT TABLE						
F	Portal Access					
Point	Easting	Northing				
P1	432957.6	7558912.5				
P2	433004.1	7558894.3				
Р3	433019.0	7558892.8				
P4	433044.0	7558892.7				
P5	433093.6	7558898.7				
P6	433152.2	7558911.1				
P7	433199.6	7558926.9				
P8	433216.3	7558937.9				
P9	433230.6	7558951.9				
P10	433251.0	7558973.9				
P11	433271.5	7558995.8				
P12	433288.4	7559006.2				
P13	433313.1	7559010.2				
P14	433348.0	7559009.0				
P15	433382.2	7559002.0				
P16	433392.2	7559002.2				
P17	433400.7	7559006.5				
P18	433405.1	7559015.3				
P19	433407.1	7559025.1				


	STAKE OUT T	ABLE
Float F	Plane Dock A	ccess Road
Point	Easting	Northing
A1	433308.8	7559079.1
A2	433314.9	7559071.1
А3	433360.4	7559005.6
A4	433379.4	7558970.5
A5	433397.1	7558913.2
A6	433413.2	7558850.2
A7	433426.9	7558807.3
A8	433474.4	7558732.0
A9	433504.3	7558713.9
A10	433528.0	7558705.8

	STAKE OUT T	ABLE
Sp	oillway Access	s Road
Point	Easting	Northing
SW1	434308.9	7559273.1
SW2	434317.9	7559265.2
SW3	434338.1	7559255.0
SW4	434362.1	7559236.5

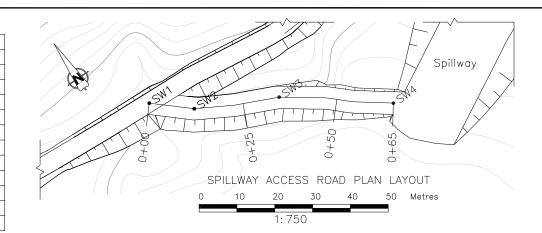

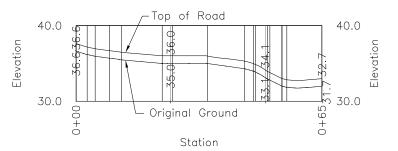

SPILLWAY ACCESS ROAD PROFILE 50 Metres 1: 750

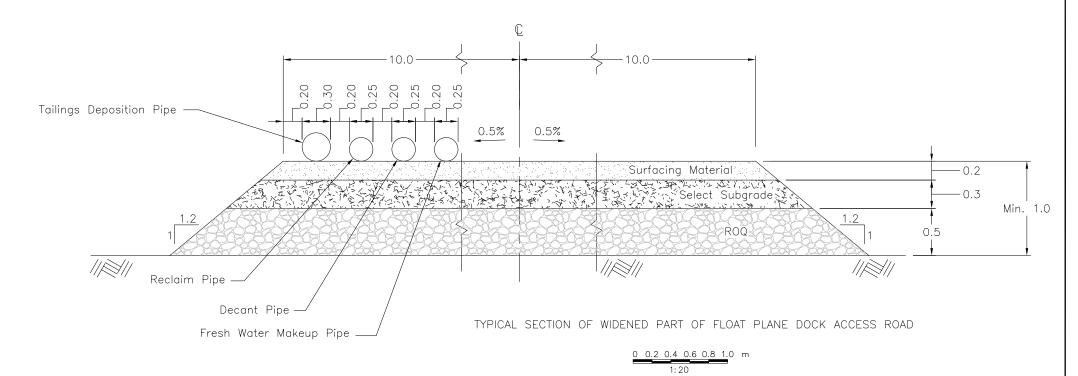

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									and dated			
									originals submitted			
									to the Nunavut	DESIGN:		DRAWN:
				В	WATER LICENSE APPLICATION				Water Board		AT	
				A	WATER LICENCE APPLICATION				I water Beard	CHECKED:	A.T.	APPROVE
DRAWING NO.	DRAWING TITLE	DRAWING NO.	DRAWING TITLE	NO.	DESCRIPTION	CHK'D A	PP'D	DATE]		AI	
	RE	FERENCE DRAWIN	GS		REVISIONS	5			PROFESSIONAL ENGINEERS STAMP	FILE NAME:	: ROADS_s	side.dwg





SRK JOB NO.: 1CM014.008

	Doris North Project
DRAWING TITLE:	


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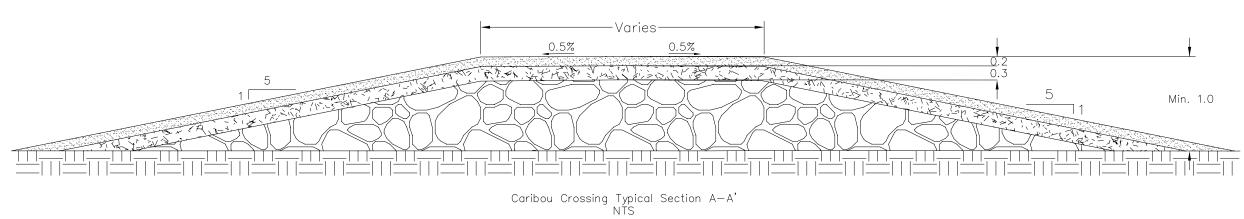
Natural ground

Surfacing material Select Subgrade Run of quarry Drainage gravel

Spillway Access Road Plan and Profile
and all Access Road Stake Out Points

S-26	SHEET 35 OF 49	REVISION NO.



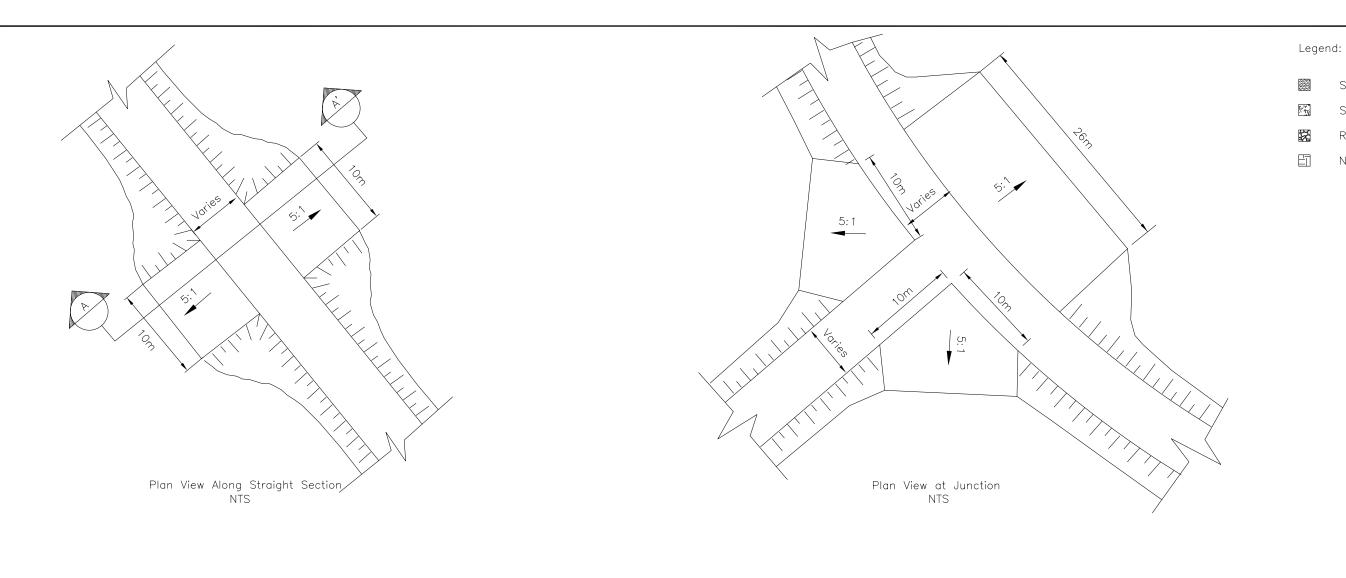


Notes

 The final locations for the Caribou crossings shall be confirmed on site after consultation with the local landowner and Elders.


Surfacing Material
Select Subgrade
Run of Quarry
Natural Ground


Caribou crossing dimensions are approximate and shall be site fitted to match each individual location.

							Stamped signed	mles ear co	nsultina	+	Doris Nor	th Project
							Stamped, signed and dated originals submitted		ers and Scientists Vancouver	MIRAMIN R	DRAWING TITLE: Caribou Cros	ssing Typical
					WATER LICENSE APPLICATION WATER LICENSE APPLICATION		to the Nunavut Water Board	DESIGN: AT DRAWN: JJH CHECKED: _ APPROVED:	REVIEWED: EMR	DORIS NORTH PROJECT DETAILED DESIGN	Plan and	
DRAWING NO.	DRAWING TITLE	DRAWING NO.	DRAWING TITLE	NO.	DESCRIPTION REVISIONS	CHK'D APP'D DATE	PROFESSIONAL ENGINEERS STAMF	AI EMR	Mar. 2007	SRK JOB NO.: 1CM014.008	DRAWING NO. S-10	SHEET REVISION NO. 18 OF 49 B

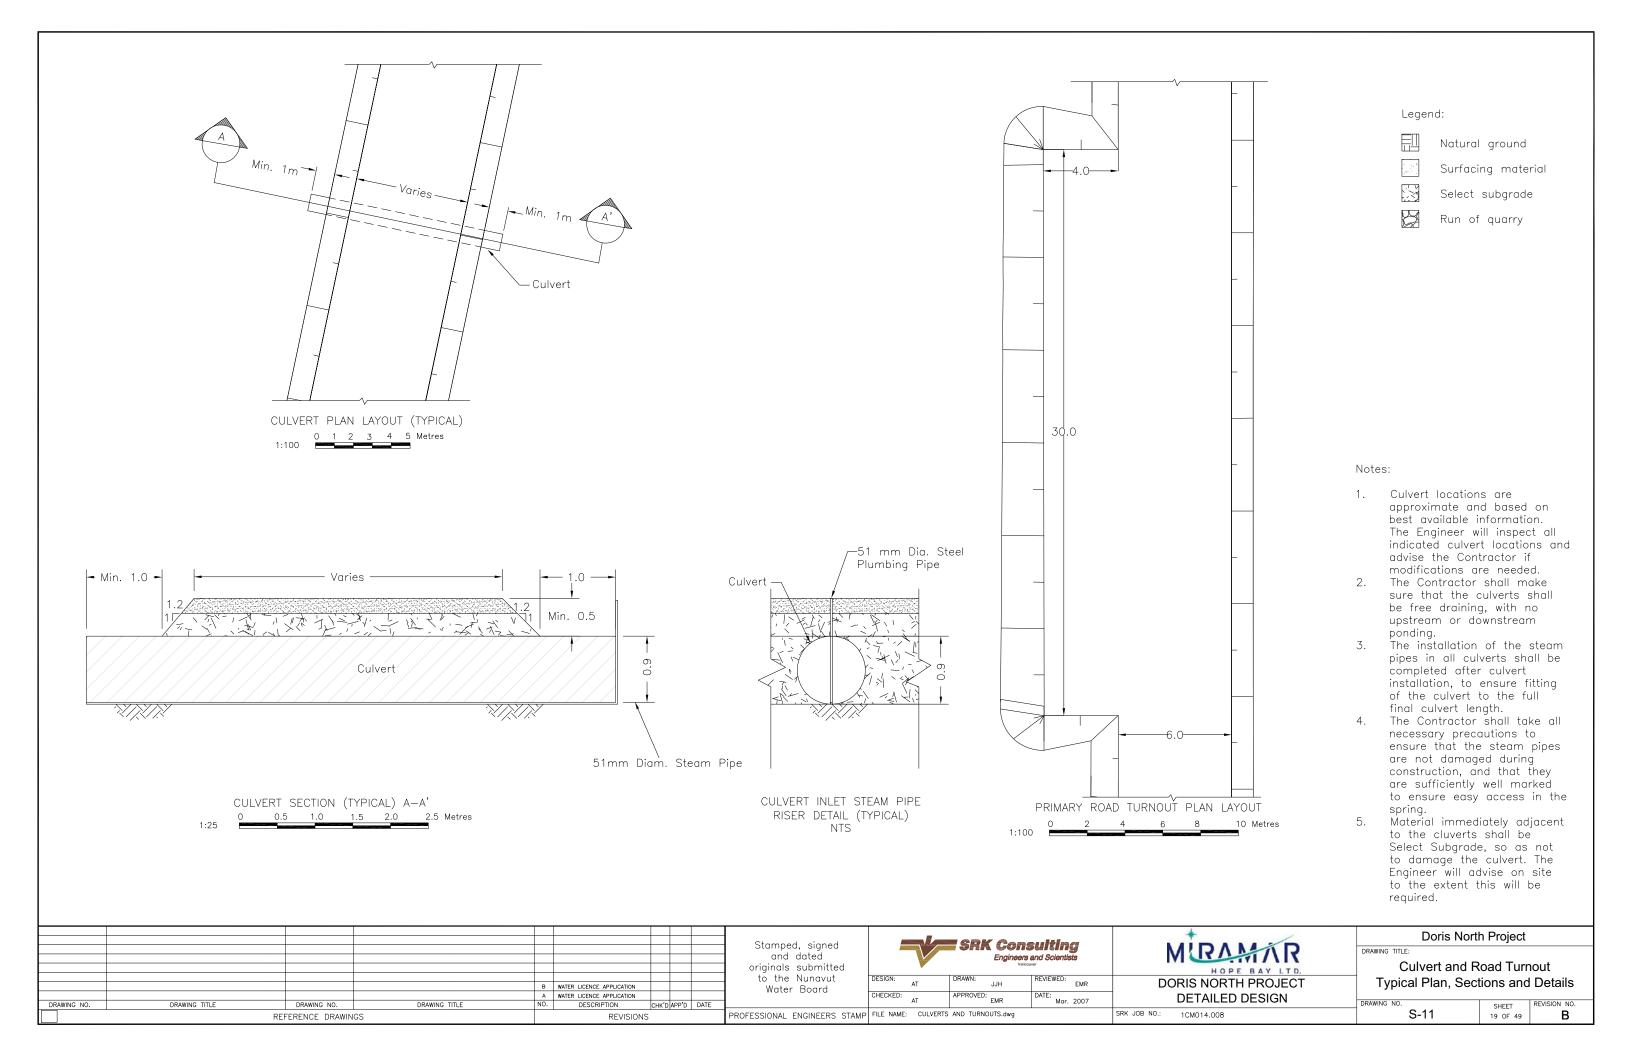

2b Issued for Construction

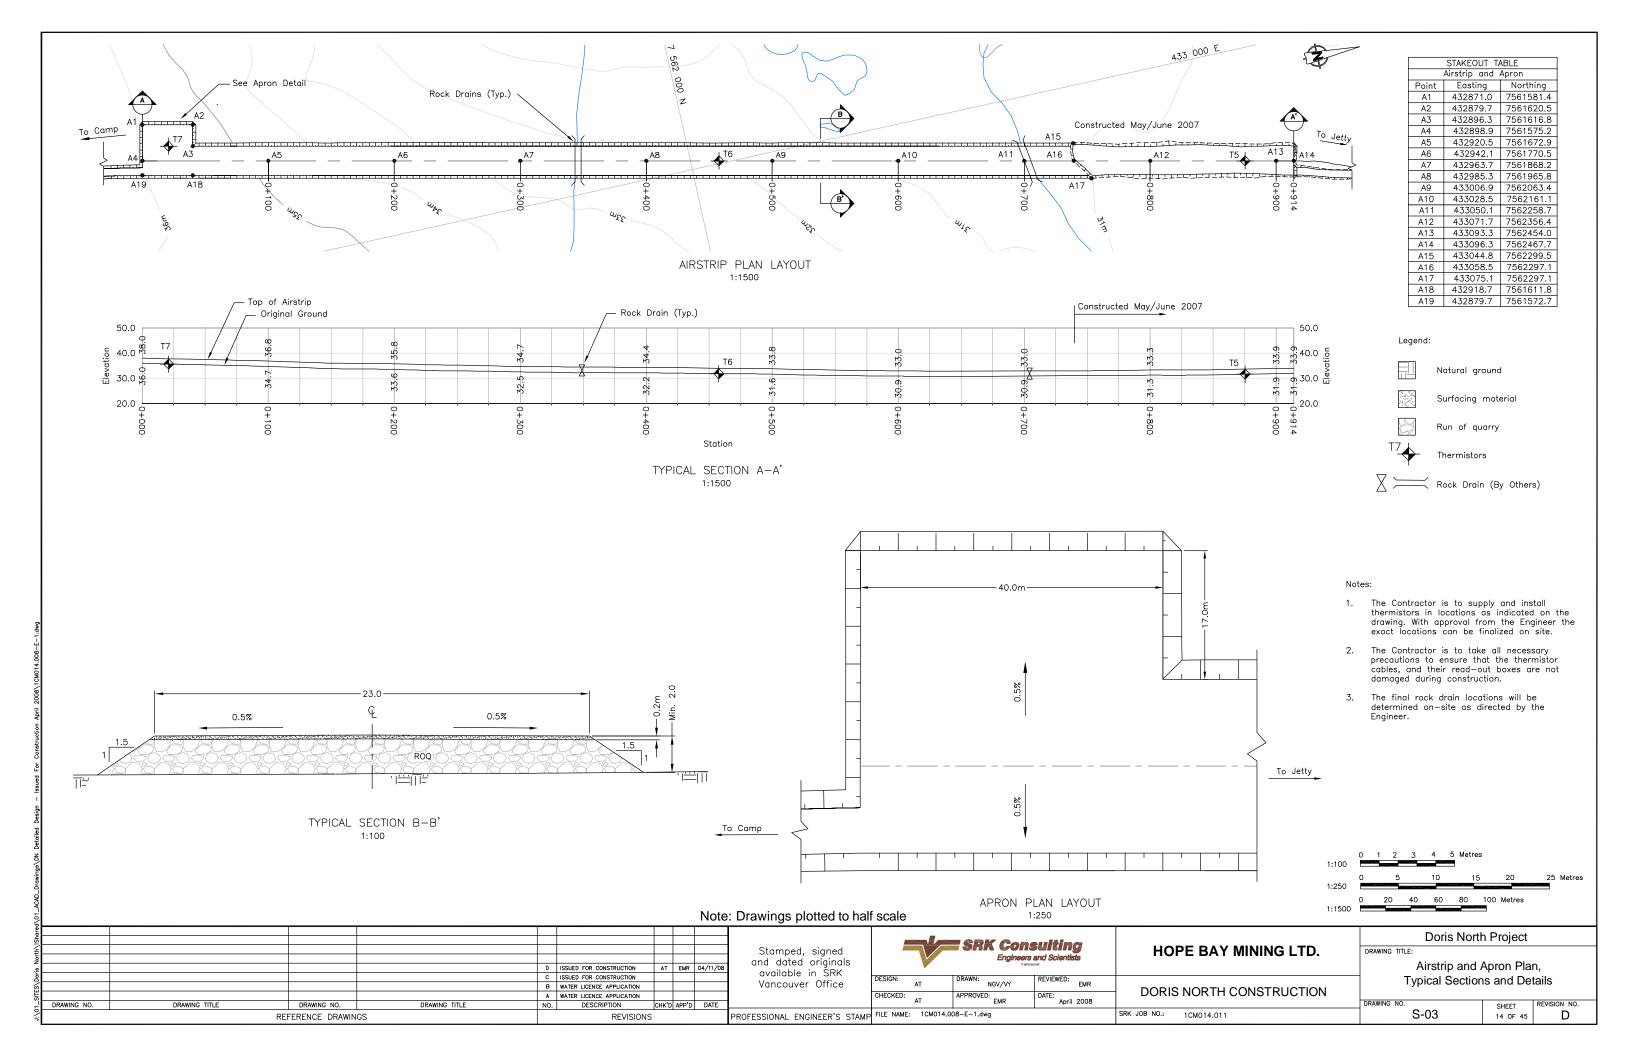

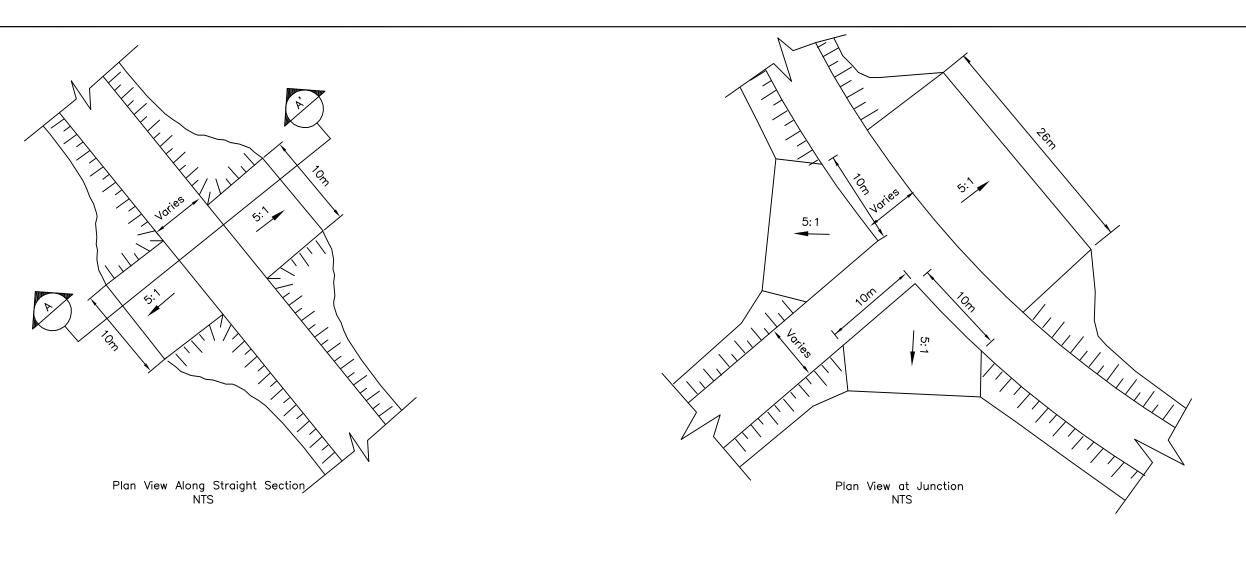

-Varies-

Caribou Crossing Typical Section A—A'

0.5%

Legend:

- Surfacing Material
- Select Subgrade
- Run of Quarry
- Natural Ground


Notes:


Min. 1.0


- The final locations for the Caribou crossings shall be confirmed on site after consultation with the local landowner and Elders.
 Caribou crossing dimensions are approximate and shall be site fitted to match each individual location.


O1_ACAD															to match each indi	vidual loc	cation.
Shared										SRK Consulting				*	Doris North Project		
North									1	Engineers and Scientists Variouser DESIGN: AT DRAWN: JJH REVIEWED: EMR				MIRAMAR	Caribou Crossing Typical Plan and Sections DRAWING NO. SHEET REVISION NO.		miaal
Poris						CONSTRUCTION							REVIEWED:	DORIS NORTH PROJECT			
SITES				DOMESTIC TOTAL		WATER LICENSE APPLICATION WATER LICENSE APPLICATION			1	CHECKED: DATE:		DATE: May 2007	DETAILED DESIGN				
DRAWING	DRAWING NO. DRAWING TITLE DRAWING NO. DRAWING TITLE					NO. DESCRIPTION CHK'D APP'D DATE REVISIONS			PROFESSIONAL ENGINEERS STAMP					SRK JOB NO.: 1CM014.011	DRAWING NO. SHEET F		C C
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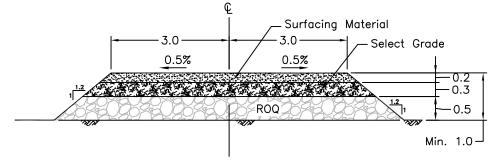
0.2 0.3



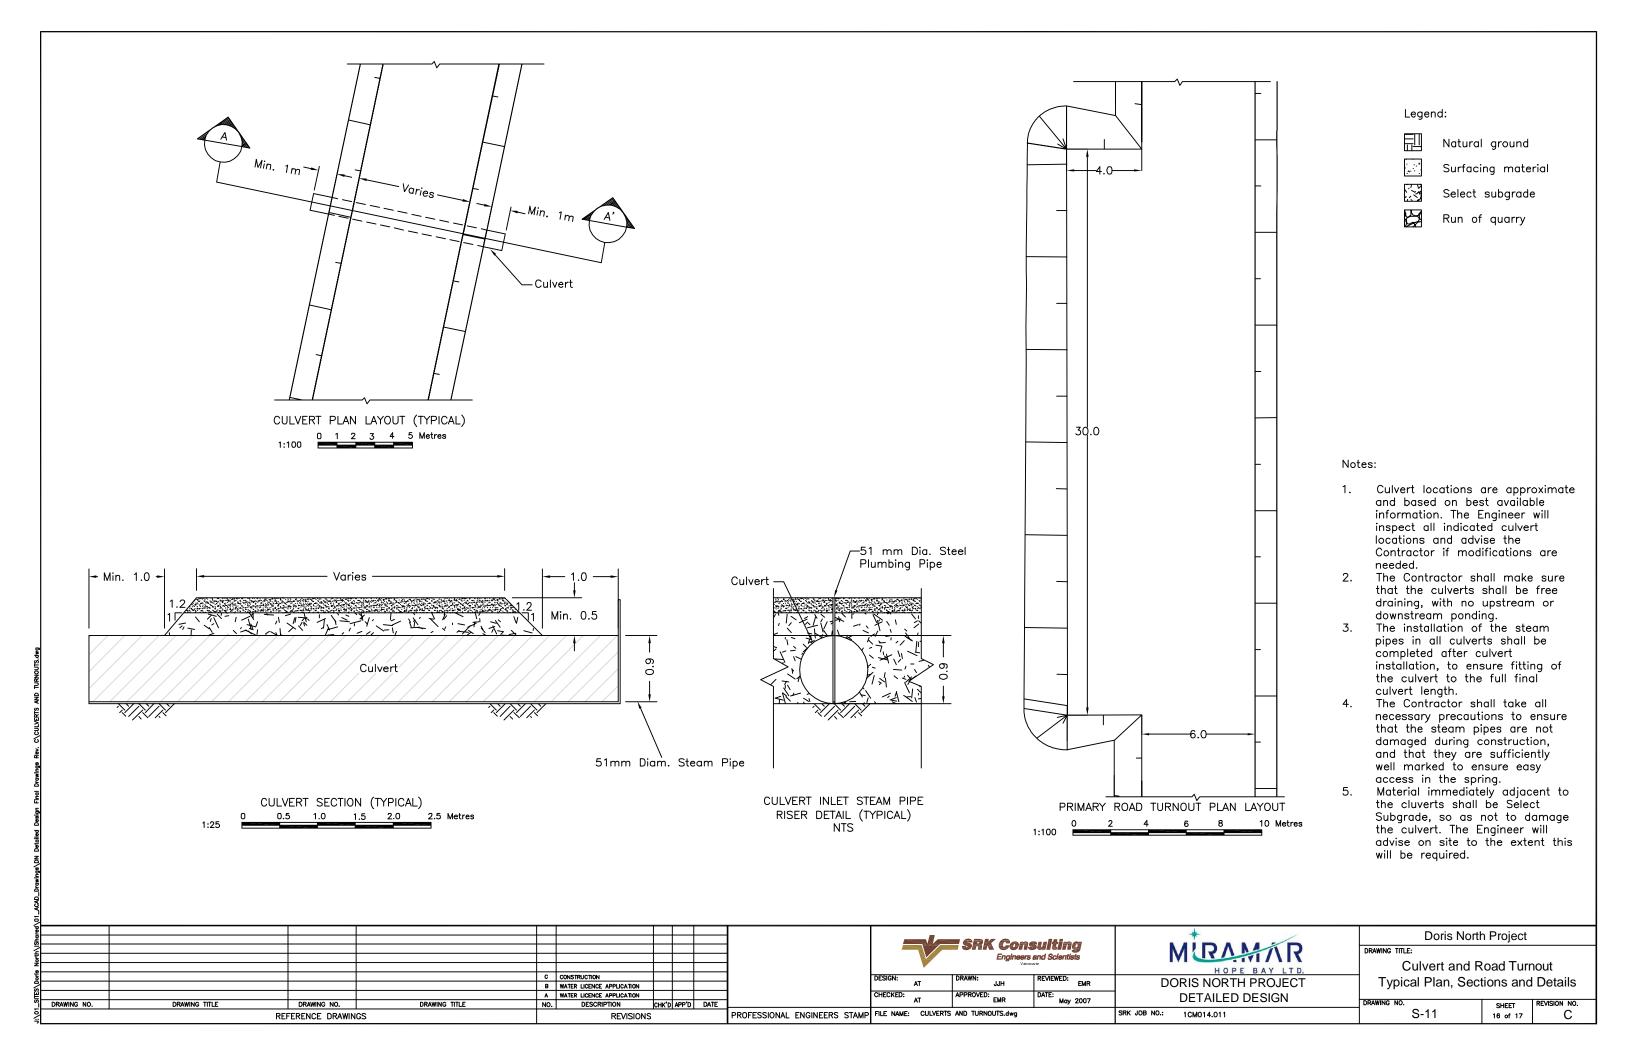

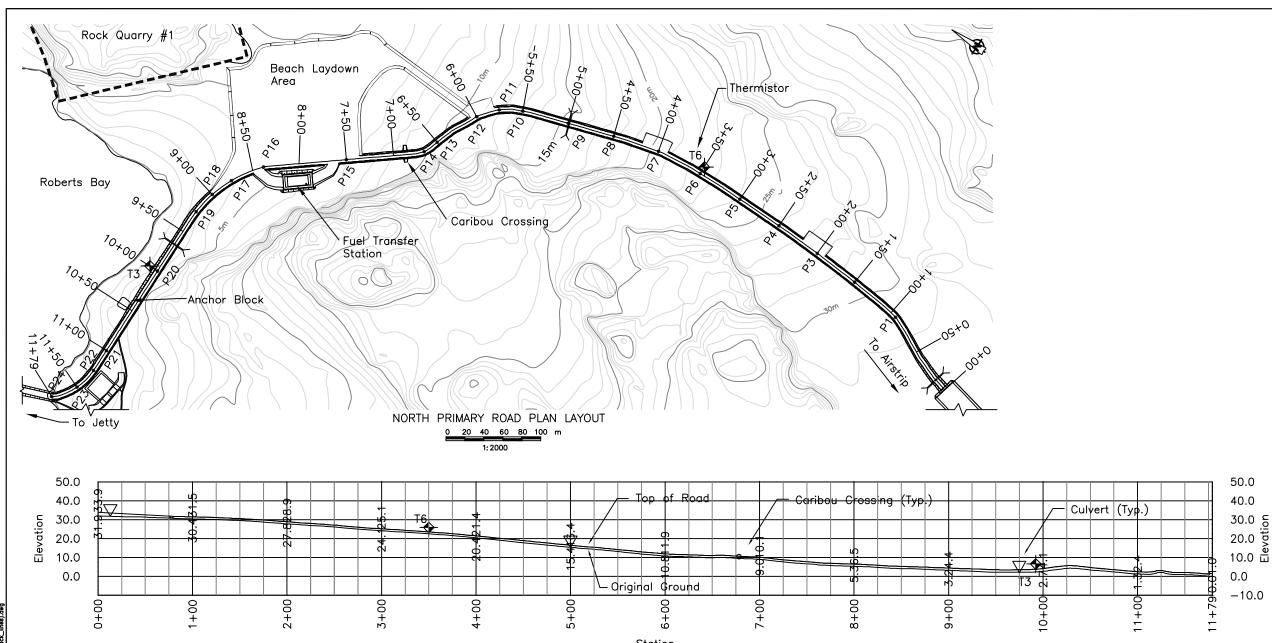

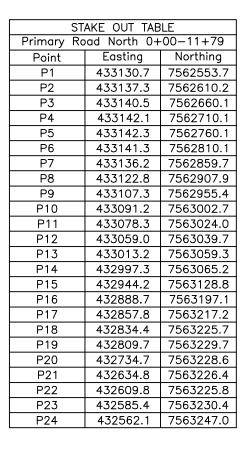

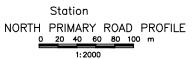

NORTH AND SOUTH PRIMARY ROAD TYPICAL SECTION 0 20 40 60 80 100 m

Legend:

Thermistors


Natural ground

Surfacing material Select Subgrade

Run of quarry

Notes:

- 1. The north primary road stretches from the Jetty to the northern end of the airstrip.
- 2. The primary road shall have a minimum crown width of 6 m, and a minimum overall fill thickness of 1 m.
- 3. Locations of culverts, road turnouts and caribou crossings will be confirmed on site by the Engineer.
- 4. Stake out points for the road are based on the road centerline. The Engineer will inspect and approve the staked out alignment before road construction can commence.
- 5. Stake out points are listed on drawing S-21.

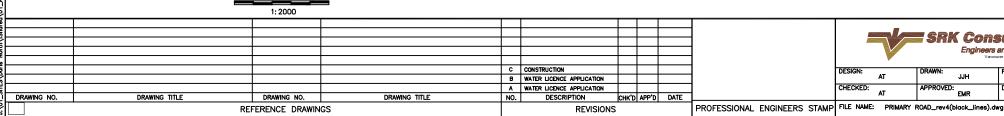


SRK Consulting REVIEWED: EMR


MIRAMINR **DORIS NORTH PROJECT DETAILED DESIGN** SRK JOB NO.: 1CM014.011


Doris North Project North Primary Road Plan and Profile (Station 00+00 - 11+79) and **Typical Section** S-15

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С



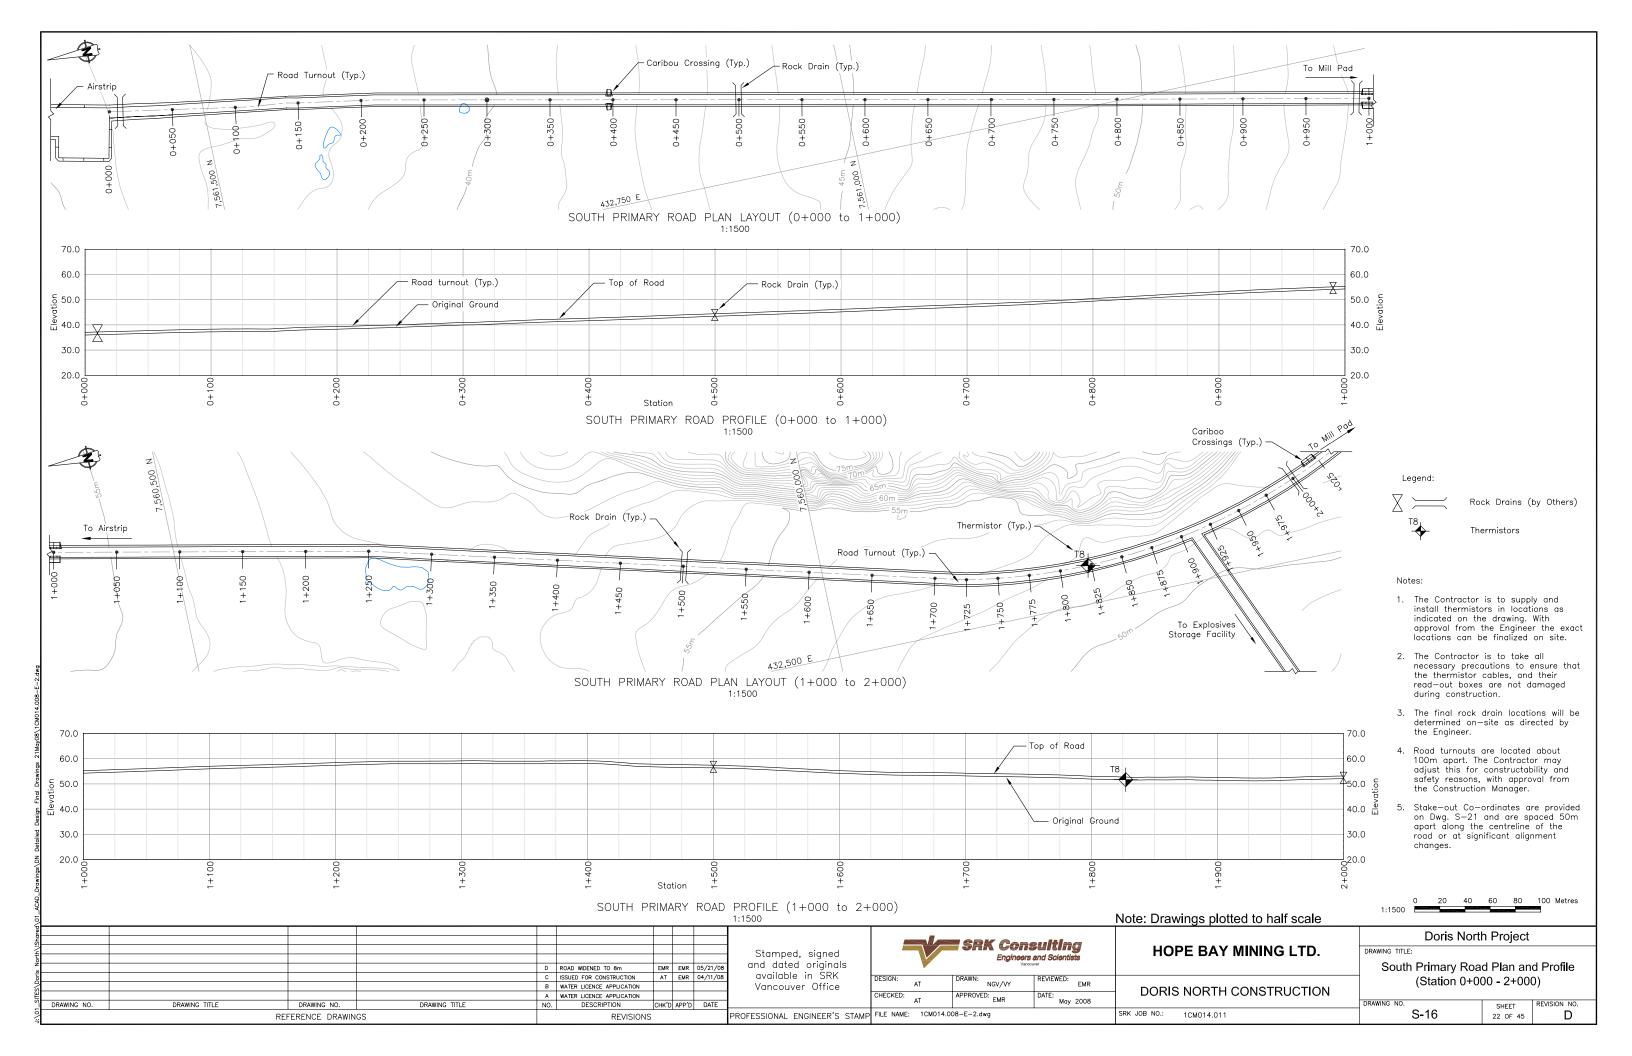

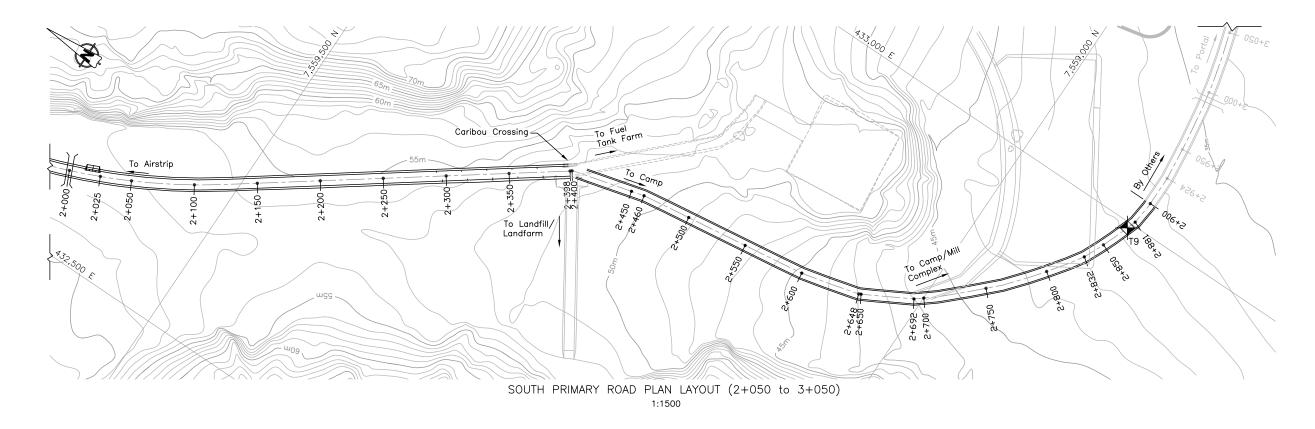

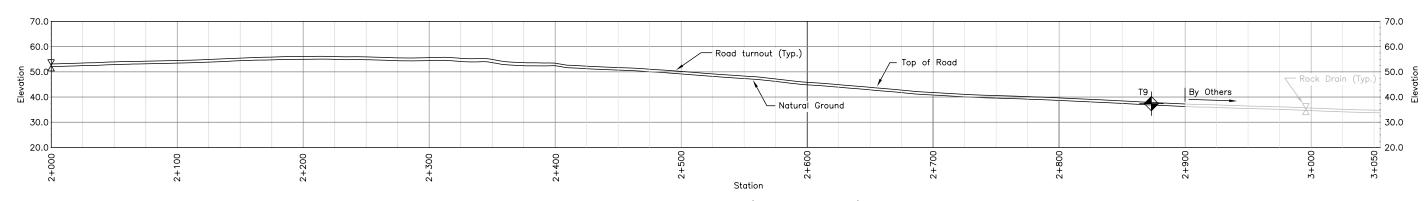SOUTH PRIMARY ROAD PROFILE (2+050 to 3+050) 1:1500

- 1. The Contractor is to supply and install thermistors in locations as indicated on the drawing. With approval from the Engineer the exact locations can be finalized on site.
- 2. The Contractor is to take all necessary precautions to ensure that the thermistor cables, and their read-out boxes are not damaged during construction.
- 3. The final rock drain locations will be determined on—site as directed by the Engineer.
- 4. Road turnouts are located about 100m apart. The Contractor may adjust this for constructability and safety reasons, with approval from the Construction Manager.
- Stake—out Co—ordinates are provided on Dwg. S—21 and are spaced 50m apart along the centreline of the road or at significant alignment changes.

Legend:

Rock Drains (by Others)

Thermistors

Note: Drawings plotted to half scale 1:1500




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ŧ										and dated originals	
z					D	ROAD WIDENED TO 8m	EMR	EMR	05/21/08		
Š					С	ISSUED FOR CONSTRUCTION	AT	EMR	04/11/08	available in SRK	D
2					В	WATER LICENCE APPLICATION				Vancouver Office	
Ĕ					Α	WATER LICENCE APPLICATION					c
v	DRAWING NO.	DRAWING TITLE	DRAWING NO.	DRAWING TITLE	NO.	DESCRIPTION	CHK'D	APP'D	DATE		
5		RE	FERENCE DRAWIN	GS		REVISIONS				PROFESSIONAL ENGINEER'S STAMP	F

SRK Consulting Engineers and Scientists						
DESIGN: AT	DRAWN: NGV/VY	REVIEWED: EMR				
CHECKED: AT APPROVED: EMR DATE: May 2008						
FILE NAME: 1CM014.008-E-2.dwg						

HOPE BAY MINING LTD. DORIS NORTH CONSTRUCTION SRK JOB NO.: 1CM014.011

Doris North Project South Primary Road Plan and Profile (Station 2+000 - 3+337) SHEET

S-17 23 OF 45

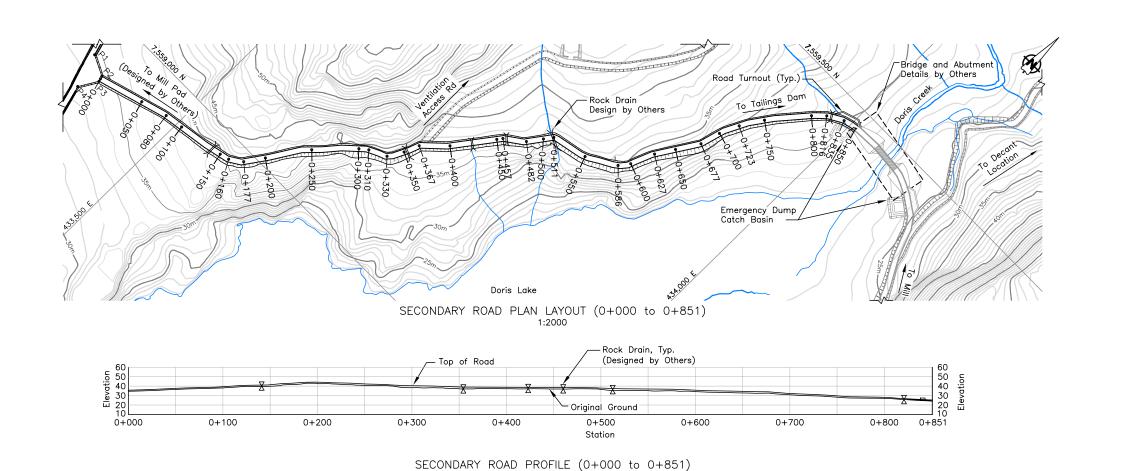

Stamped, signed

and dated

originals submitted

to the Nunavut

Water Board

C ISSUE FOR CONSTRUCTION

DRAWING TITLE

DRAWING NO.

DRAWING TITLE

REFERENCE DRAWINGS

B WATER LICENSE APPLICATION
A WATER LICENSE APPLICATION

DESCRIPTION

REVISIONS

AT EMR 04/11/08

STAKE OUT TABLE							
Secondary Road Tie-in Pad							
Point	Easting	Northing					
P1	433,387.0	7,558,955.1					
P2	433,408.5	7,558,944.6					
P3	433,410.2	7,558,938.8					
P4	433,398.4	7,558,918.7					

Legend:

Rock Drains (by Others)



Road Turnout

Notes:

- Locations of culverts, road turnouts, caribou crossings and Emergency Dump Catch Basins will be confirmed on site by the Engineer.
- Stake out points for the road are based on the road centerline. The Engineer will inspect and approve the staked out alignment before road
- Bridge and Abutment designed by Others will be tie—into Secondary road. All Road change must be approved by the Engineer prior to Construction.
- The Secondary Road links to the Float Plane Access Road at chainage 0+076.

Note: Drawings plotted to half scale

1:2000 **Doris North Project** Secondary Road Plan and Profile (Station 0+000 - 0+851)

S-18

150

SHEET

23 OF 45

200 Metres

SRK Consulting
Engineers and Scientists
Varxouver EMR

DORIS NORTH CONSTRUCTION

HOPE BAY MINING LTD. : April 2008 PROFESSIONAL ENGINEER'S STAMP FILE NAME: S-18_21_Secondary Road.dwg SRK JOB NO.: 1CM014.011

	STAKE OUT TAB	
South F	Primary Road 0+0	
Point	Easting	Northing
0+000	432907.1	7561573.4
0+050	432898.5	7561524.2
0+100	432889.8	7561474.9
0+150	432882.9	7561425.5
0+200	432874.5	7561376.2
0+250	432864.6	7561327.2
0+300	432854.3	7561278.3
0+350	432844.0	7561229.3
0+400	432833.6	7561180.4
0+450	432823.3	7561131.5
0+500	432813.0	7561082.6
0+550	432802.7	7561033.6
0+600	432792.3	7560984.7
0+650	432782.0	7560935.8
0+700	432771.7	7560886.9
0+750	432761.4	7560837.9
0+800	432751.2	7560789.0
0+850	432741.0	7560740.0
0+830	432730.9	7560691.1
0+950	432720.7	7560642.1
1+000		7560593.2
1+050	432710.5 432700.3	7560593.2
1+100	432690.1	7560495.3
1+150	432680.0	7560446.3
1+200	432669.8	7560397.4
1+250	432659.6	7560348.4
1+300	432646.9	7560300.1
1+350	432634.3	7560251.7
1+400	432621.6	7560203.3
1+450	432608.9	7560155.0
1+500	432596.2	7560106.6
1+550	432583.5	7560058.2
1+600	432570.9	7560009.9
1+650	432558.2	7559961.5
1+700	432545.5	7559913.1
1+725	432539.2	7559888.9
1+750	432535.1	7559864.3
1+775	432532.3	7559839.4
1+800	432530.7	7559814.5
1+825	432530.4	7559789.5
1+850	432531.5	7559764.5
1+875	432533.7	7559739.6
1+900	432537.3	7559714.9
1+925	432542.2	7559690.4
1+950	432548.2	7559666.1
1+975	432555.5	7559642.2
2+000	432564.2	7559618.8

	STAKE OUT TABLE					
South P		000-3+337				
Point	Easting	Northing				
2+000	432564.2	7559618.8				
2+025	432573.9	7559595.7				
2+050	432584.9	7559573.3				
2+100	432610.1	7559530.1				
2+150	432639.1	7559489.4				
2+200	432668.6	7559449.1				
2+250	432698.1	7559408.7				
2+300	432727.7	7559368.4				
2+350	432757.2	7559328.1				
2+398	432785.8	7559289.0				
2+400	432786.9	7559287.8				
2+450	432799.8	7559239.6				
2+460	432802.4	7559229.4				
2+500	432807.9	7559190.3				
2+550	432814.6	7559140.7				
2+600	432821.5	7559091.2				
2+648	432833.1	7559044.5				
2+650	432834.0	7559042.9				
2+692	432854.3	7559006.0				
2+700	432859.2	7558999.9				
2+750	432893.3	7558963.3				
2+800	432931.2	7558930.8				
2+832	432957.6	7558912.5				
2+850	432973.9	7558905.2				
2+881	433003.0	7558894.4				
2+900	433021.9	7558892.7				
2+924	433045.9	7558892.7				
2+950	433071.7	7558895.6				
3+000	433121.1	7558903.5				
3+050	433169.4	7558916.3				
3+083	433200.7	7558927.3				
3+100	433214.6	7558936.7				
3+150	433249.6	7558972.4				
3+184	433273.1	7558997.4				
3+200	433286.5	7559005.4				
3+201	433287.6	7559006.1				
3+225	433313.1	7559010.2				
3+250	433336.0	7559010.2				
3+255	433341.4	7559010.2				
3+295	433380.5	7559002.1				
3+300	433385.1	7559002.0				
3+306	433391.3	7559001.9				
3+314	433399.3	7559004.3				
3+324	433404.5	7559012.4				
3+337	433407.3	7559025.8				

	STAKE C	UT TABLE	
Se	condary Roa	8+0-000+0 b	51
Chainage	Easting	Northing	Elevation
0+000	433,409.4	7,558,941.7	35.7
0+050	433,457.3	7,558,955.9	37.6
0+080	433,485.9	7,558,964.1	38.5
0+100	433,505.9	7,558,967.3	39.4
0+150	433,555.0	7,558,976.3	41.5
0+160	433,565.1	7,558,978.9	42.4
0+177	433,578.1	7,558,988.4	43.2
0+200	433,591.4	7,559,007.6	44.2
0+250	433,619.5	7,559,048.7	42.4
0+300	433,653.7	7,559,085.1	40.4
0+310	433,661.9	7,559,091.7	40.2
0+330	433,680.2	7,559,100.8	39.7
0+350	433,689.7	7,559,116.8	39.2
0+367	433,696.1	7,559,132.8	38.9
0+400	433,719.0	7,559,156.0	38.8
0+450	433,748.8	7,559,196.1	38.5
0+457	433,752.7	7,559,201.4	38.5
0+482	433,772.4	7,559,216.9	38.4
0+500	433,783.1	7,559,231.7	38.0
0+511	433,789.6	7,559,240.7	37.6
0+550	433,827.2	7,559,250.1	36.9
0+586	433,858.4	7,559,268.4	36.3
0+600	433,866.5	7,559,279.2	35.7
0+627	433,876.9	7,559,304.4	34.9
0+650	433,888.9	7,559,323.7	34.5
0+677	433,903.5	7,559,347.1	34.0
0+700	433,909.3	7,559,368.7	32.3
0+723	433,918.3	7,559,389.2	31.3
0+750	433,932.8	7,559,412.6	29.8
0+800	433,964.3	7,559,451.4	28.2
0+816	433,975.7	7,559,462.8	27.1
0+835	433,992.1	7,559,472.3	26.1
0+850	434,006.4	7,559,475.8	25.2
0+851	434,007.7	7,559,475.9	25.2

STAKE OUT TABLE						
Explosives Fac	cility Access Road	0+000-0+803				
Point	Easting	Northing				
0+000	432539.4	7559703.3				
0+050	432493.4	7559683.7				
0+100	432447.4	7559664.2				
0+150	432401.4	7559644.6				
0+200	432355.4	7559625.0				
0+236	432322.4	7559611.0				
0+250	432310.1	7559618.1				
0+300	432266.7	7559642.9				
0+350	432223.3	7559667.8				
0+400	432180.0	7559692.6				
0+450	432136.6	7559717.5				
0+500	432093.2	7559742.4				
0+575	432028.3	7559779.6				
0+550	432049.8	7559767.2				
0+600	432014.5	7559800.7				
0+650	431987.2	7559842.5				
0+675	431973.4	7559863.7				
0+700	431972.4	7559888.4				
0+750	431970.2	7559938.4				
0+800	431968.1	7559988.3				
0+803	431968.0	7559991.7				

STAKE OUT TABLE					
Float Plane	e Access Road 0	+000-0+362			
Point	Easting	Northing			
0+000	433360.4	7559005.6			
0+035	433378.0	7558974.8			
0+050	433382.1	7558960.8			
0+076	433389.5	7558935.7			
0+100	433397.1	7558913.1			
0+150	433409.5	7558864.7			
0+165	433413.2	7558850.2			
0+200	433423.9	7558816.8			
0+213	433427.9	7558804.4			
0+246	433442.0	7558775.0			
0+250	433444.4	7558771.4			
0+294	433469.7	7558734.9			
0+300	433474.5	7558732.0			
0+335	433504.3	7558713.9			
0+350	433518.6	7558709.0			
0+362	433529.9	7558705.1			

Note: Drawings plotted to half scale

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ı,	DRAWING NO.	DRAWING TITLE	DRAWING NO.	DRAWING TITLE	NO.	DESCRIPTION	CHK'D	APP'D	DATE	
J:\01		REFERENC	E DRAWINGS			REVISIONS	3			PROFES


Stamped, signed and dated originals submitted	FIX Consulting Engineers and Scientists					
to the Nunavut	DESIGN:	DRAWN:	REVIEWED:			
Water Board		JJH	EMR			
water board	CHECKED:	APPROVED:	DATE:			
	AT	EMR	April 2008			
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HOPE BAY MINING LTD. DORIS NORTH CONSTRUCTION


Doris North Project DRAWING TITLE:
South Primary, Secondary,
Float Plane and Explosive Access

SRK JOB NO.: 1CM014.008

SHEET REVISION NO.
26 OF 45

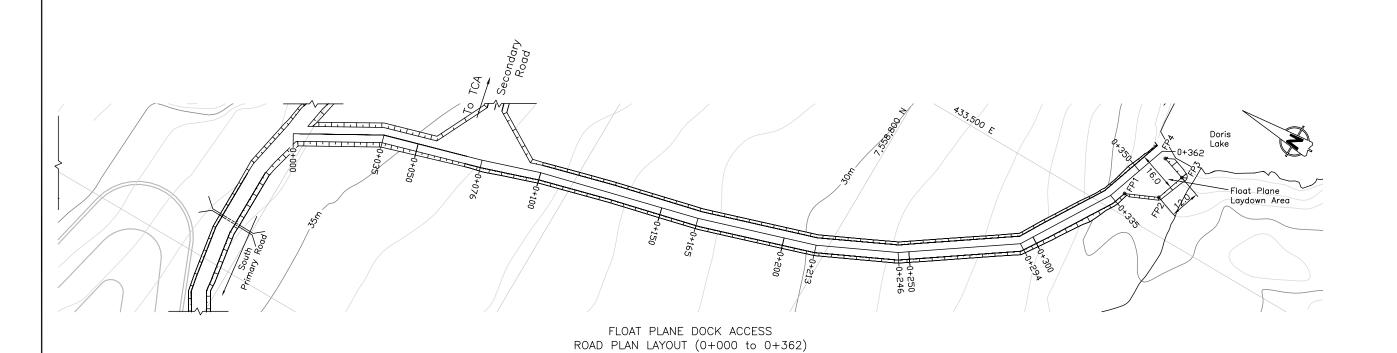

1:750

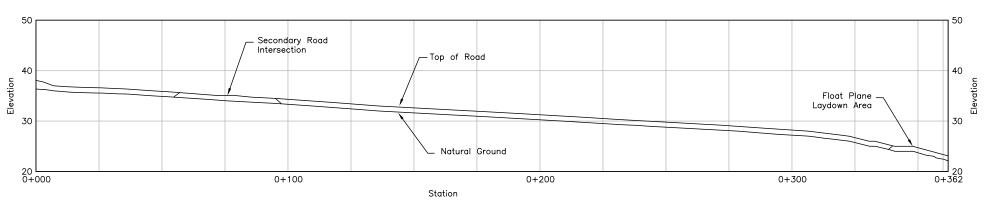

	FL	DAT PLAN	IE DOCK		
ACCESS	ROAD	PROFILE	(0+000)	to	0+362)
		1:750			

STAKE OUT TABLE							
Float Plane Laydown Area							
Point	Easting	Northing					
FP1	433,507.8	7,558,709.5					
FP2	433,513.4	7,558,697.0					
FP3	433,524.8	7,558,693.2					
FP4	433,528.0	7,558,702.6					

Notes:

- The final rock drain locations will be determined on—site as directed by the Engineer
- 2. The Float Plane Dock will be designed and installed by Other.
- The Float Plane Dock access road links to the South Primary Road at chainage 0+076.
- Stake—out co—ordinates are provided on Drawing S—21 and are spaced at 50m along the centerline of the road or signicant alignment changes.



Note: Drawings plotted to half scale

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- 81					Α	WATER LICENCE APPLICATION					CHECKED:	AT	APPROVED: EM
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5		REFERENCE DRAWINGS				REVISIONS				PROFESSIONAL ENGINEER'S STAMP	FILE NAME	: S-24_Ro	ads_side.dwg
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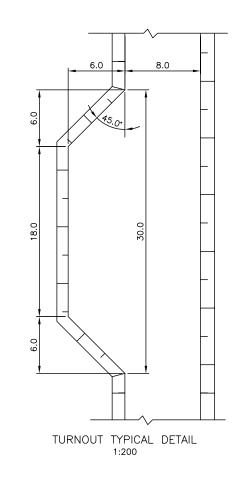
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DESIGN:	AT	DRAWN:	JJH	REVIEWED:	EMR		
CHECKED:	AT	APPROVED:	EMR	DATE: April	2008		


HOPE	BAY MII	NING LTD.
DORIS I	IORTH CO	NSTRUCTIO

SRK JOB NO.: 1CM014.008

Doris North Project
DRAWING TITLE:
Float Plane Dock and Portal Access

	Road Plan and Profile						
DRAWING NO.	S-24	SHEET 33 OF 49	REVISION NO.				



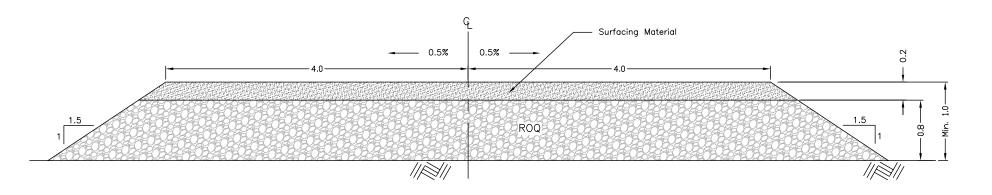

NORTH AND SOUTH PRIMARY ROAD TYPICAL SECTION

Legend:


Surfacing Material



ROQ Material (Run of Quarry)

Notes:

- Topographic contour data for the terrain model was provided by MHBL and is based on 2001 Aerial Photography and manual surveys at select locations. Contour interval is 1m.
- All drawings are scaled appropriately for D-size construction drawings. Scales may not be correct if these drawings are reproduced and presented in any other size format.
- 3. The design are based on the contour information shown on these drawings. It is howeer the Contractors responsibility to confirm that the contours are a fair reflection of the ground levels in the vicinity of the works, and to advise the Construction Manager and Engineer if otherwise otherwise.

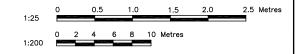

Note: Drawings plotted to half scale

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SITES\Doris					В	ROAD WIDENED TO 8m	EMR	EMR	05/21/08	1
Ë					Α	ISSUED FOR CONSTRUCTION	AT	EMR	04/11/08]
- 11	DRAWING NO.	DRAWING TITLE	DRAWING NO.	DRAWING TITLE	NO.	DESCRIPTION	CHK'D	APP'D	DATE	
J:\01	REFERENCE DRAWINGS					REVISIONS	;			PROF


Stamped, signed and dated originals available in SRK	SRK Consulting Engineers and Scientists Vancaurer						
Vancouver Office	DESIGN: AT	DRAWN: NV/VY	REVIEWED: EMR				
	CHECKED: AT	APPROVED: EMR	DATE: May 2008				
OFESSIONAL ENGINEER'S STAMP	FILE NAME: 1CM014.0	008-E-7.dwg					


HOPE BAY MINING LTD.


DORIS NORTH CONSTRUCTION SRK JOB NO.: 1CM014.011

Doris North Project South Primary Road and Road Turnout Typical Section and Detail


SHEET REVISION NO. S-27 В 32 OF 45

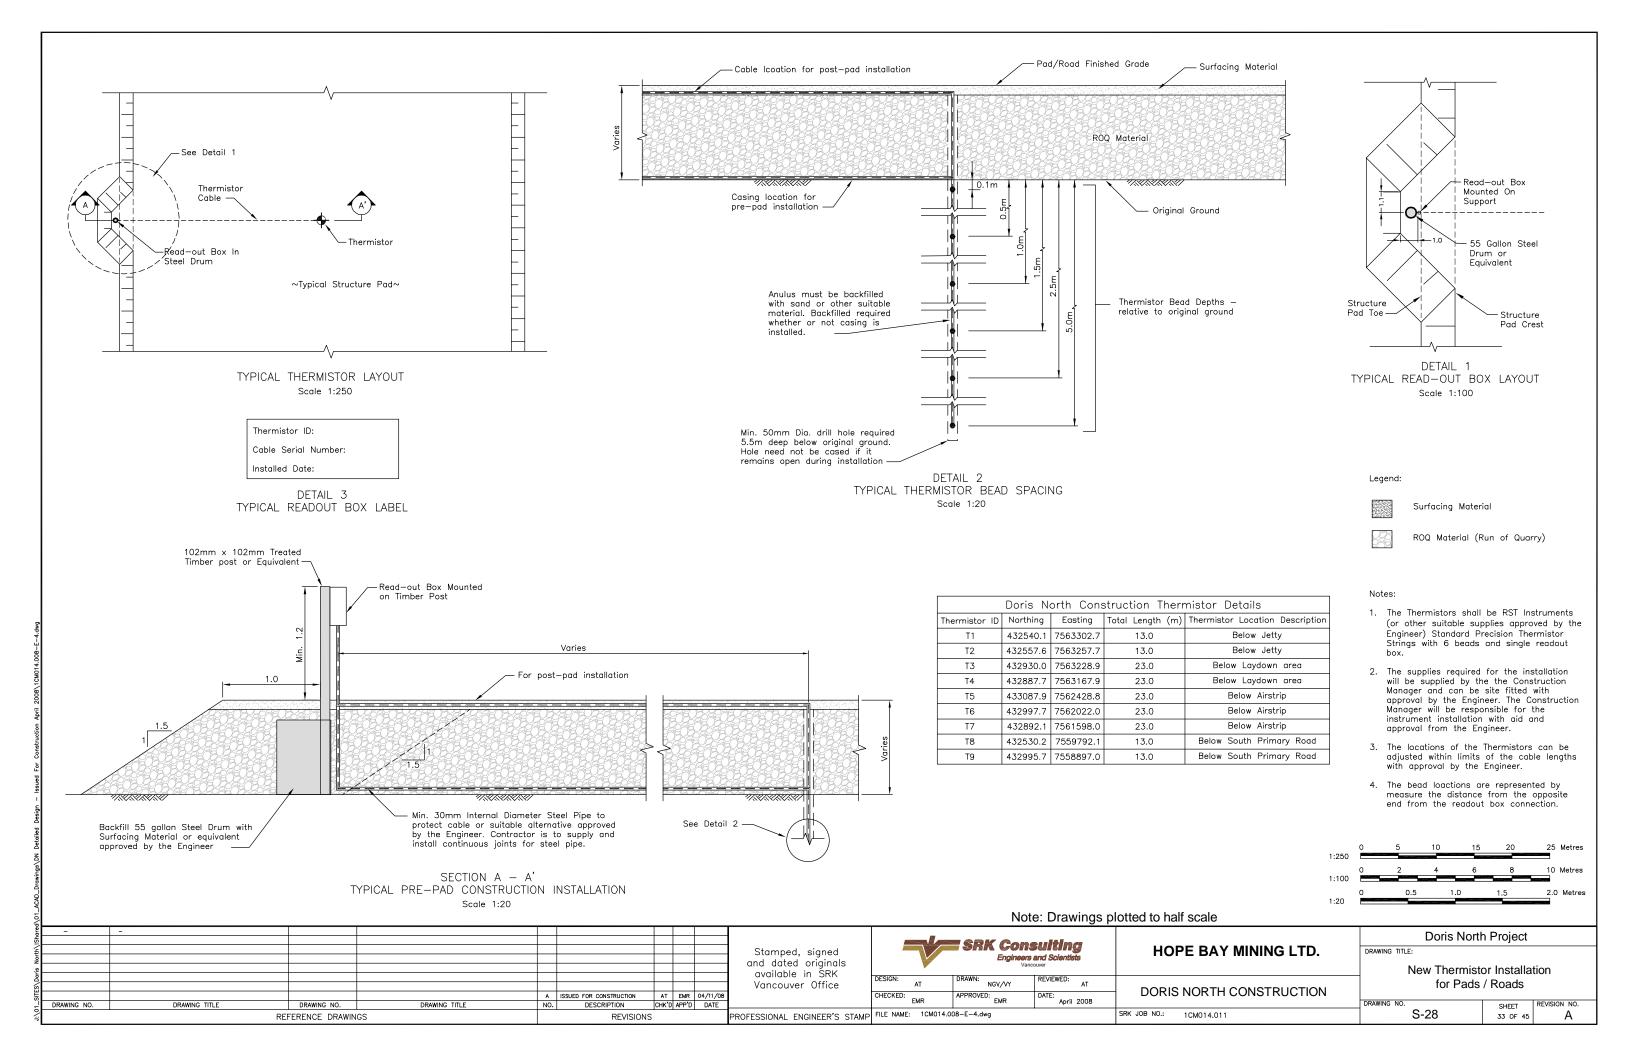


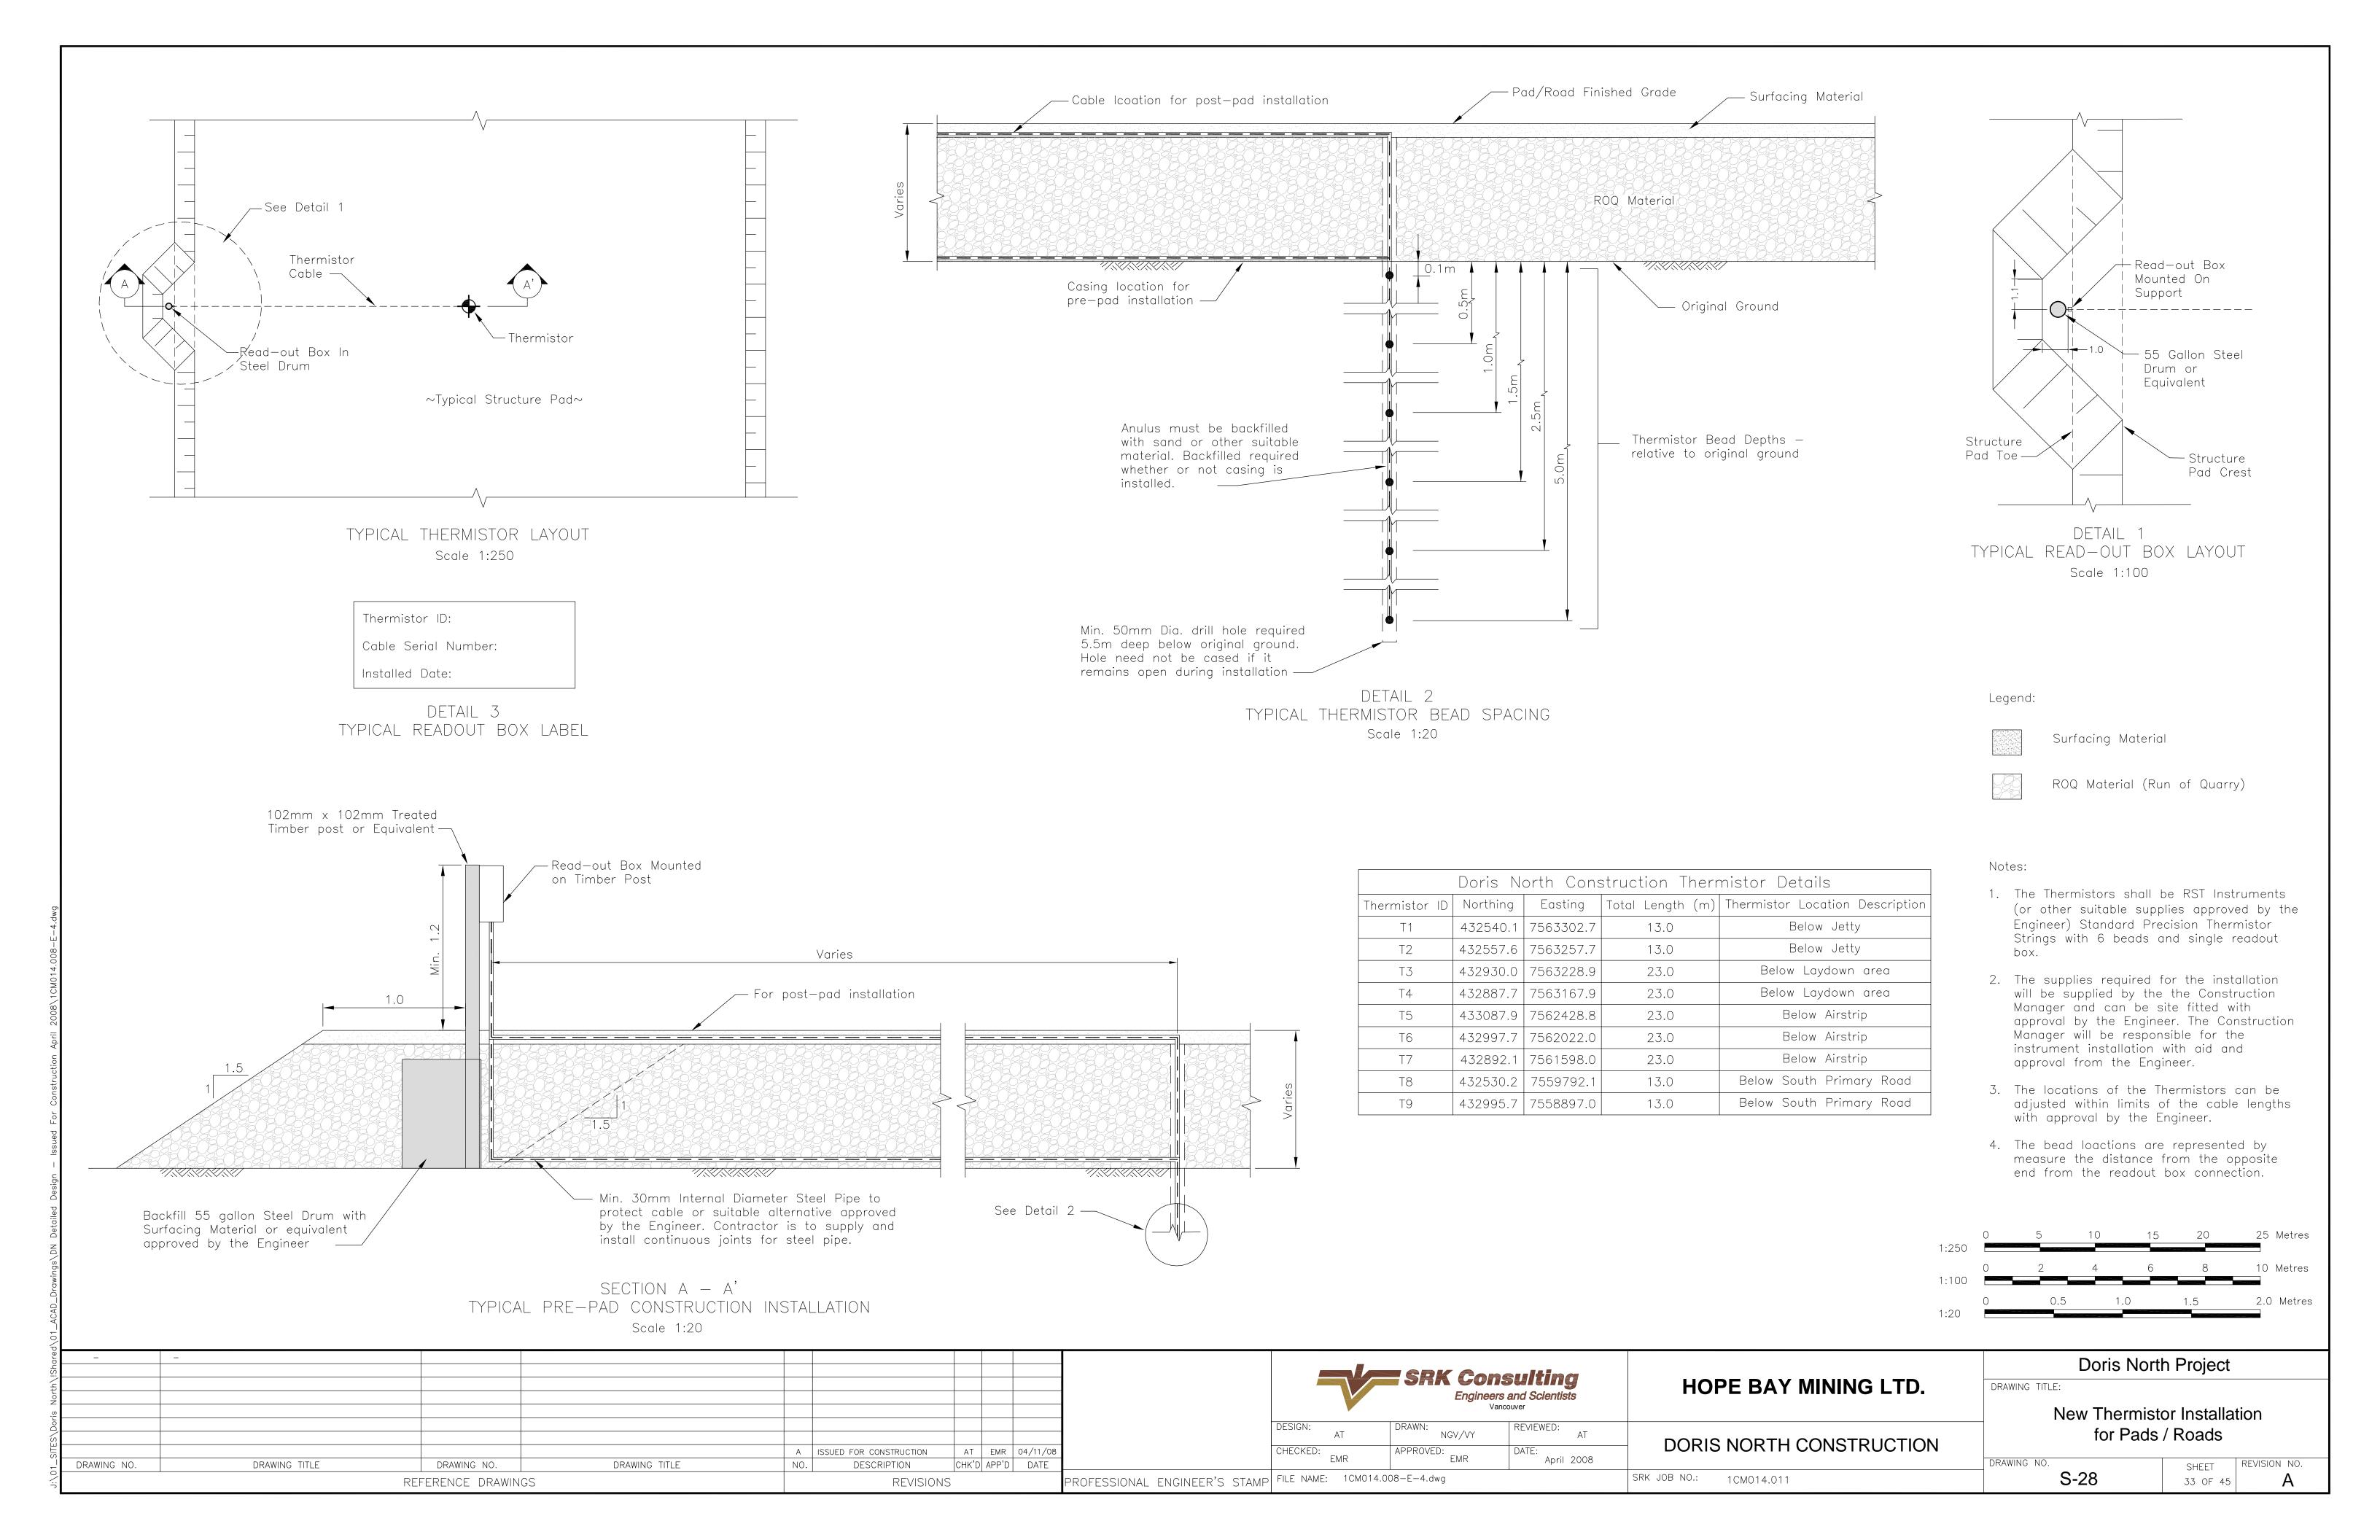


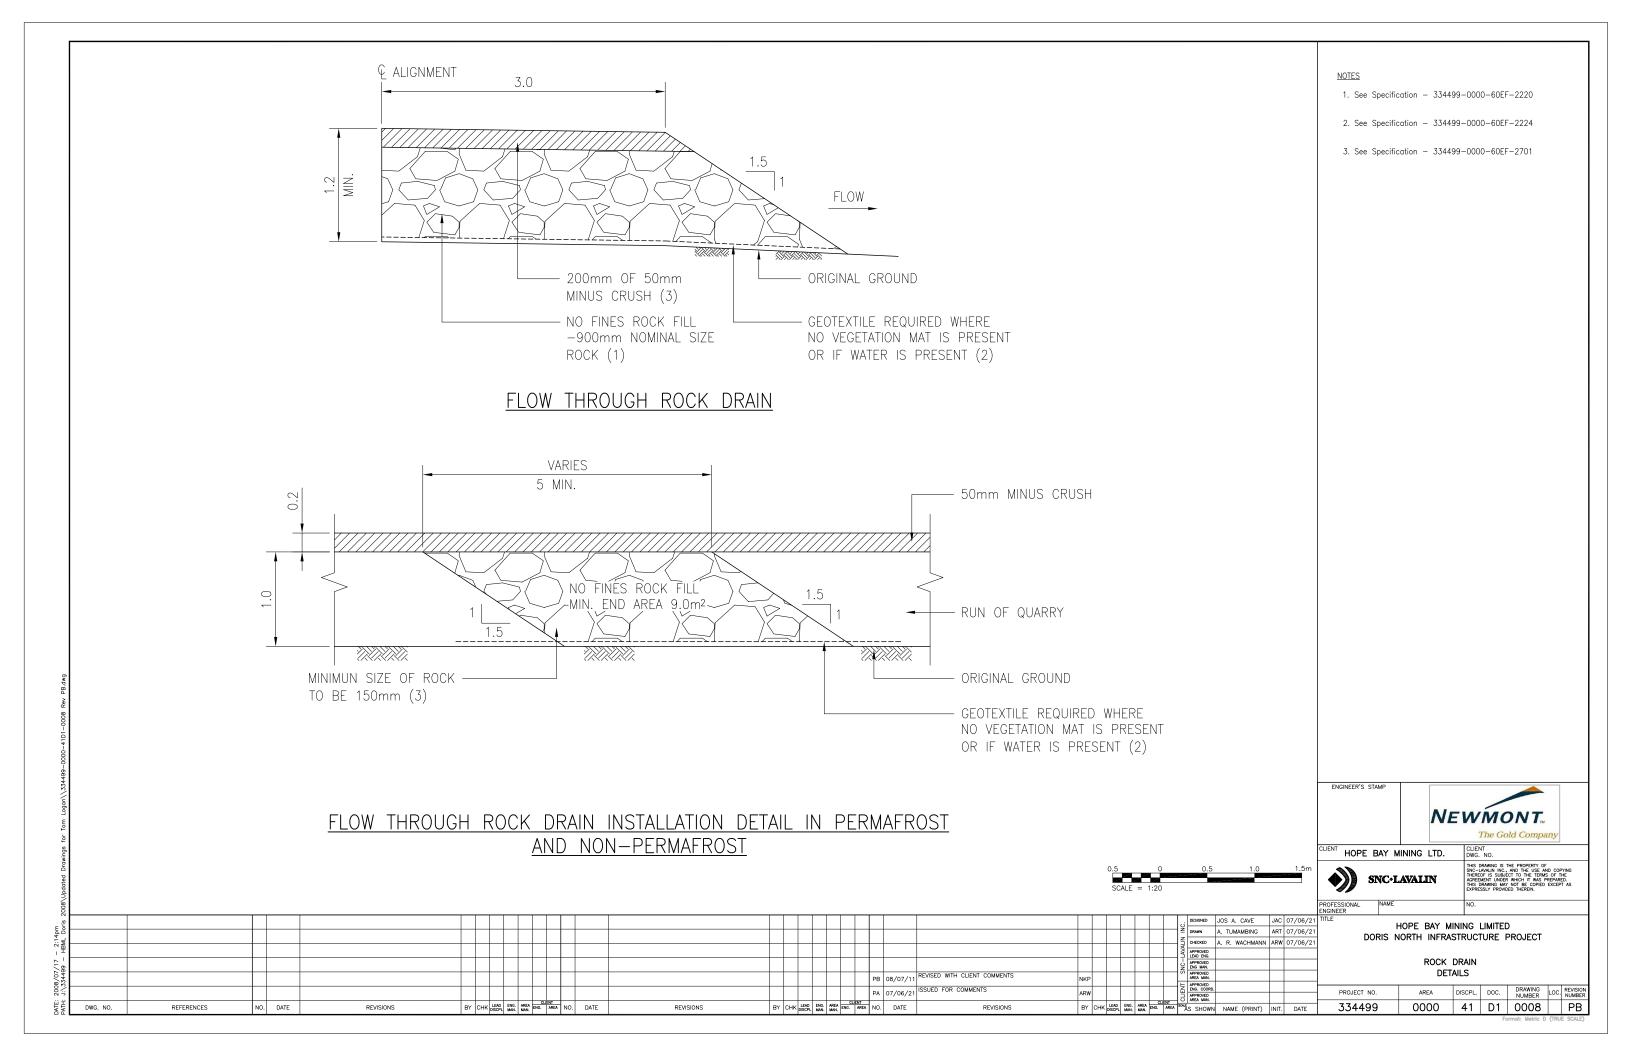

2c As-Built Drawings for Constructed Facilities

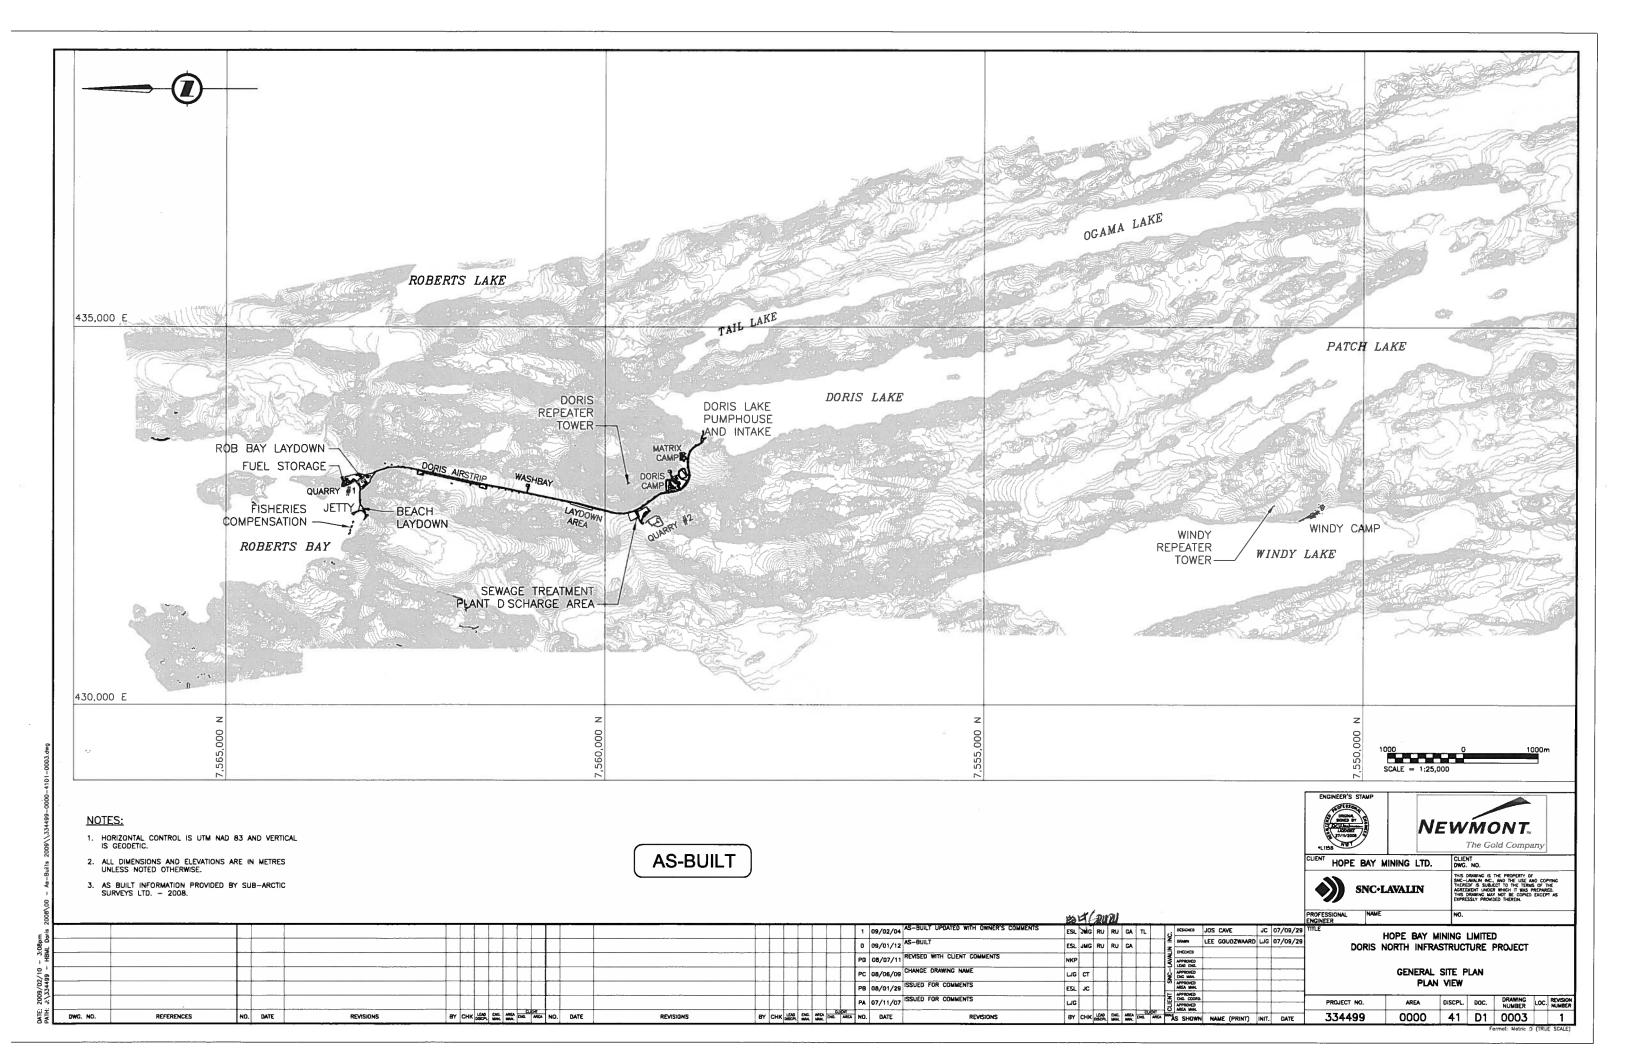


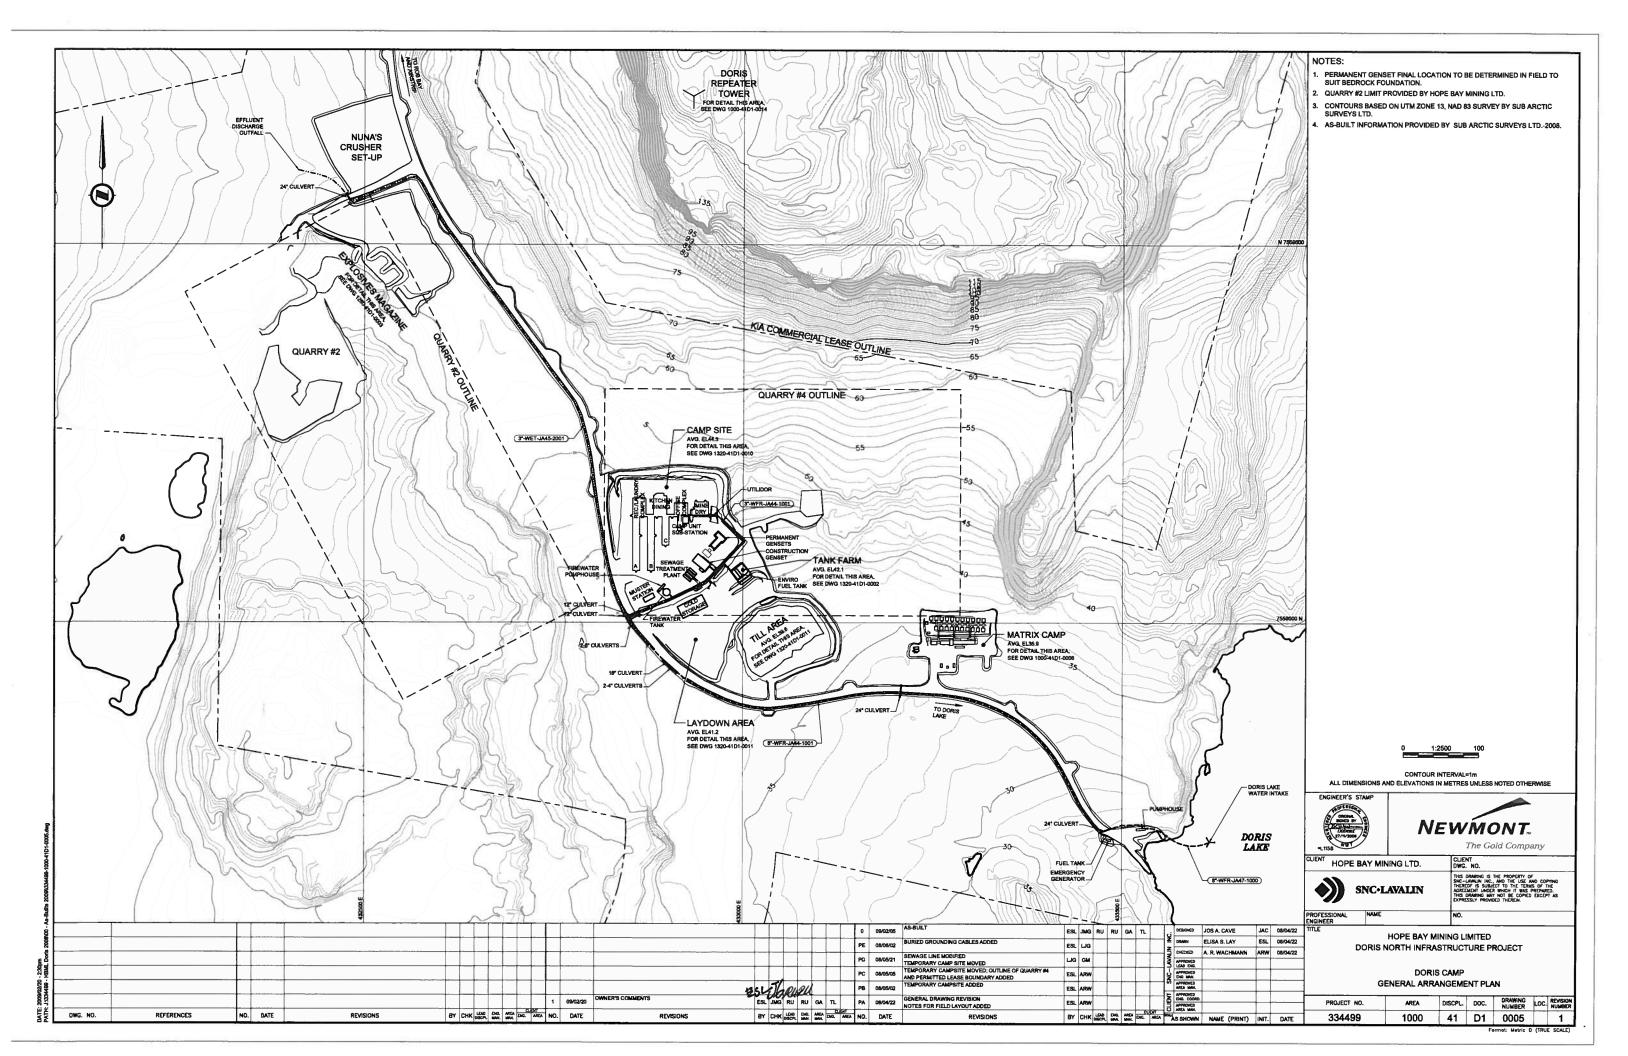

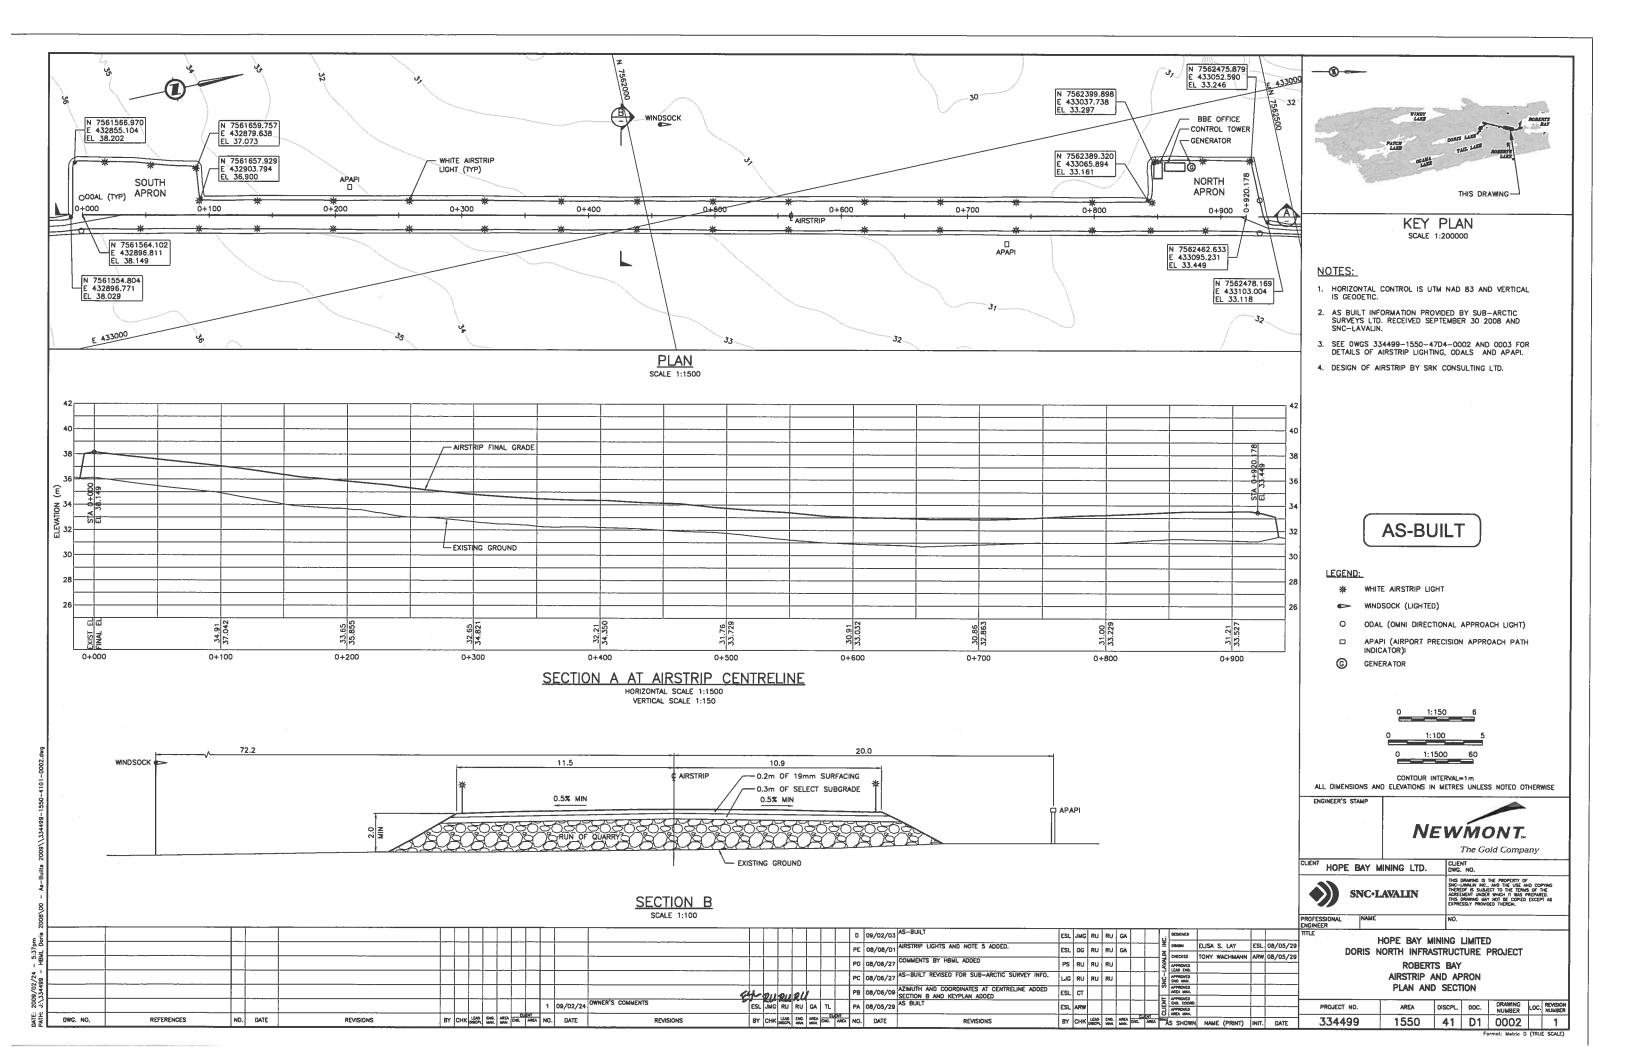

3. Beach Laydown Area

3a Relevant Drawings Submitted with Original Water Licens	se Application	

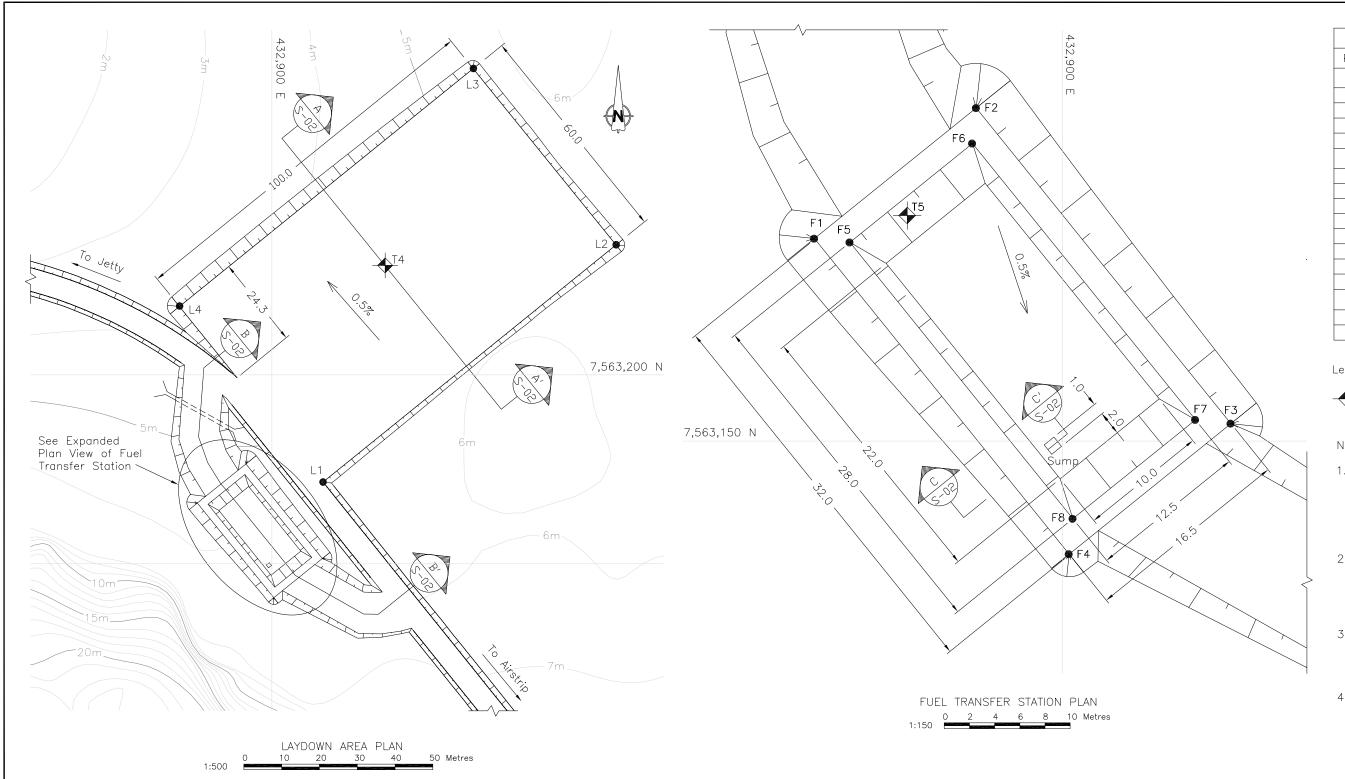

STAKE OUT TABLE						
Point	Northing	Easting				
В	each Laydowi	n Area				
L1	432913.3	7563171.4				
L2	432991.0	7563234.4				
L3	432953.3	7563281.0				
L4	432875.6	7563218.1				
F	uel Transfer	Station				
F1	432880.3	7563166.1				
F2	432893.1	7563176.4				
F3	432913.4	7563151.4				
F4	432900.5	7563141.0				
F5	432883.1	7563165.8				
F6	432892.8	7563173.6				
F7	432910.5	7563151.7				
F8	432900.8	7563143.8				
T	hermistor Loc	cations				
T4	432930.0	7563228.9				
T5	432887.7	7563167.9				


Legend:



Thermistor Location

Notes:

- 1. The Contractor shall supply and install thermistors in locations as indicated on the drawing. With approval from the Engineer the exact locations can be finalized on
- 2. The Contractor shall take all necessary precautions to ensure that the thermistor cables, and their read—out boxes are not damaged during construction.
- 3. The Contractor shall be responsible to keep the Fuel Transfer Station dry and free of snow and ice during the construction period.
- 4. A Specialist Contractor will be responsible for the design, procurement and installation of all mechanical and/or electrical equipment at the Fuel Transfer Station. The details of these elements are not indicated on the drawing.

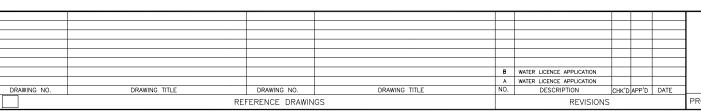


Stamped, signed and dated originals submitted	SRK Consulting Engineers and Scientists							
to the Nunavut Water Board	DESIGN:	DRAWN: JJH	REVIEWED: EMR					
Hator Board	CHECKED: AT	APPROVED: EMR	DATE: Mar. 2007					
PROFESSIONAL ENGINEERS STAMP	FILE NAME: FUEL TRAN	NSFER AND LAYDOWNrev1.	dwg					

MIRAMAR **DORIS NORTH PROJECT DETAILED DESIGN** SRK JOB NO.: 1CM014.008


Doris North Project


Beach Laydown Area and Fuel Transfer Station Plan


SHEET 9 OF 49 S-01 В

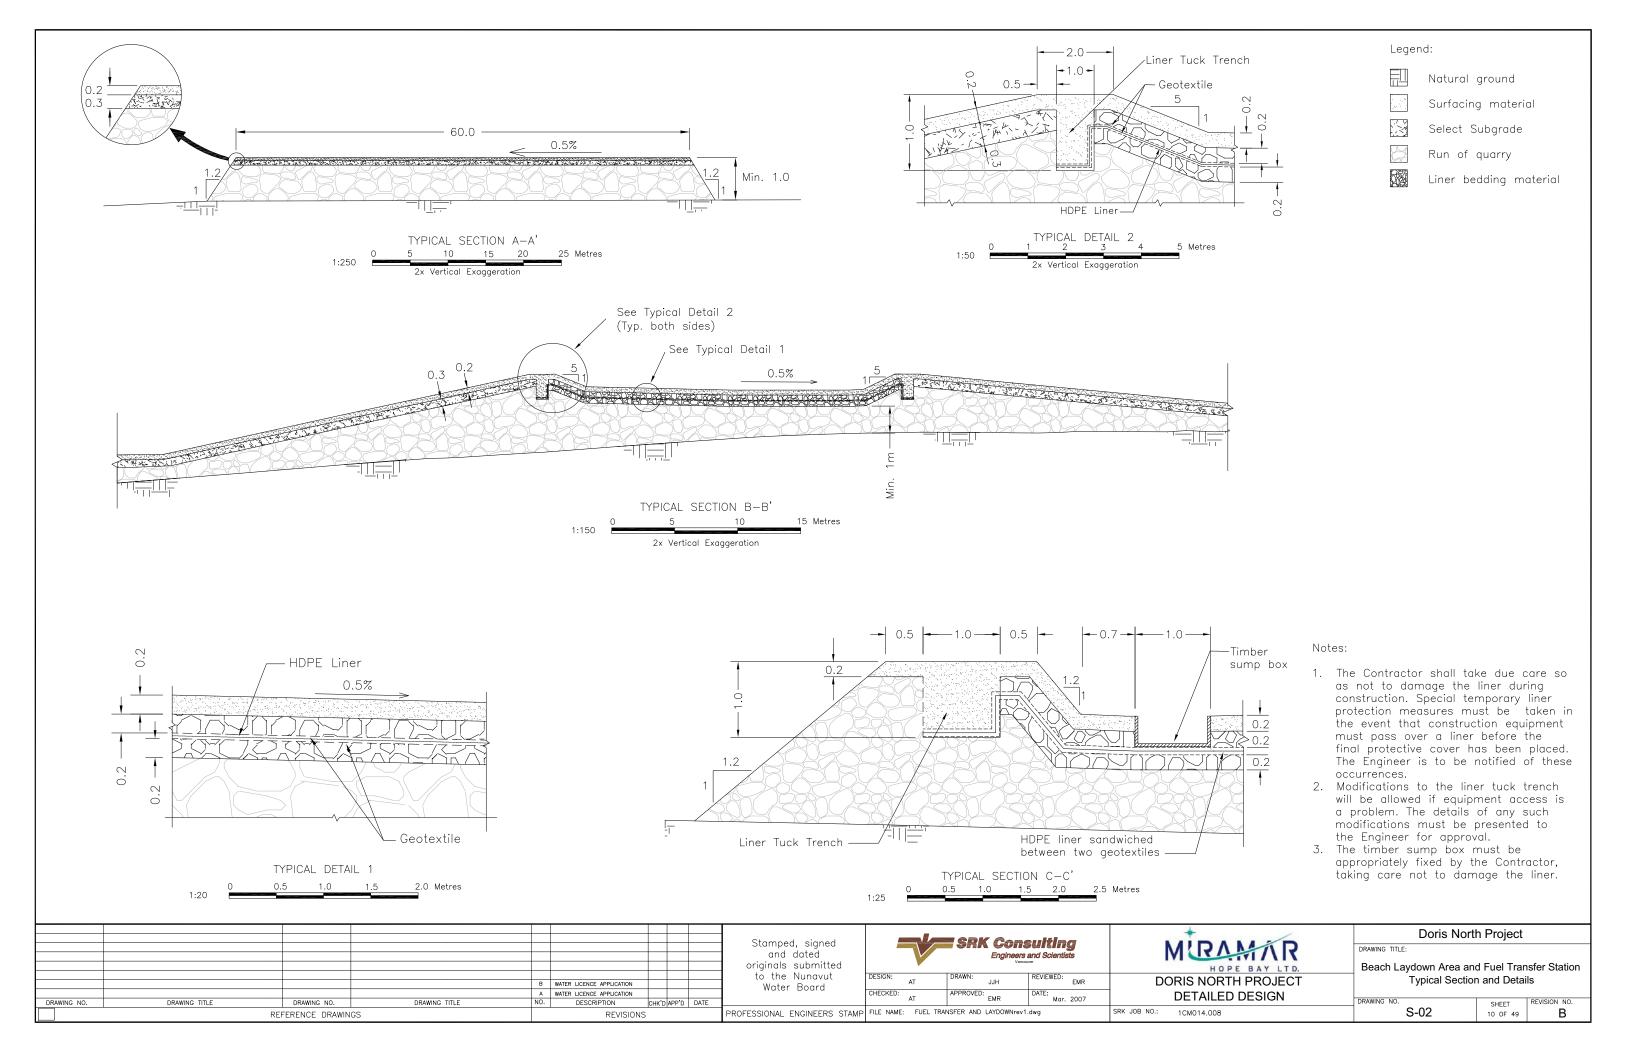


3b Issued for Construction

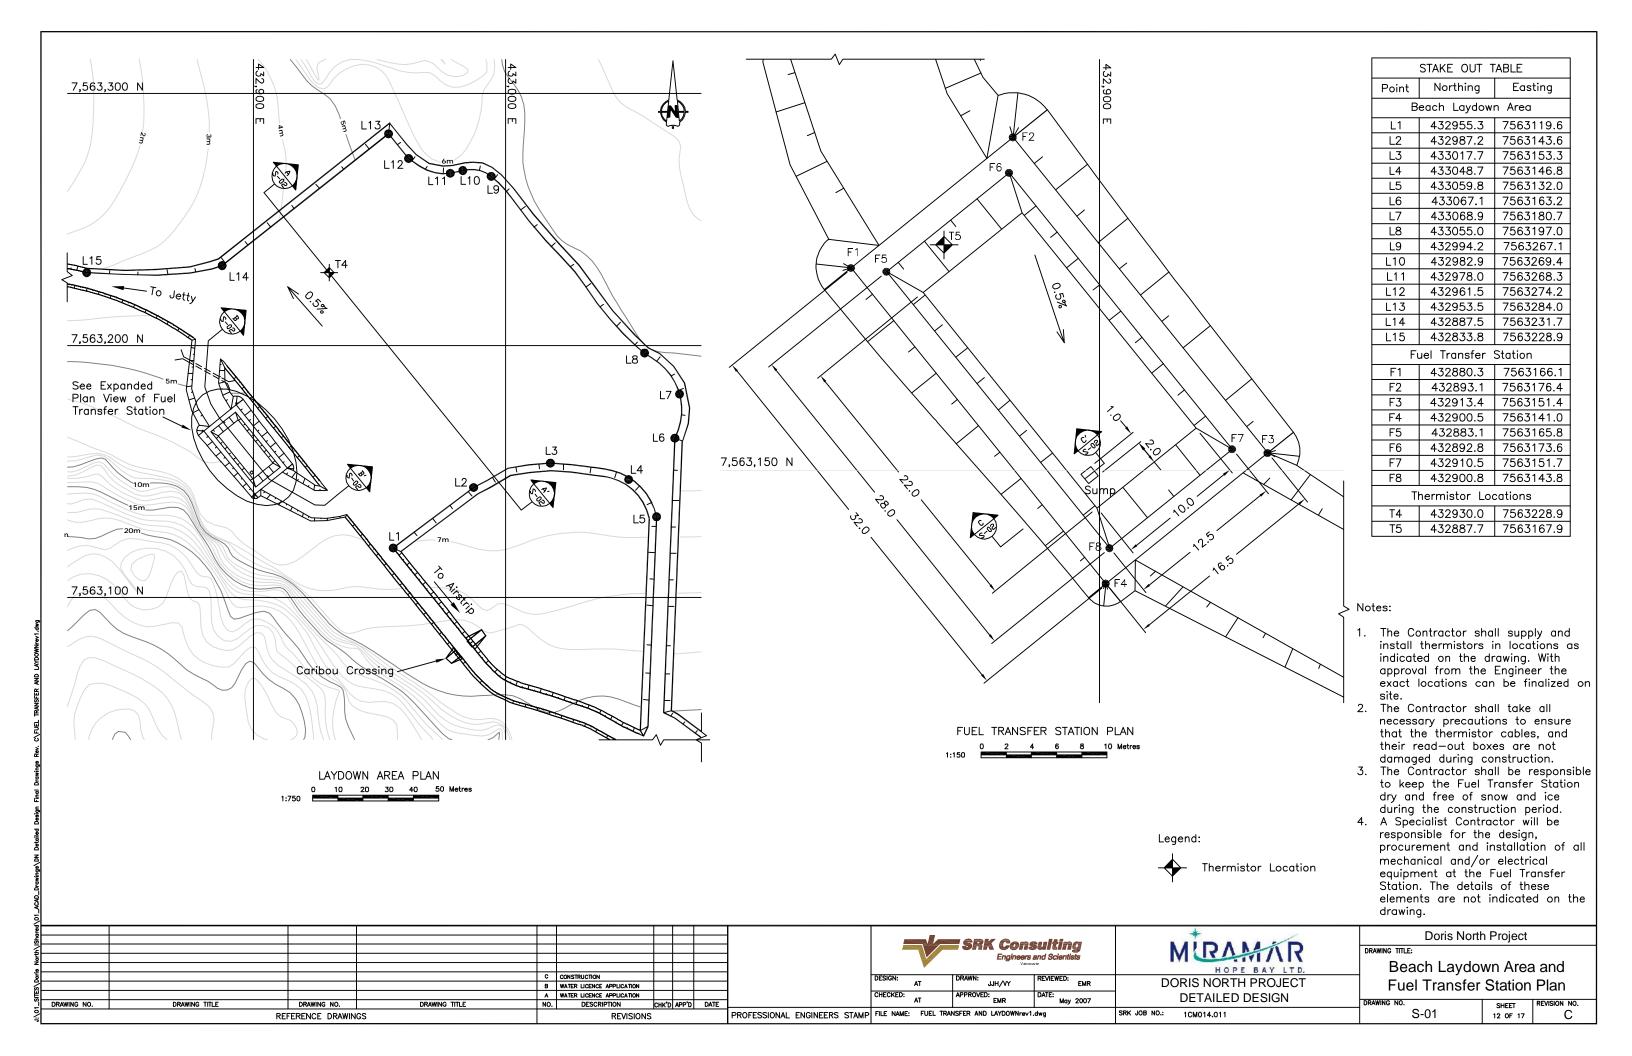


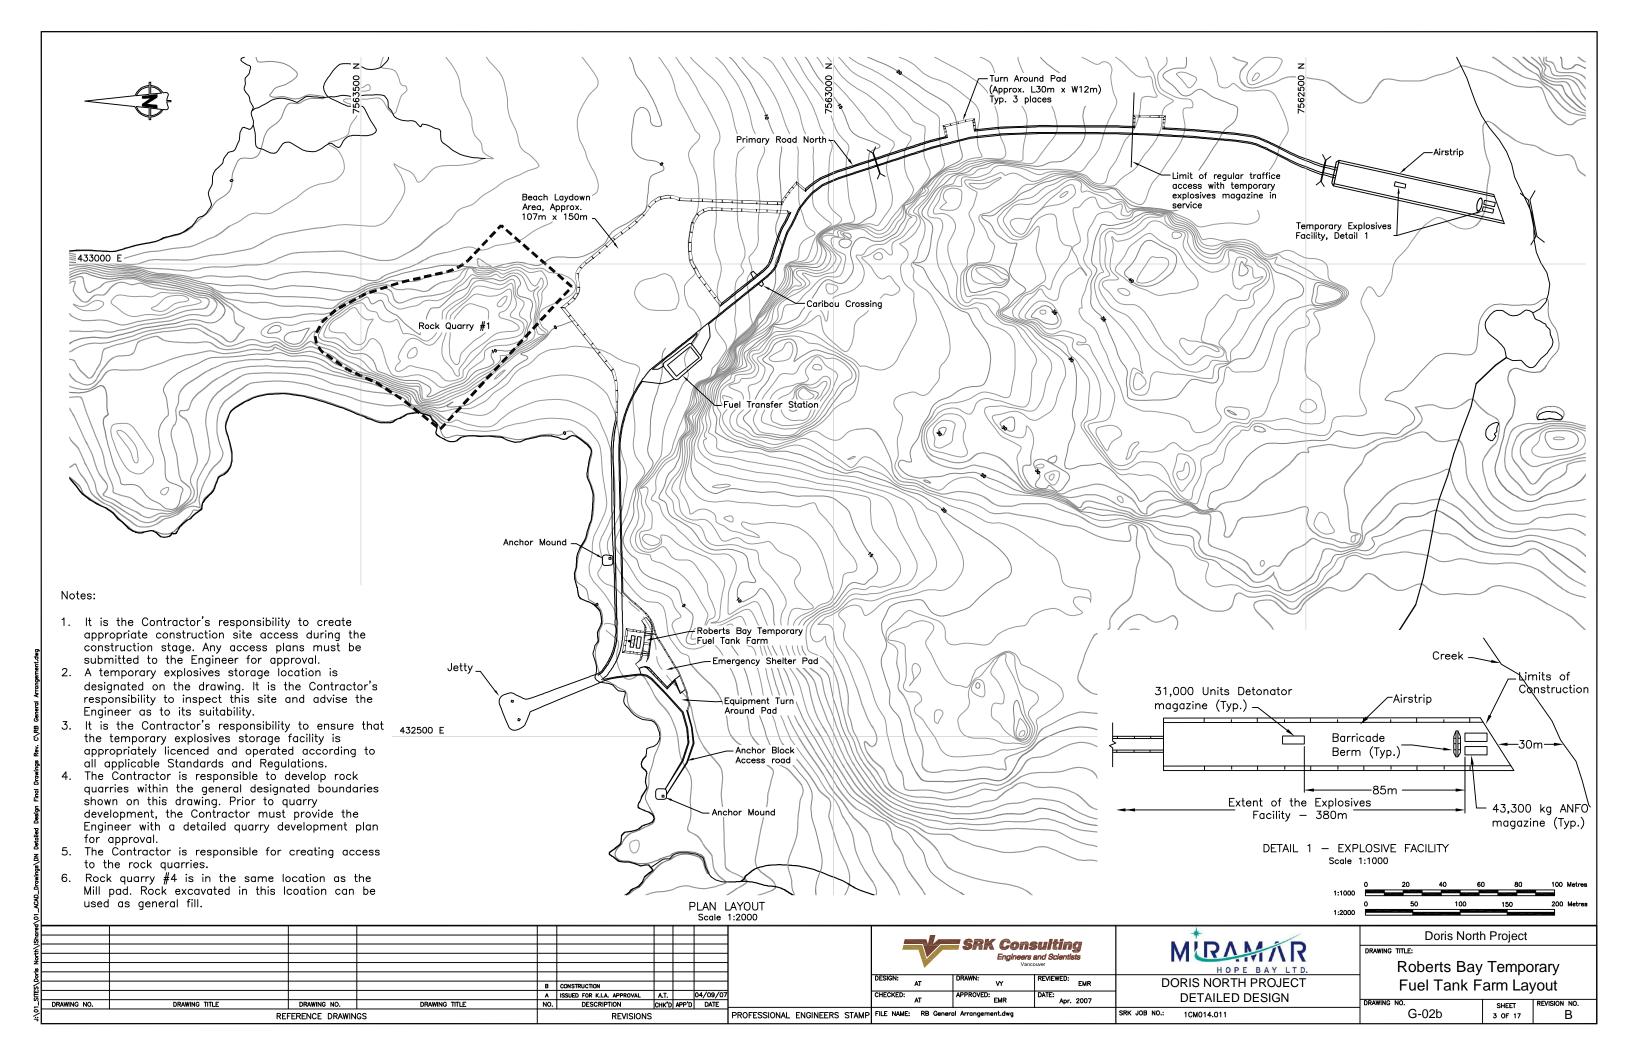


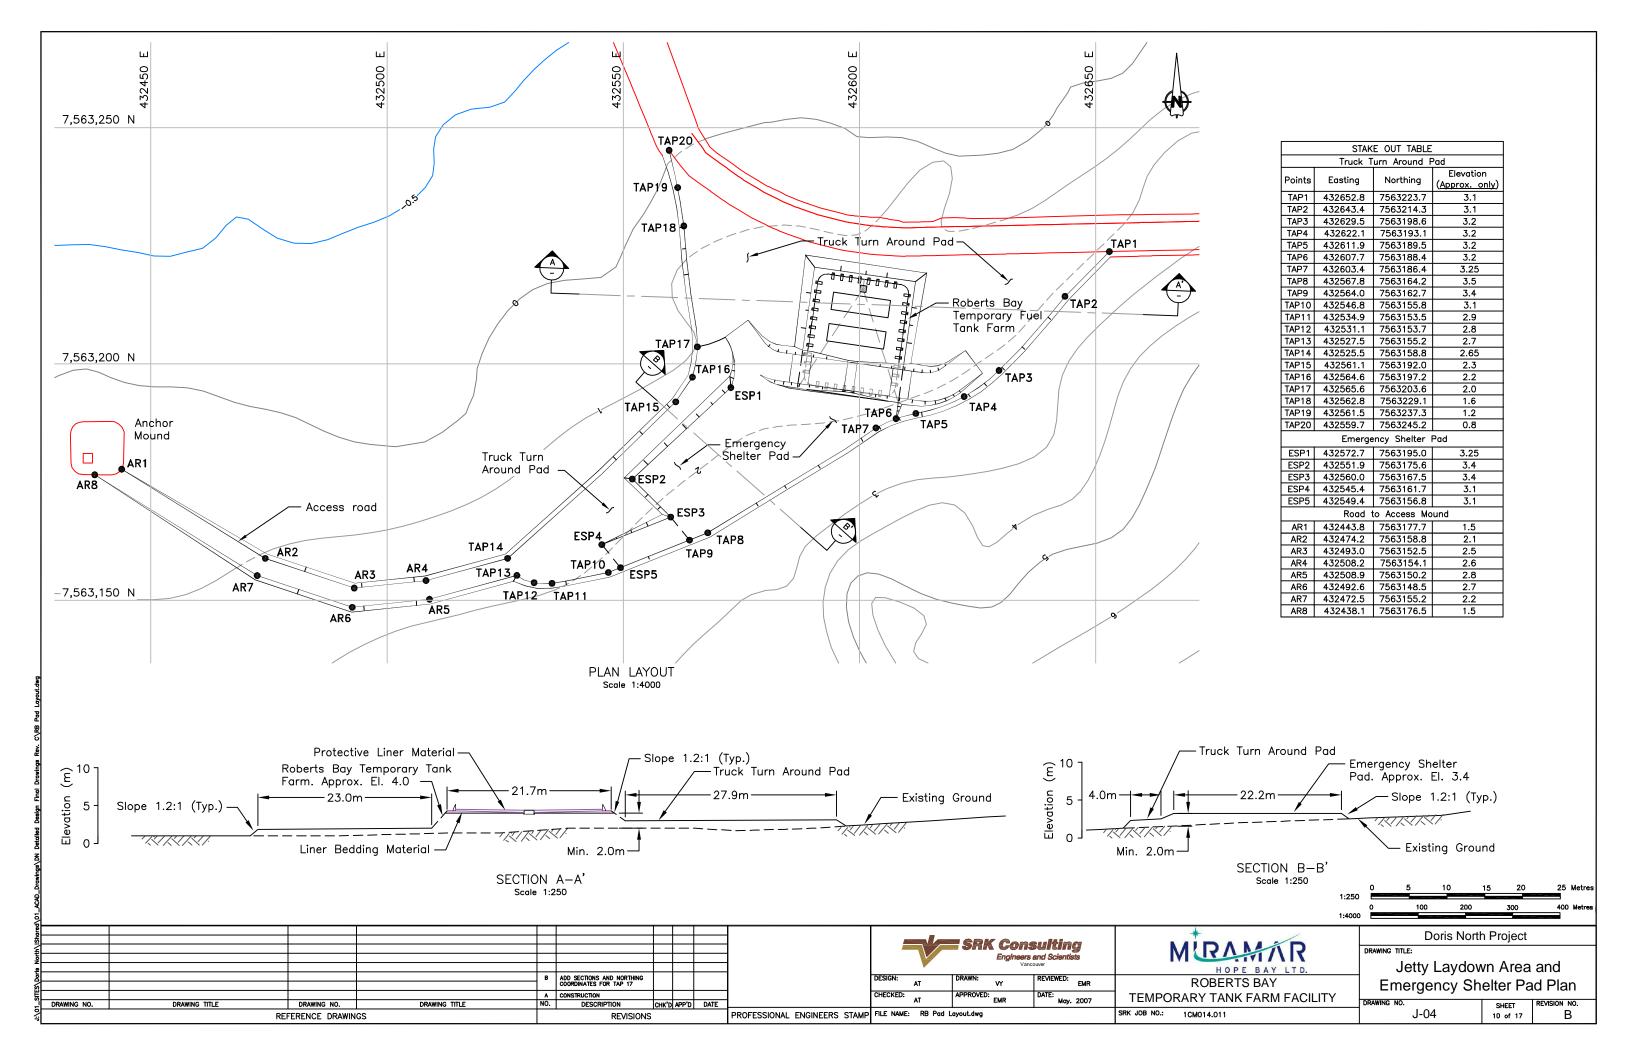

3c As-Built Drawings for Constructed Facilities

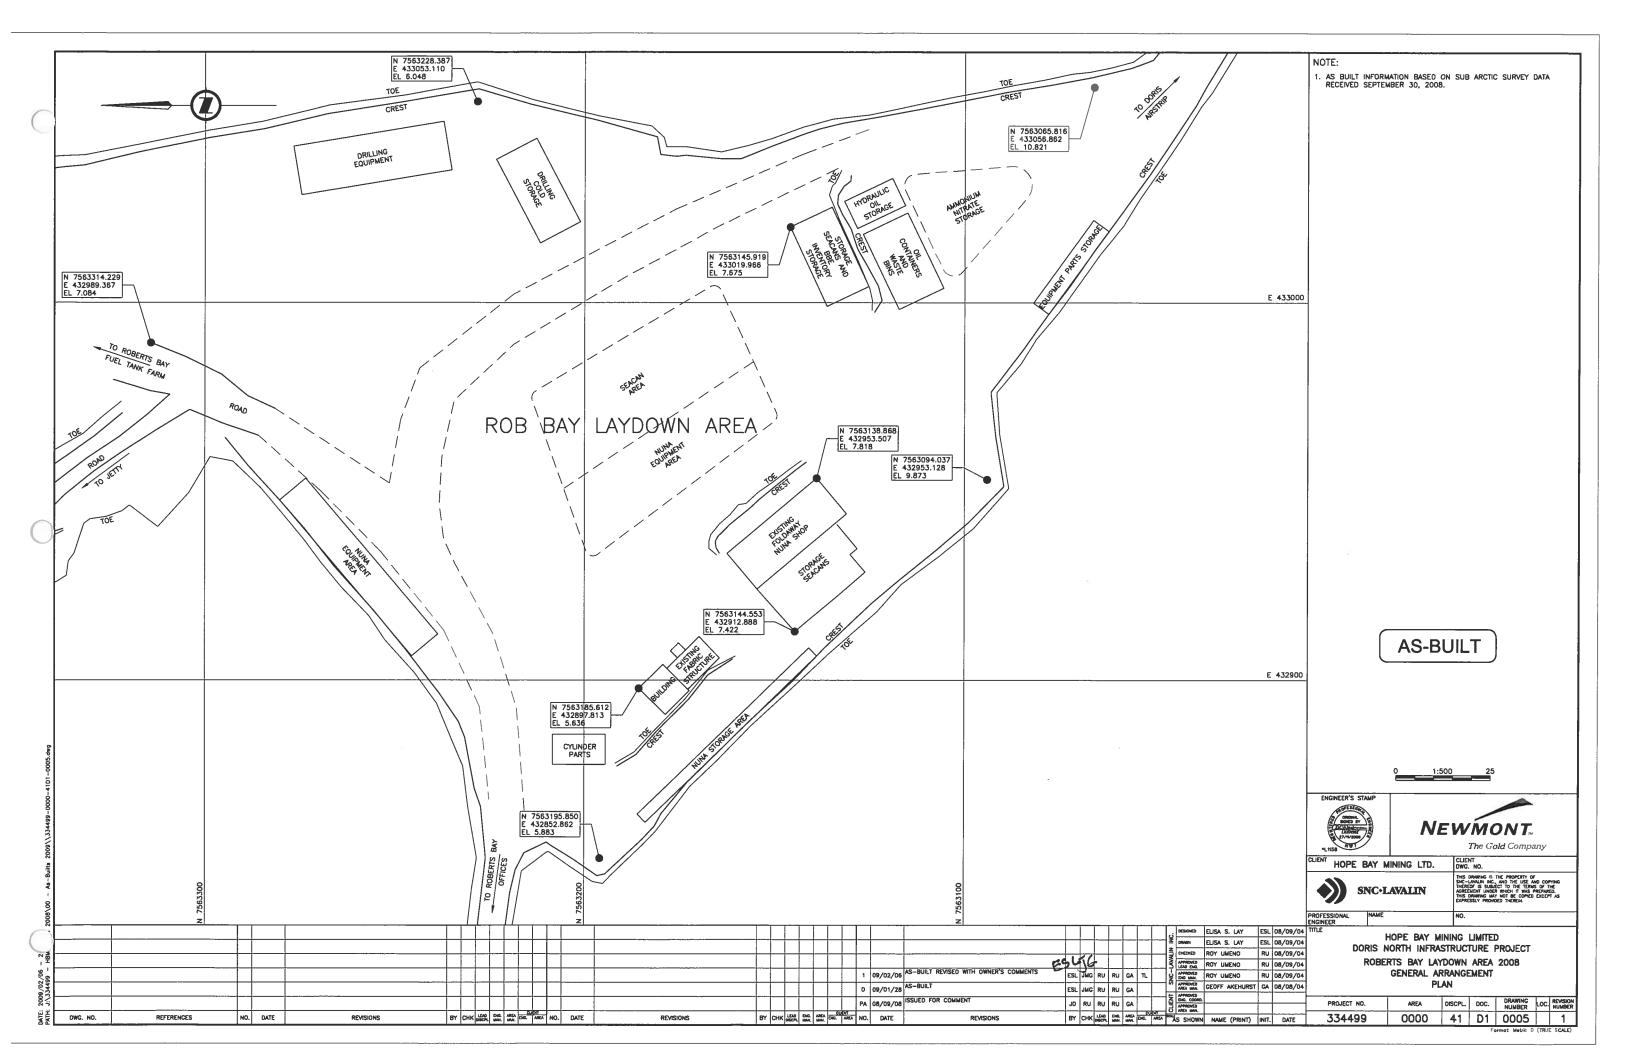


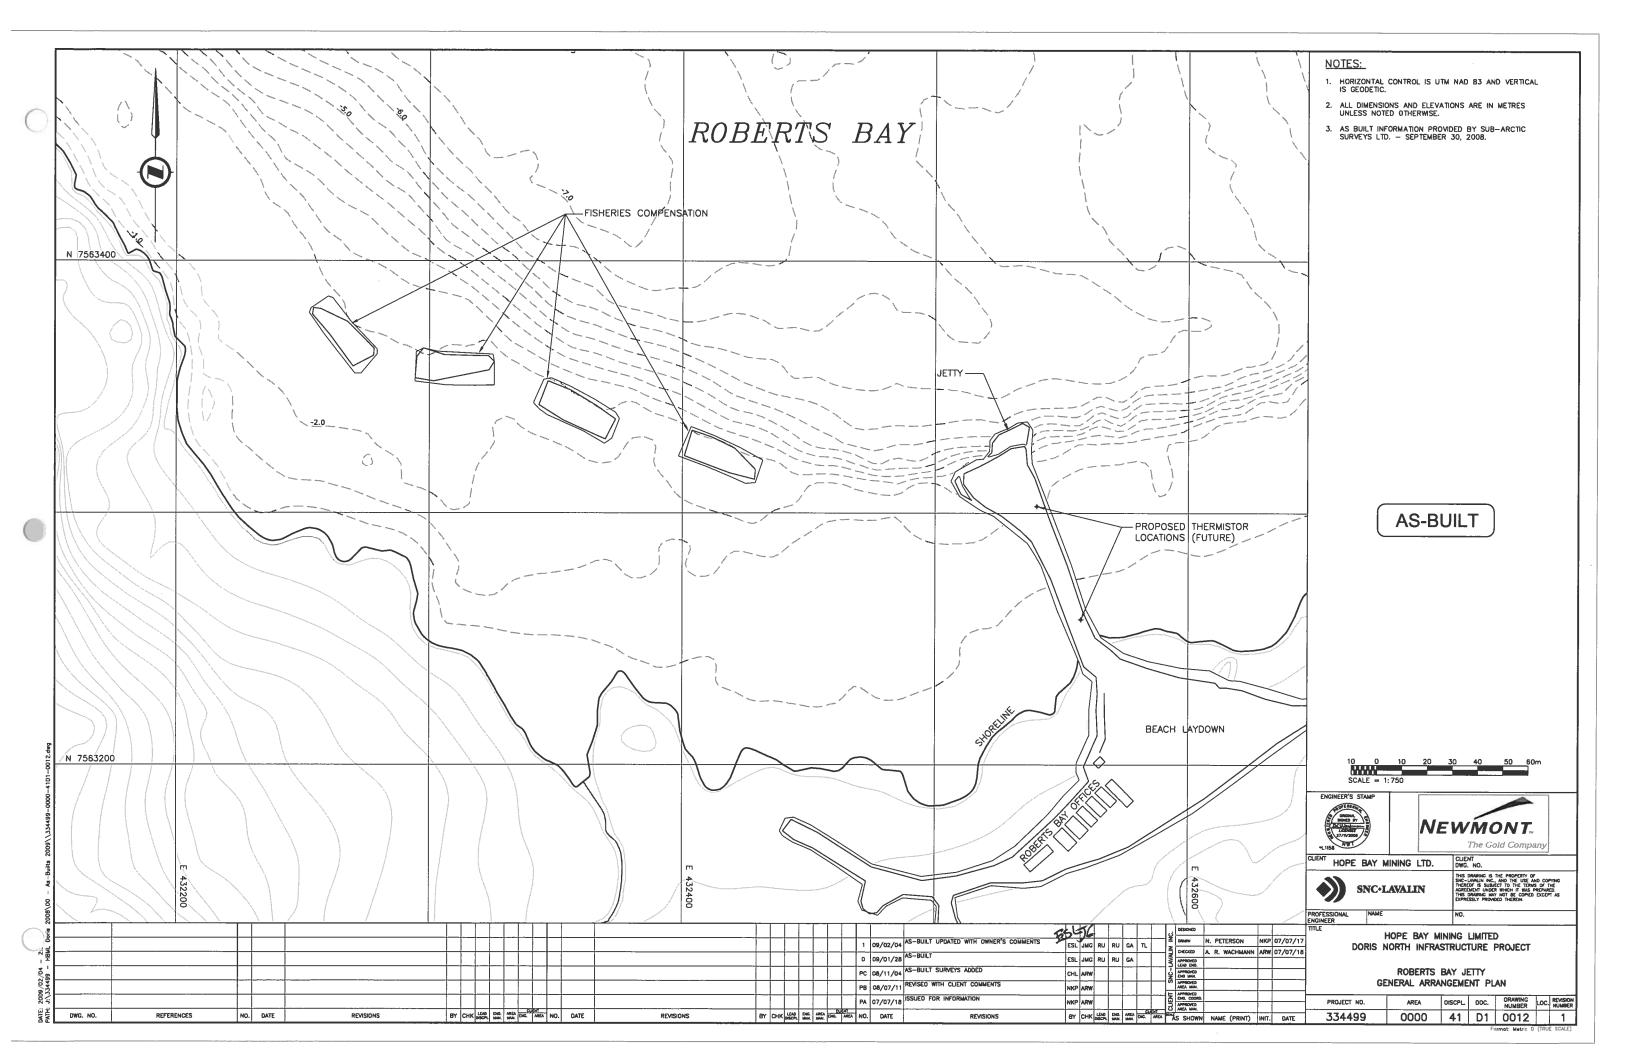


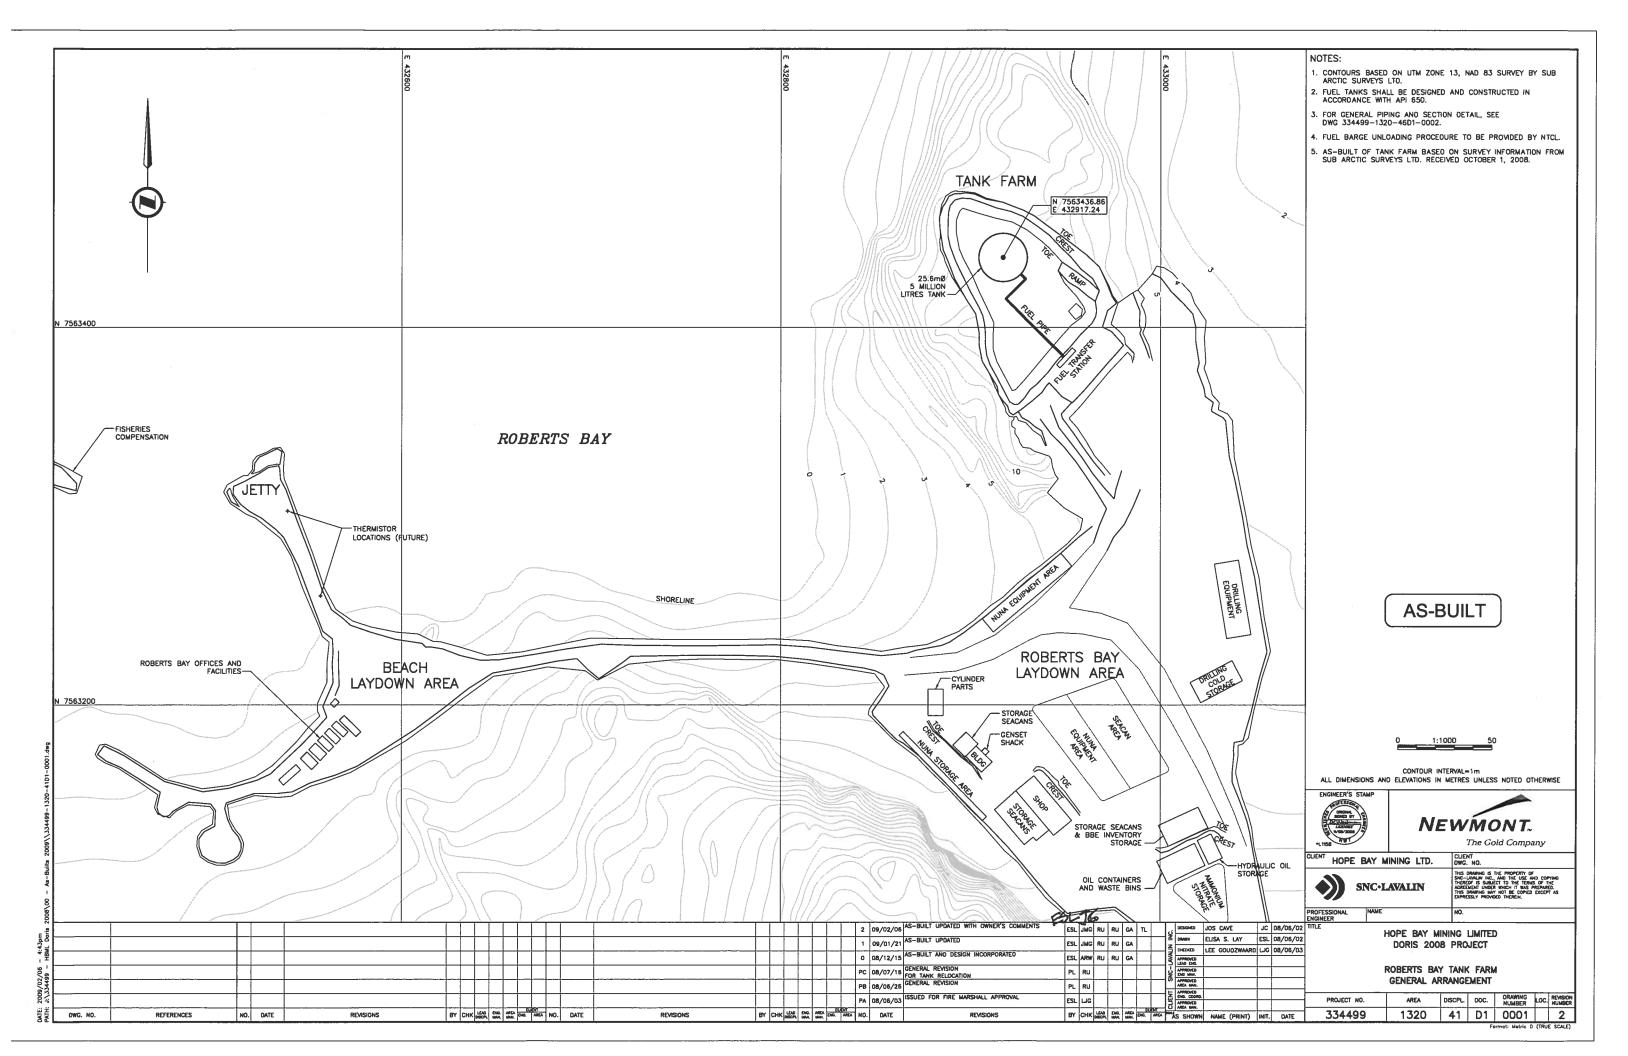



4. Fresh Water Intake

4a Relevant D	Drawings Submitted with	Original Water License	e Application	

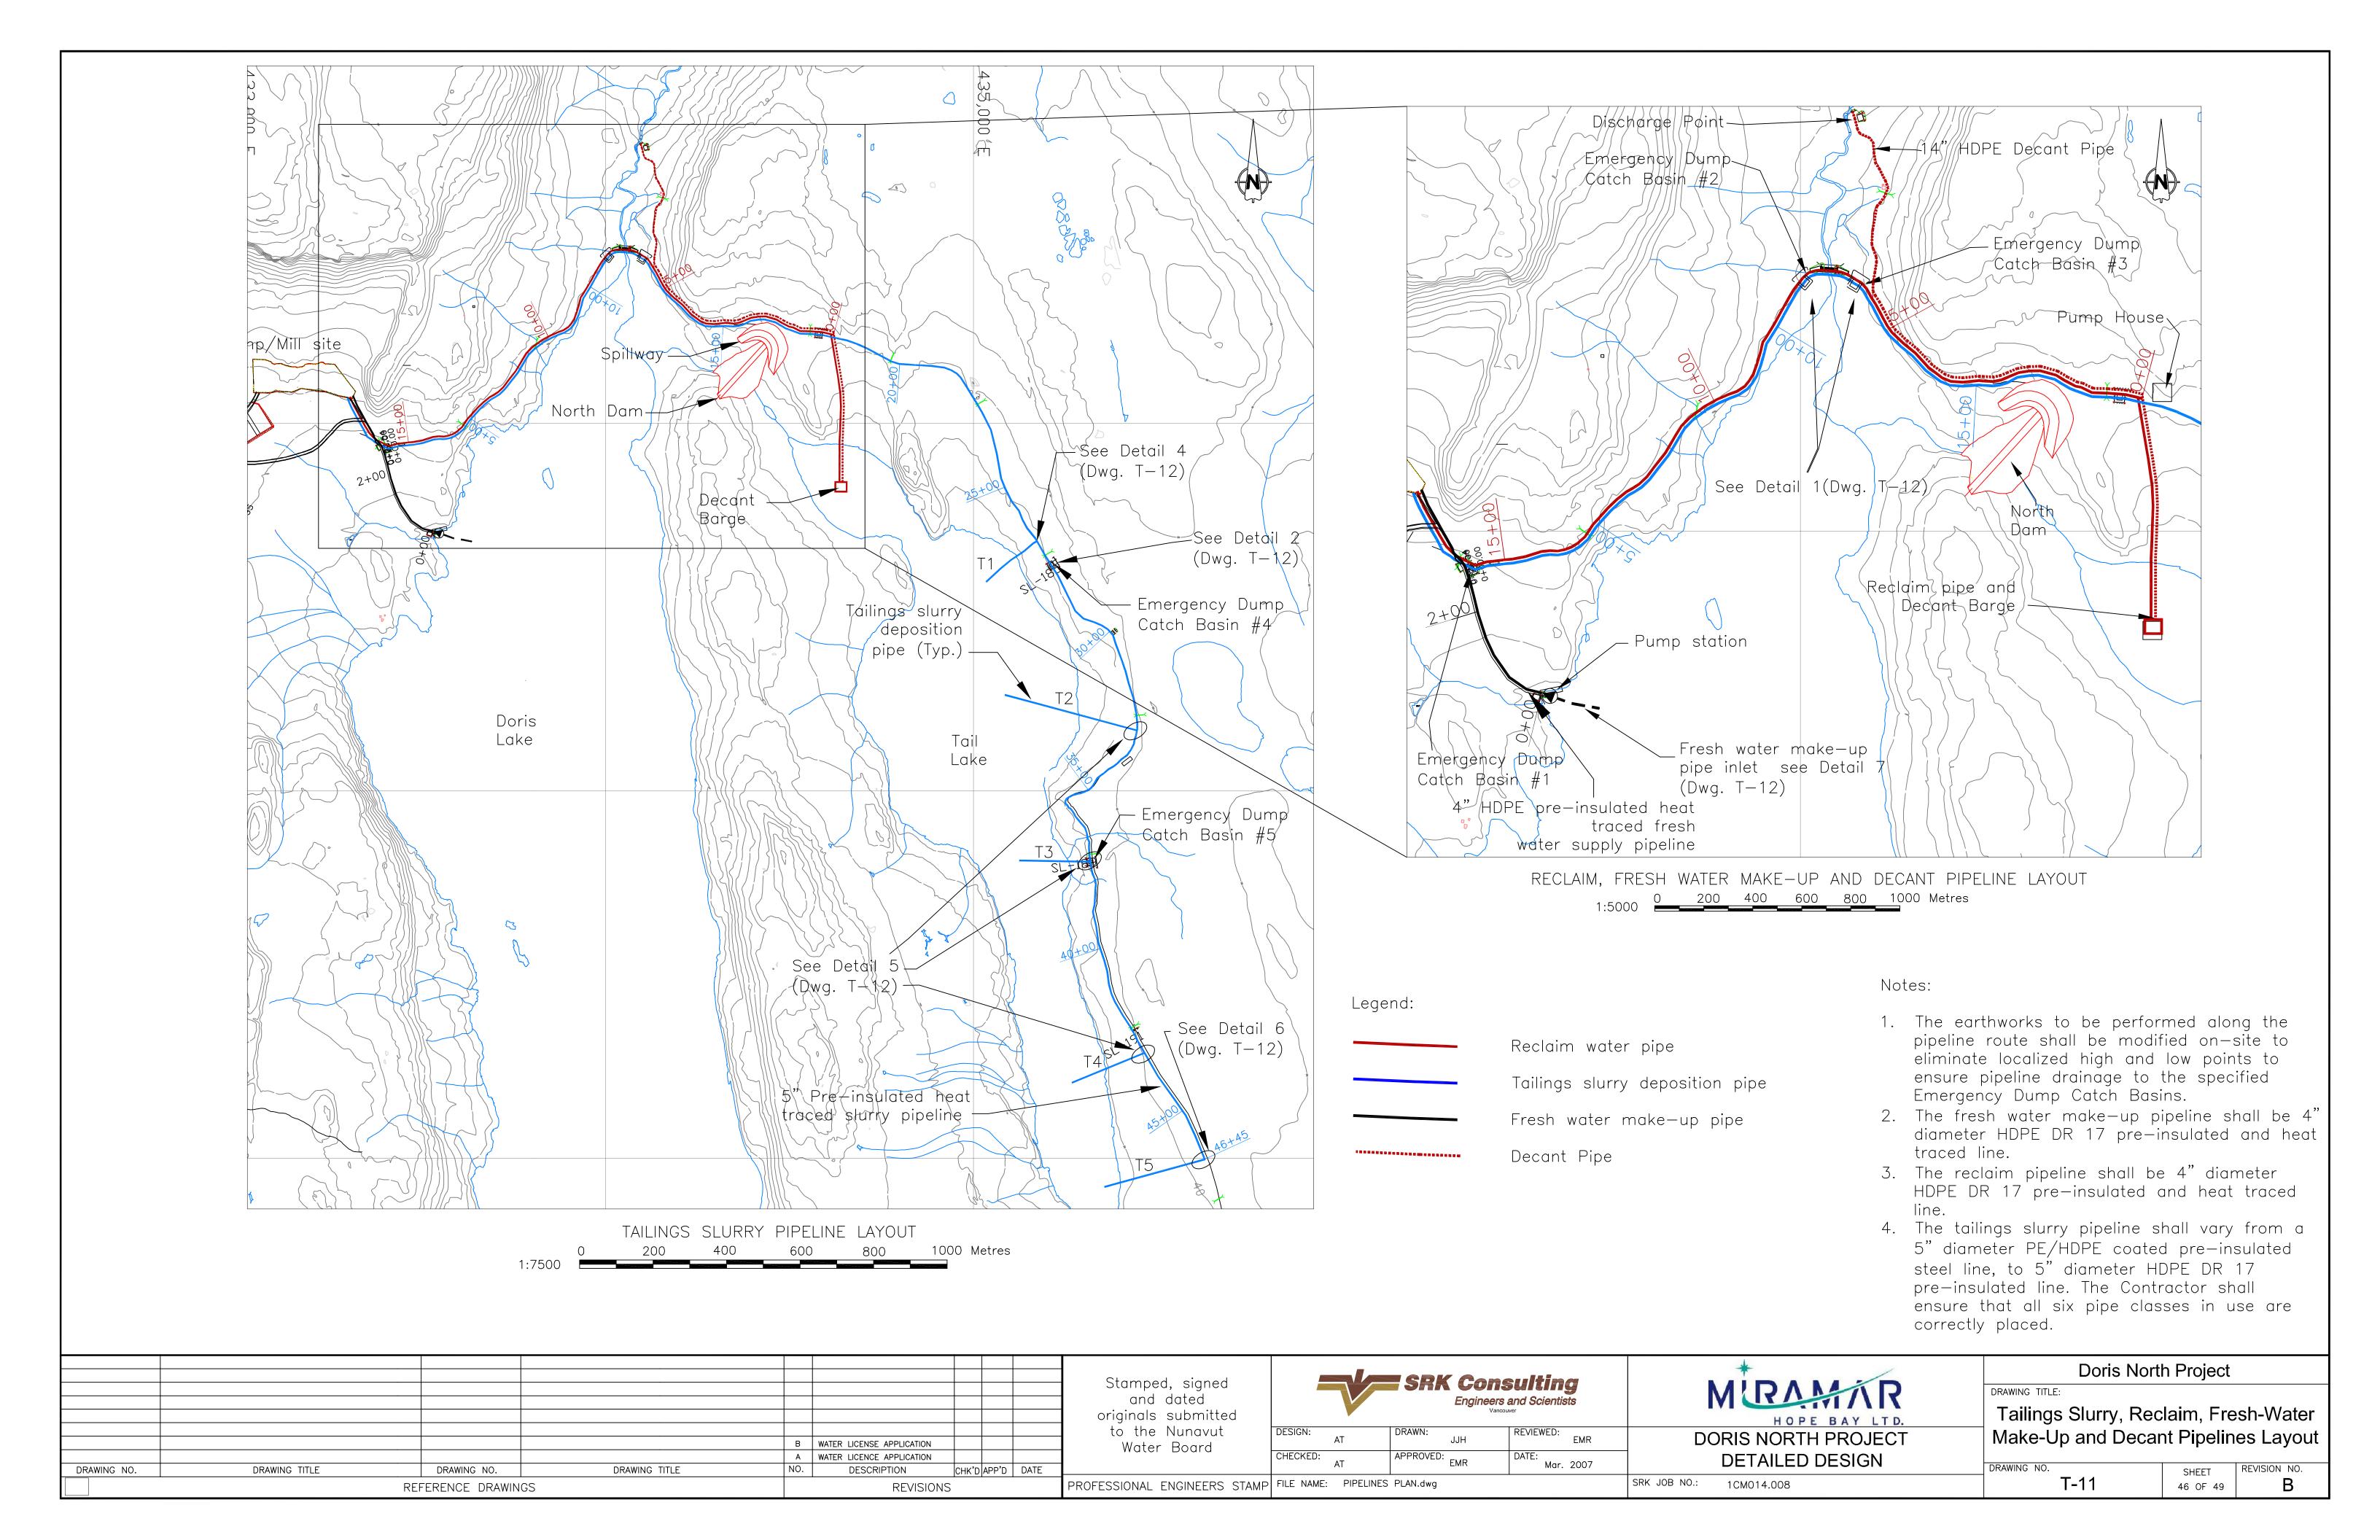

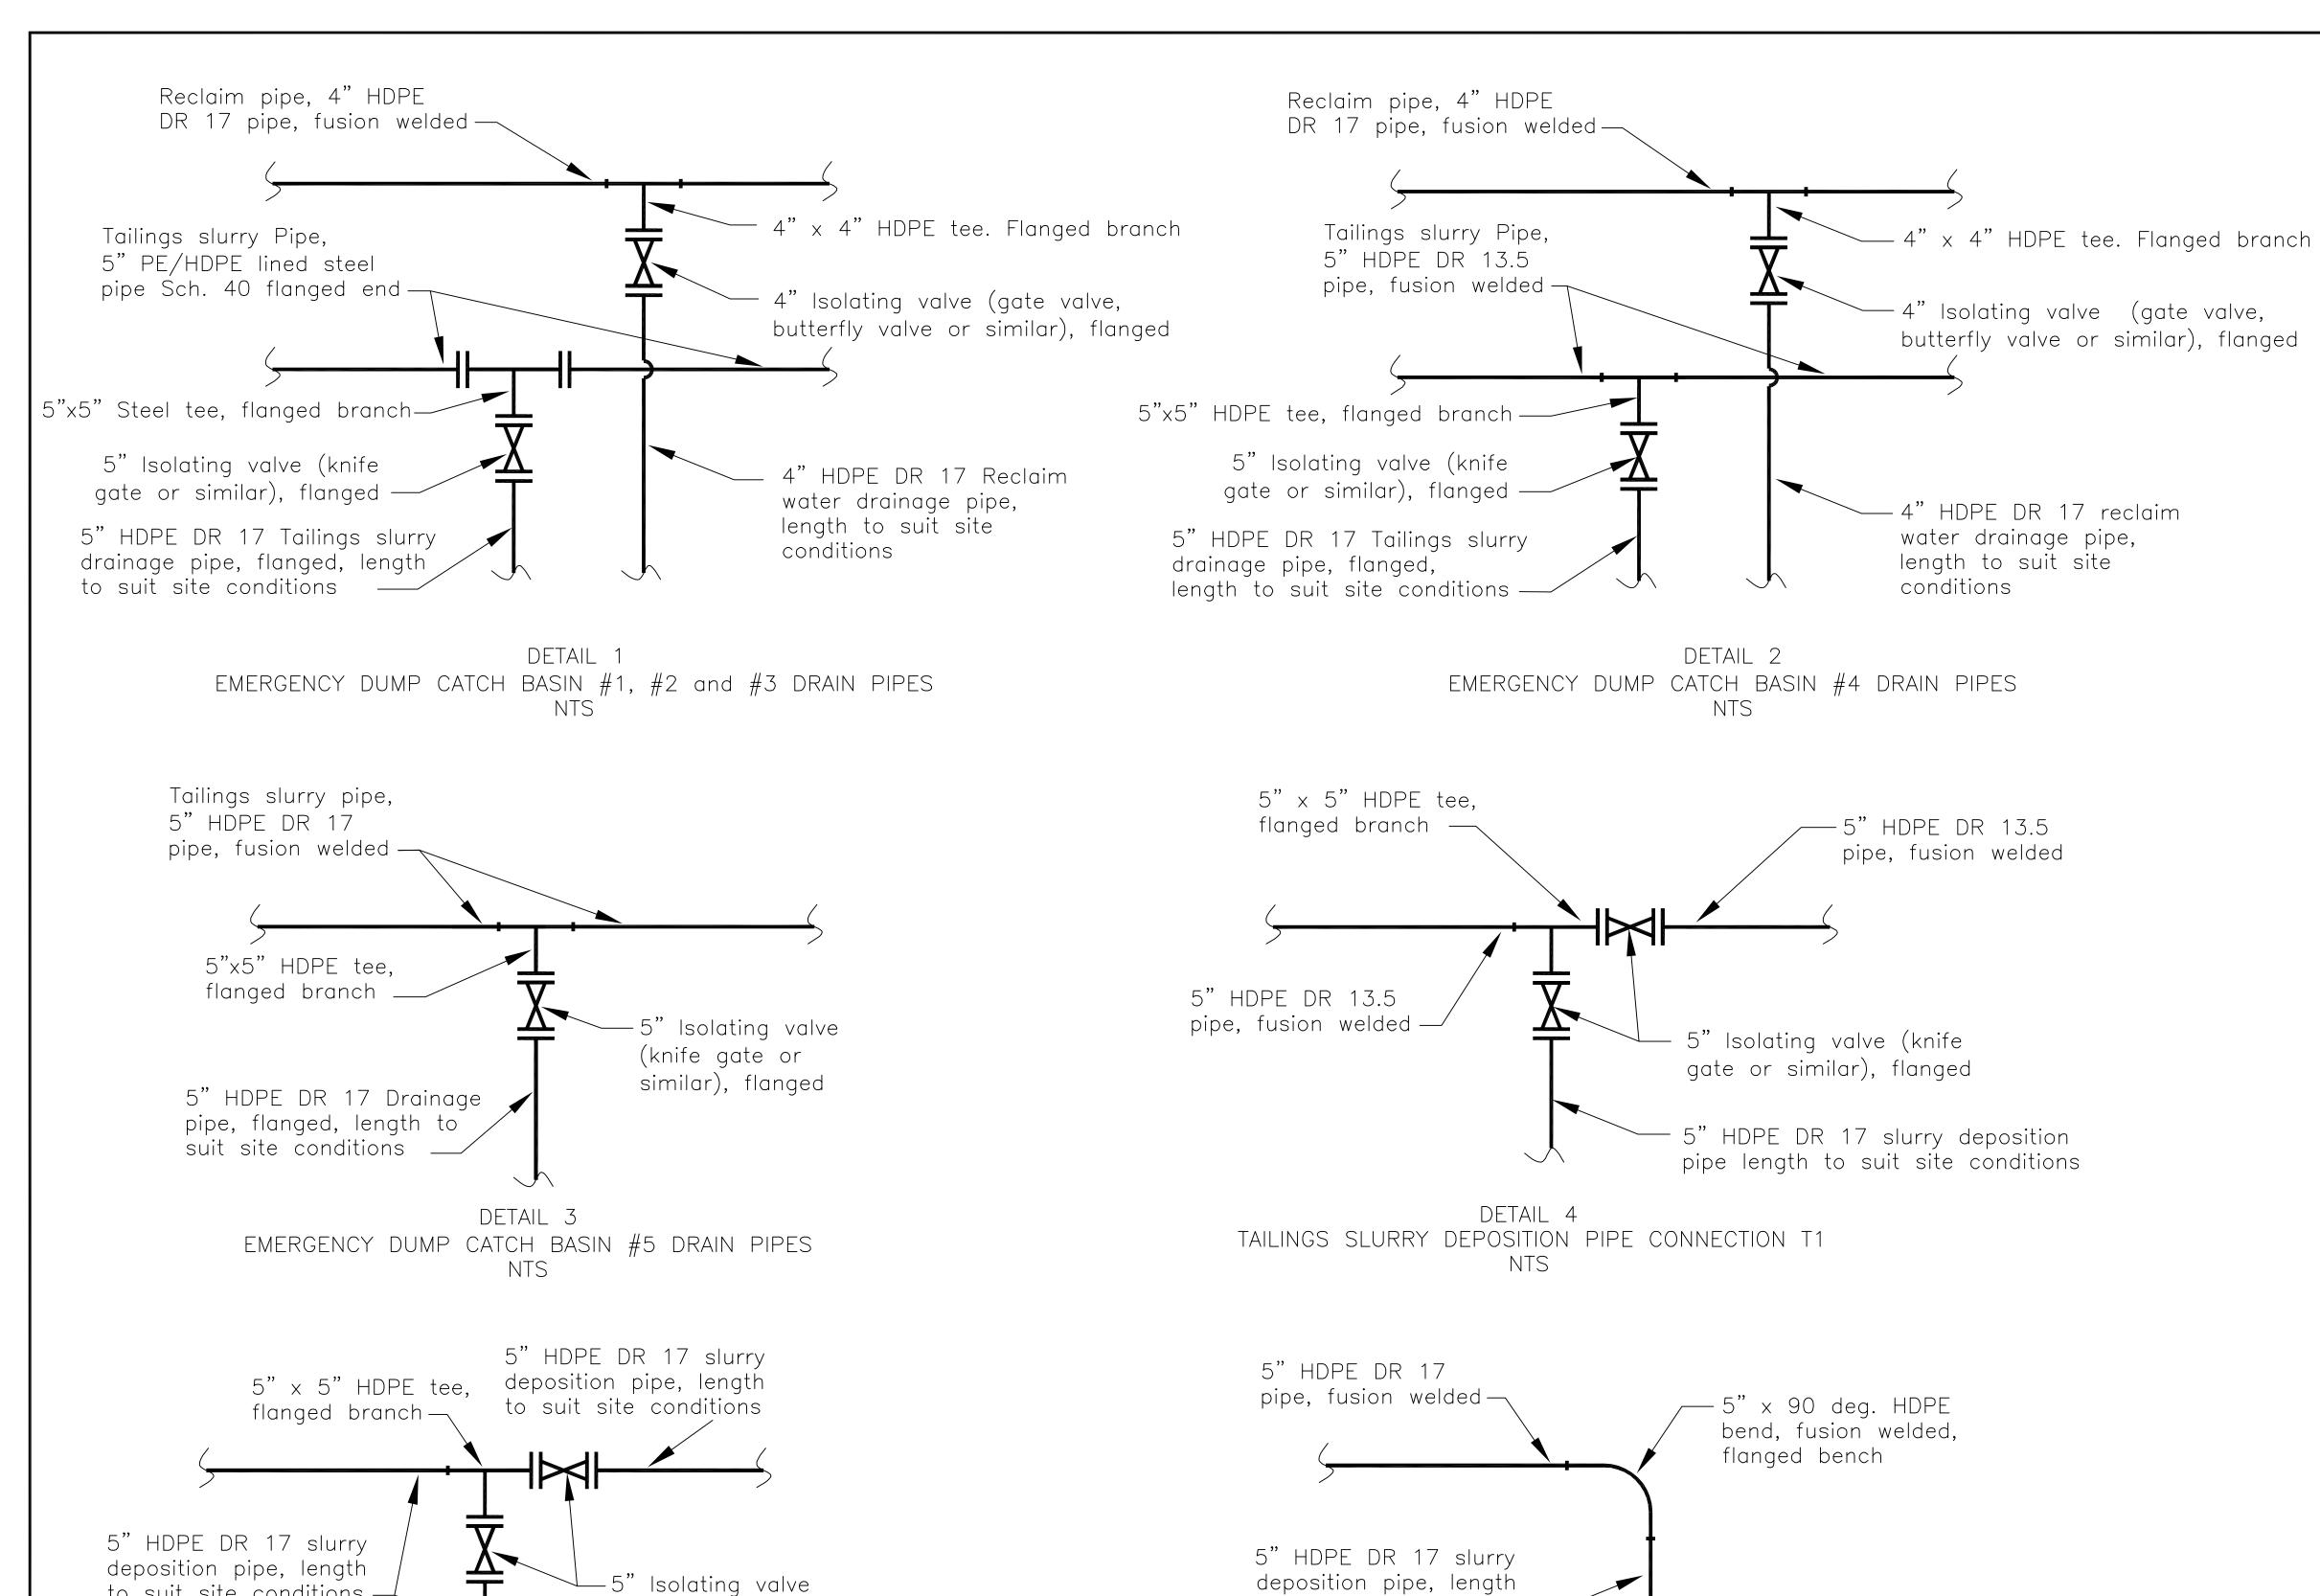

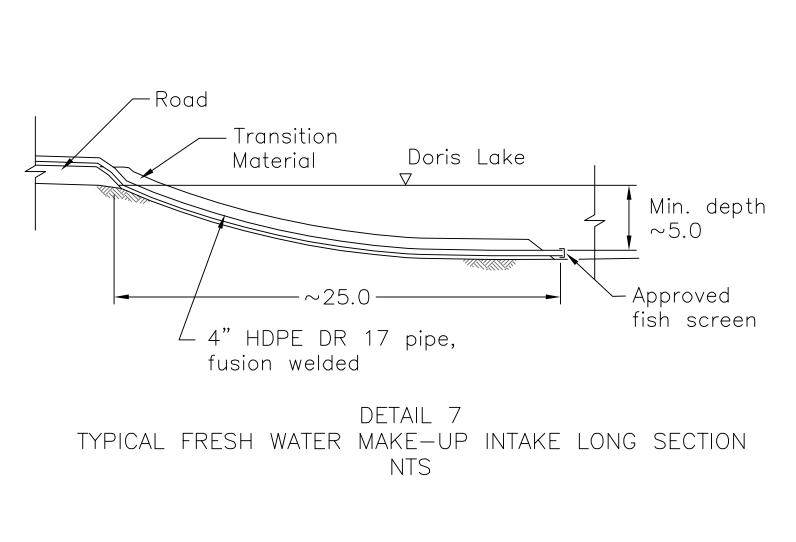


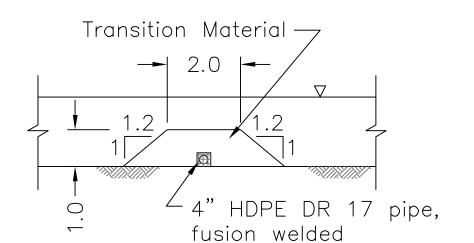

TYPICAL FRESH WATER MAKE-UP INTAKE CROSS SECTION NTS

Notes:

- 1. Pipe crossings shall be installed in such a fashion that overlapping pipes do not buckle. The Engineer will inspect and approve each crossing and may instruct Contractor to place pipe bedding material to protect pipes at crossings.
- 2. The final location and orientation of all valves will be confirmed on site by the Engineer.
- 3. The tailings slurry and decant pipelines shall be pre-insulated in accordance with the approved Specifications.
- 4. The reclaim and fresh water make—up pipelines shall be pre—insulated and heat traced in accordance with the approved Specifications.
- 5. The fresh water make—up pipeline inlet in Doris Lake shall have an approved fish screen based on the 1995 Department of Fisheries and Oceans "Freshwater Intake End-of-Pipe Fish Screen Guidelines".
- 6. Tailings slurry and reclaim drain pipelines into Emergency Dump Catch Basins, shall terminate at the freeboard elevation within the Emergency Dump Catch Basin. This determination shall be made on site by the Contractor and confirmed by the Engineer.

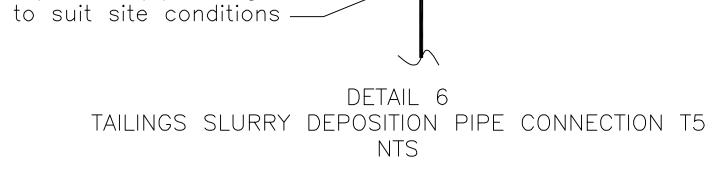

B WATER LICENCE APPLICATION A WATER LICENCE APPLICATION DRAWING NO. DRAWING TITLE DRAWING NO. DRAWING TITLE CHK'D APP'D DATE DESCRIPTION REFERENCE DRAWINGS REVISIONS

(knife gate or

similar), flanged

to suit site conditions

DETAIL 5

TAILINGS SLURRY DEPOSITION PIPE CONNECTION T2, T3 & T4

NTS

Stamped, signed and dated originals submitted to the Nunavut Water Board

SRK Consulting Engineers and Scientists DESIGN: DRAWN: REVIEWED:

CHECKED: APPROVED: Mar. 2007 PROFESSIONAL ENGINEERS STAMP FILE NAME: figure 1[1].1.dwg

MIRAMINR HOPE BAY LTD. **DORIS NORTH PROJECT DETAILED DESIGN**


1CM014.008


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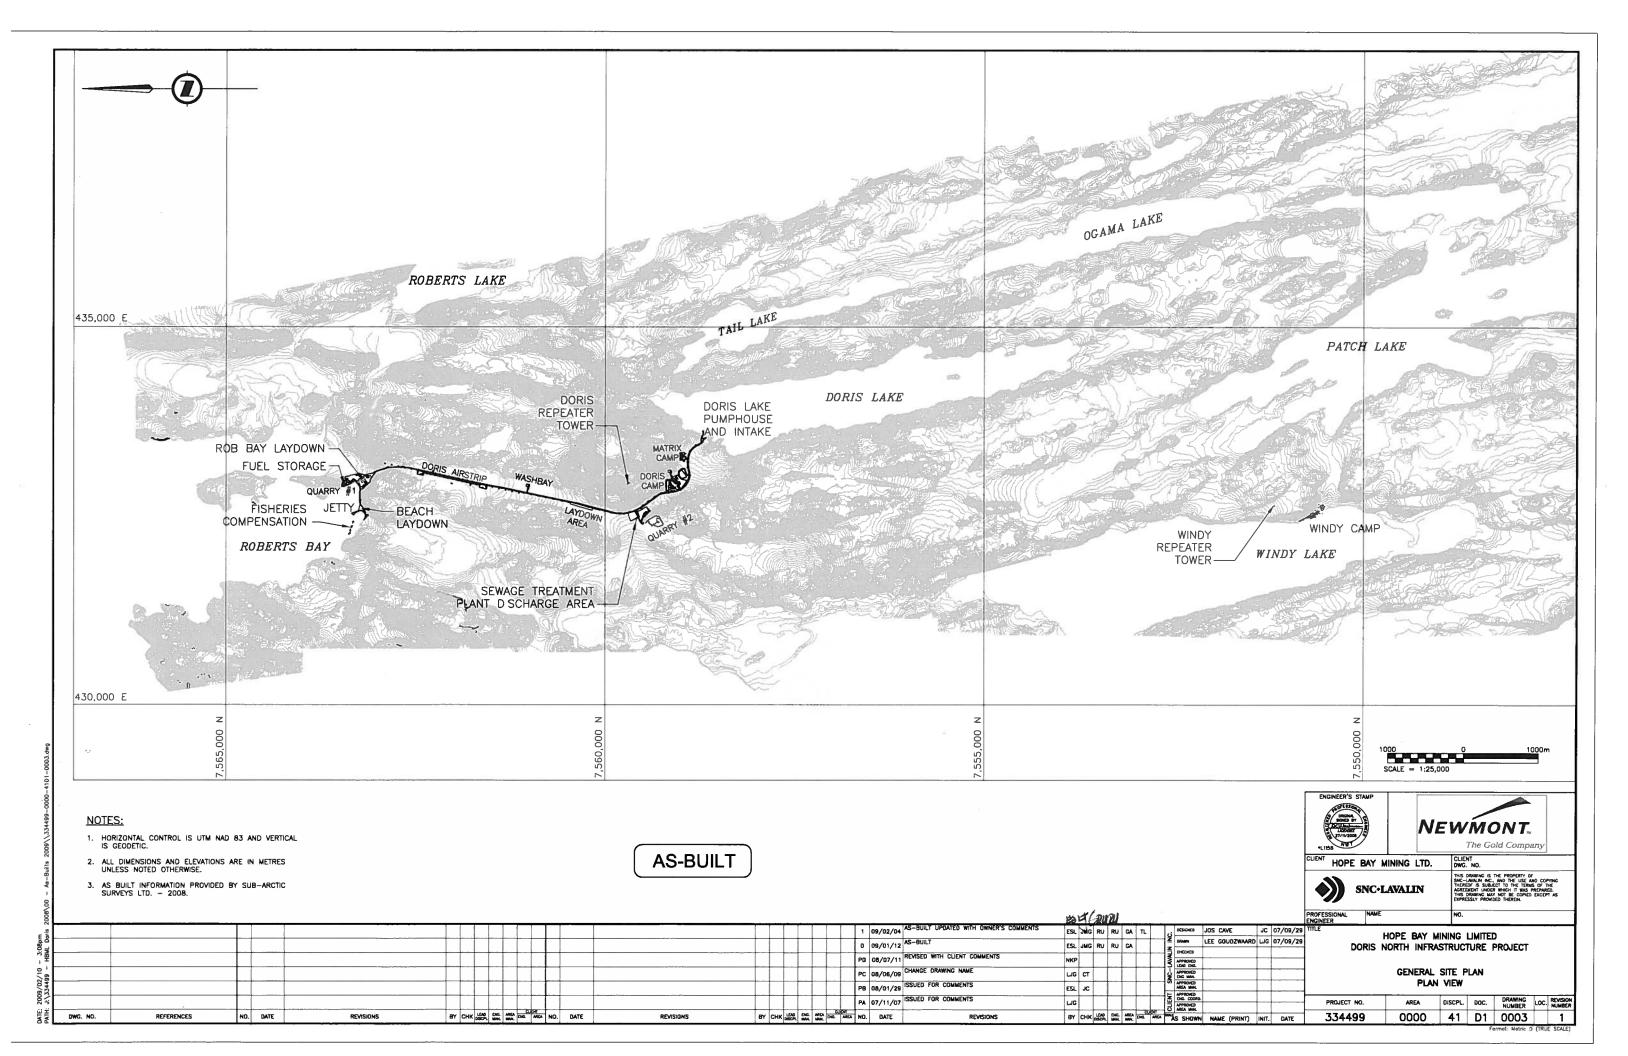
47 OF 49


4b Issued for Construction




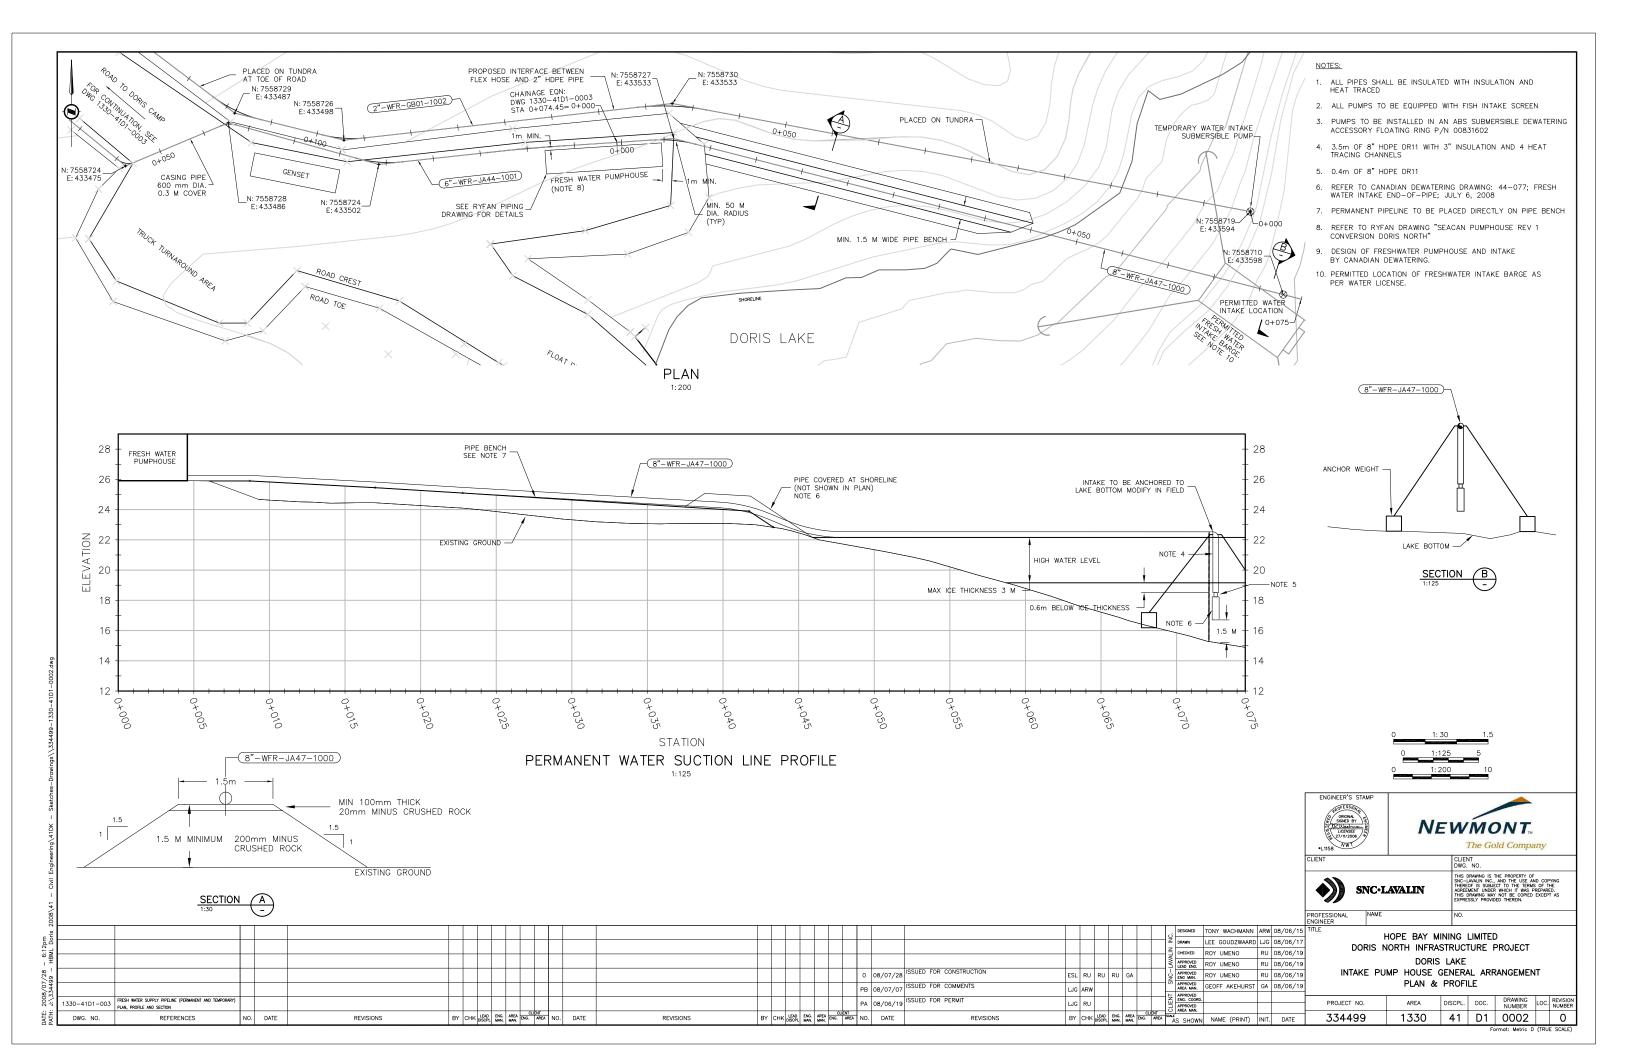

4c As-Built Drawings for Constructed Facilities

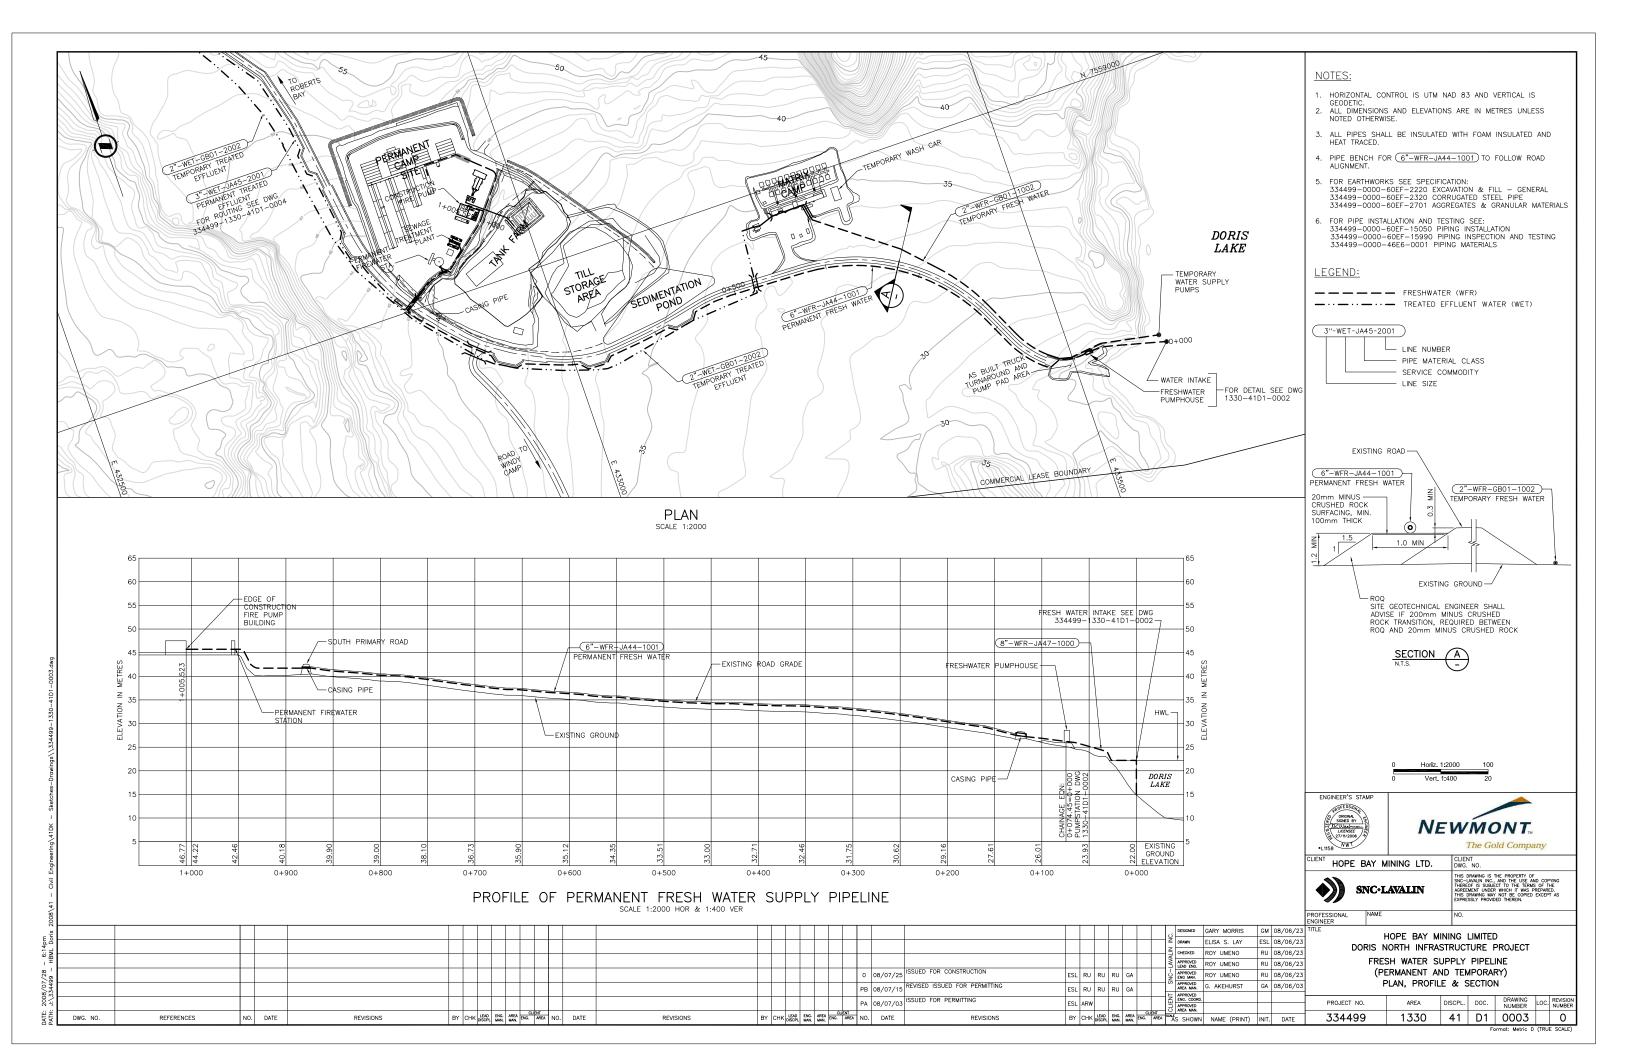


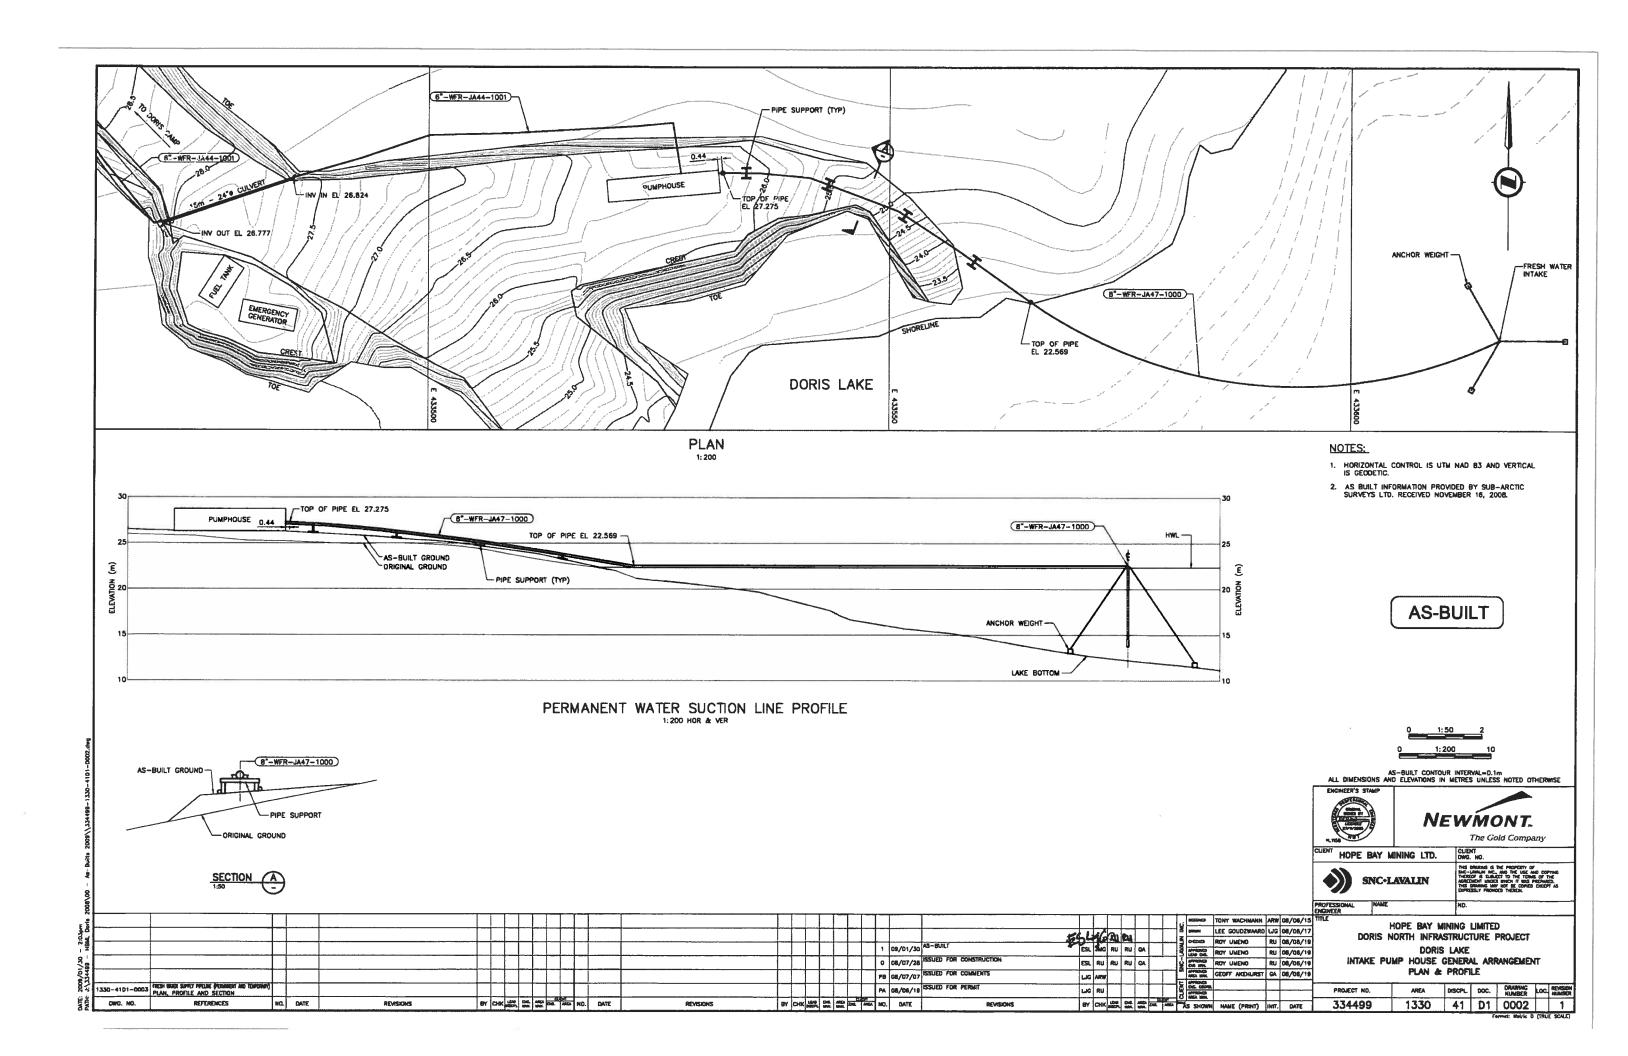

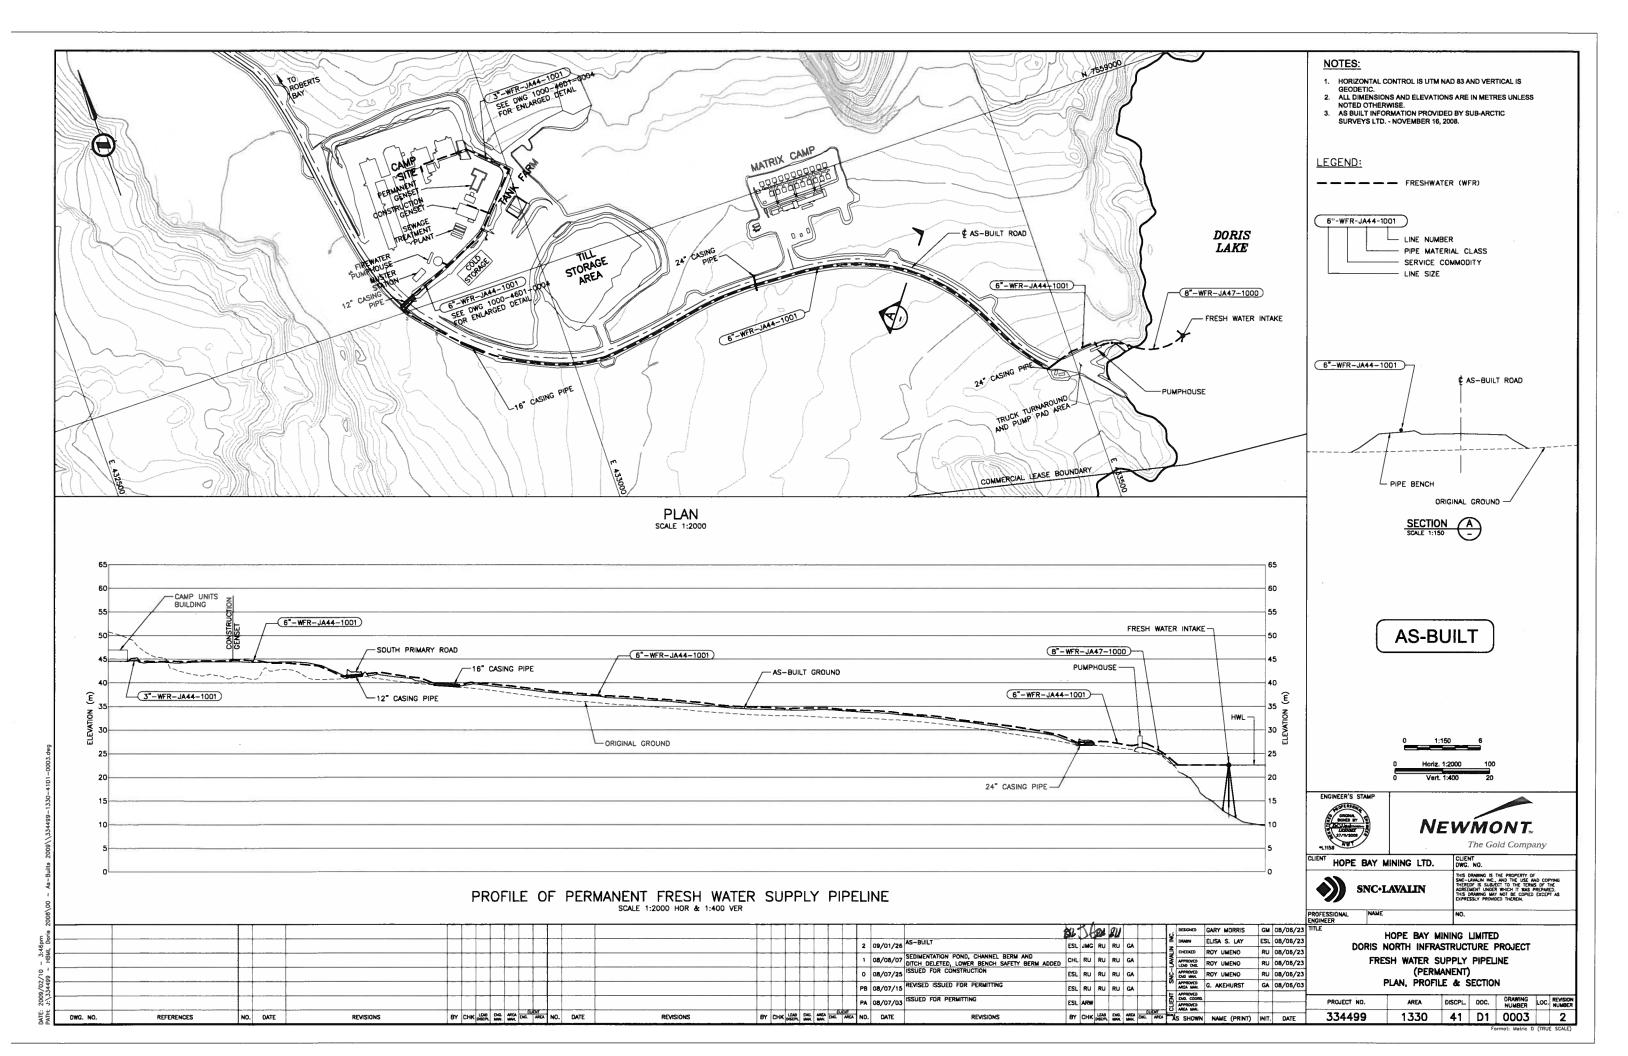

5. Fue	I Storage and Containme	nt Facility		



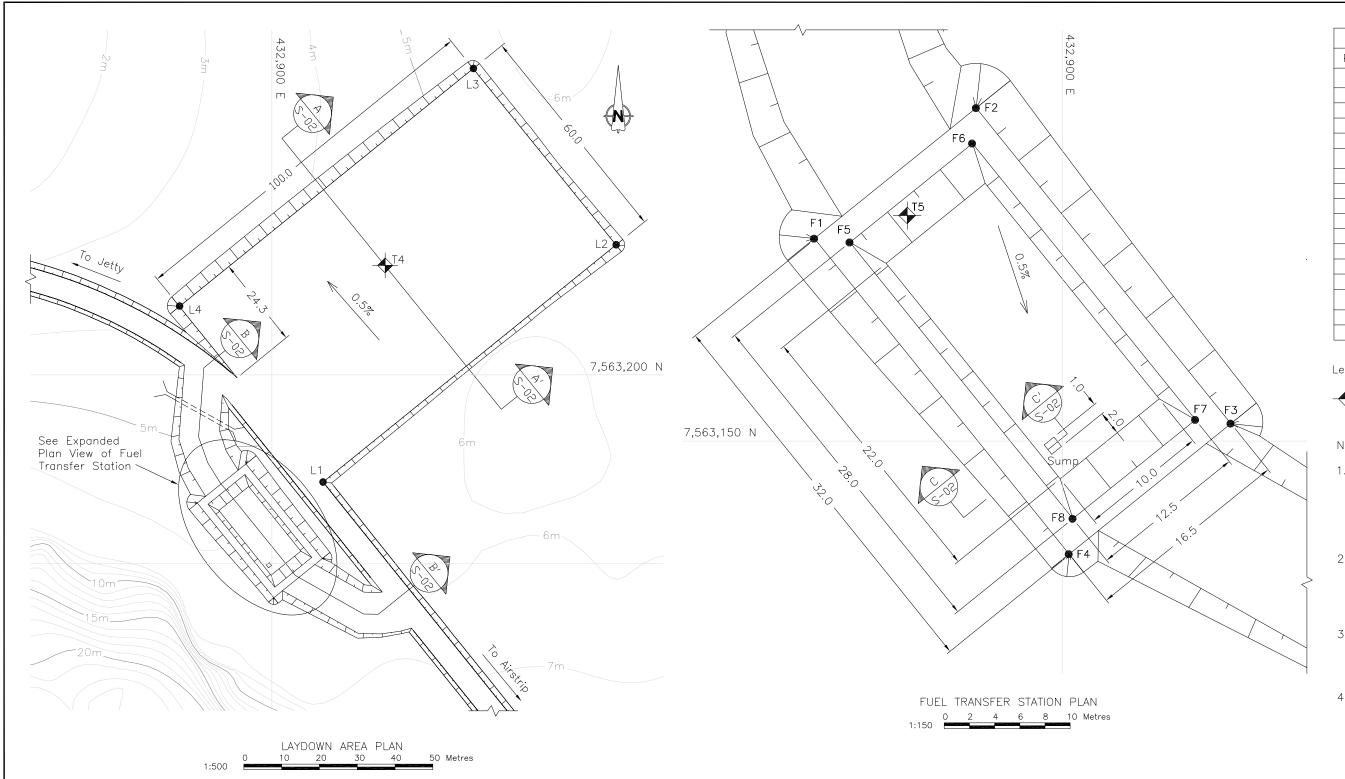

STAKE OUT TABLE					
Point	Northing	Easting			
Beach Laydown Area					
L1	432913.3	7563171.4			
L2	432991.0	7563234.4			
L3	432953.3	7563281.0			
L4	432875.6	7563218.1			
Fuel Transfer Station					
F1	432880.3	7563166.1			
F2	432893.1	7563176.4			
F3	432913.4	7563151.4			
F4	432900.5	7563141.0			
F5	432883.1	7563165.8			
F6	432892.8	7563173.6			
F7	432910.5	7563151.7			
F8	432900.8	7563143.8			
Thermistor Locations					
T4	432930.0	7563228.9			
T5	432887.7	7563167.9			


Legend:



Thermistor Location

Notes:

- 1. The Contractor shall supply and install thermistors in locations as indicated on the drawing. With approval from the Engineer the exact locations can be finalized on
- 2. The Contractor shall take all necessary precautions to ensure that the thermistor cables, and their read—out boxes are not damaged during construction.
- 3. The Contractor shall be responsible to keep the Fuel Transfer Station dry and free of snow and ice during the construction period.
- 4. A Specialist Contractor will be responsible for the design, procurement and installation of all mechanical and/or electrical equipment at the Fuel Transfer Station. The details of these elements are not indicated on the drawing.

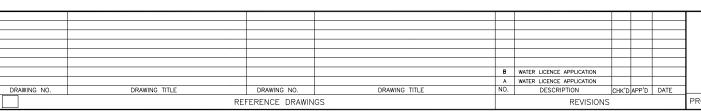


Stamped, signed and dated originals submitted	SRK Consulting Engineers and Scientists			
to the Nunavut Water Board	DESIGN:	DRAWN: JJH	REVIEWED: EMR	
Hator Board	CHECKED: AT	APPROVED: EMR	DATE: Mar. 2007	
PROFESSIONAL ENGINEERS STAMP	FILE NAME: FUEL TRAN	NSFER AND LAYDOWNrev1.	dwg	


MIRAMAR **DORIS NORTH PROJECT DETAILED DESIGN** SRK JOB NO.: 1CM014.008


Doris North Project

Beach Laydown Area and Fuel Transfer Station Plan

SHEET 9 OF 49 S-01 В

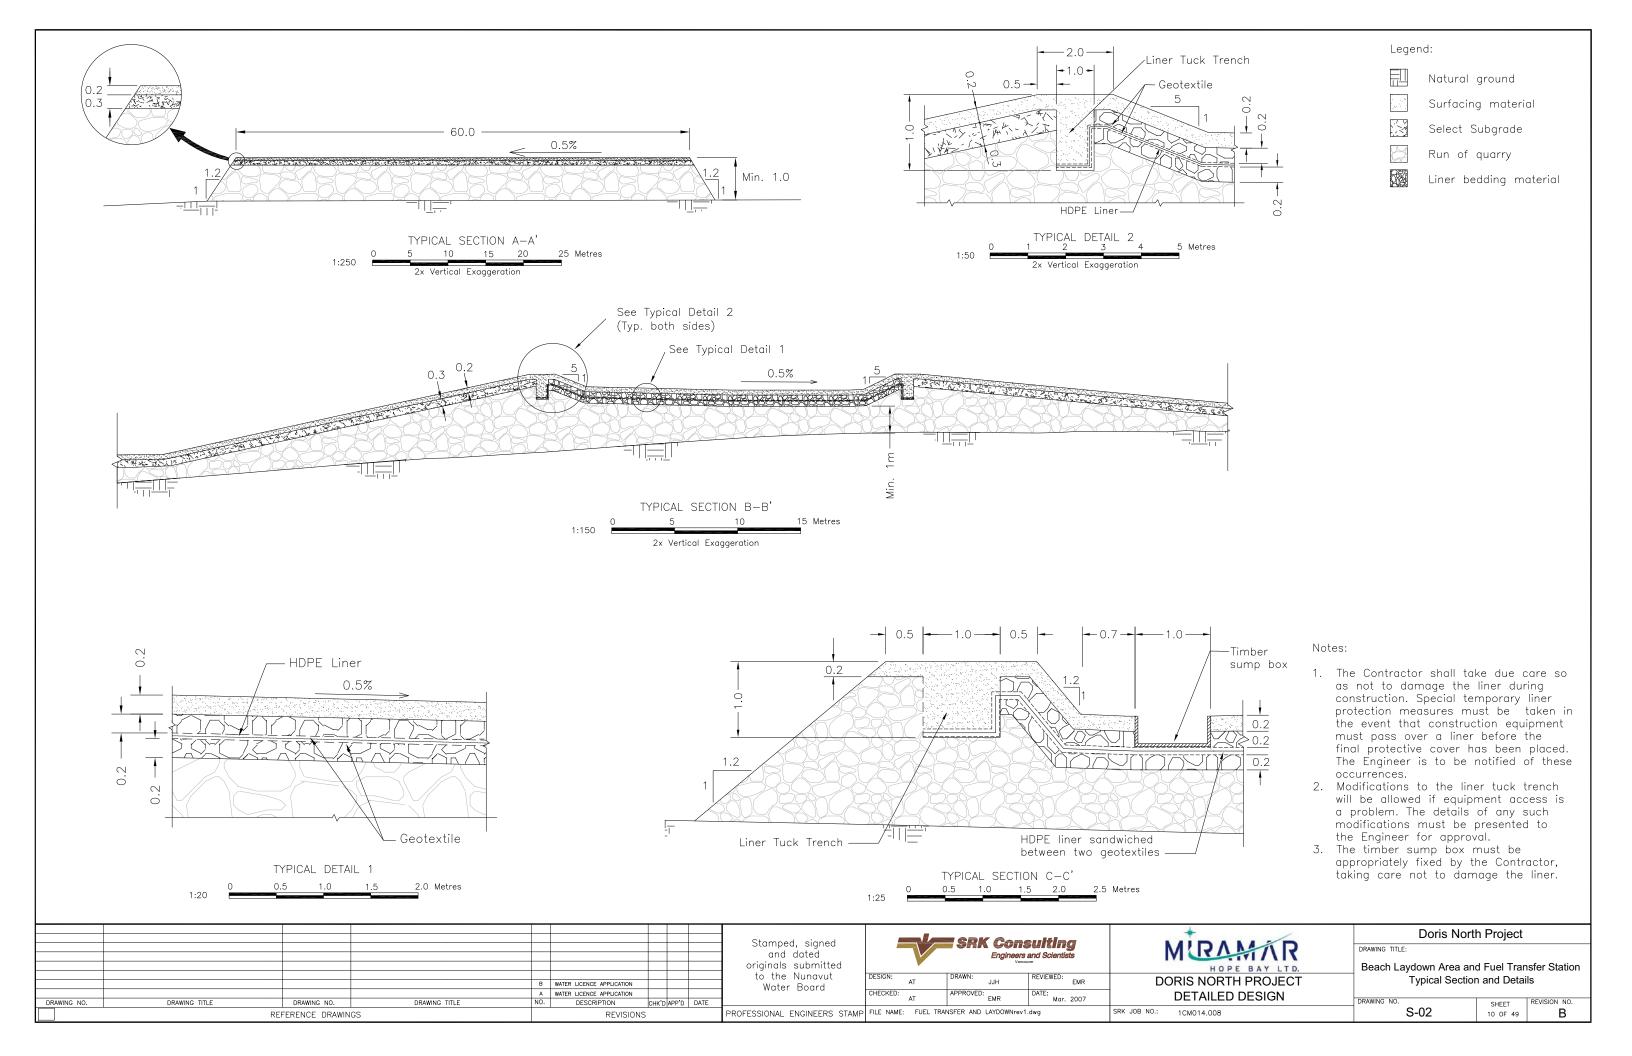


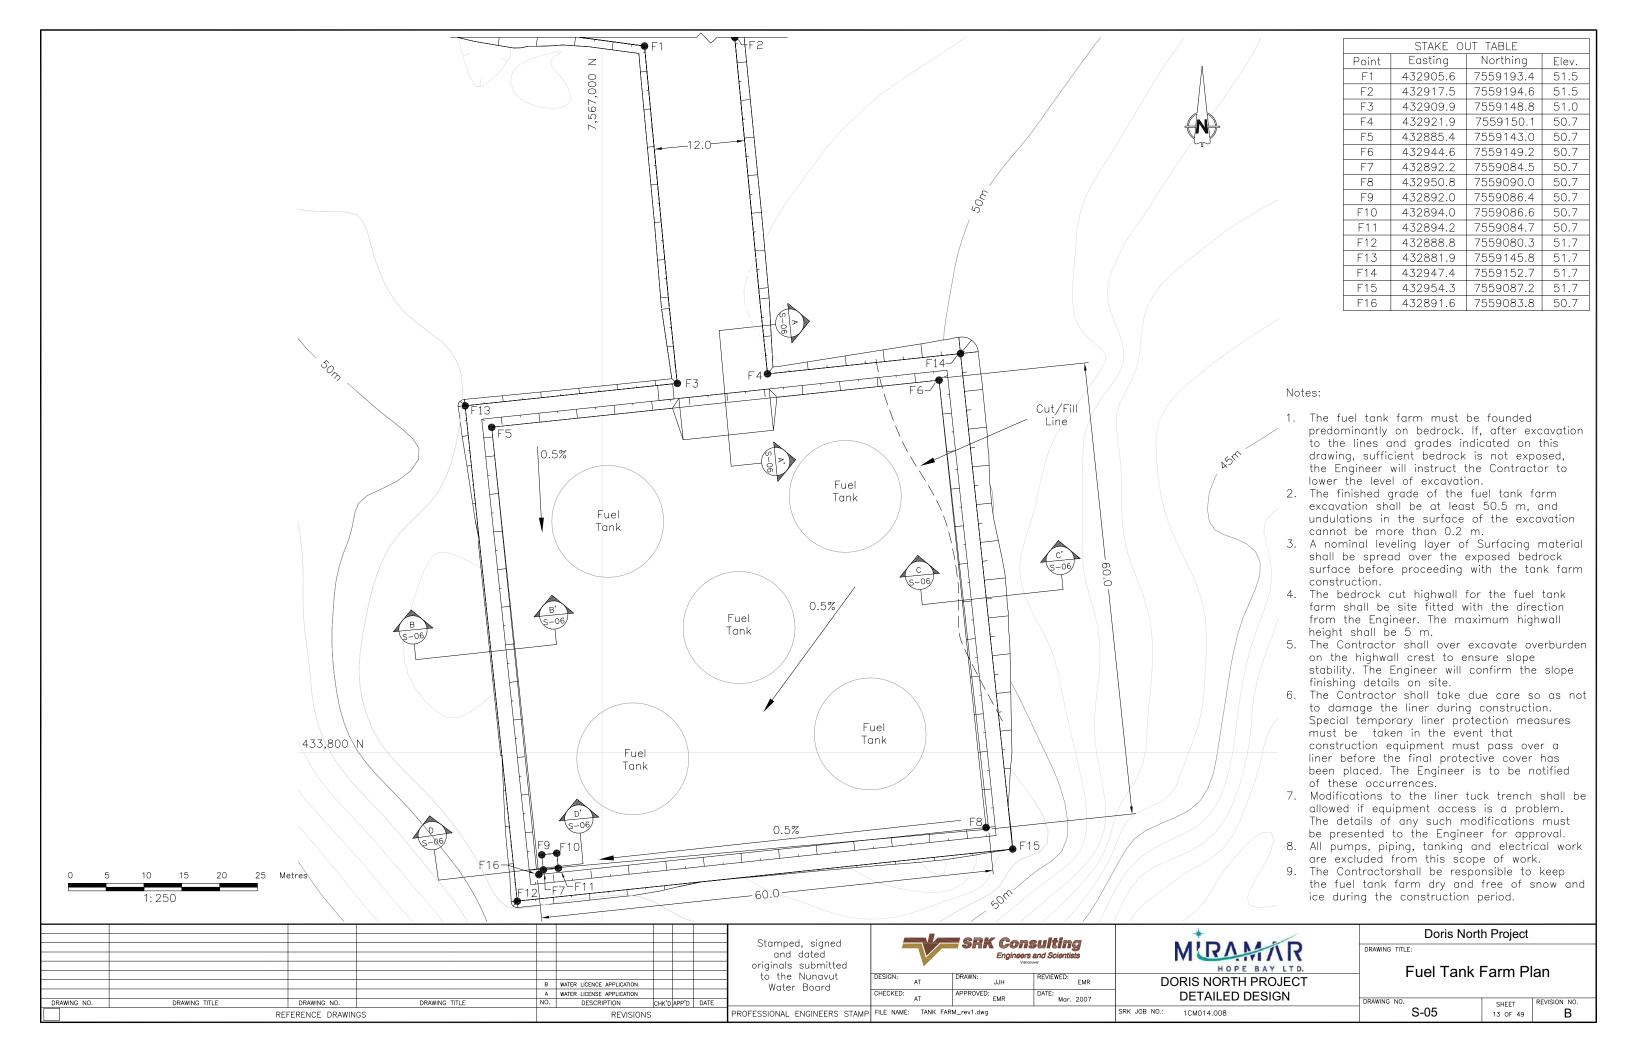

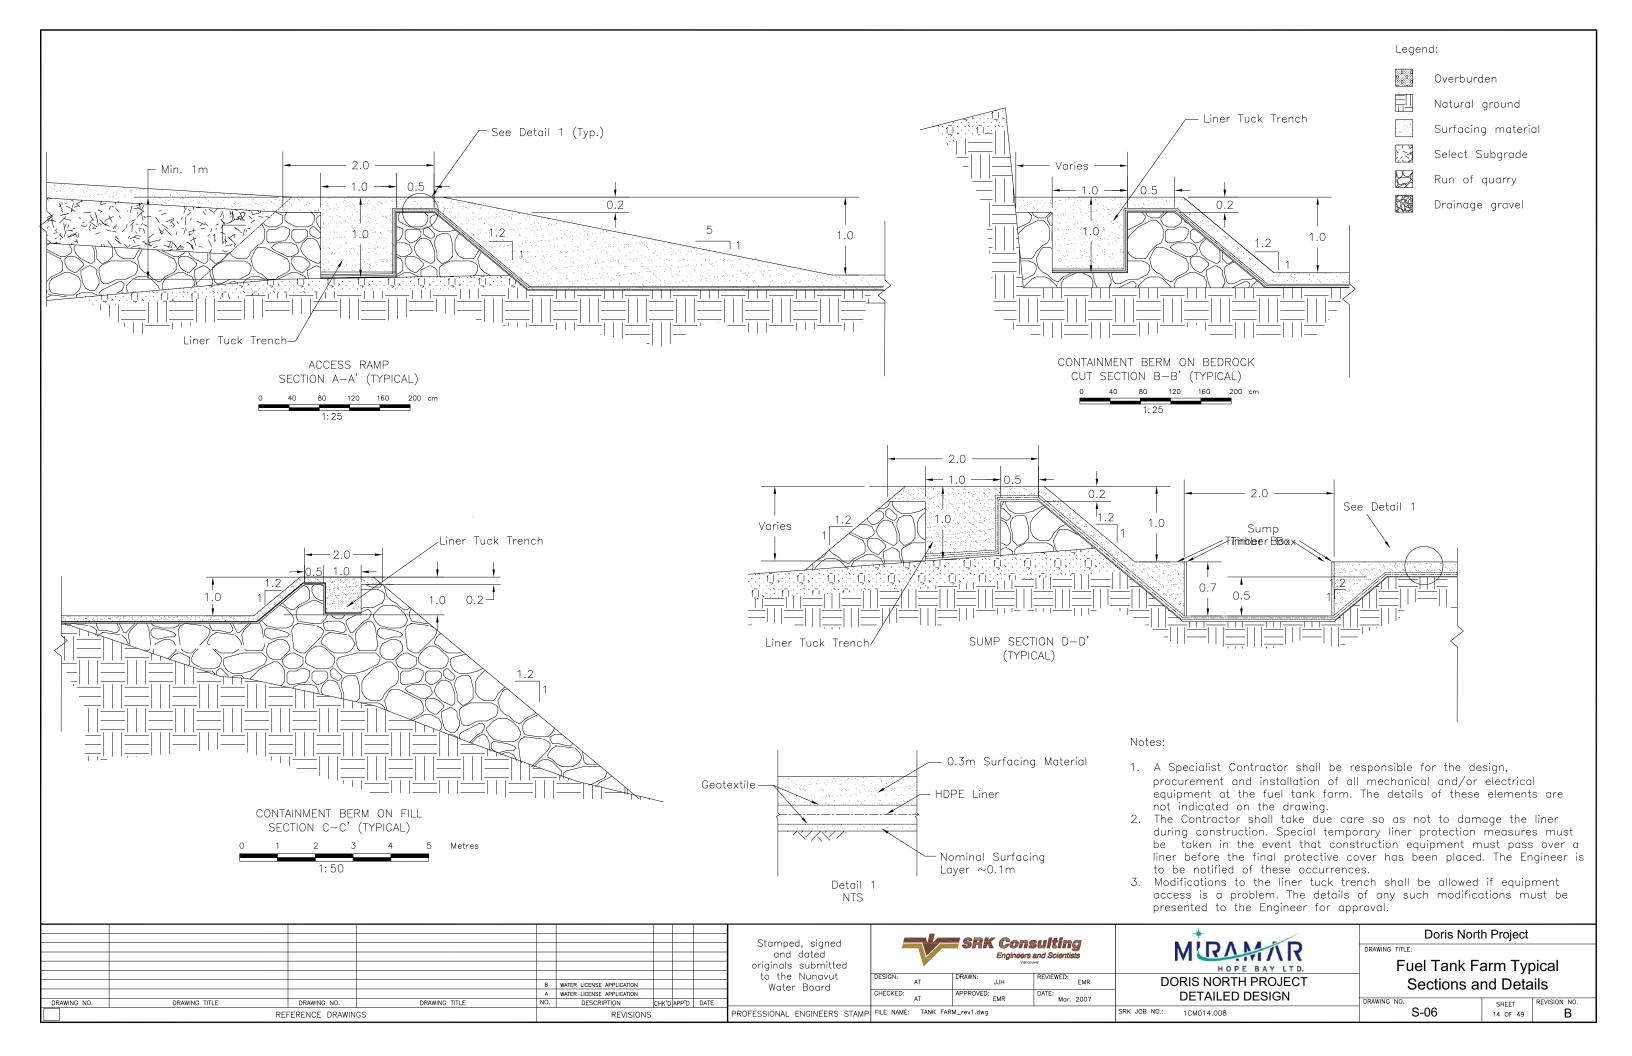



Miramar Hope Bay Ltd.
Water License Pre-Hearing Technical Meeting Information Supplement
Doris North Project, Nunavut
June 2007


Figure 1: Roberts Bay Fuel Tank Facility

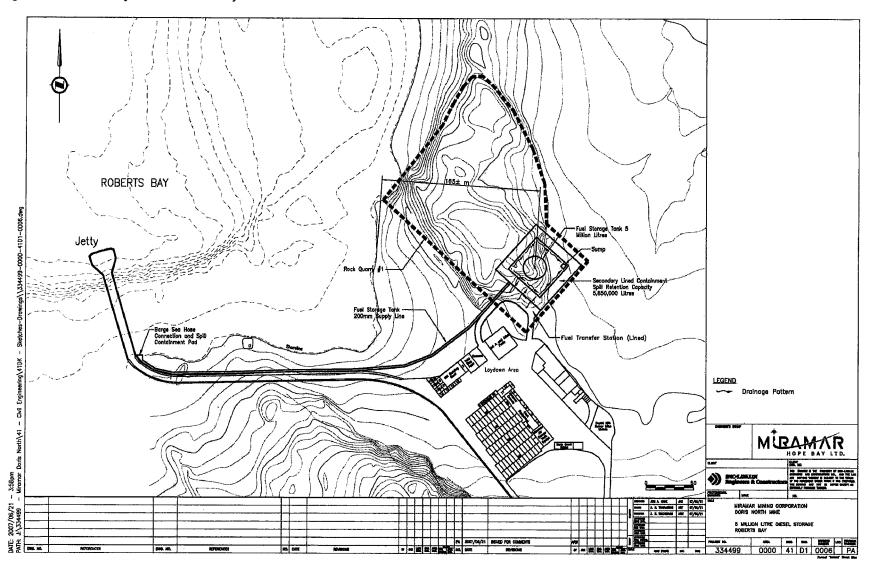



5b Issued for Construction

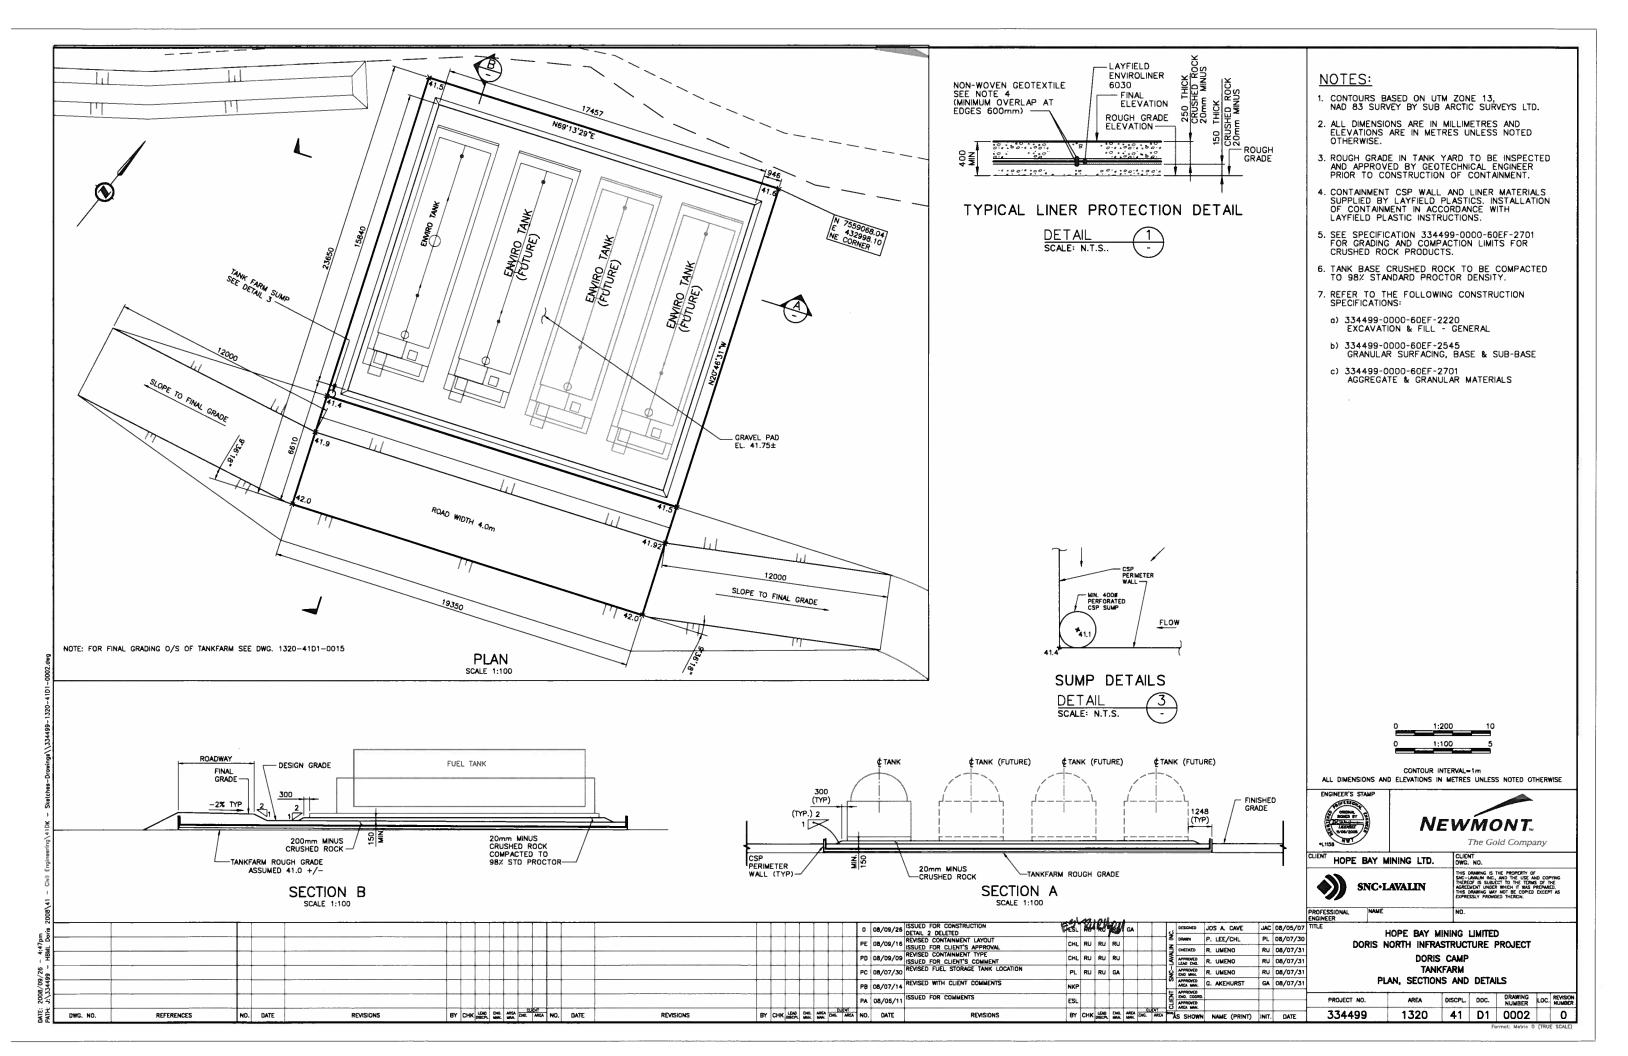


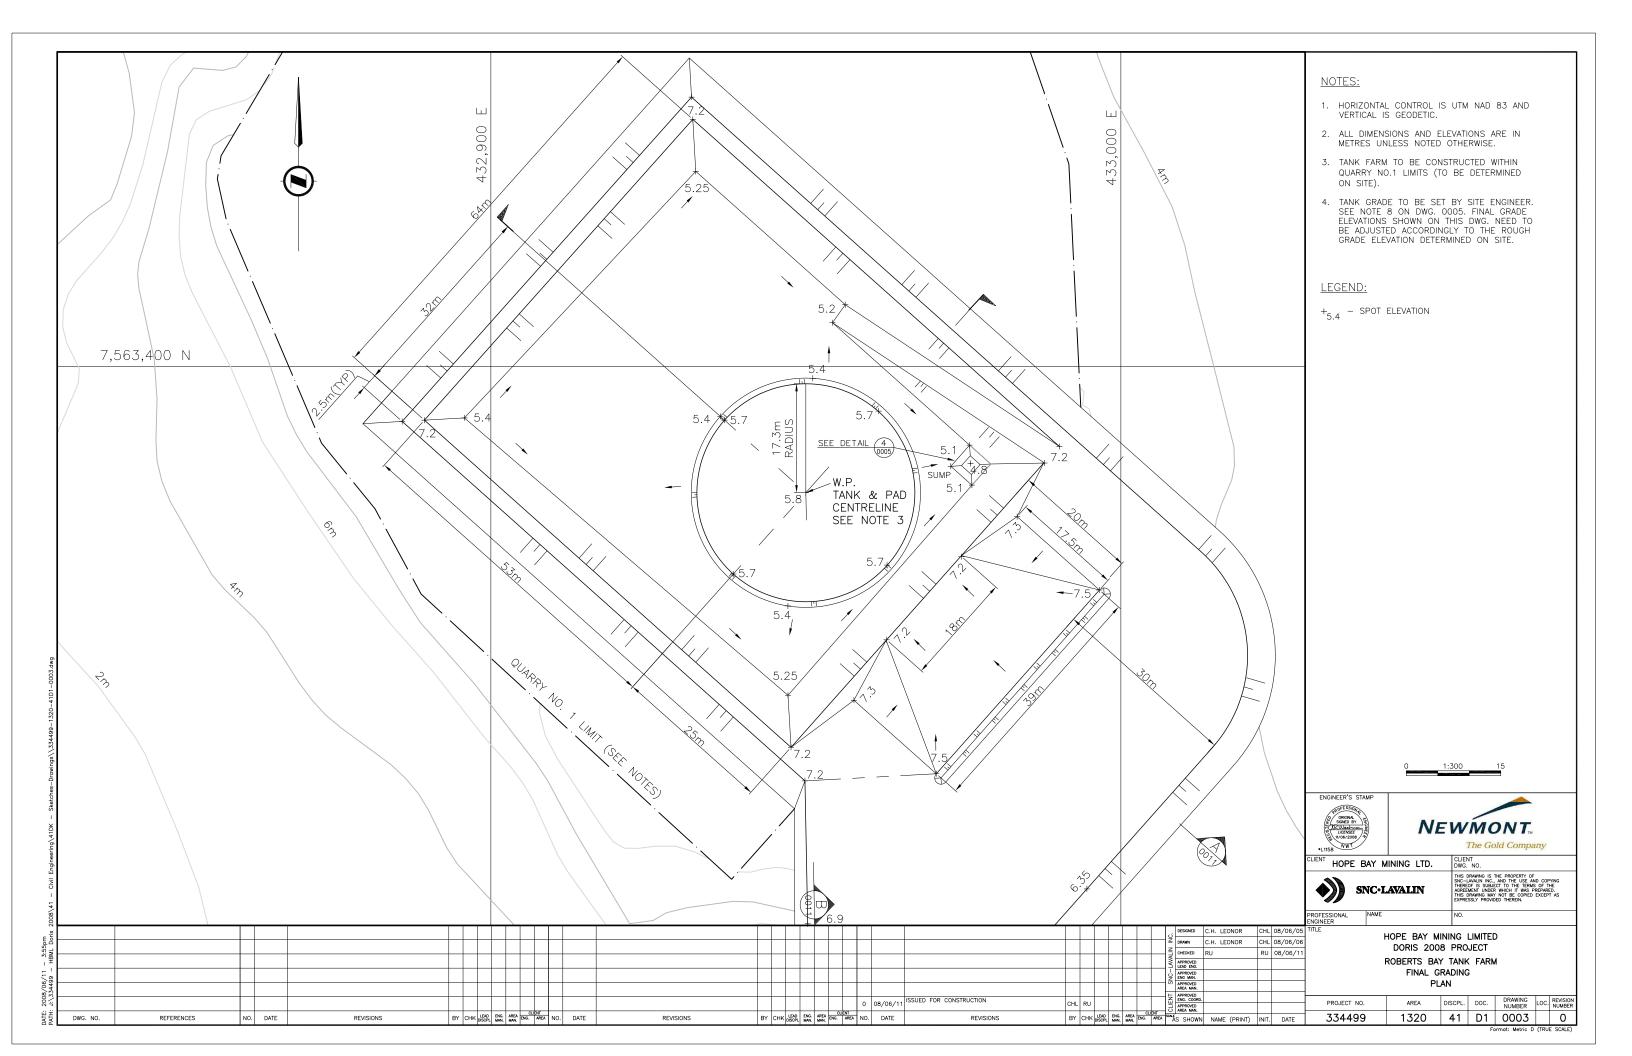

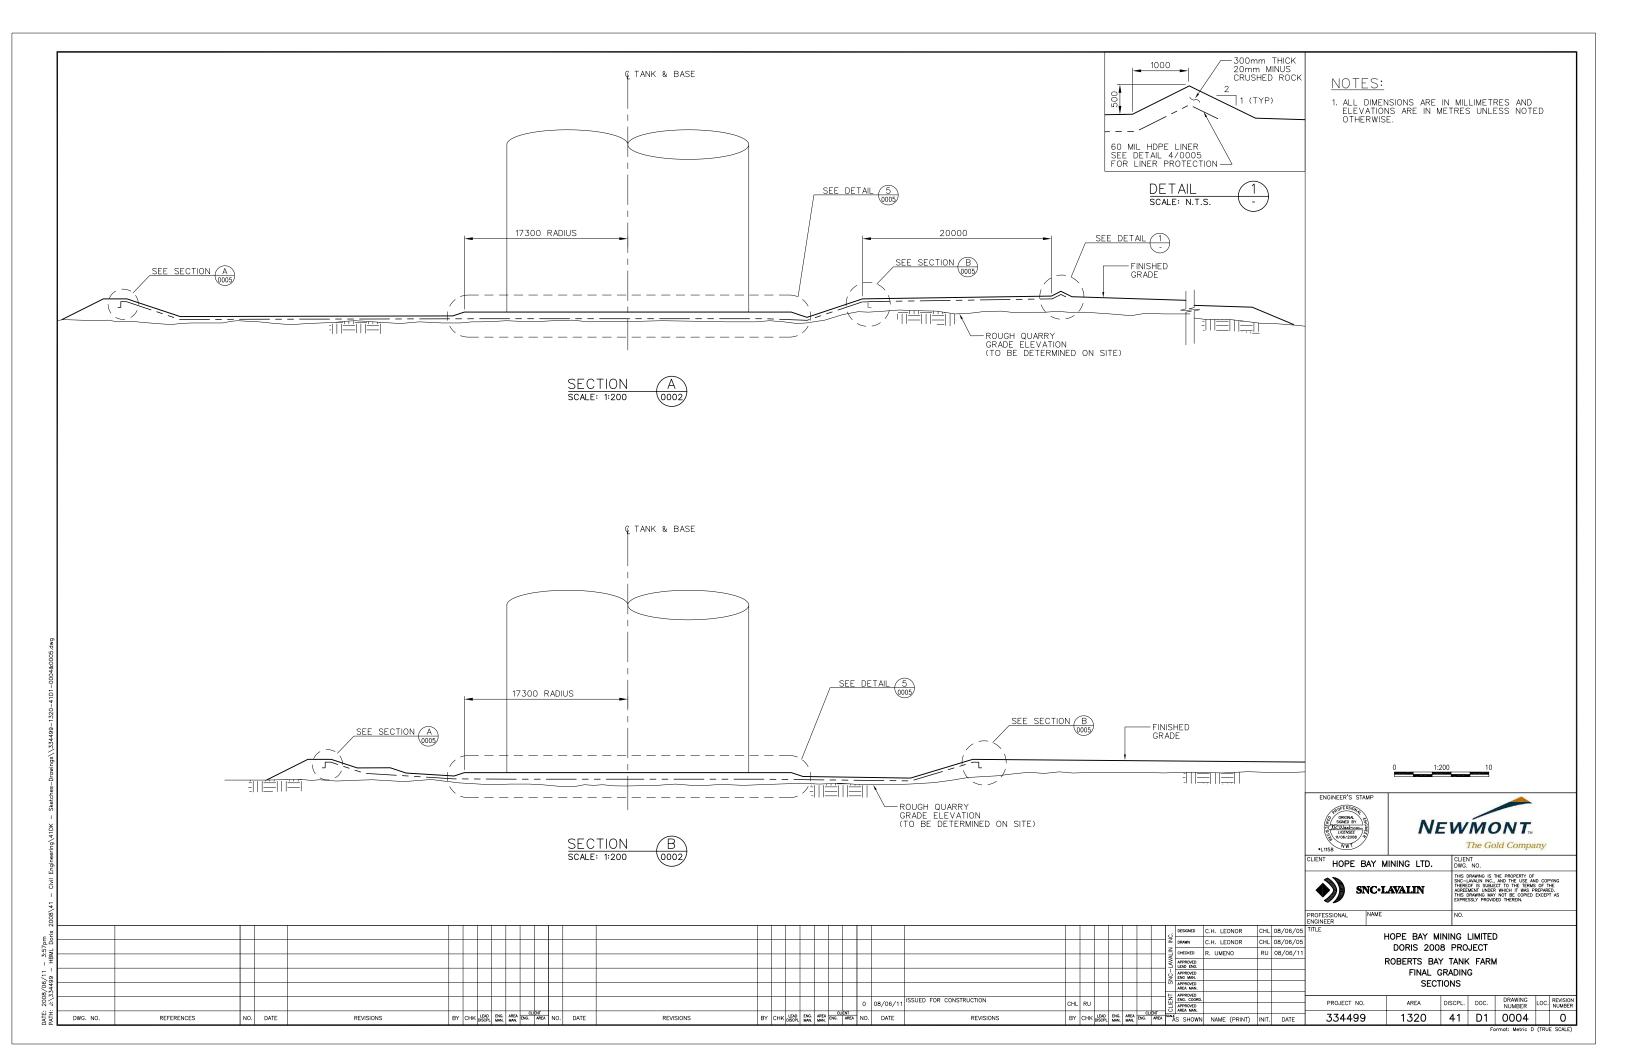


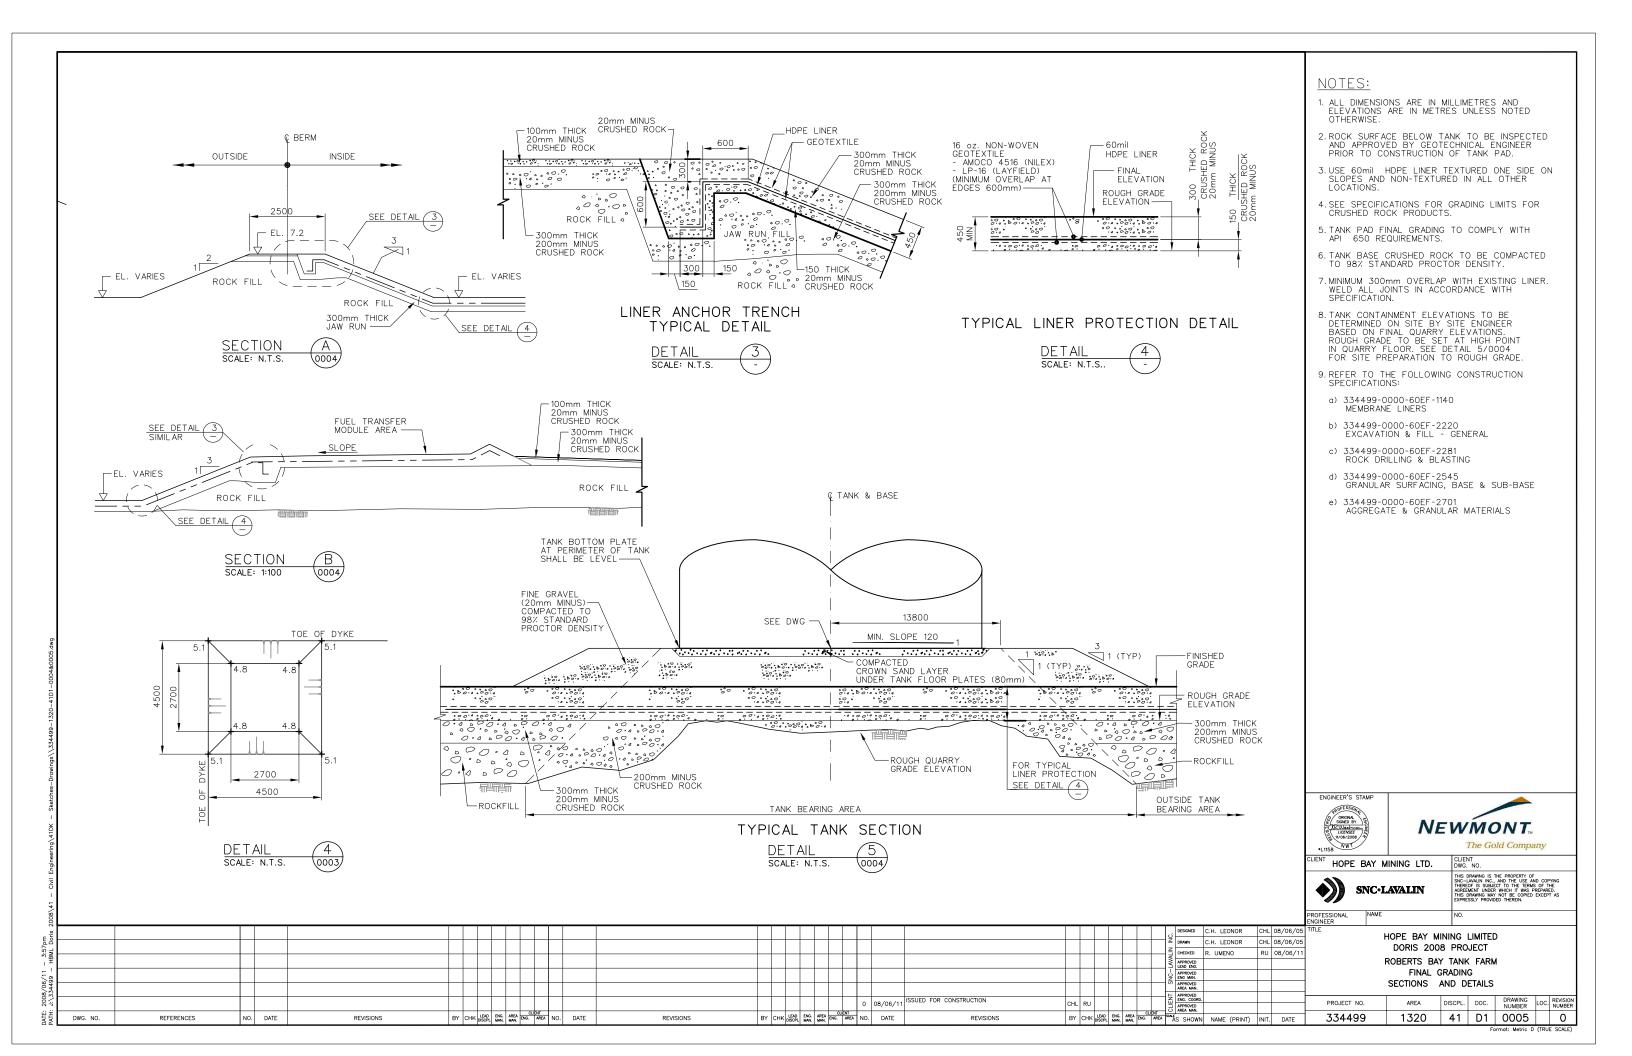


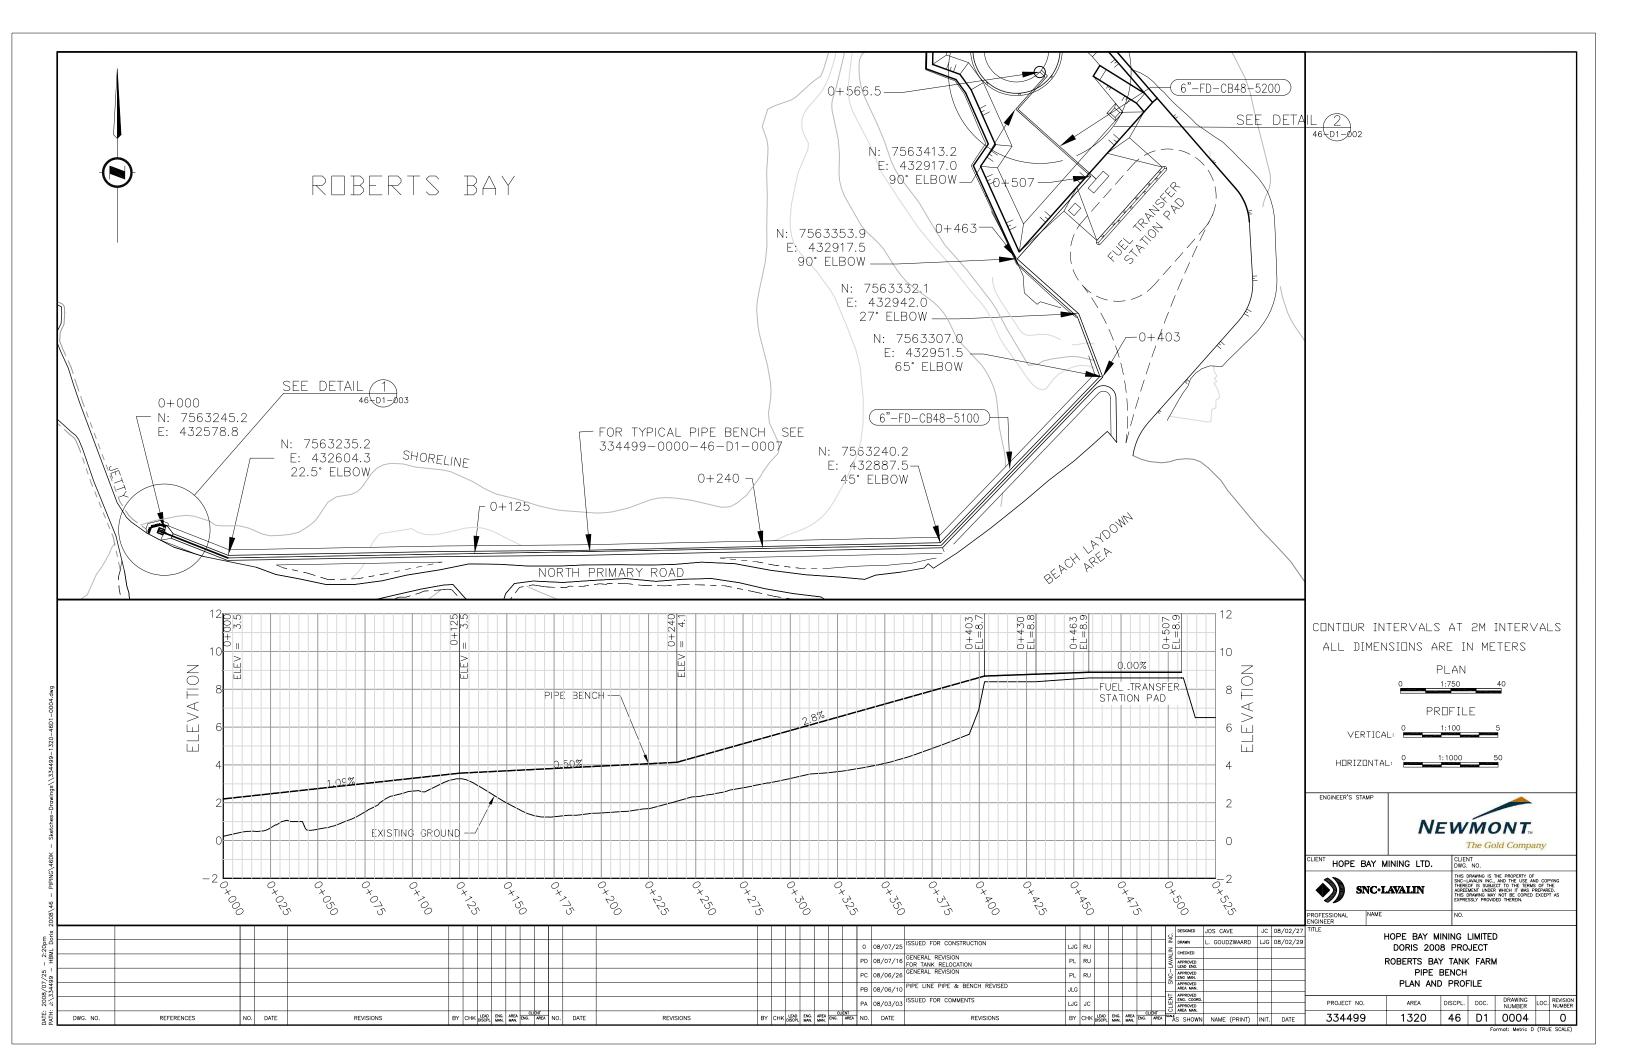


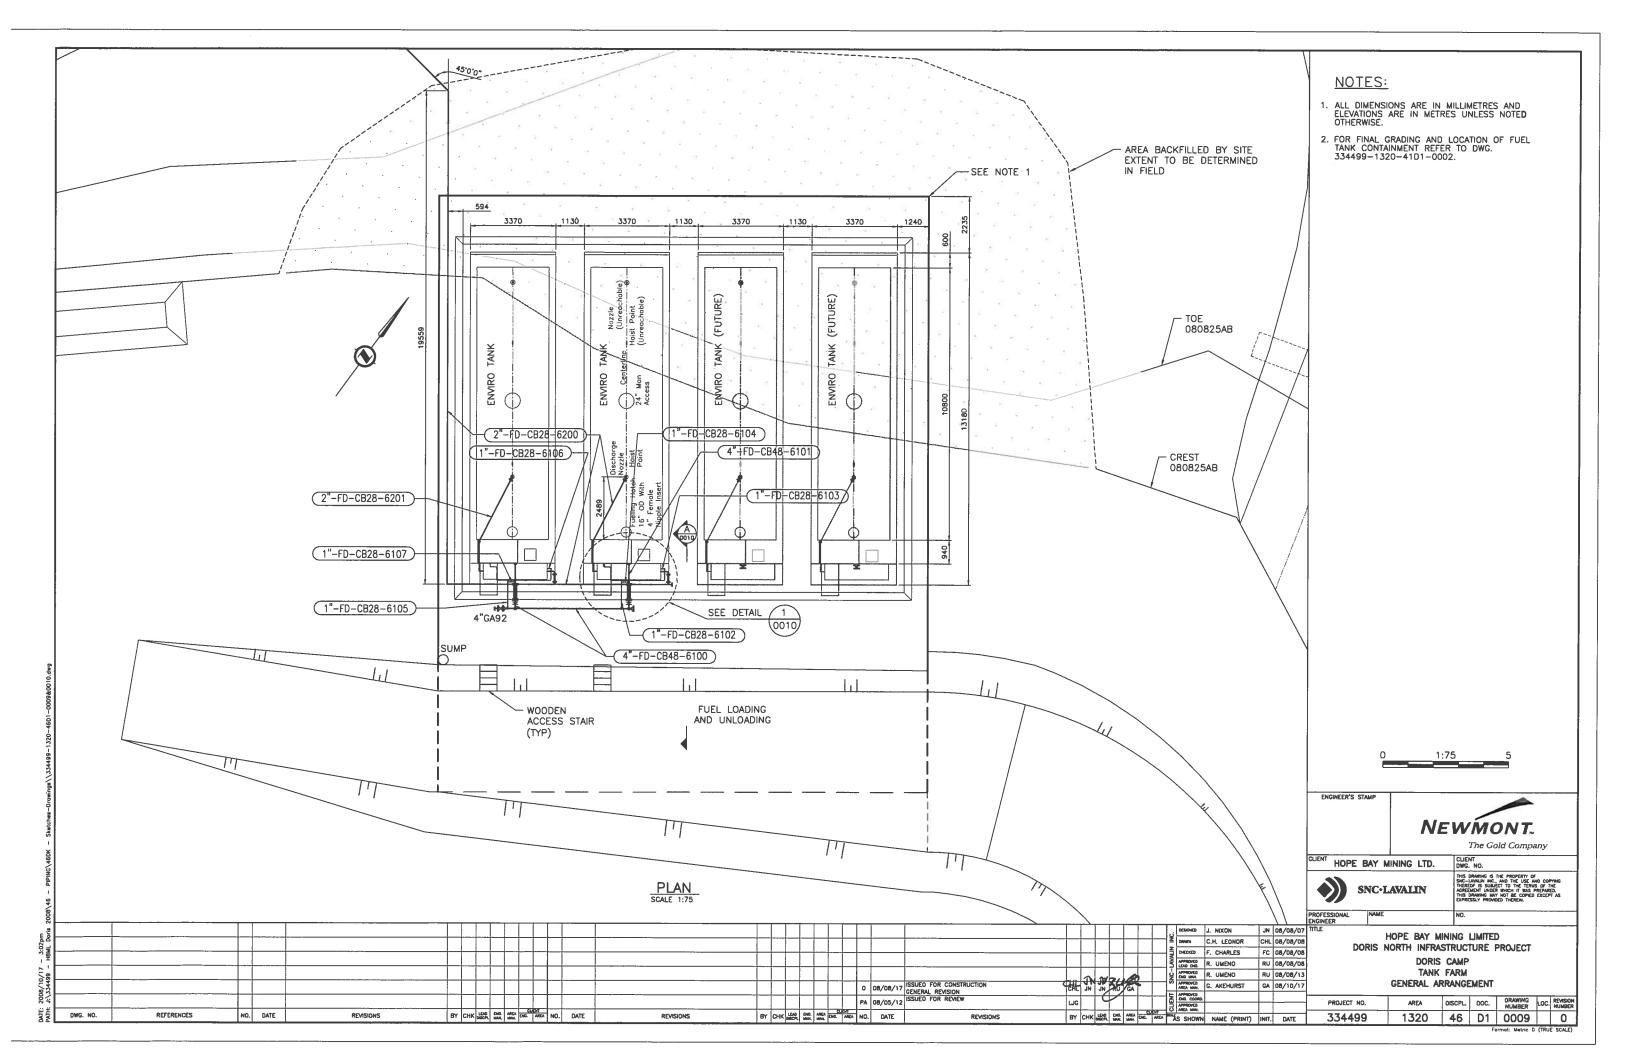


5c As-Built Drawings for Constructed Facilities

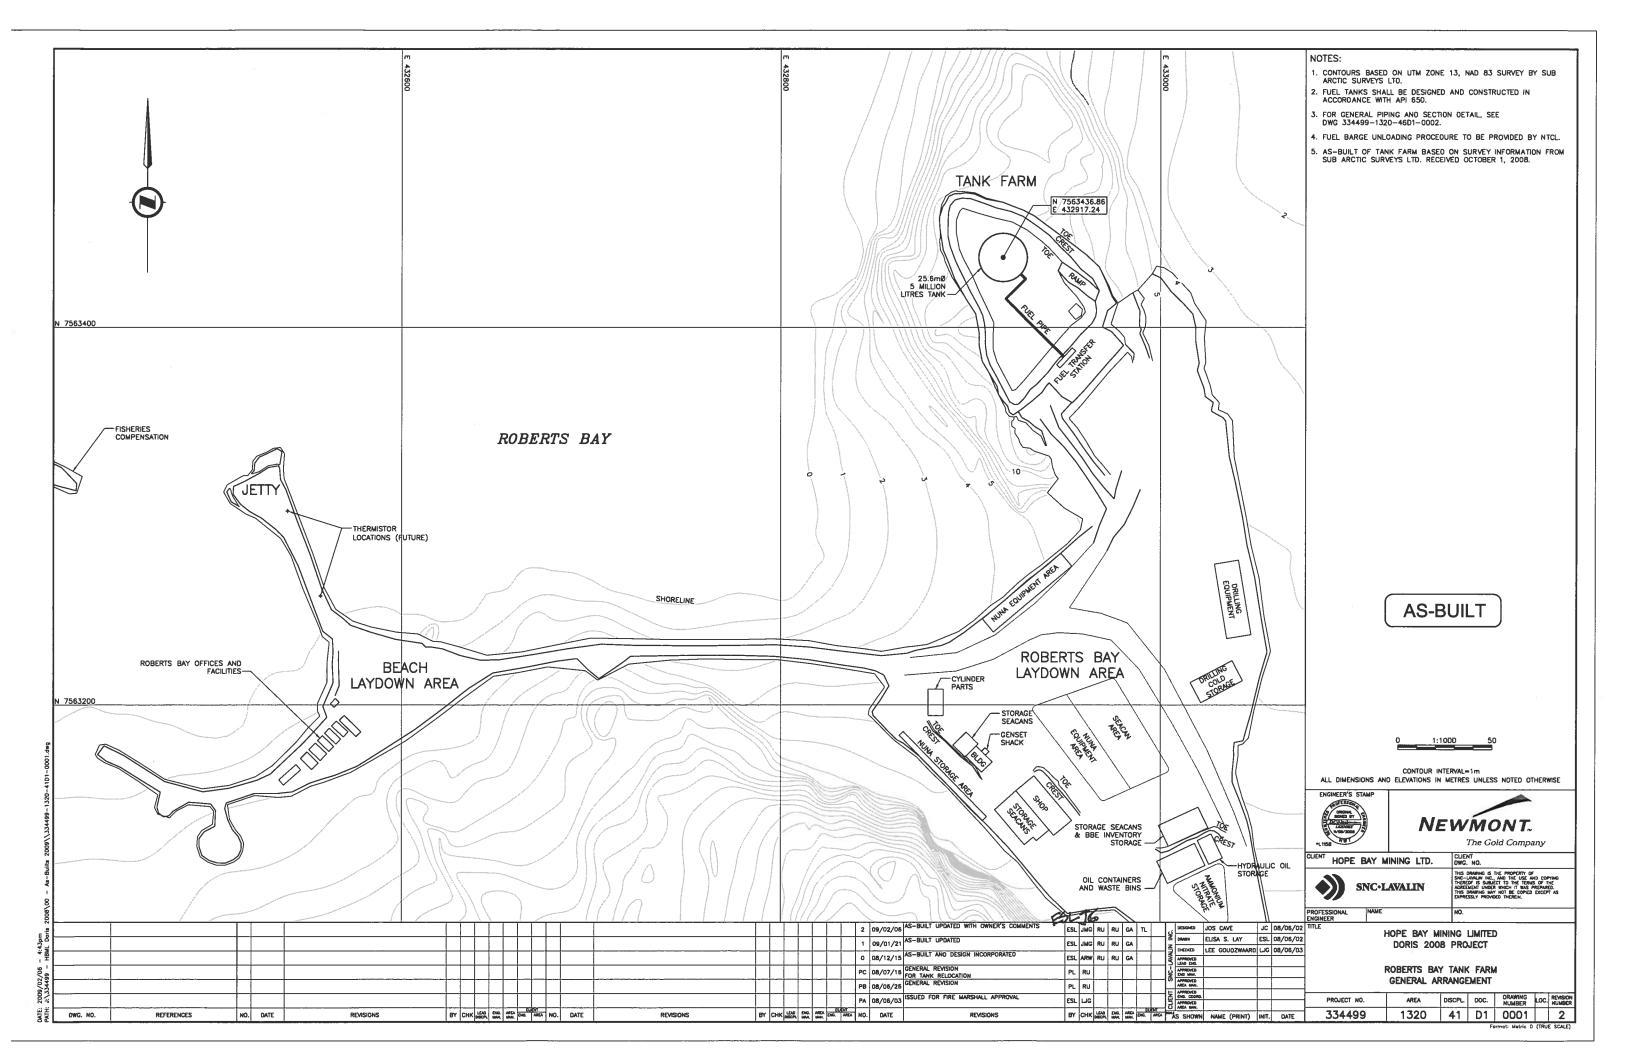


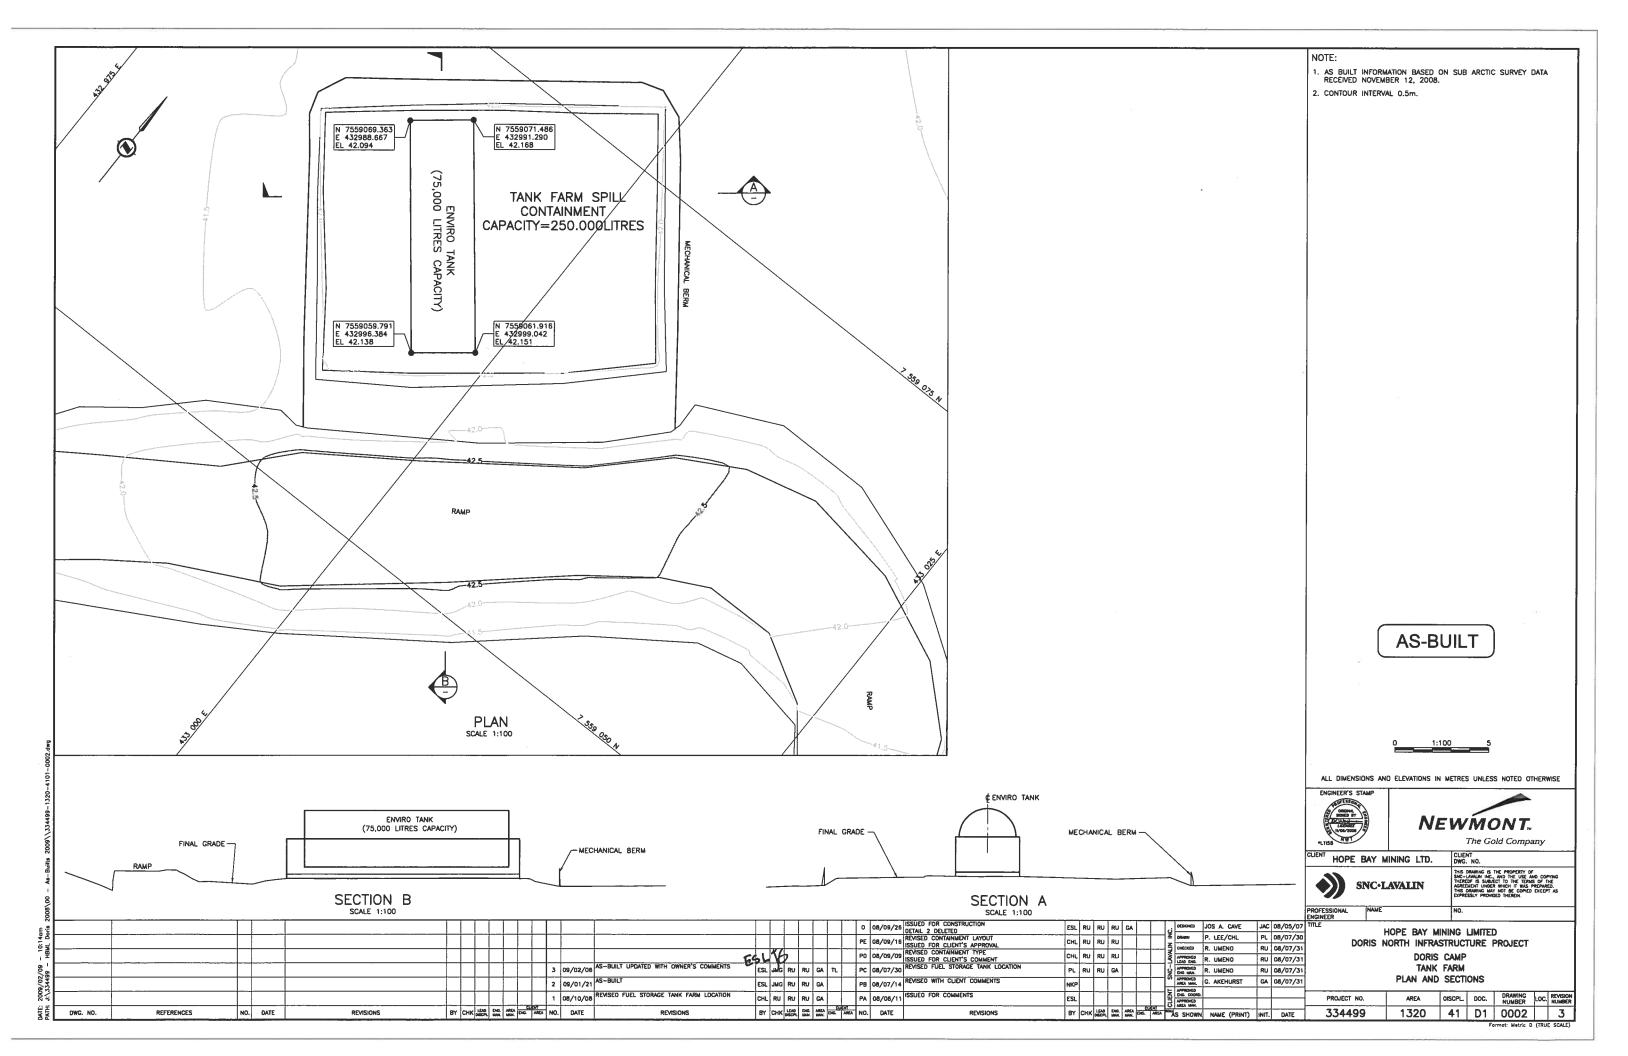

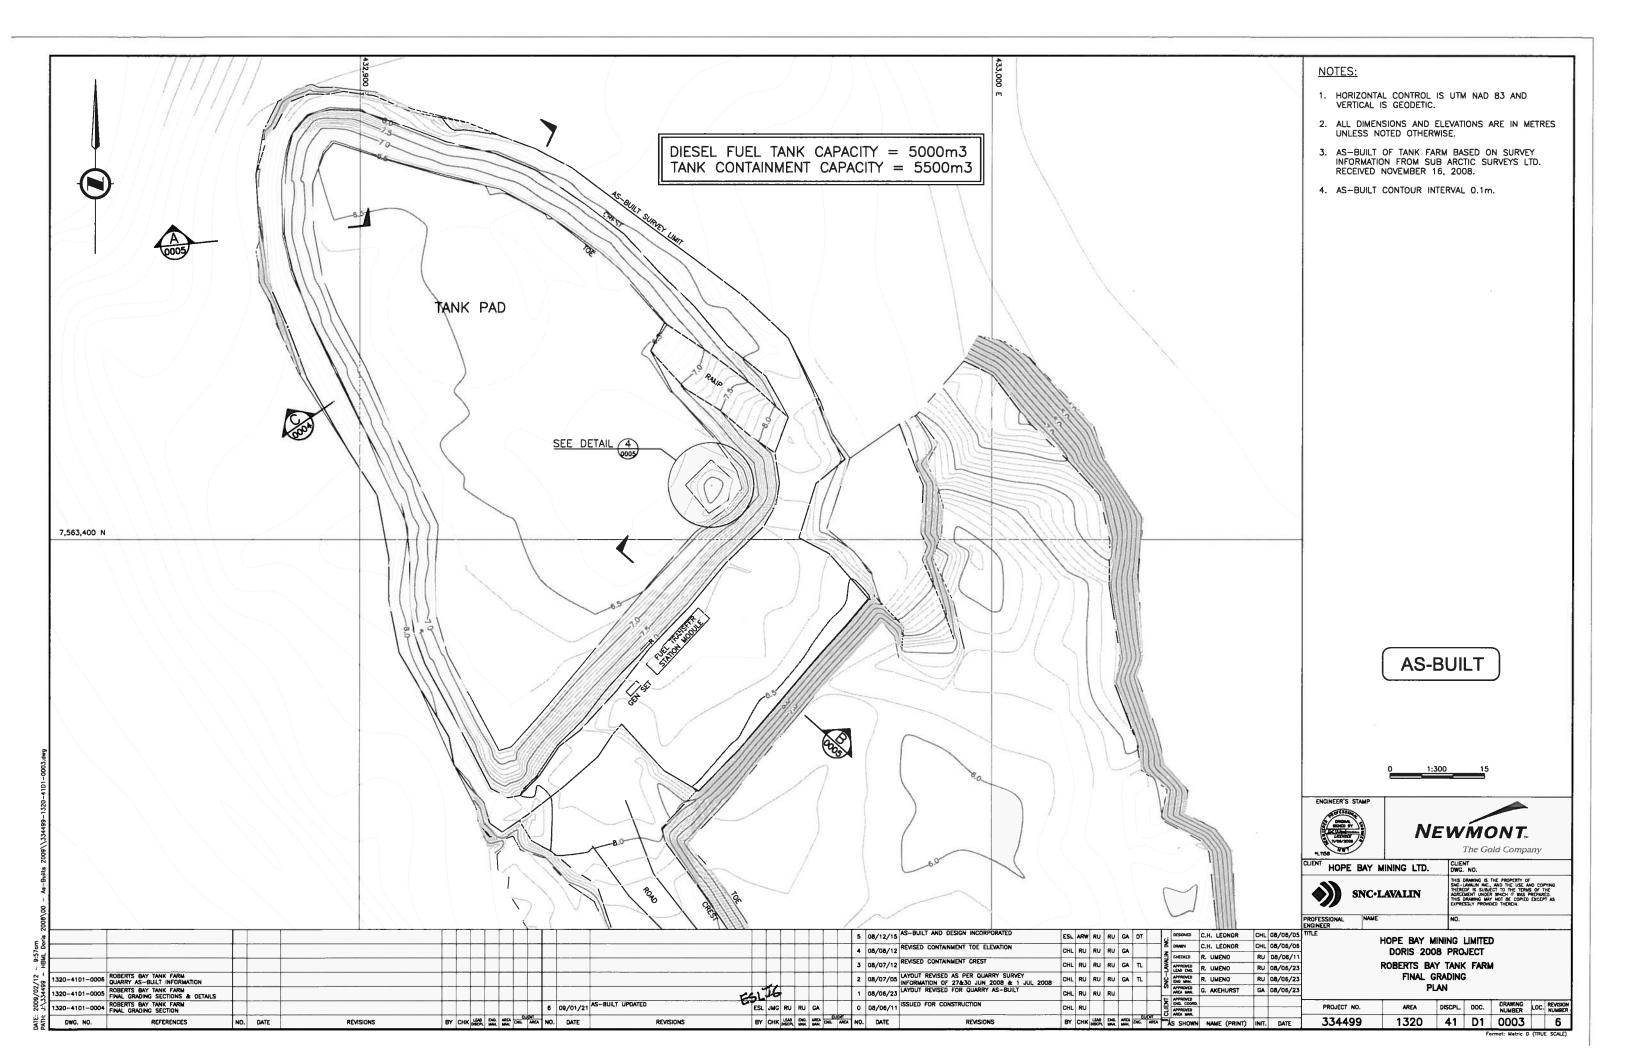


NOTES: 1. HORIZONTAL CONTROL IS UTM NAD 83 AND VERTICAL IS GEODETIC. 2. ALL DIMENSIONS IN MILLIMETRES AND ELEVATIONS ARE IN METRES UNLESS NOTEO AS-BUILT OF TANK FARM BASED ON SURVEY INFORMATION FROM SUB ARCTIC SURVEYS LTD. RECEIVED NOVEMBER 16, 2008. 4. QUARRY SUB-BASE - GRADE ELEVATION (SUB-ARCTIC SURVEYS LTD. - SURVEY 1 JULY 5. QUARRY LIMIT (SUB-ARCTIC SURVEYS LTD. SURVEY 27&30 JUNE 2008) ROBERTS BAY DIESEL FUEL TANK REFER TO DWG 334499-1320-41D1-0005 Rev 5 FOR LINER INSTALLATION SECTION. € 25.6m Ø TANK FINAL GRADE SEE NOTE 3 ПШПШП -QUARRY SUB-BASE GRADE ELEVATION SEE NOTE 4 QUARRY LIMIT DATUM ELEV 0.00 **AS-BUILT** SECTION 0003 SCALE: 1:100 NEWMONT. The Gold Company HOPE BAY MINING LTD. SNC-LAVALIN ESL JMG RU RU GA (L C.H. LEDNOR CHL 08/06/05 HOPE BAY MINING LIMITED 4 09/02/09 AS-BUILT UPDATED WITH OWNER'S COMMENTS ENWY C.H. LEONOR CHL 08/05/05 DORIS 2008 PROJECT 3 09/01/21 AS-BUILT UPDATED CHECKED R. UMENO RU 08/06/11 ESL JMG RU RU GA ROBERTS BAY DIESEL FUEL TANK 2 08/12/15 AS-BUILT AND DESIGN INCORPORATED FINAL GRADING ESL ARW RU RU GA DT 1 08/07/05 REVISED SECTION AS PER QUARRY SURVEY INFORMATION OF 27&30 JUN 2008 & 1 JUL 2008 0 08/06/11 SSUED FOR CONSTRUCTION SECTION CHL RU RU RU GA 1320-4101-0003 ROBERTS BAY TANK FARM FINAL GRADING SECTION DISCPL. DOC. DRAWING LOC. REVISION NUMBER PROJECT NO. BY CHK LEAD DIG. AREA DIG. AREA ND. DATE BY CHK LEAD DIG. AREA DIG. AREA WAL DIG. AREA WAL SHOWN NAME (PRINT) INIT. DATE BY CHK DECA MAKE THE AREA NO. DATE DWG. NO. NO. DATE REVISIONS REVISIONS 334499 1320 41 D1 0004 4 REFERENCES

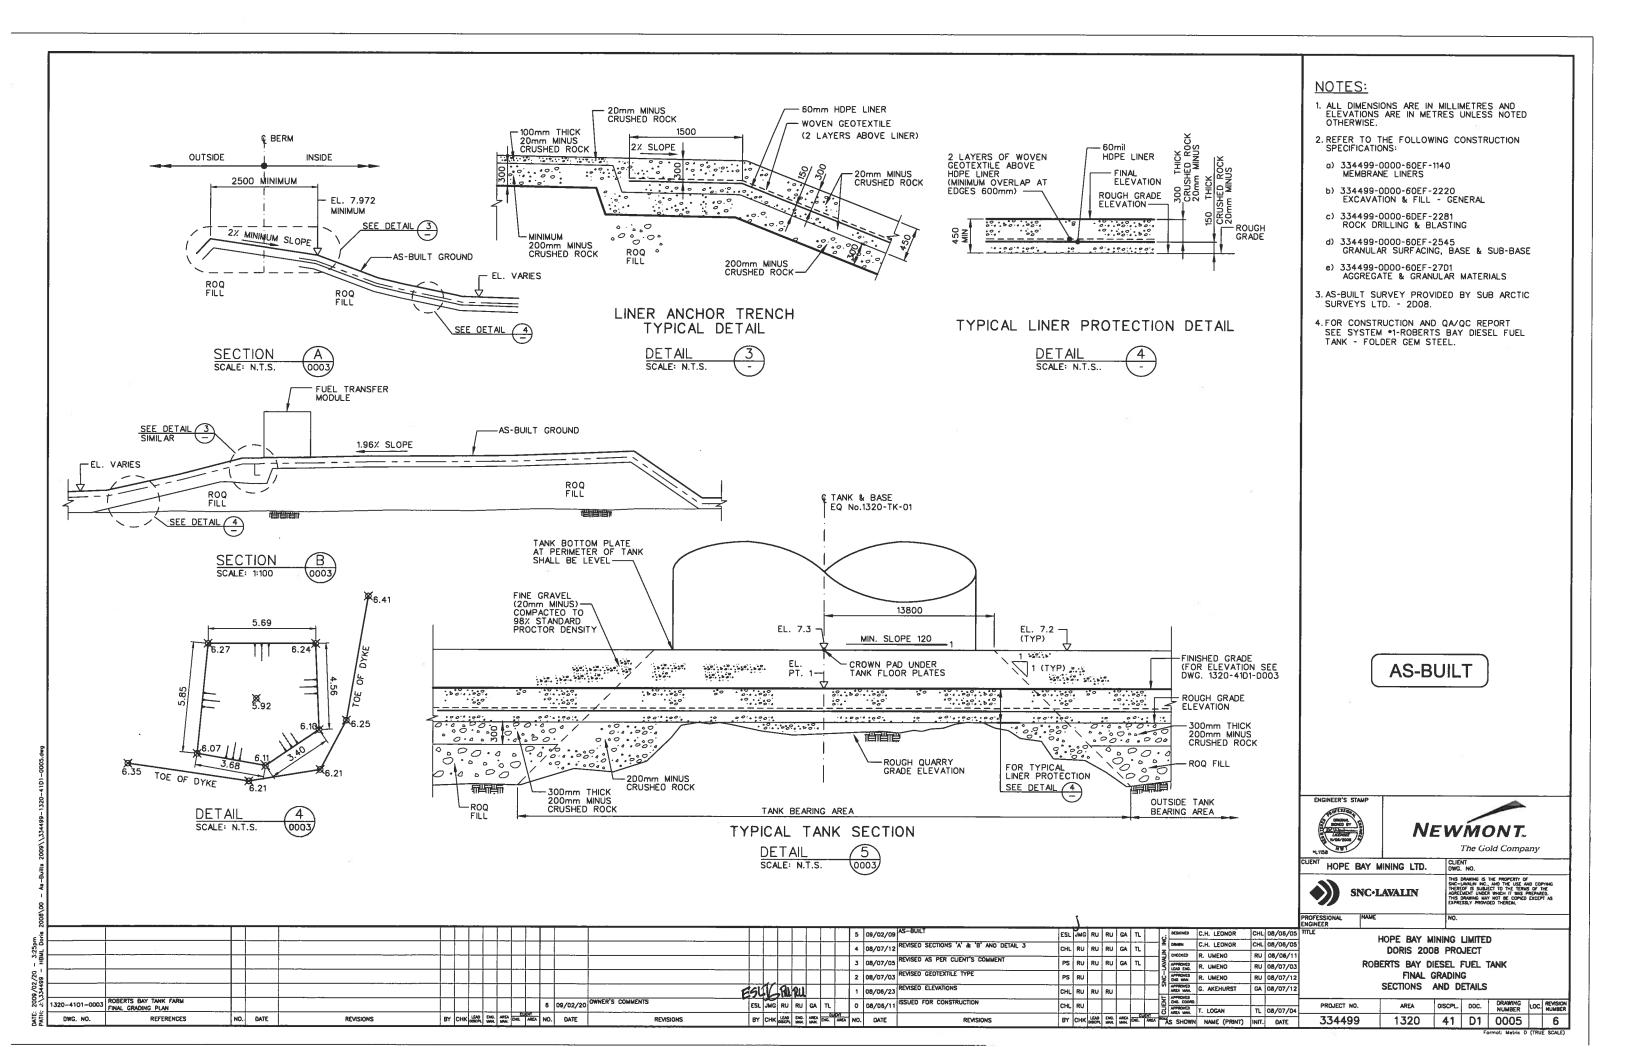

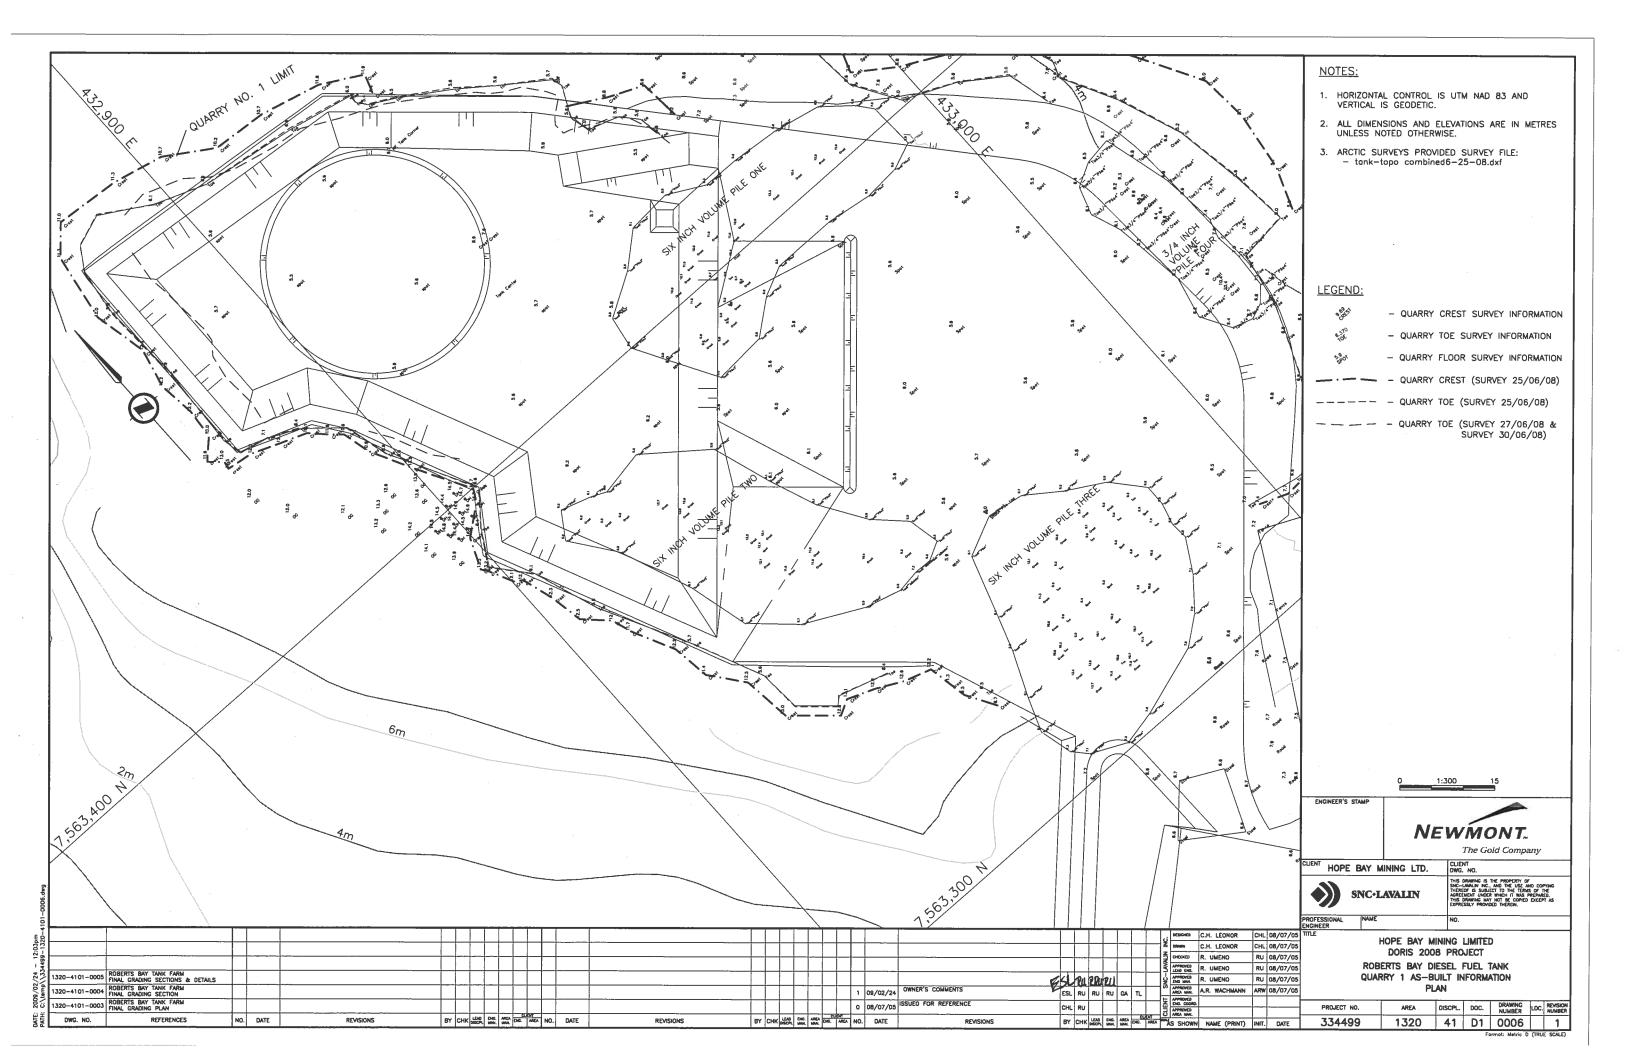


6. Quarrie	S


6	a Relevant Drawings Submitted with O	riginal Water License Application	

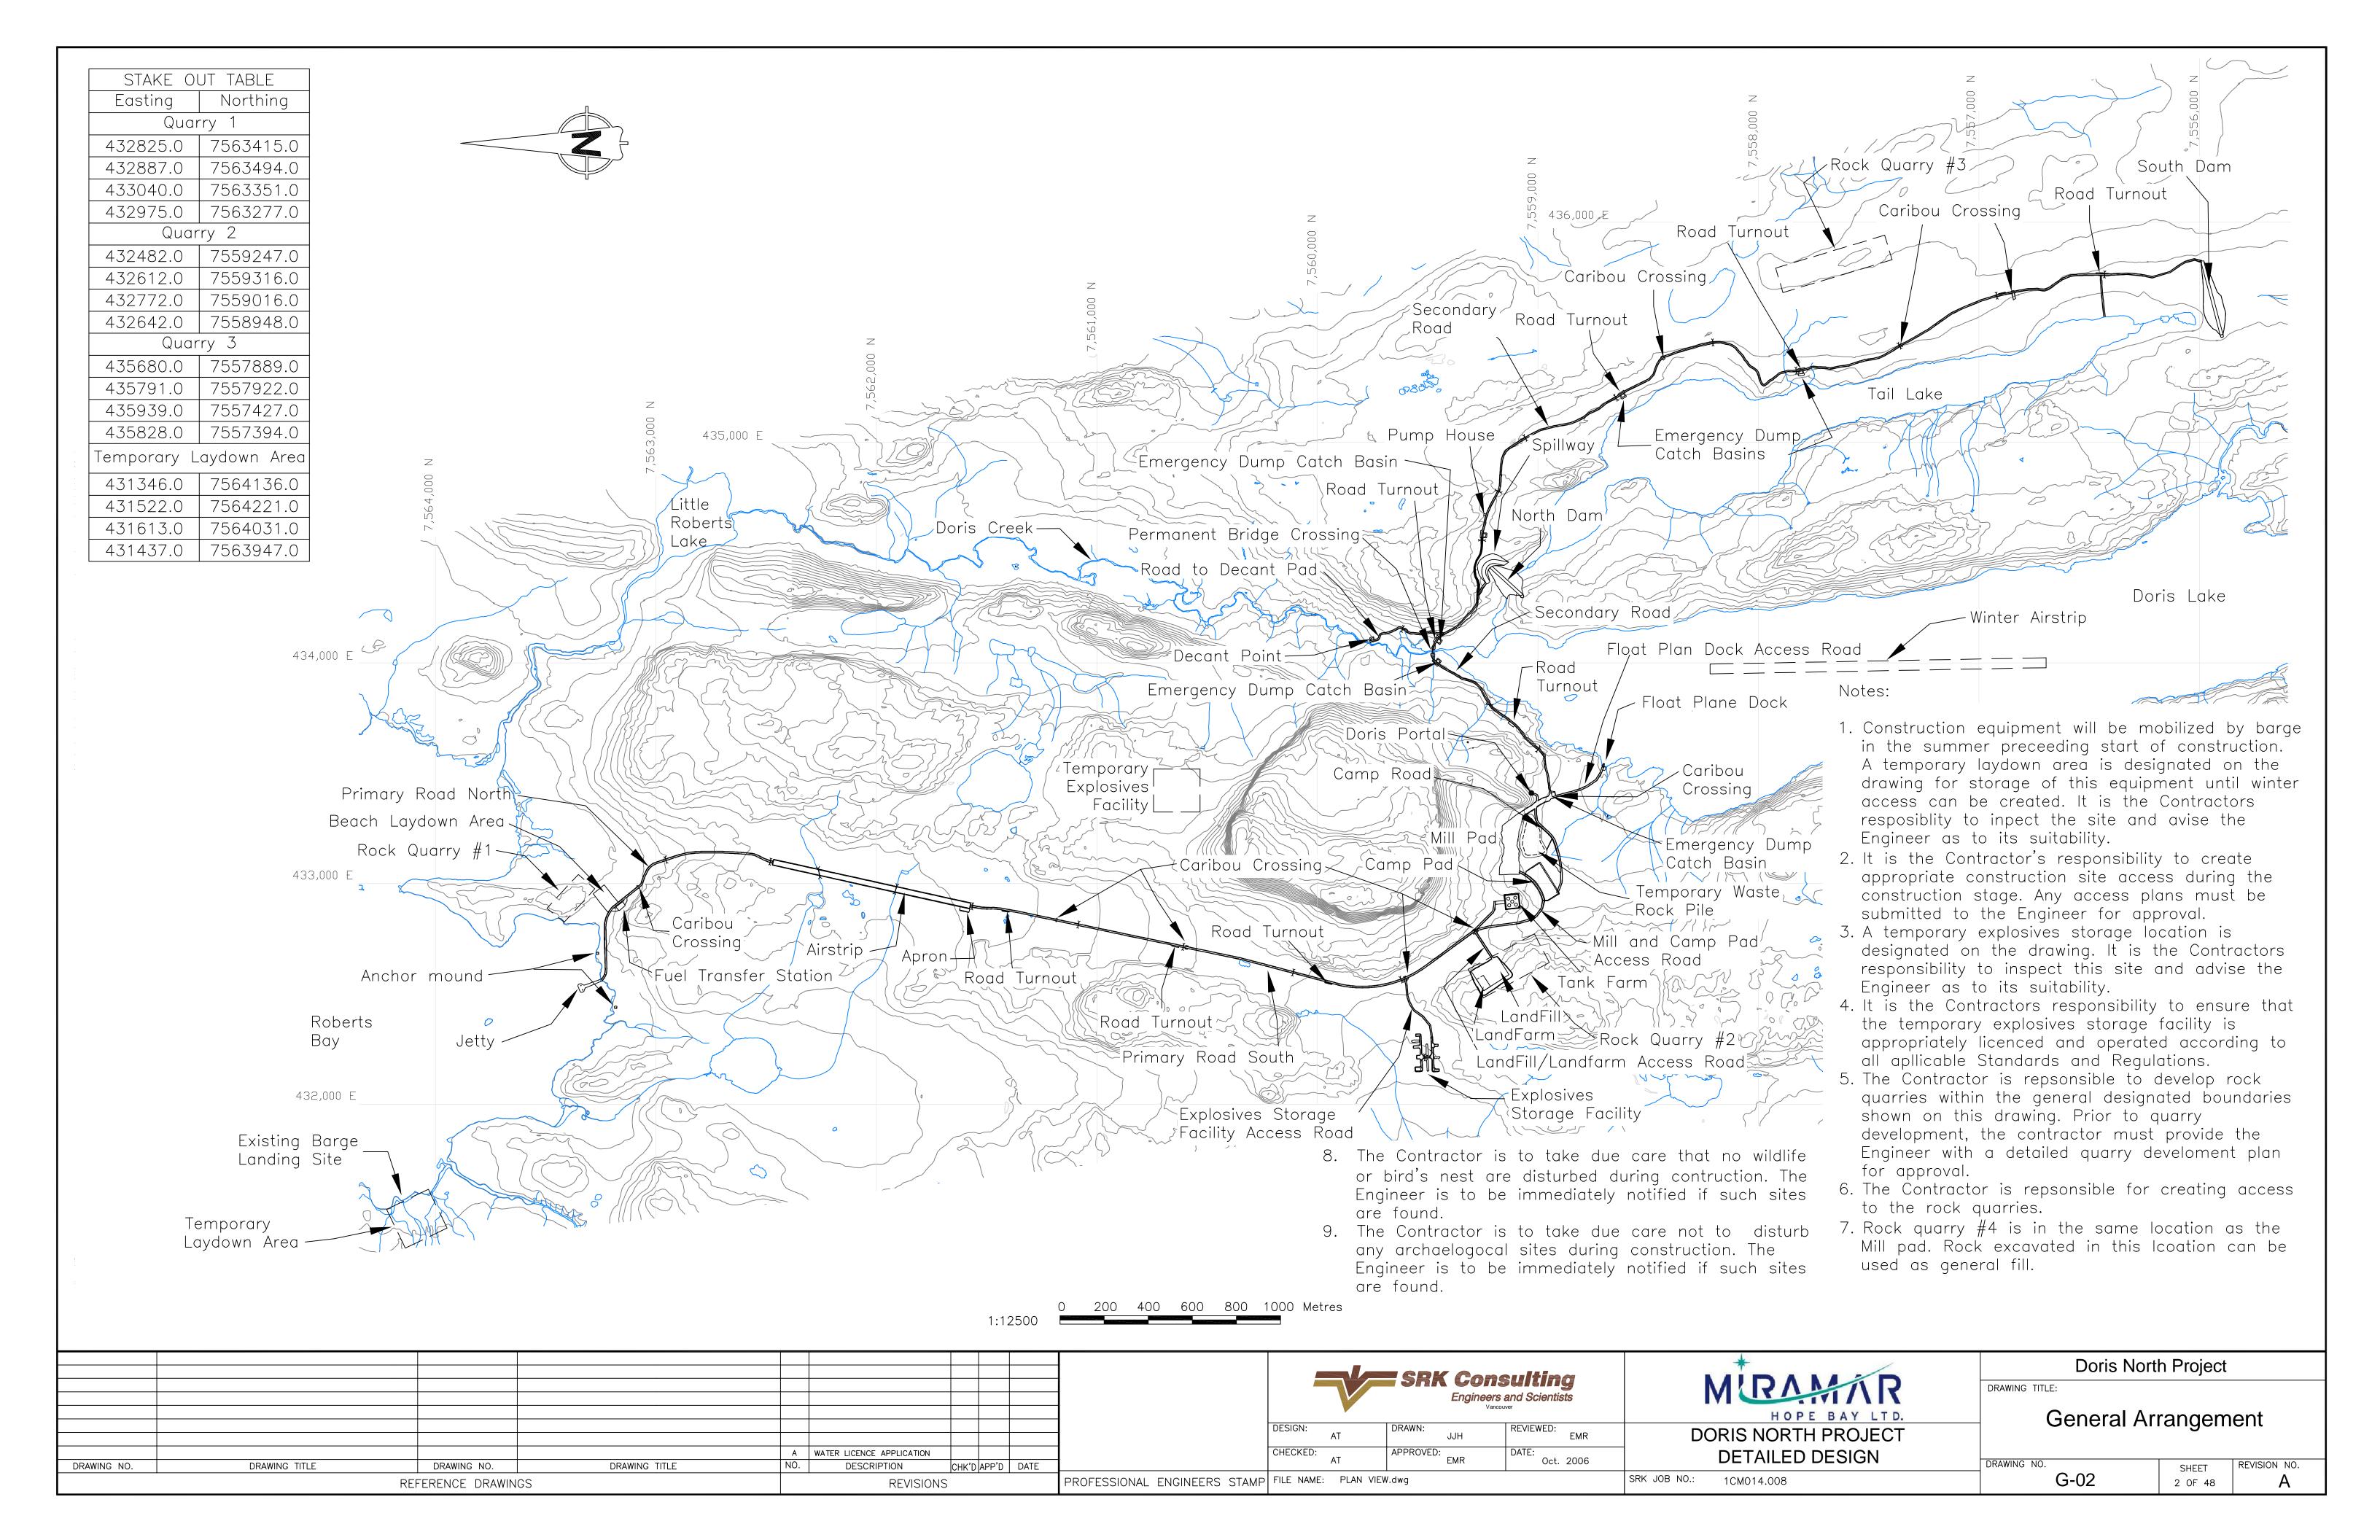


6b Issued for Construction

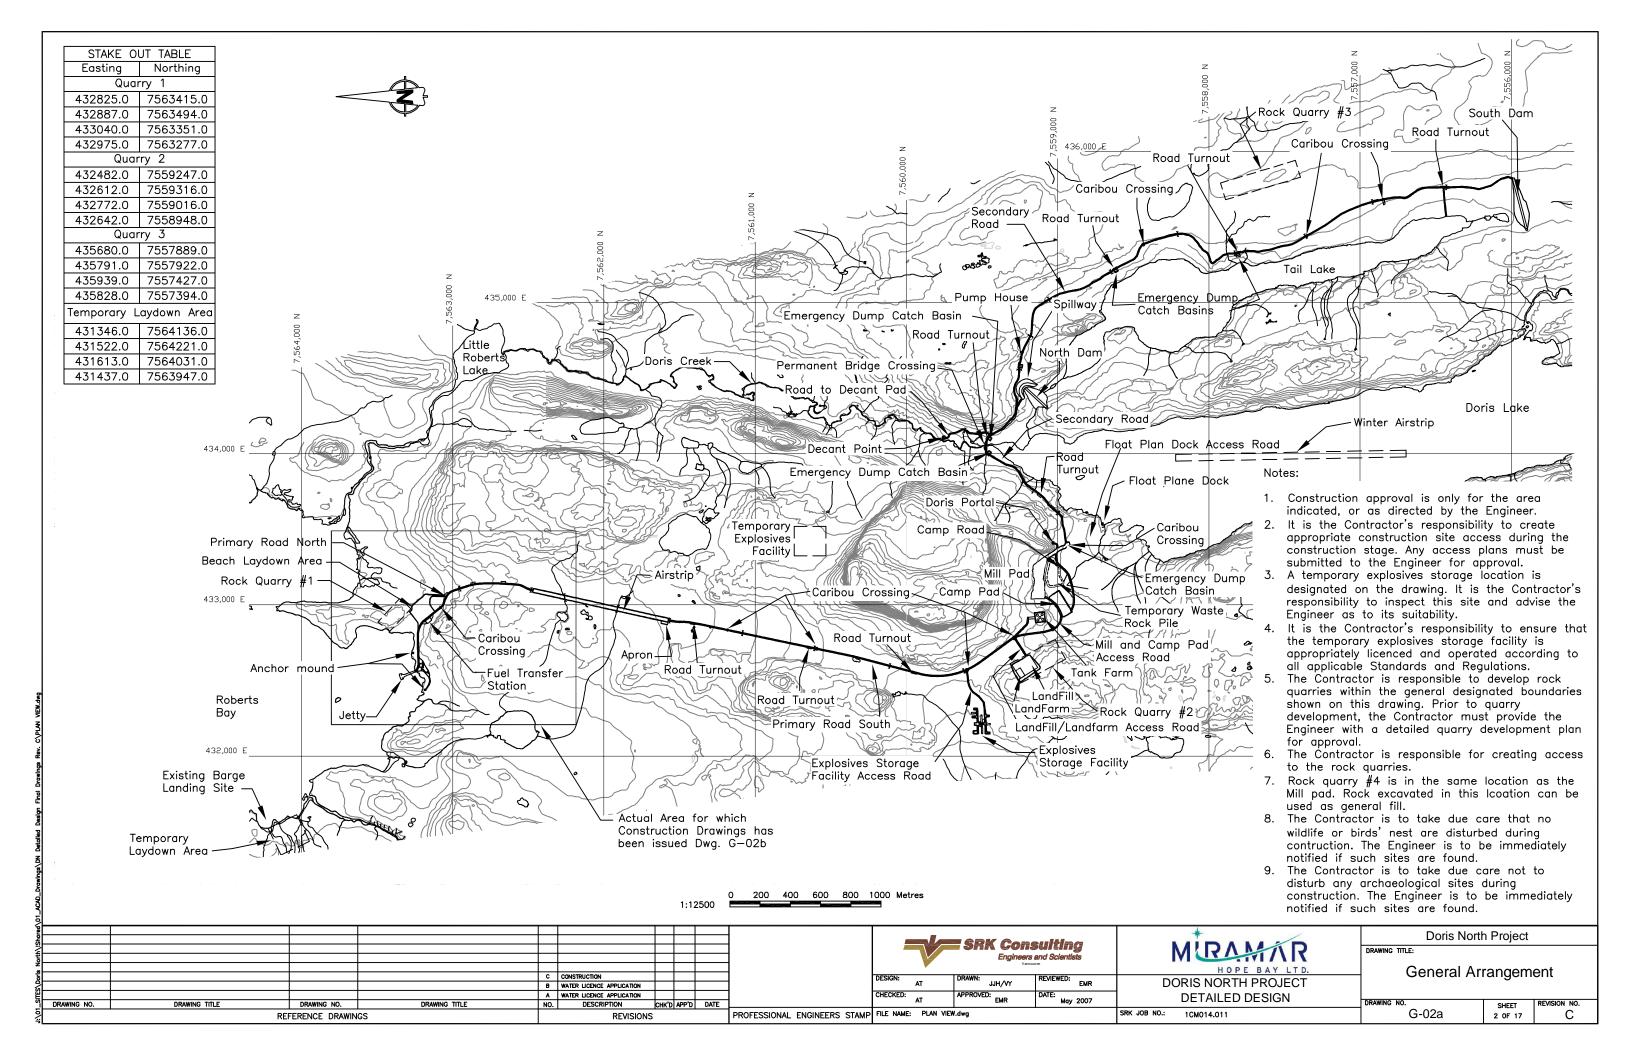


6c As-Built Drawings for Constructed Facilities

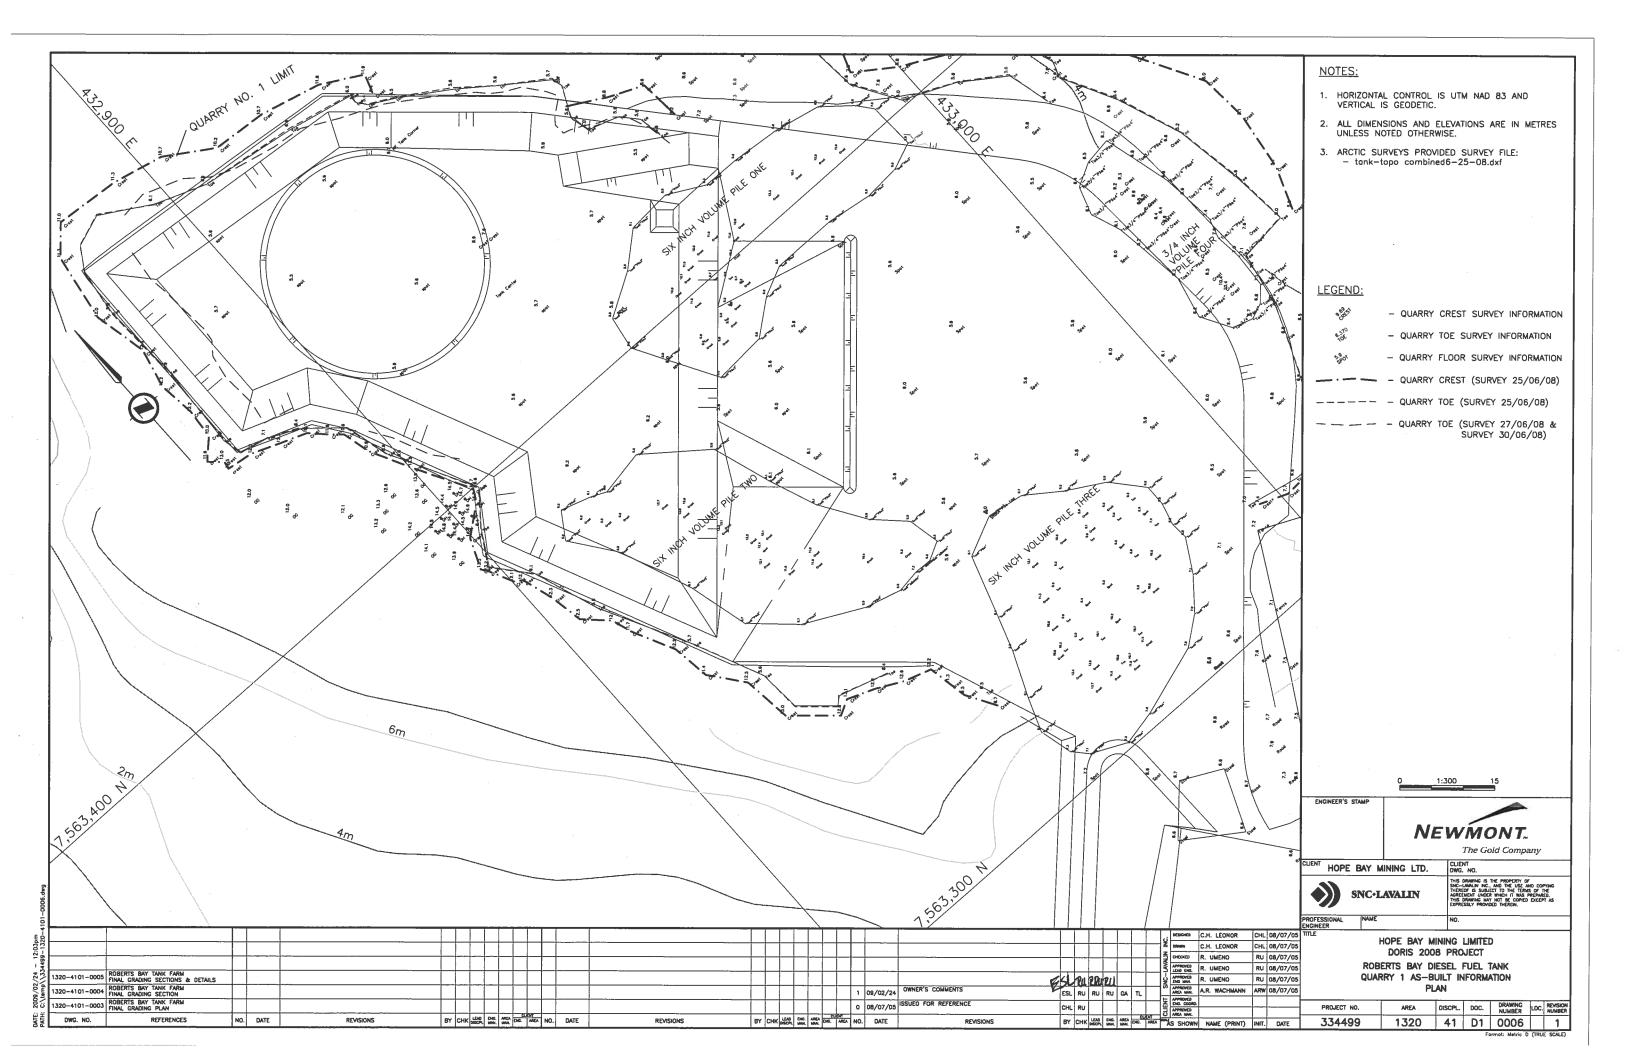


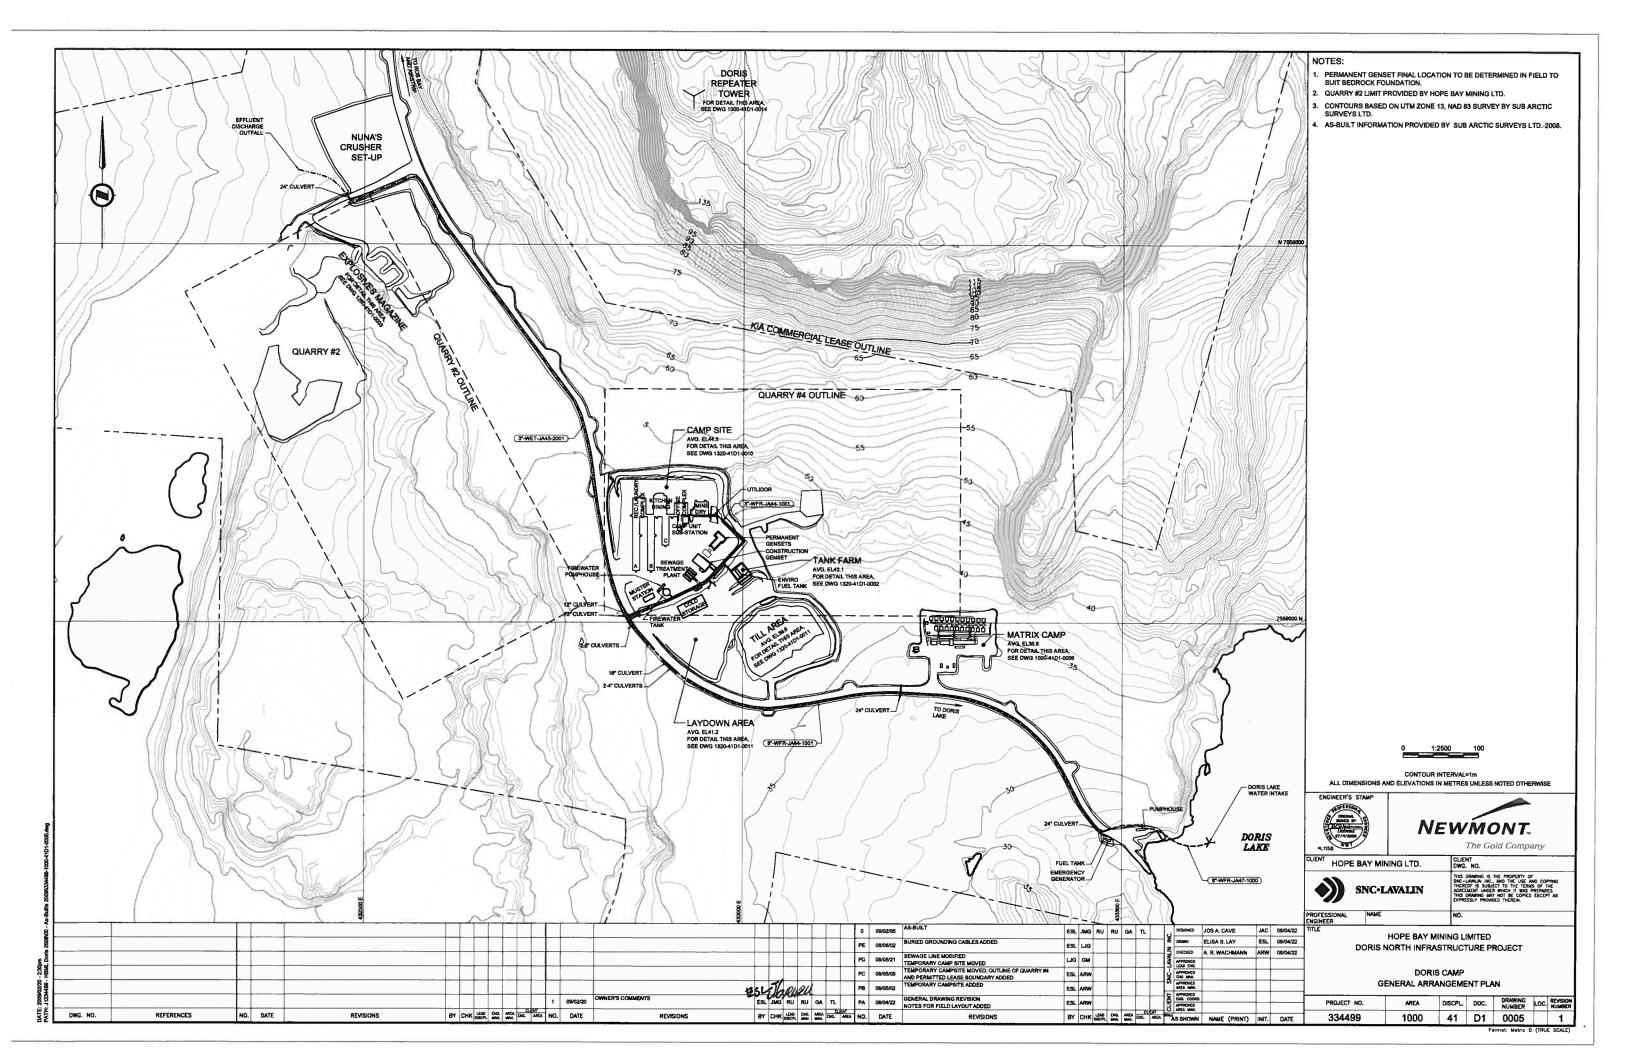



7. Sewage Treatment Plant

7b Issued for Construction

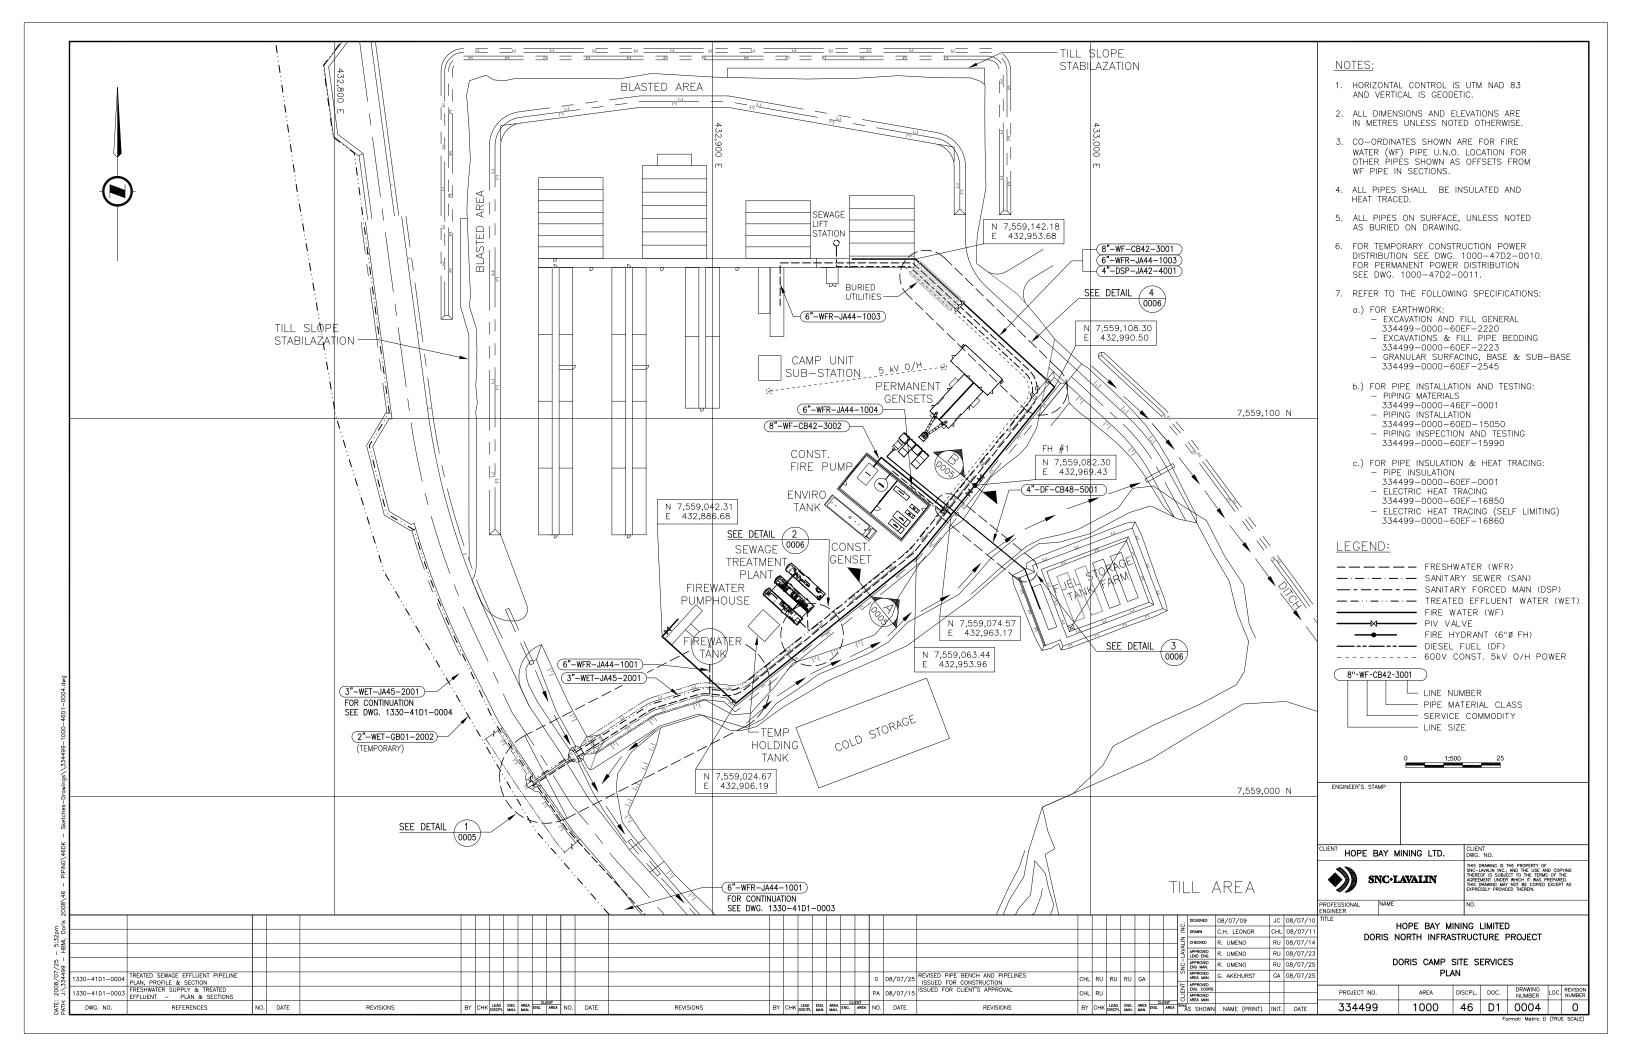

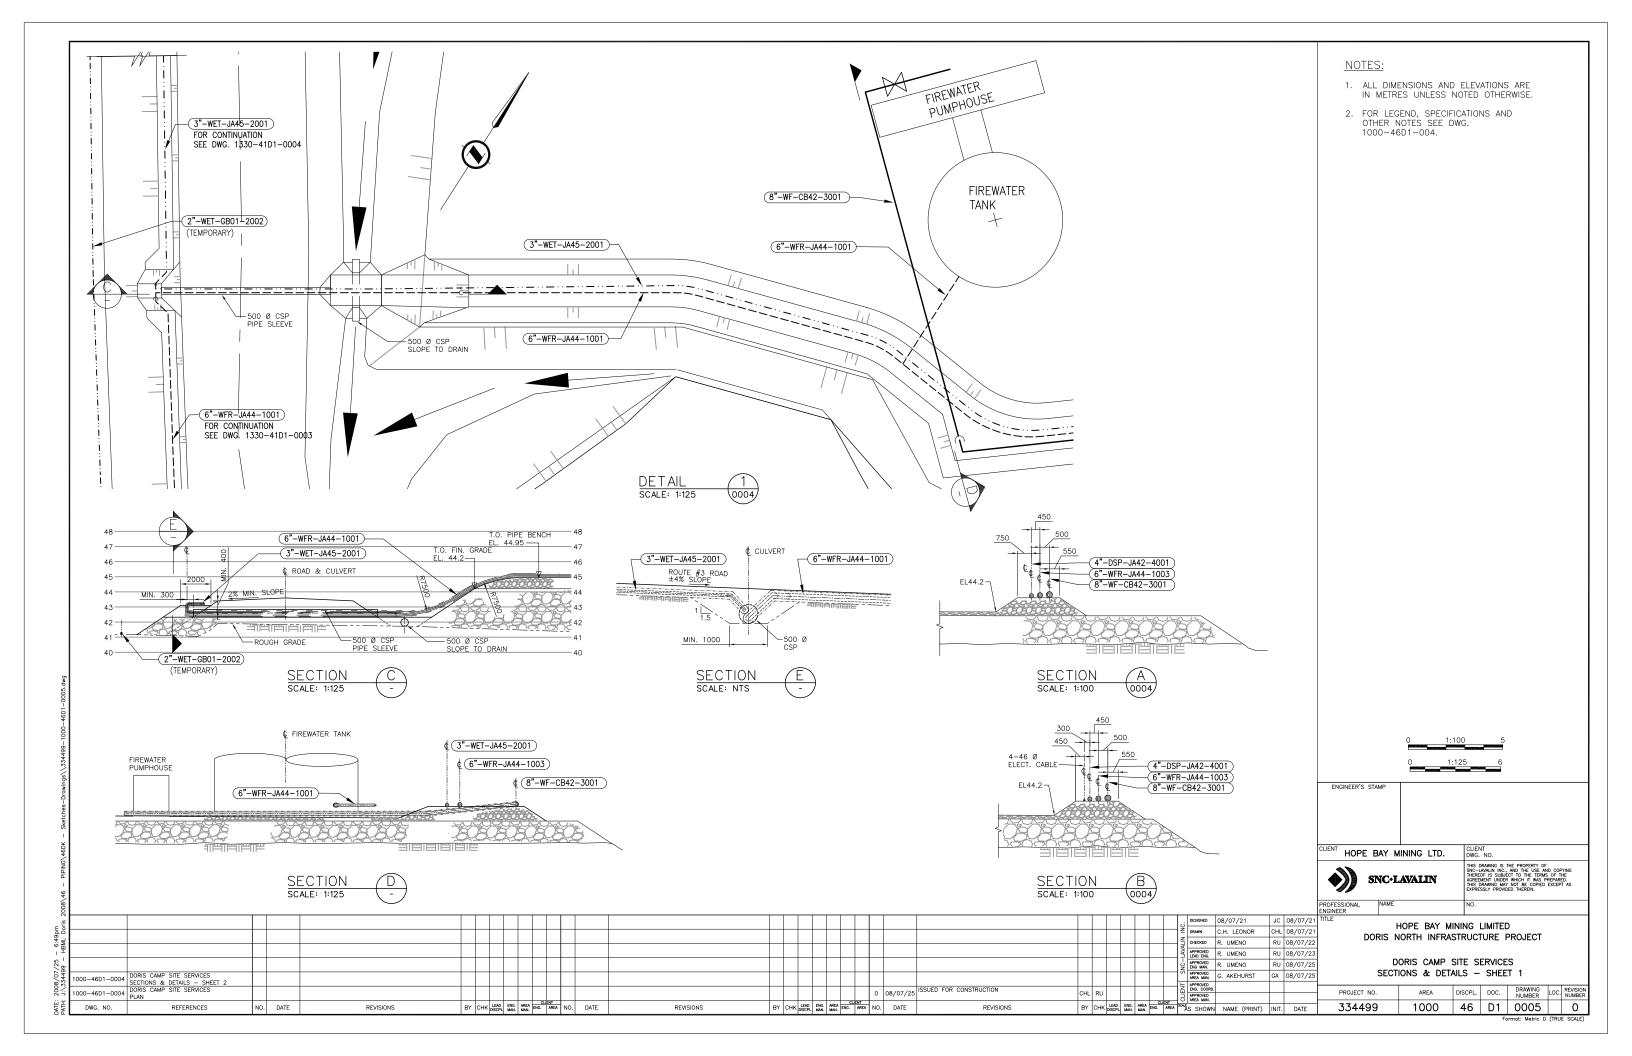

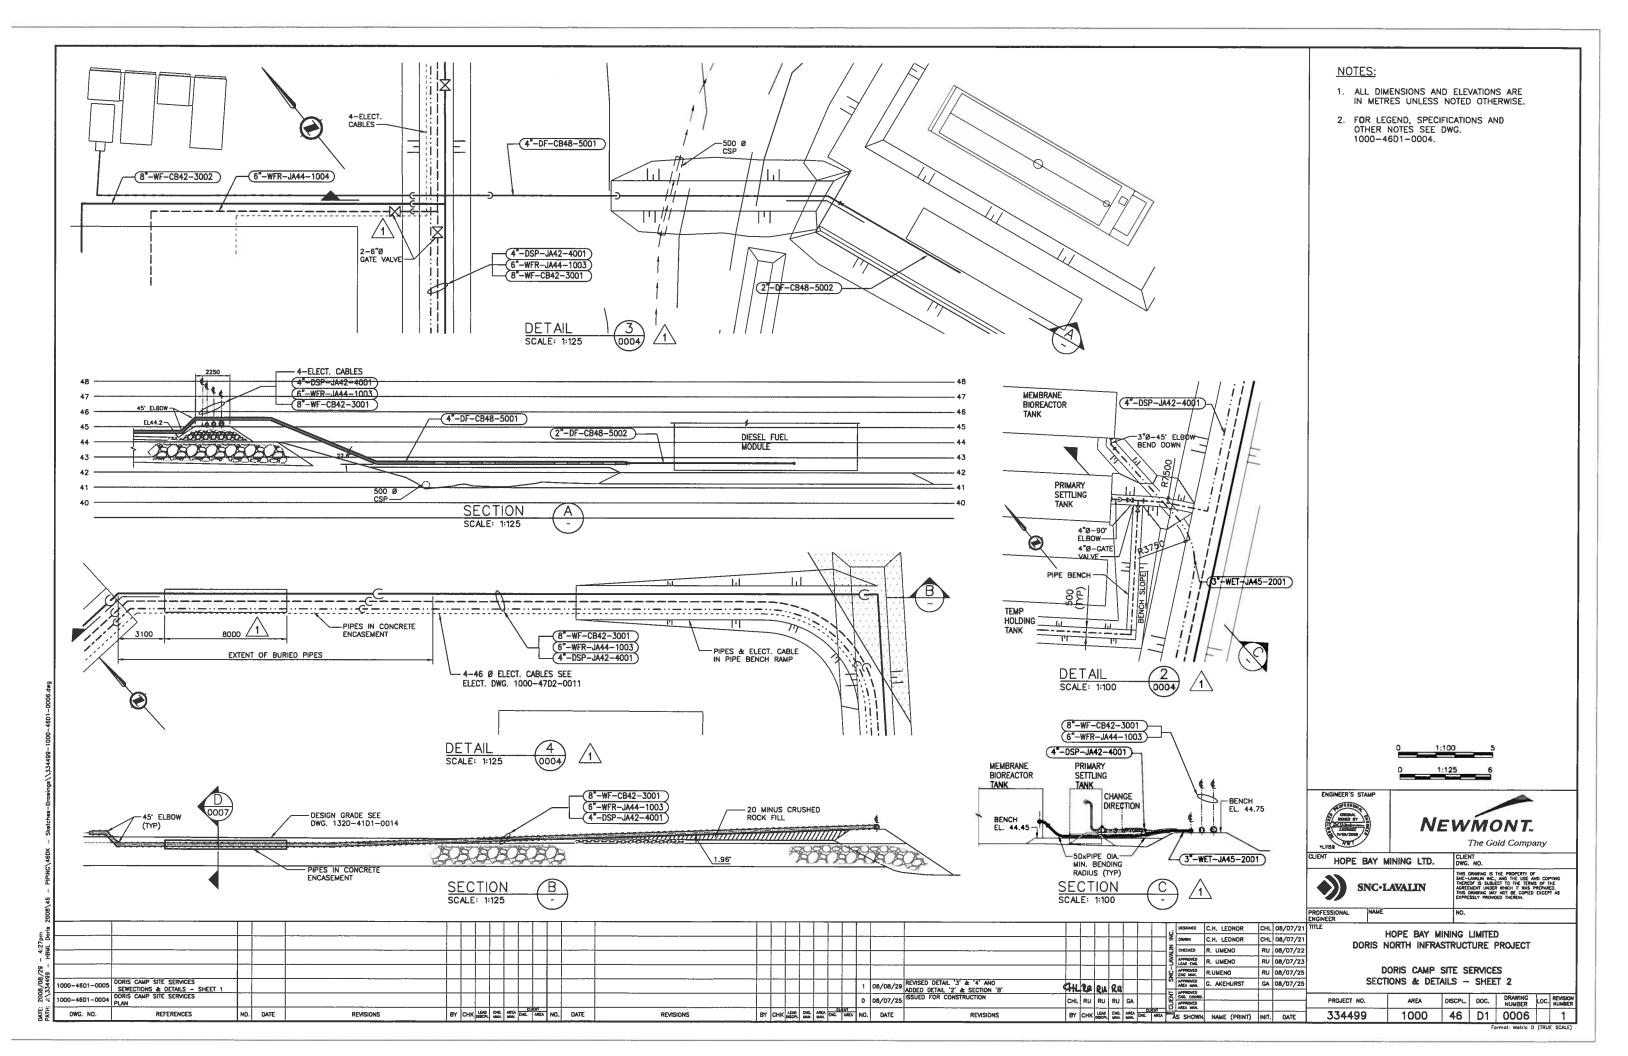

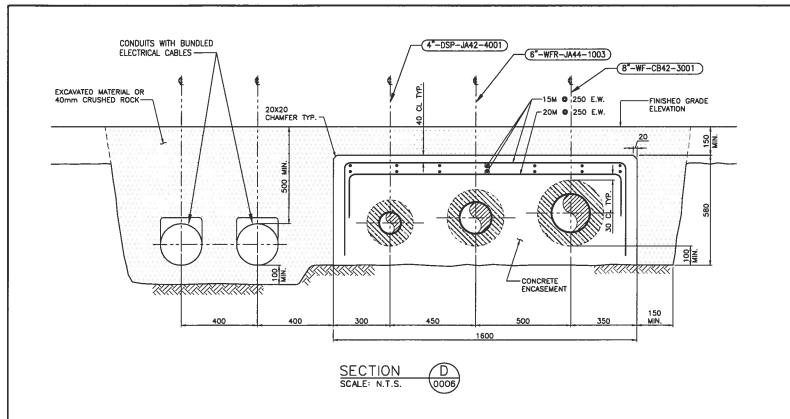

BY CHK LEAD DIG. AREA DIG. AREA NO. DATE

REVISIONS

NO. DATE

REVISIONS

DWG. NO.

NOTES:

- ALL DIMENSIONS ARE IN MILLIMETRES AND ELEVATIONS ARE IN METRES UNLESS NOTED OTHERWISE.
- FOR LEGEND, SPECIFICATIONS AND OTHER NOTES SEE DWG. 1000-46D1-004.
- FOR CONCRETE GENERAL NOTES AND STANDARD DETAILS SEE DWG. 0000-42D2-2001.

ENGINEER'S STAMP



SNC-LAVALIN

HOPE BAY MINING LTD.

| CHK | CHK

BY CHK | SEC | One AREA | SOCIETY | PA | O8/08/29 | SSUED FOR CONSTRUCTION |


BY CHK | OSCOP, MAKE MAKE | ORG. AREA | NO. DATE | REVISION

REVISIONS


HOPE BAY MINING LIMITED DORIS NORTH INFRASTRUCTURE PROJECT


DORIS CAMP SITE SERVICES SECTIONS & DETAILS - SHEET 3


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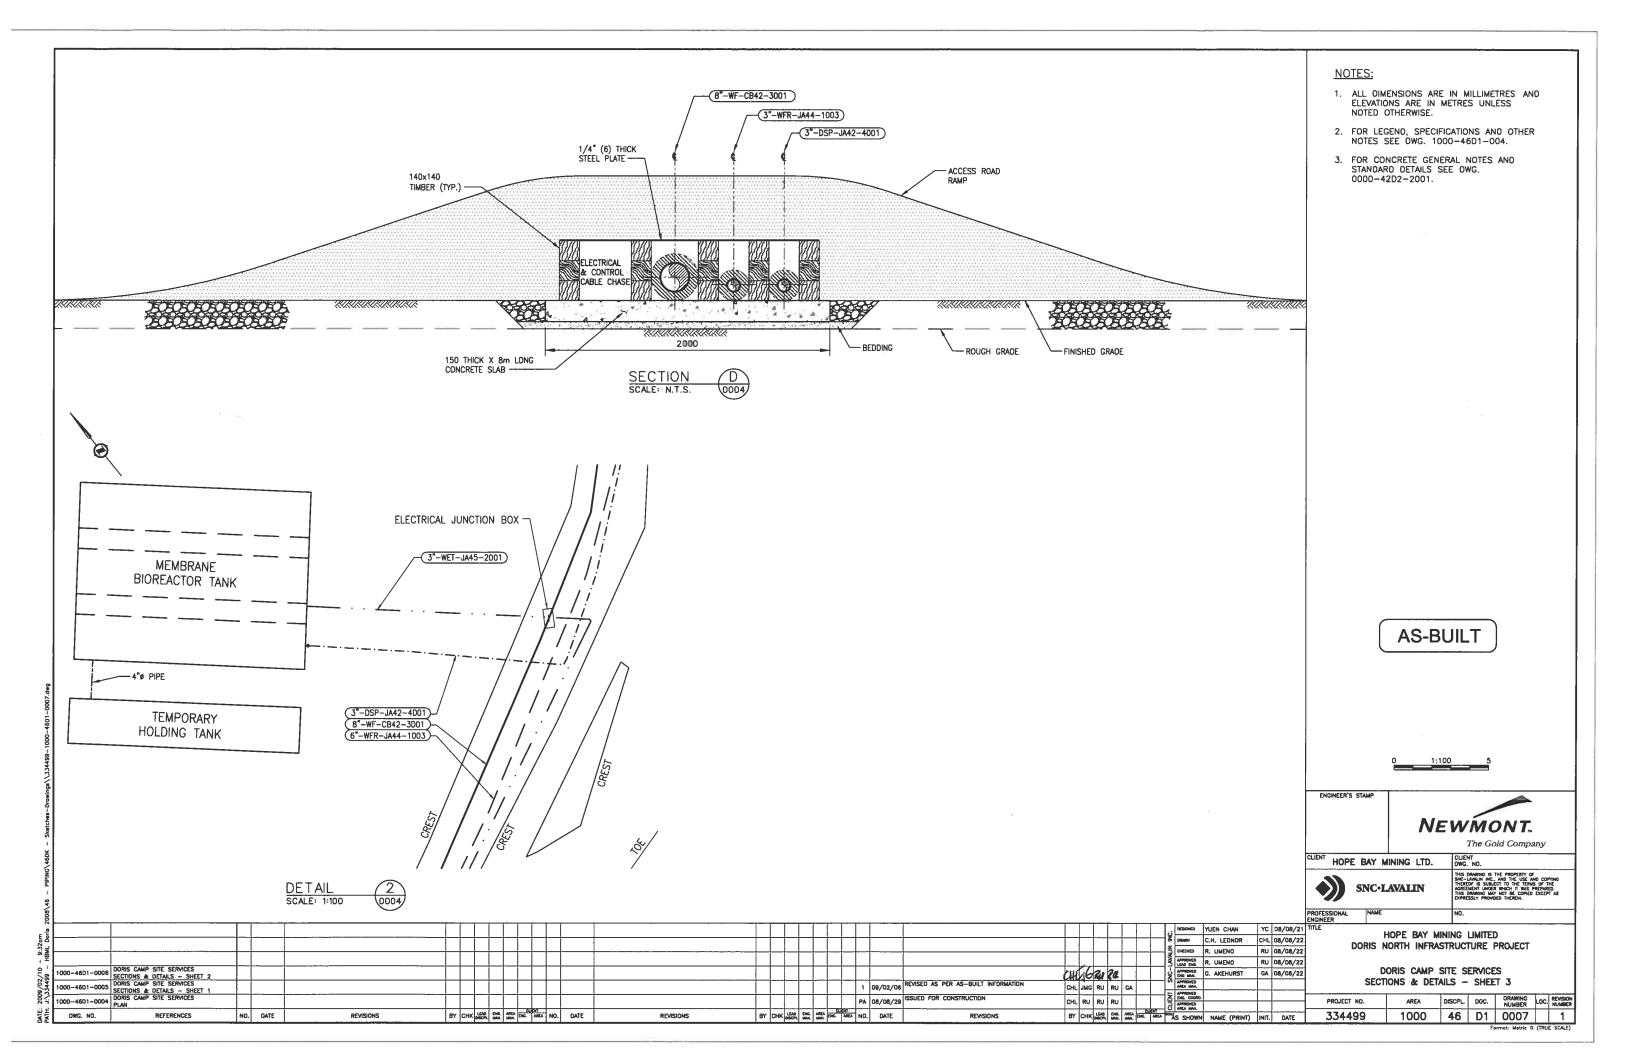


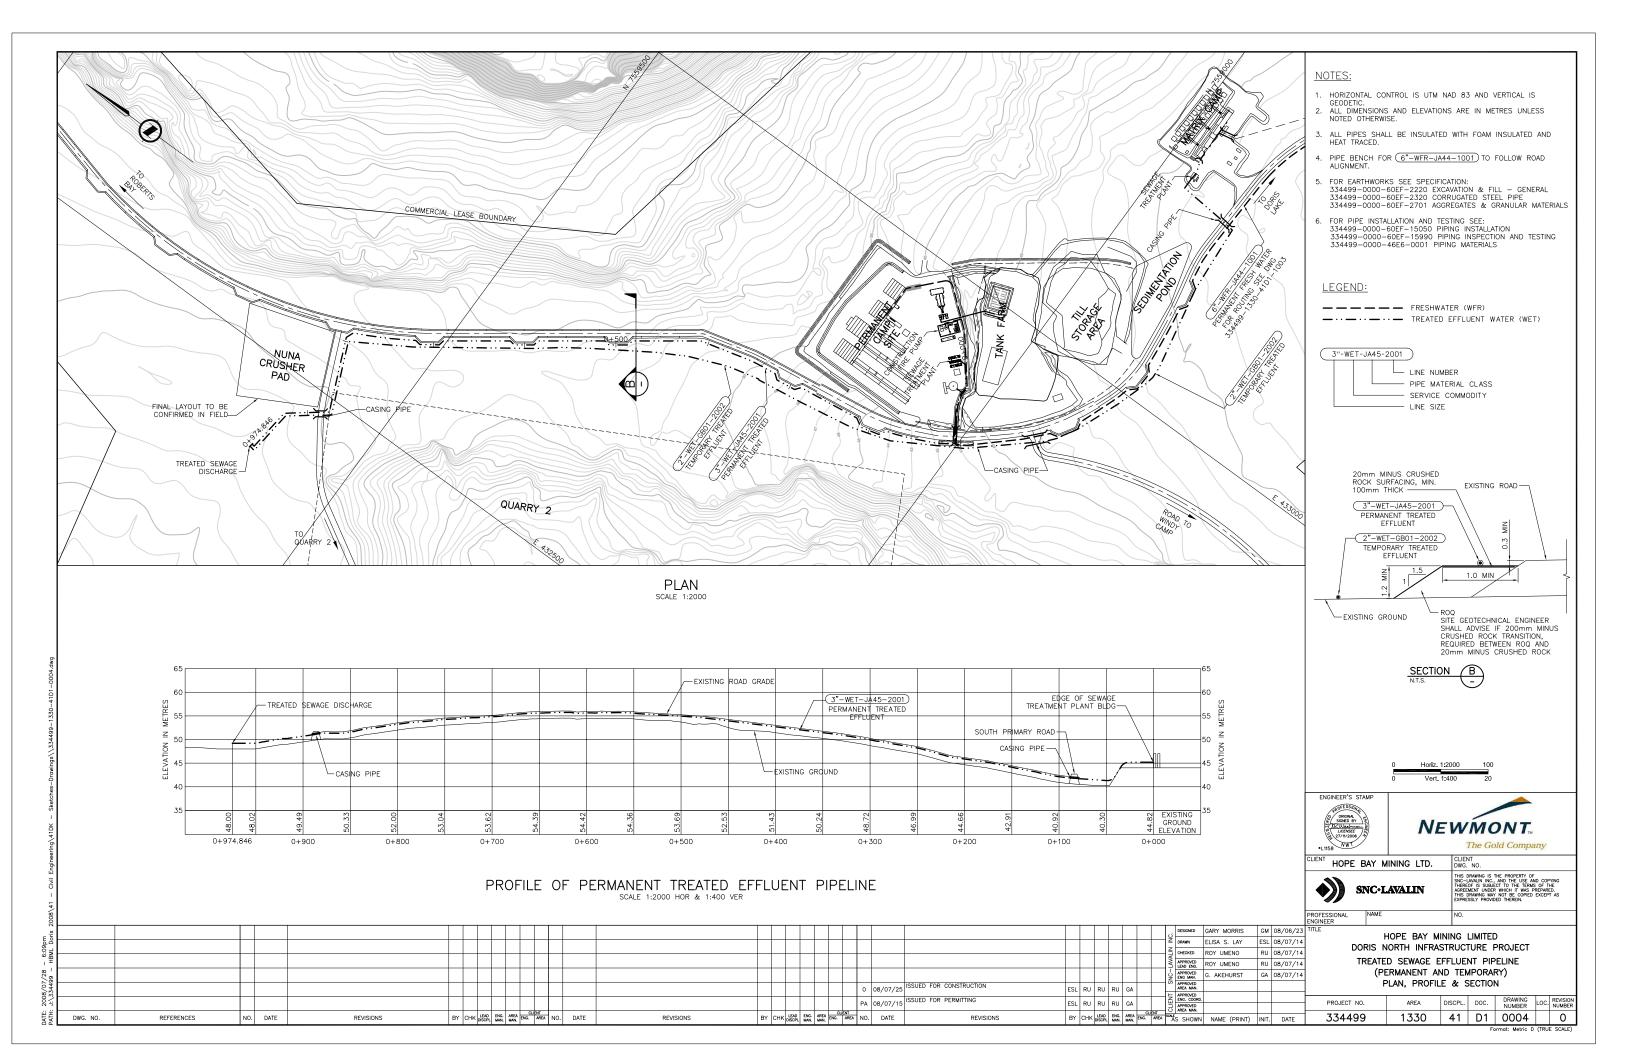
7c As-Built Drawings for Constructed Facilities



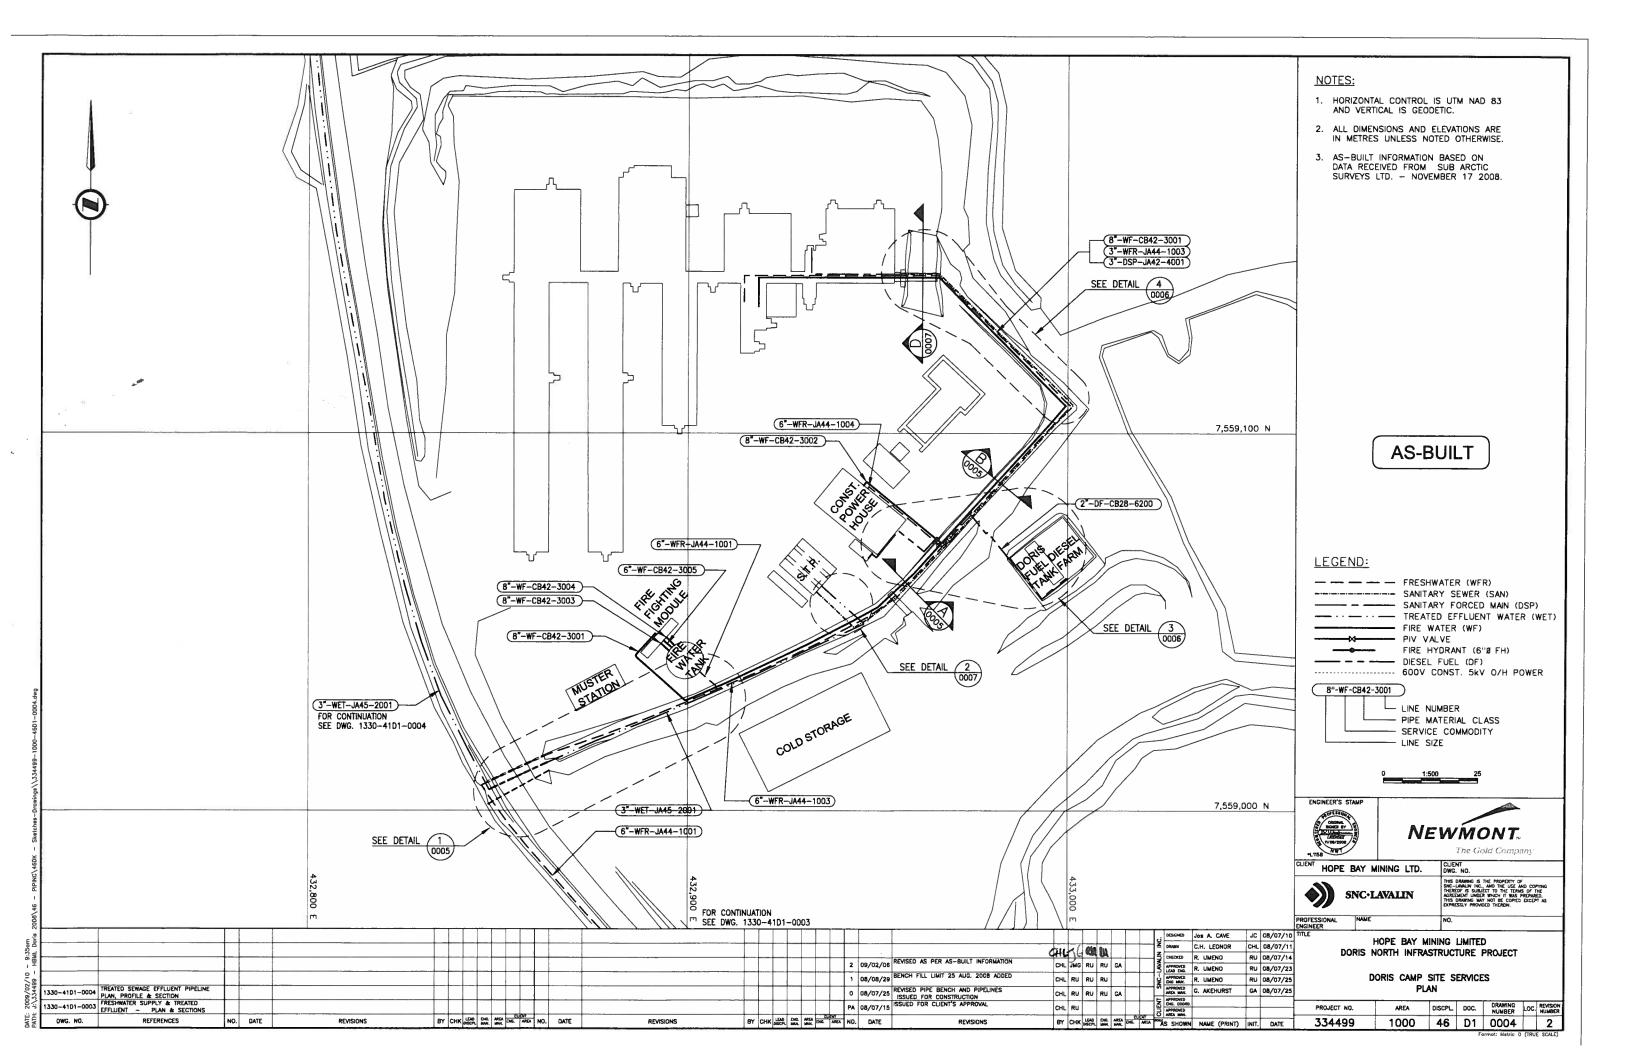

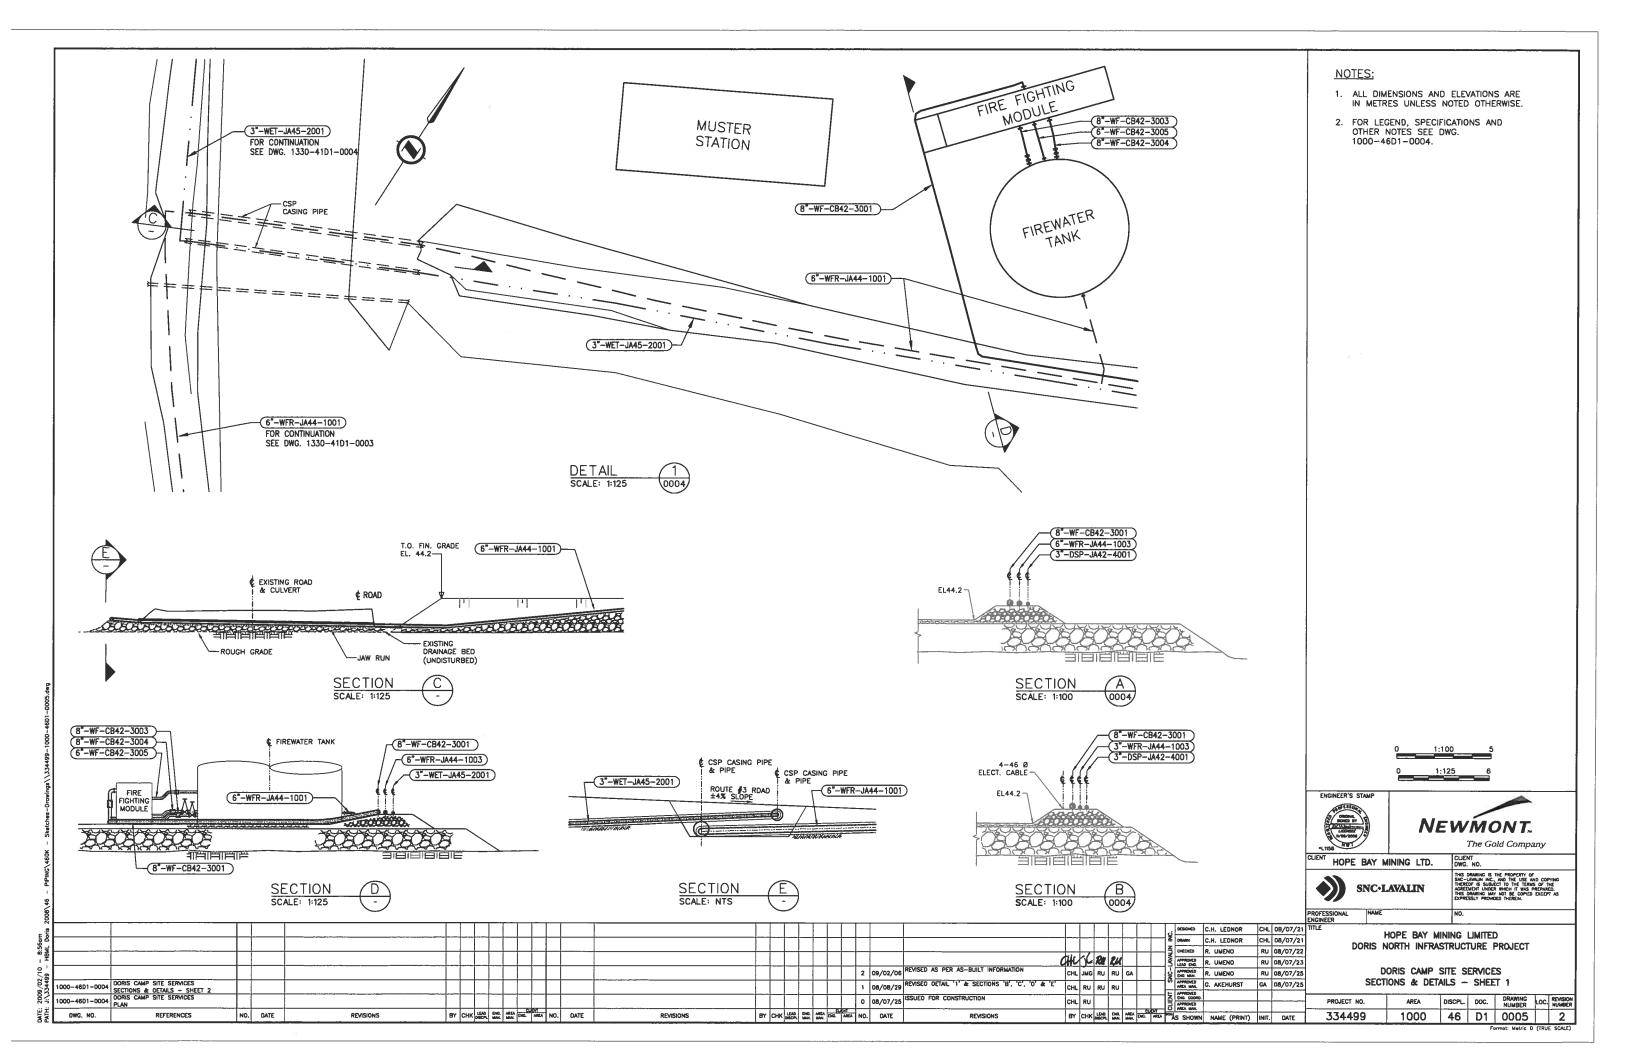


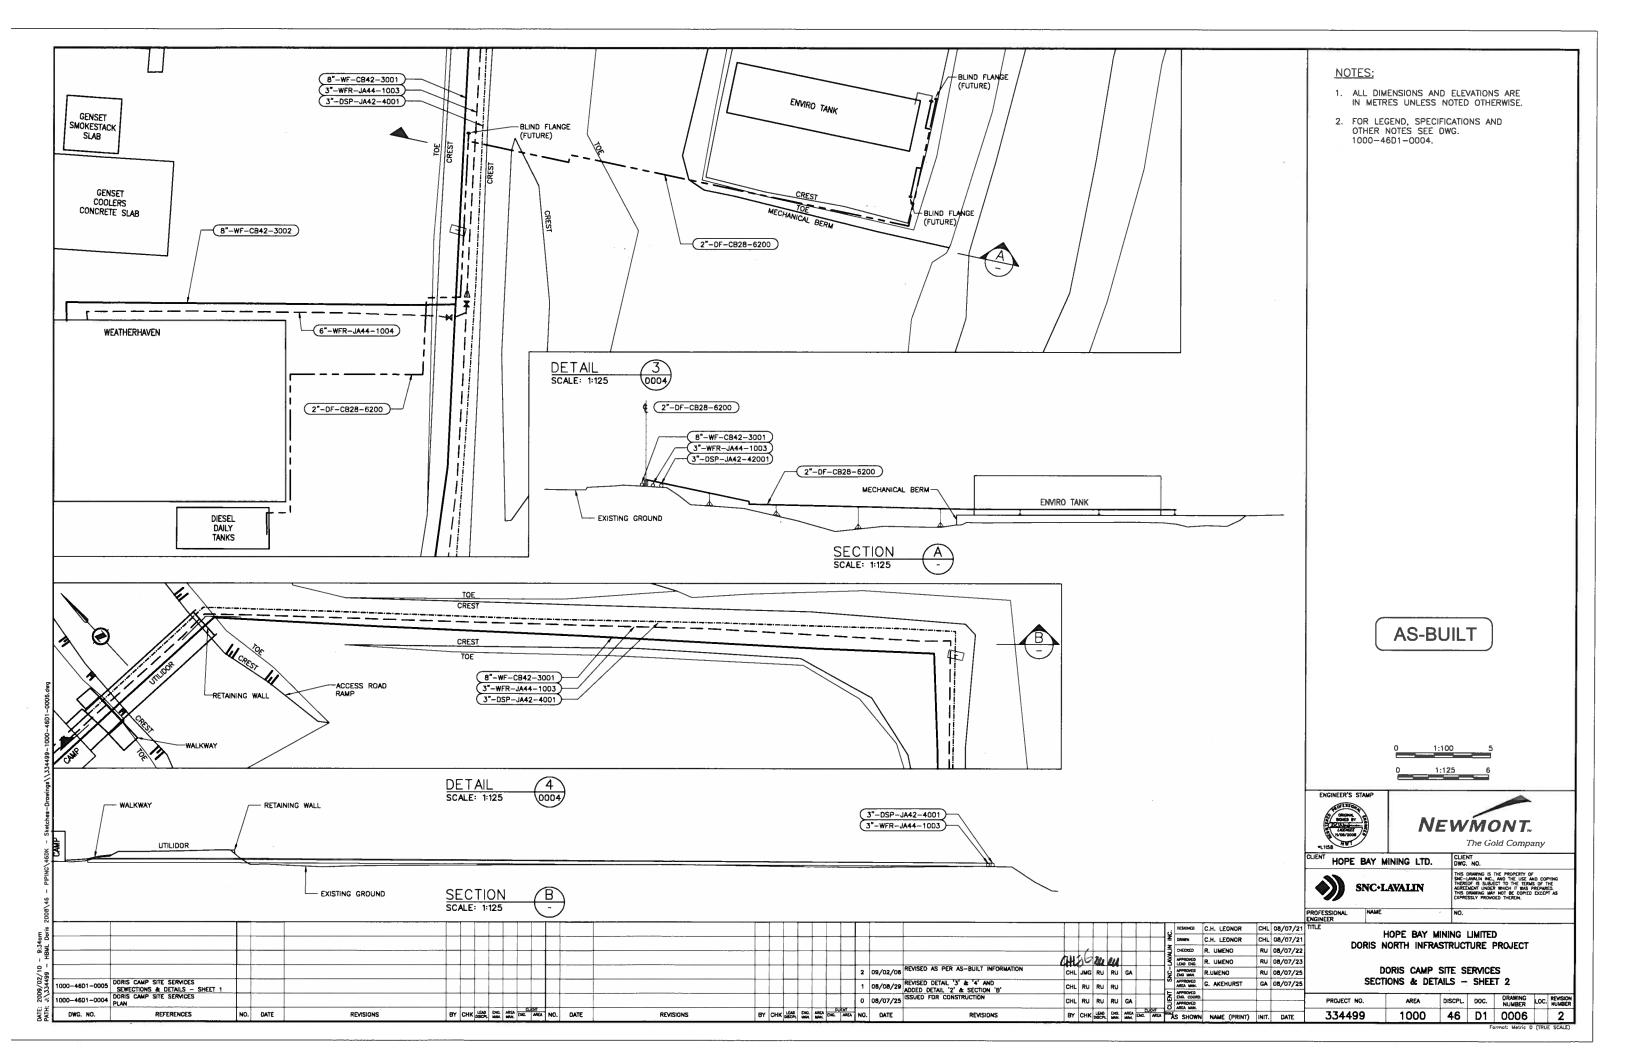

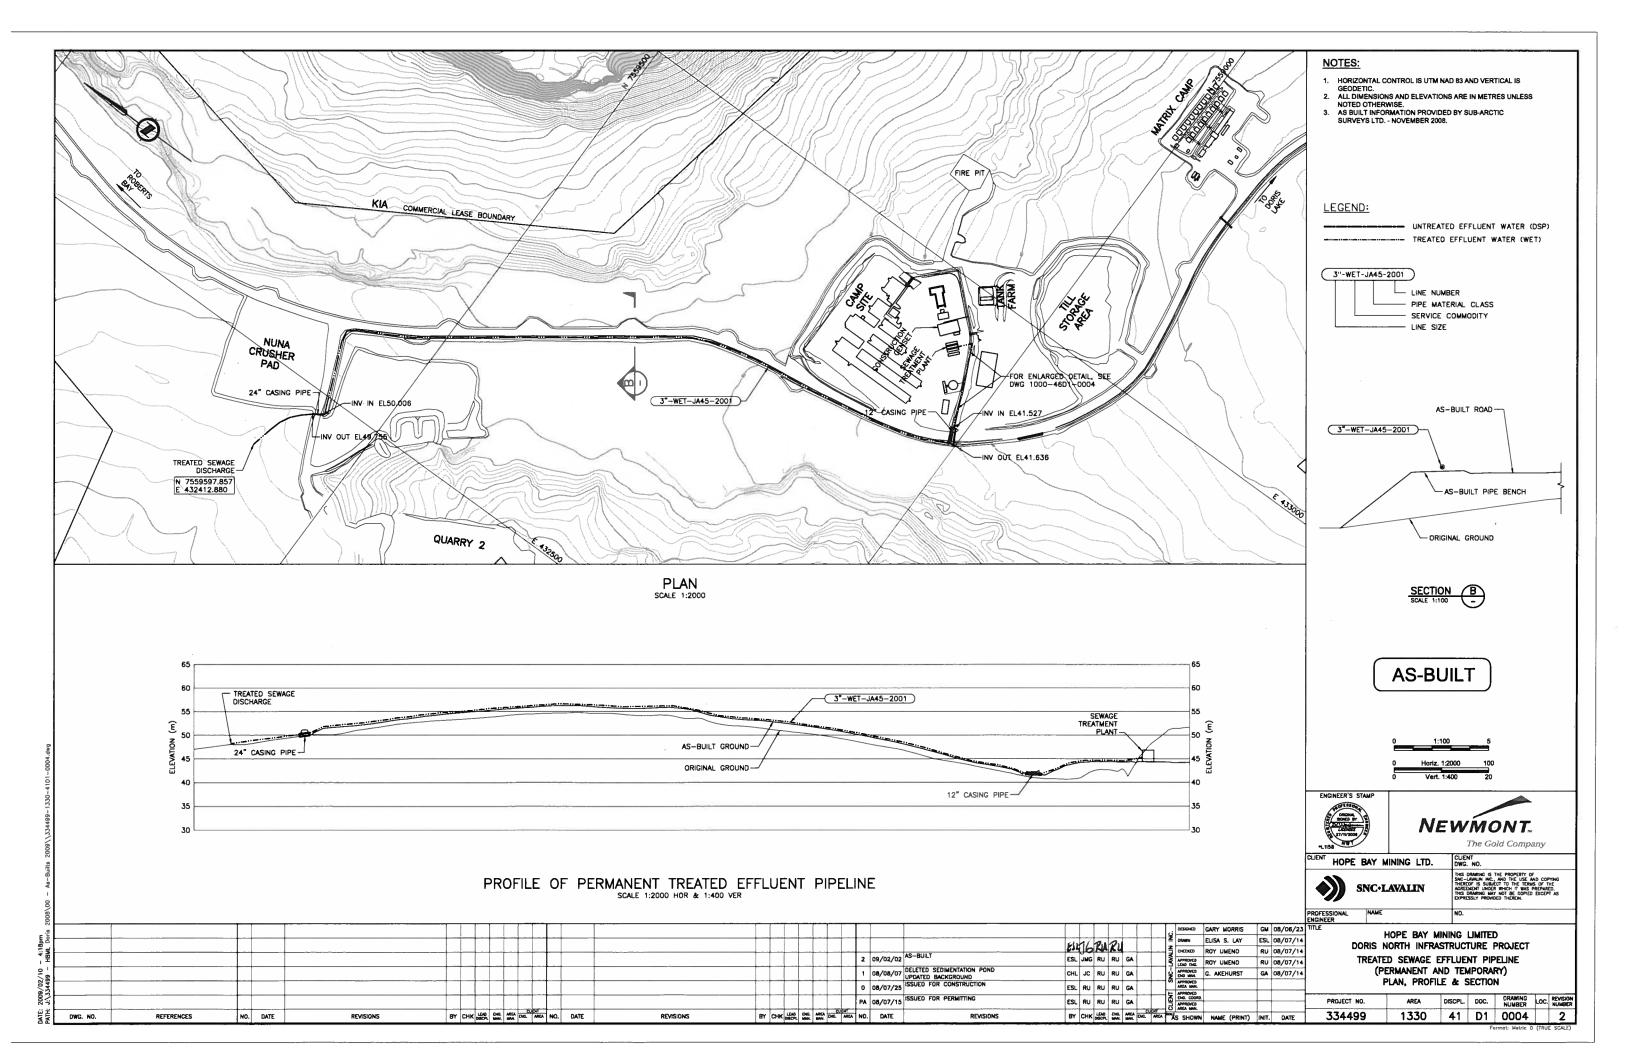


8. Airstrip	
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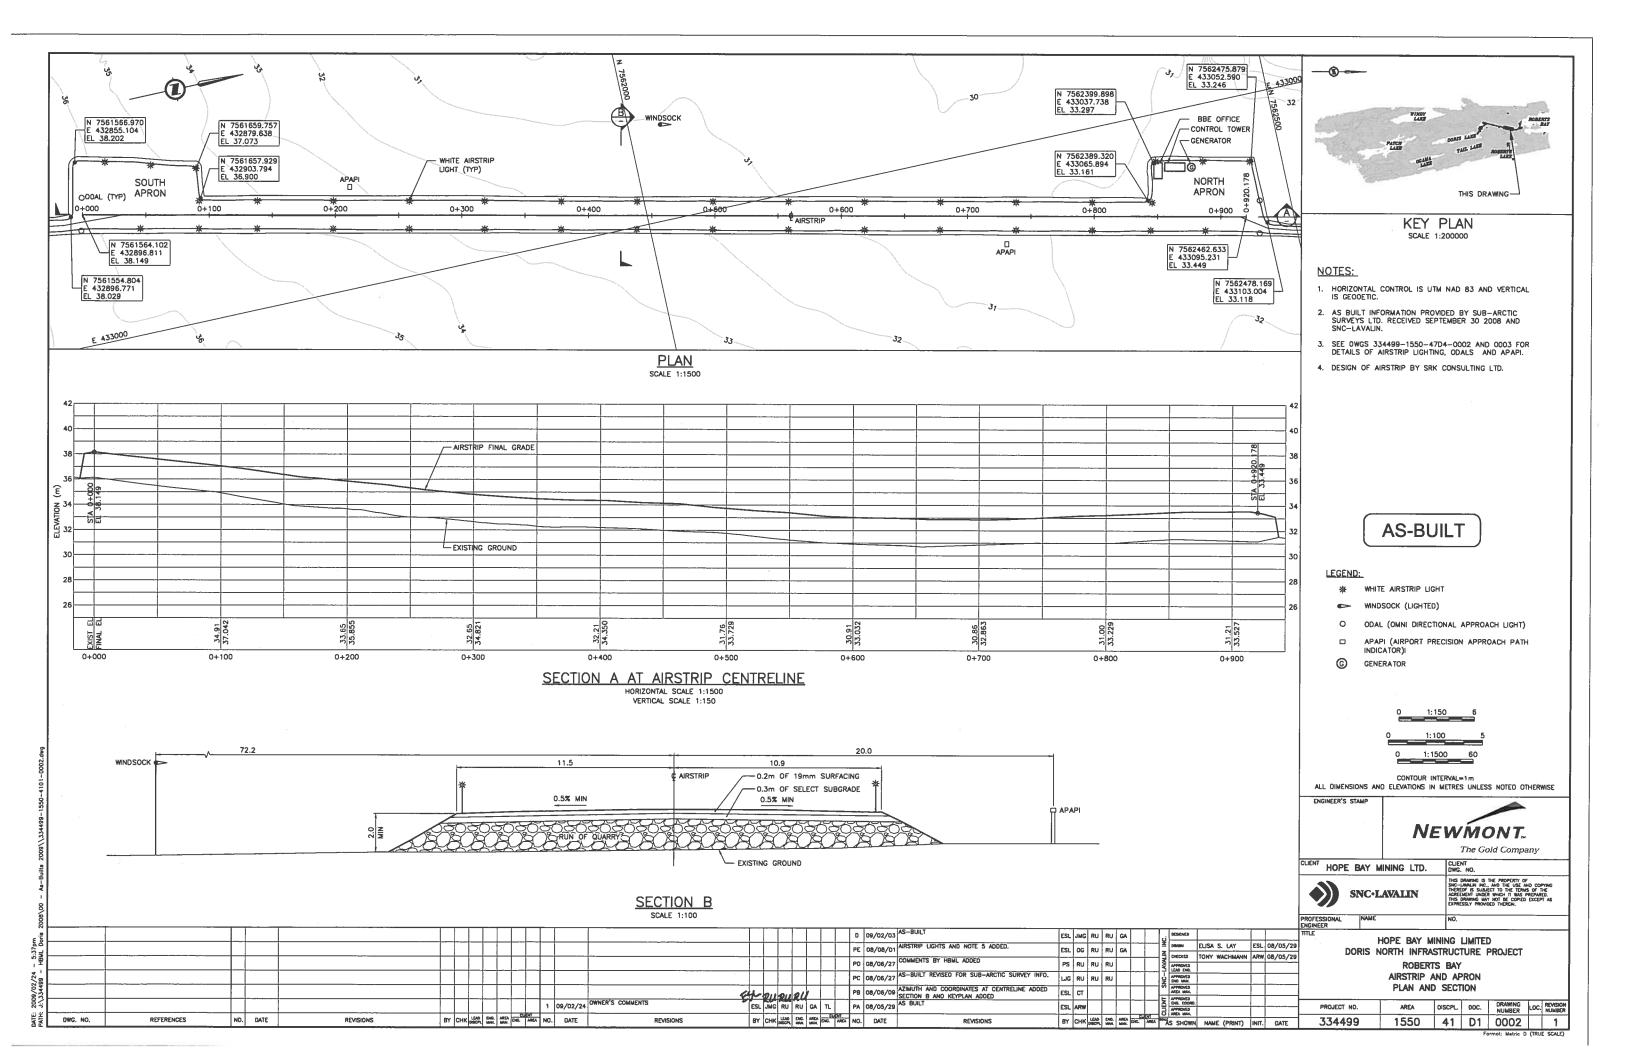
8a Relevant Drawings Submitted with Original Water License Application

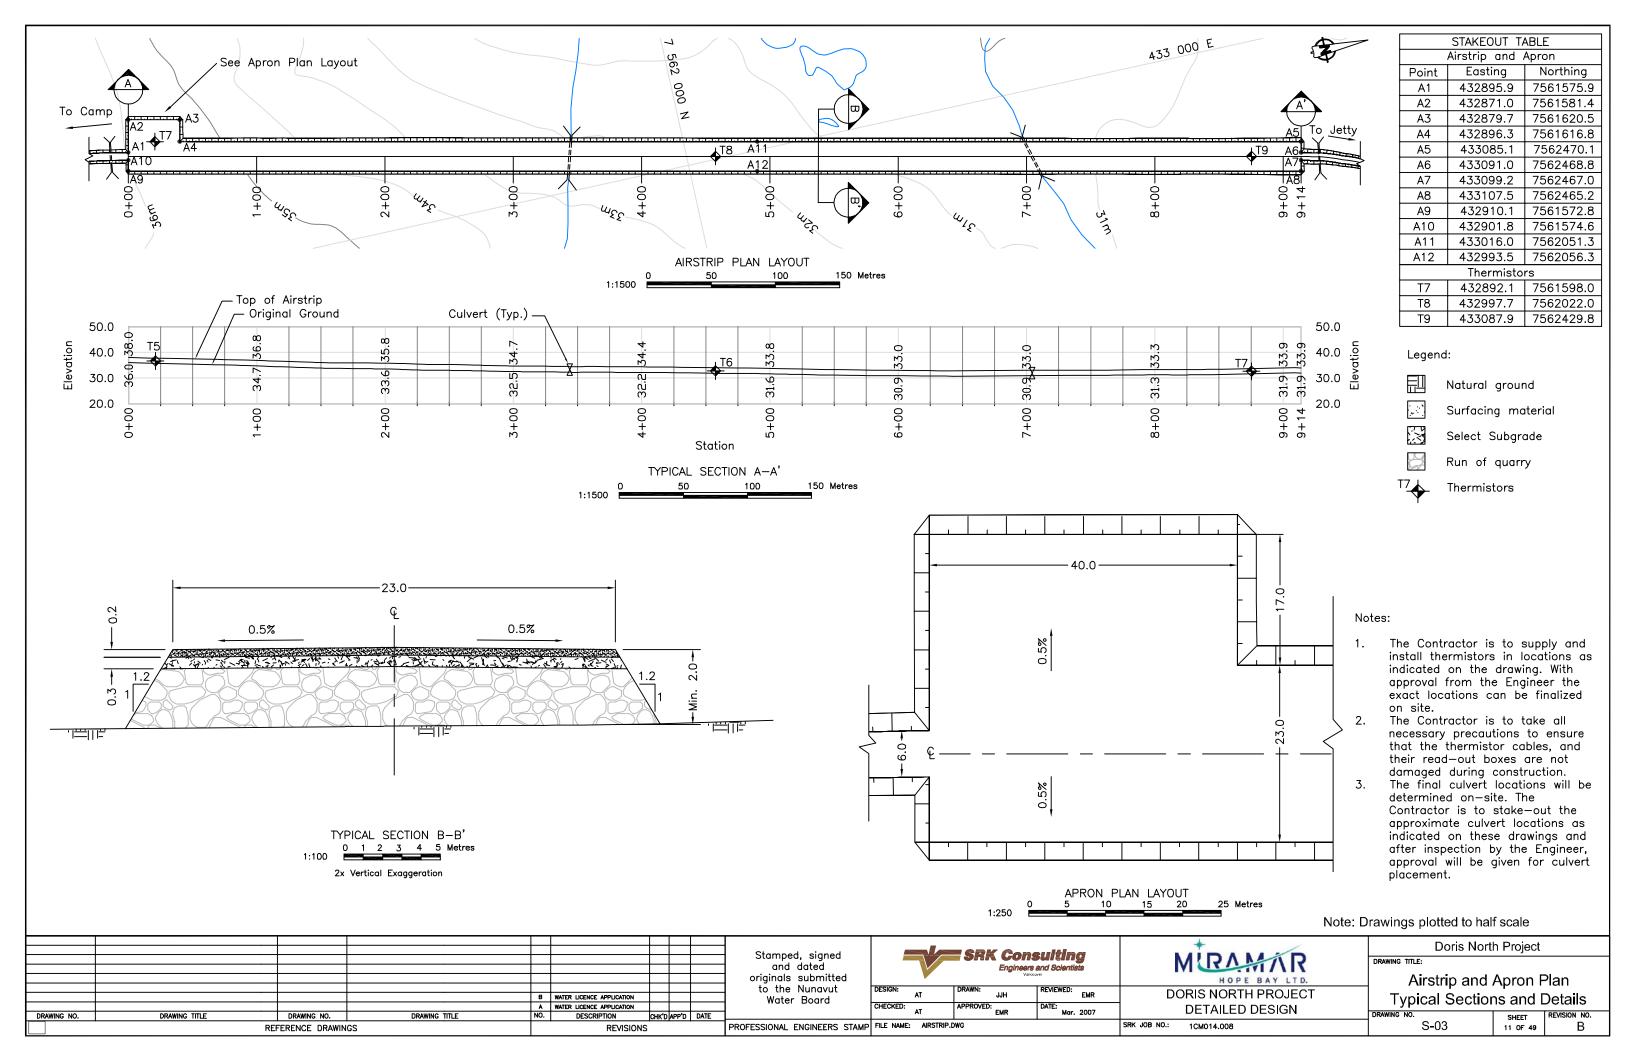

8b Issued for Construction

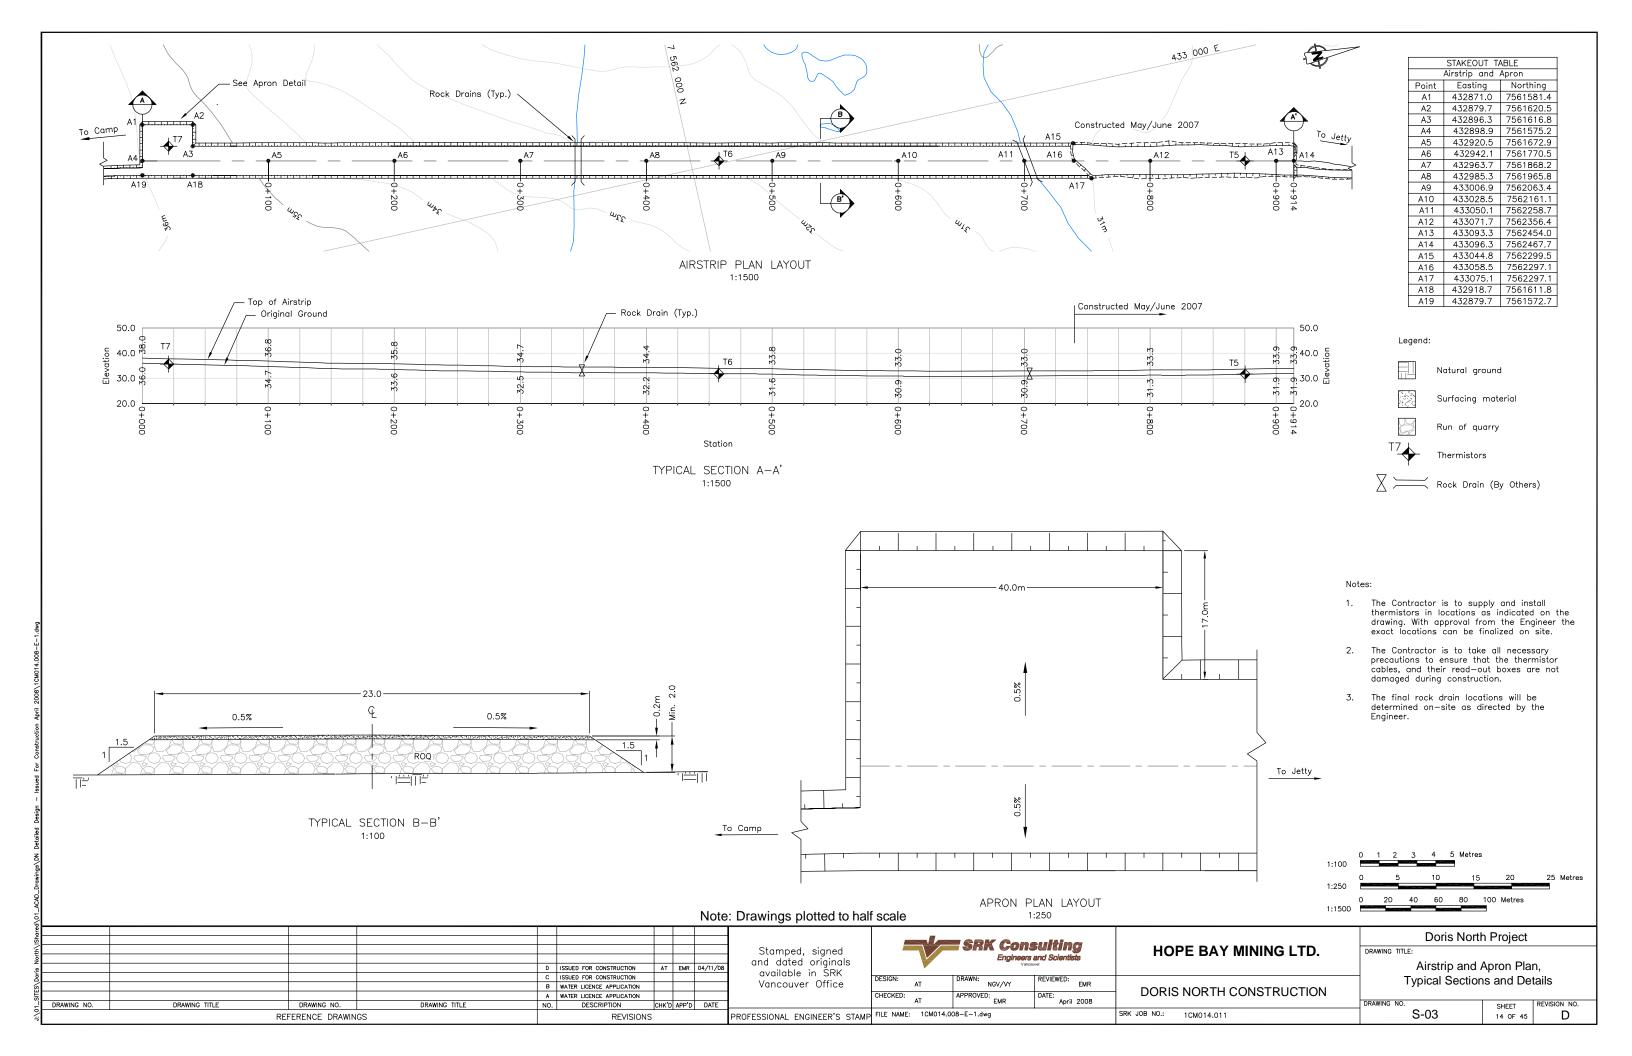


8c As-Built Drawings for Constructed Facilities



9. Camp

9a Relevant Drawings Submitted with Original Water License Application

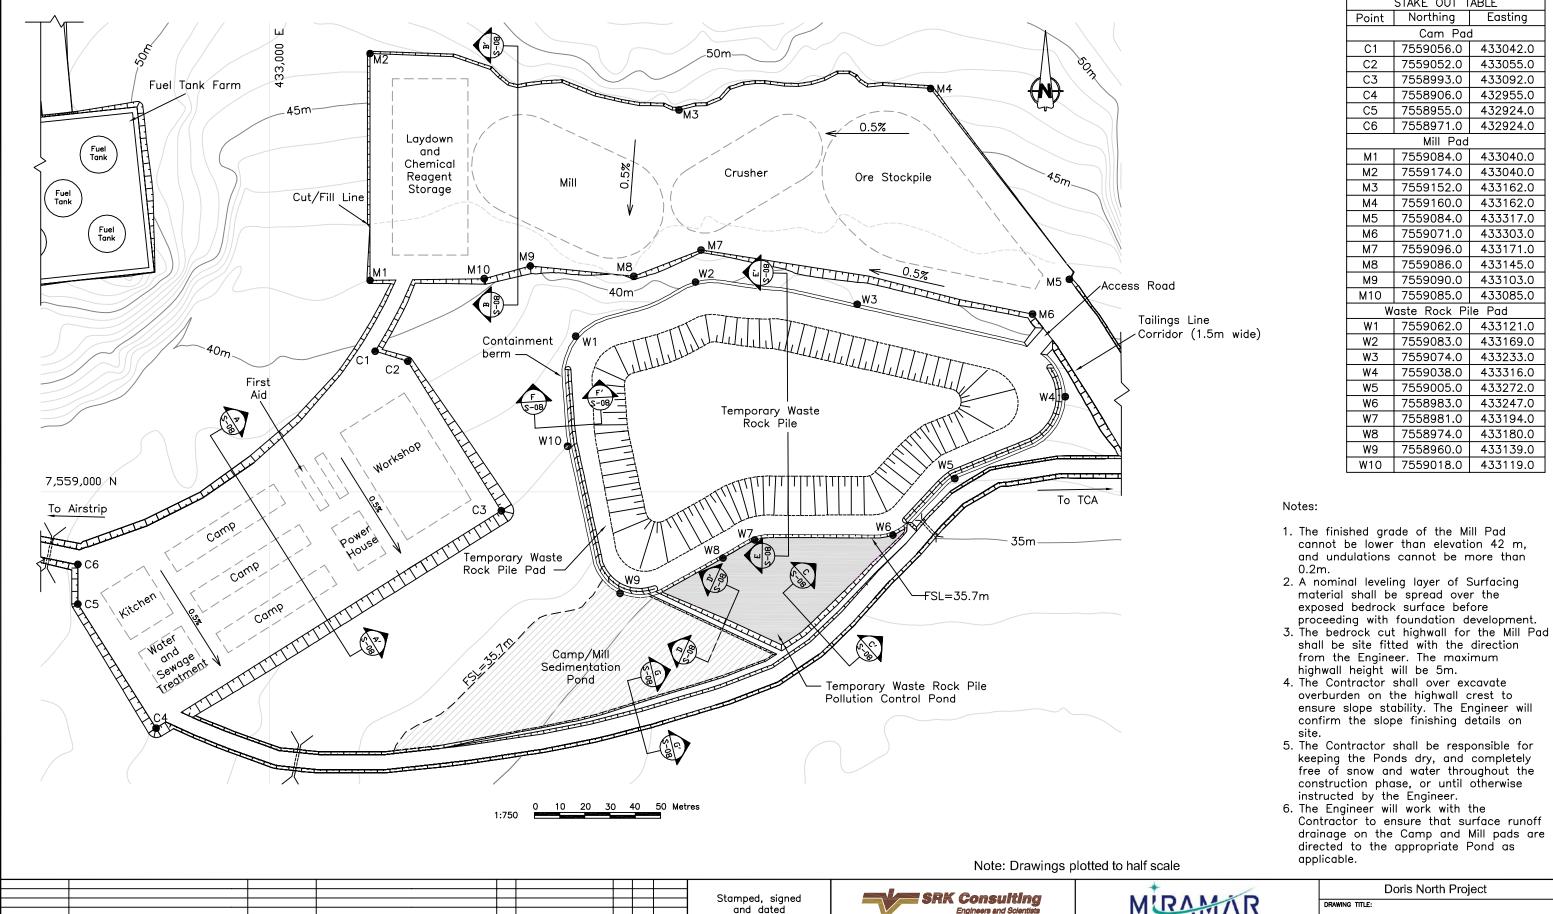

originals submitted

to the Nunavut

Water Board

B WATER LICENCE APPLICATION

A WATER LICENCE APPLICATION
NO. DESCRIPTION

CHK'D APP'D

REVISIONS

DRAWING TITLE

REFERENCE DRAWINGS

DRAWING TITLE

STAKE OUT TABLE				
Point	Northing	Easting		
Cam Pad				
C1	7559056.0	433042.0		
C2	7559052.0	433055.0		
C3	7558993.0	433092.0		
C4	7558906.0	432955.0		
C5	7558955.0	432924.0		
C6	7558971.0	432924.0		
	Mill Pad			
М1	7559084.0	433040.0		
M2	7559174.0	433040.0		
М3	7559152.0	433162.0		
М4	7559160.0	433162.0		
М5	7559084.0	433317.0		
М6	7559071.0	433303.0		
М7	7559096.0	433171.0		
М8	7559086.0	433145.0		
М9	7559090.0	433103.0		
M10	7559085.0	433085.0		
Waste Rock Pile Pad				
W1	7559062.0	433121.0		
W2	7559083.0	433169.0		
W3	7559074.0	433233.0		
W4	7559038.0	433316.0		
W5	7559005.0	433272.0		
W6	7558983.0	433247.0		
W7	7558981.0	433194.0		
W8	7558974.0	433180.0		
W9	7558960.0	433139.0		
W10	7559018.0	433119.0		


- 1. The finished grade of the Mill Pad cannot be lower than elevation 42 m, and undulations cannot be more than
- 2. A nominal leveling layer of Surfacing material shall be spread over the exposed bedrock surface before
- shall be site fitted with the direction from the Engineer. The maximum highwall height will be 5m.
- overburden on the highwall crest to ensure slope stability. The Engineer will confirm the slope finishing details on
- 5. The Contractor shall be responsible for keeping the Ponds dry, and completely free of snow and water throughout the construction phase, or until otherwise instructed by the Engineer.
- 6. The Engineer will work with the Contractor to ensure that surface runoff drainage on the Camp and Mill pads are directed to the appropriate Pond as

SRK Consulting MIRAMINR EVIEWED: EMR DORIS NORTH PROJECT **DETAILED DESIGN** PROFESSIONAL ENGINEERS STAMP FILE NAME: MILL AND CAMP PLAN_rev1A.dwg SRK JOB NO.: 1CM014.008


Doris North Project


Camp and Mill Pad Plan


SHEET 15 OF 49 S-07

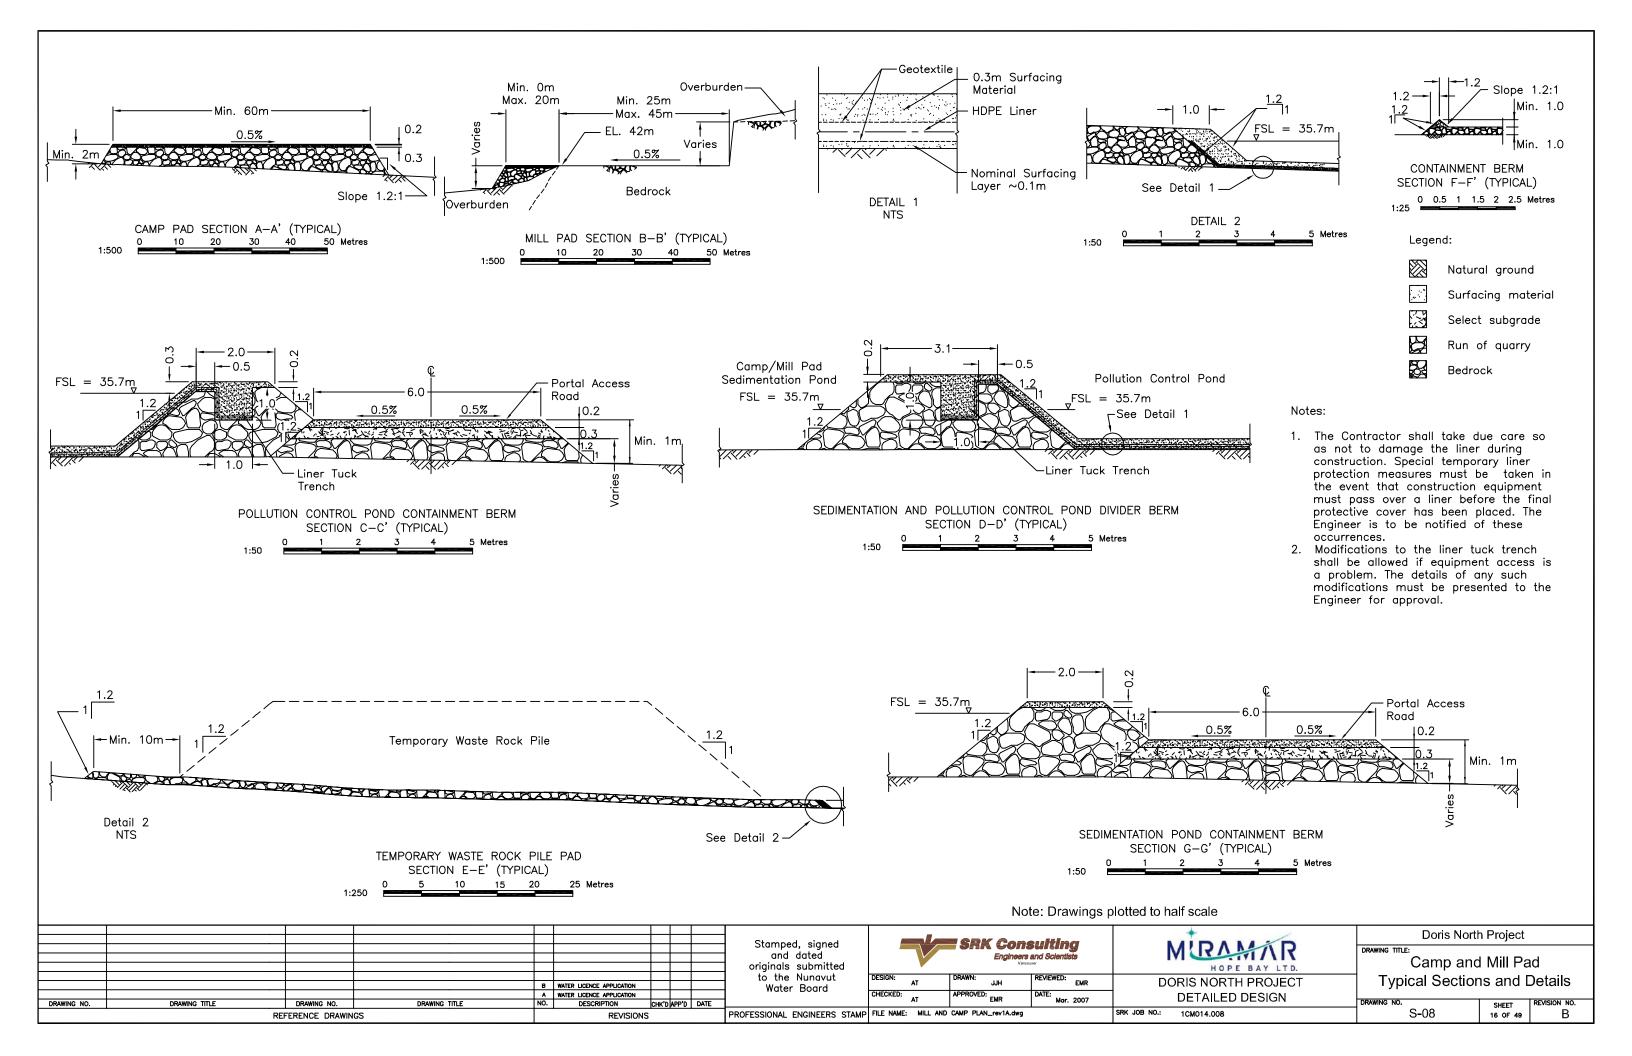


9b Issued for Construction

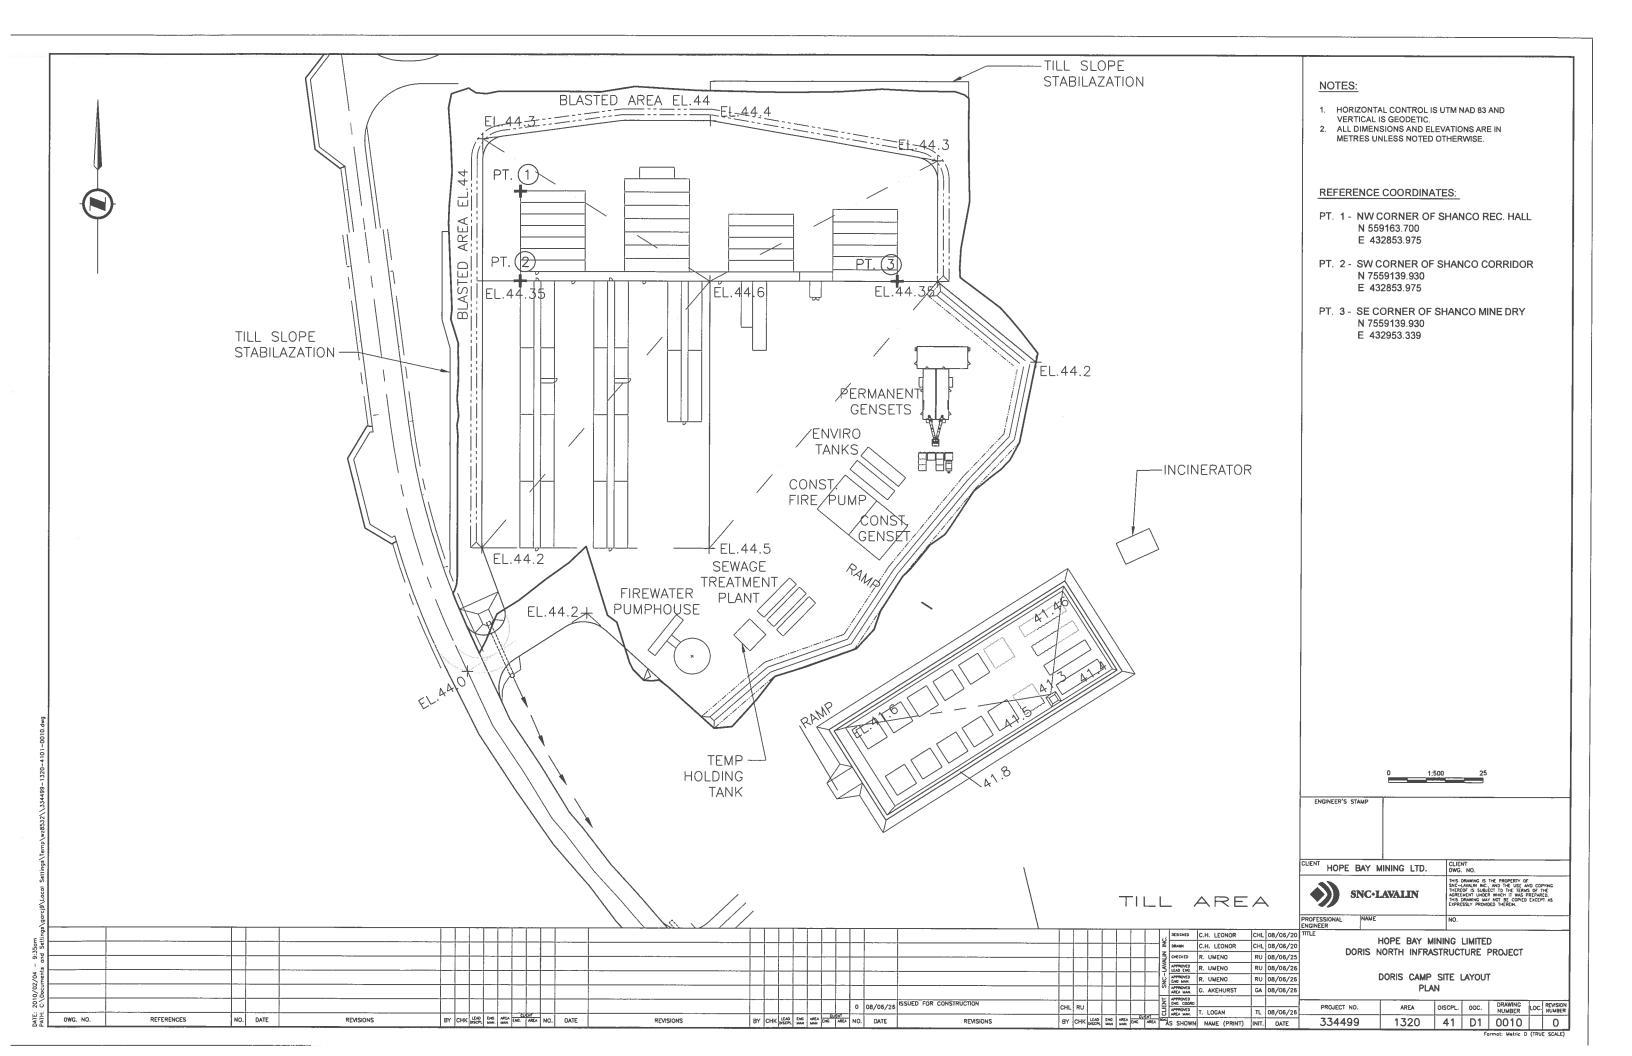


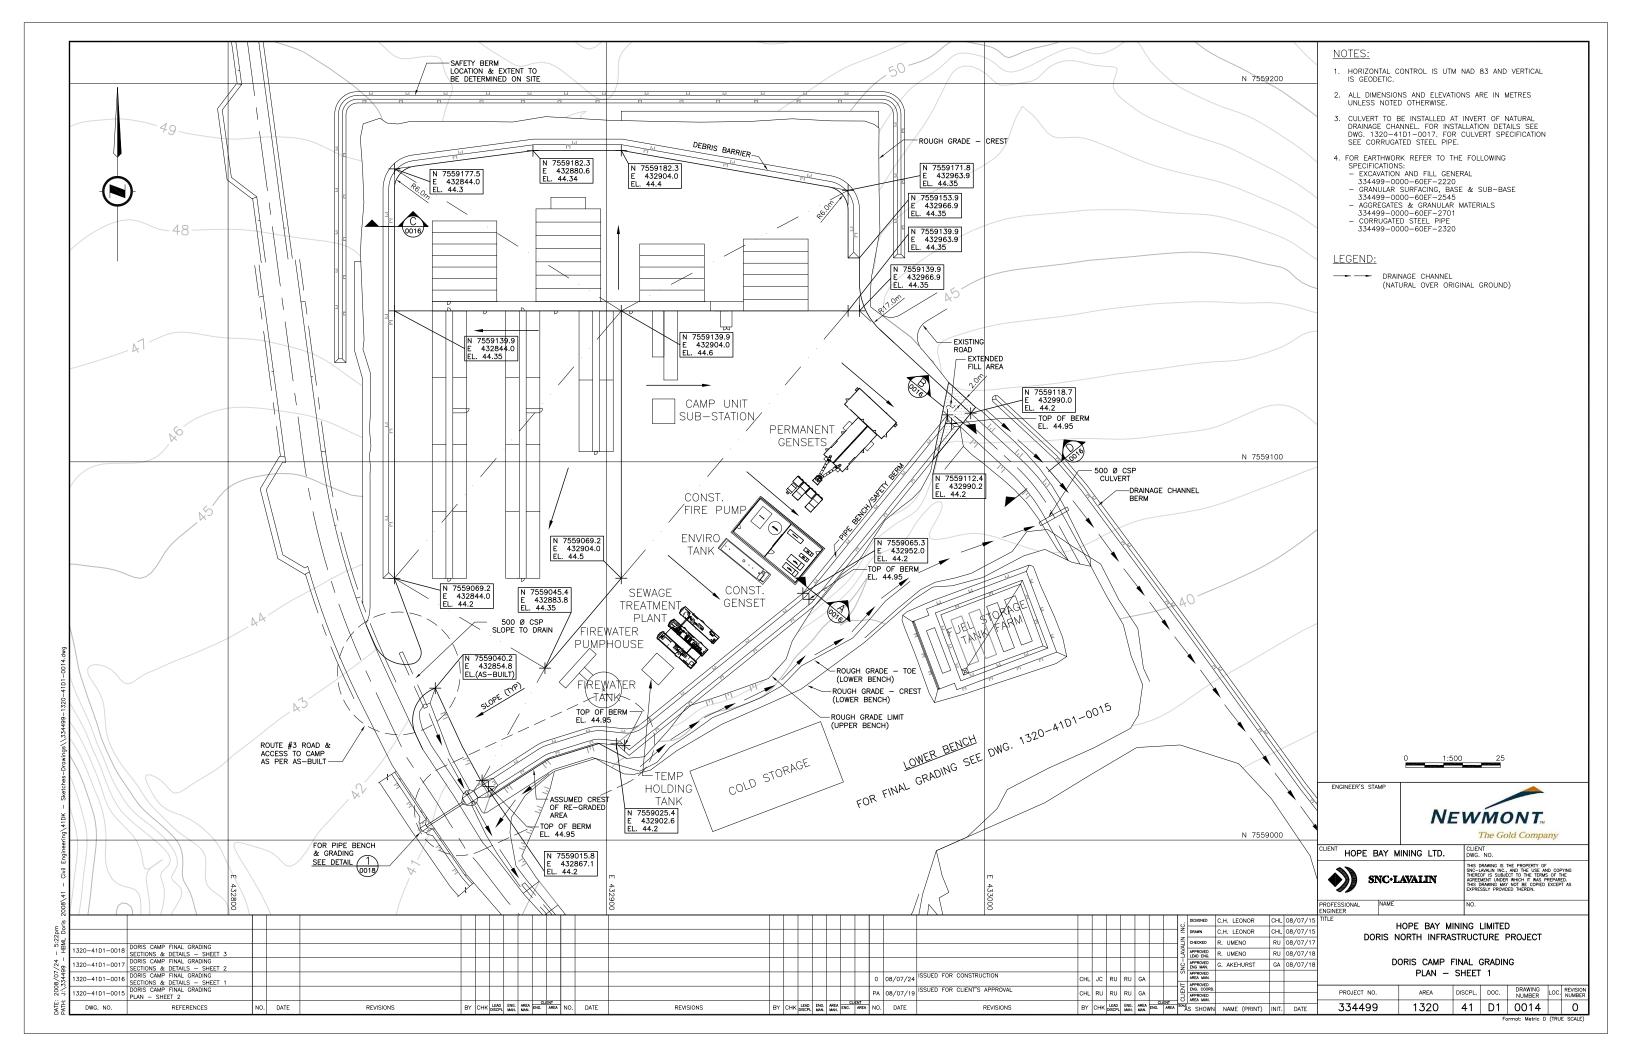


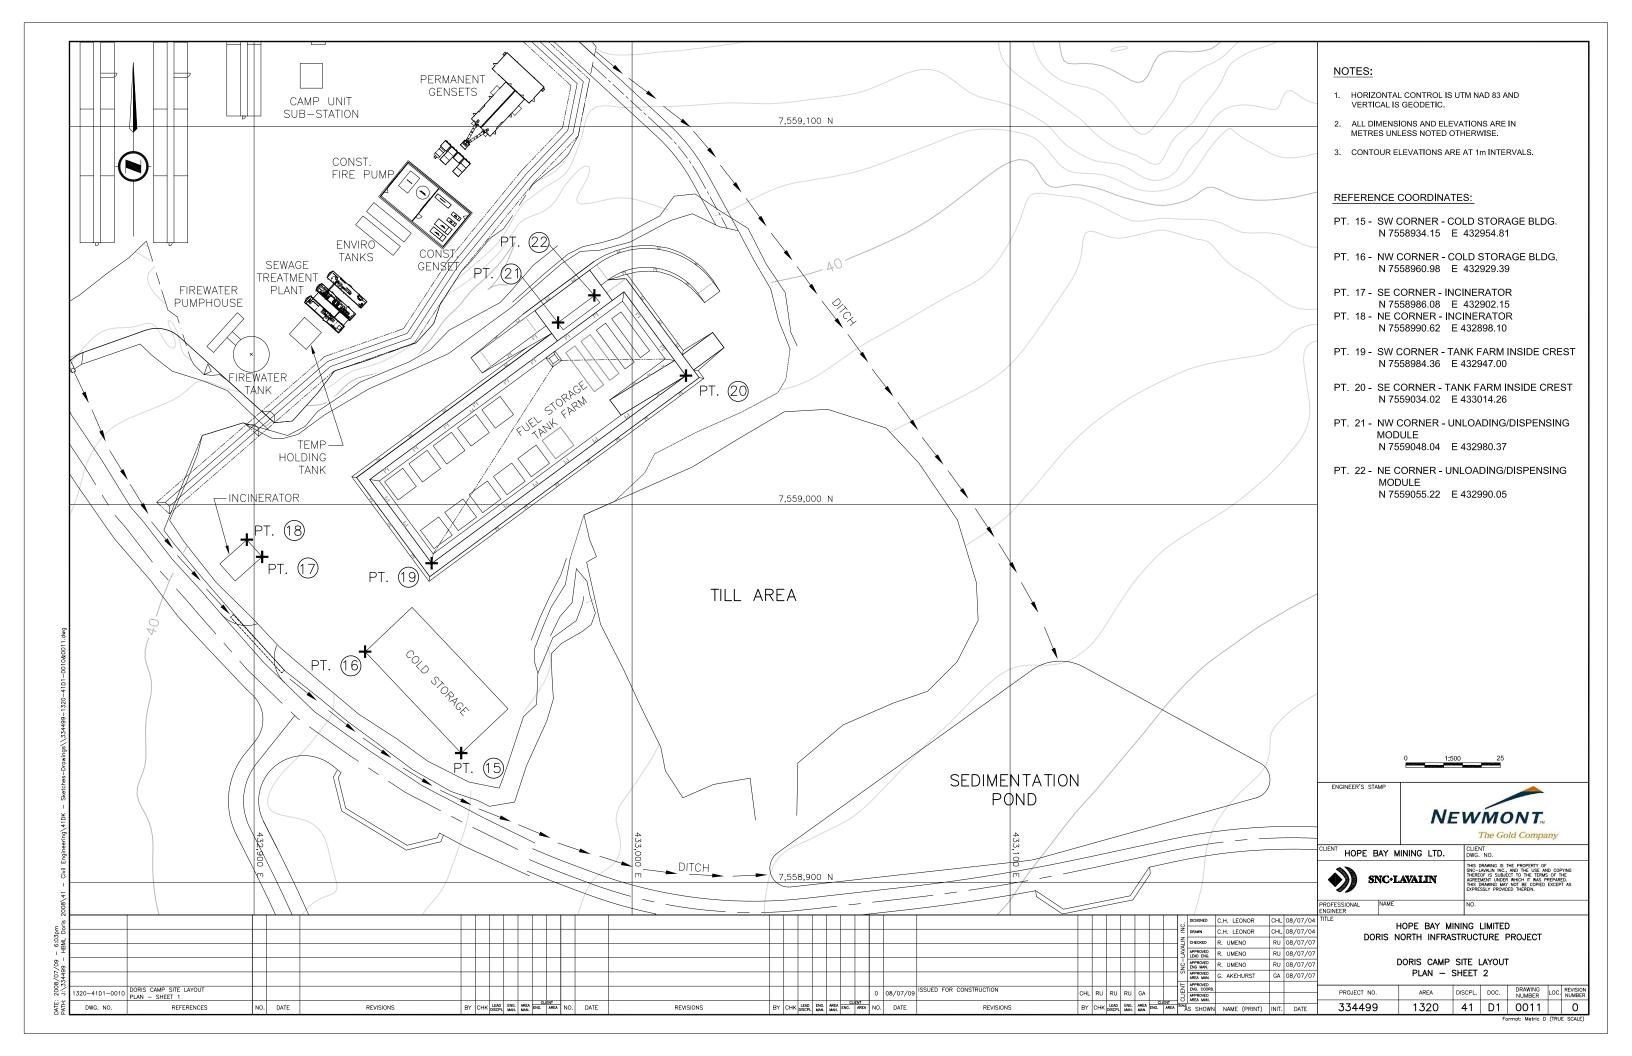


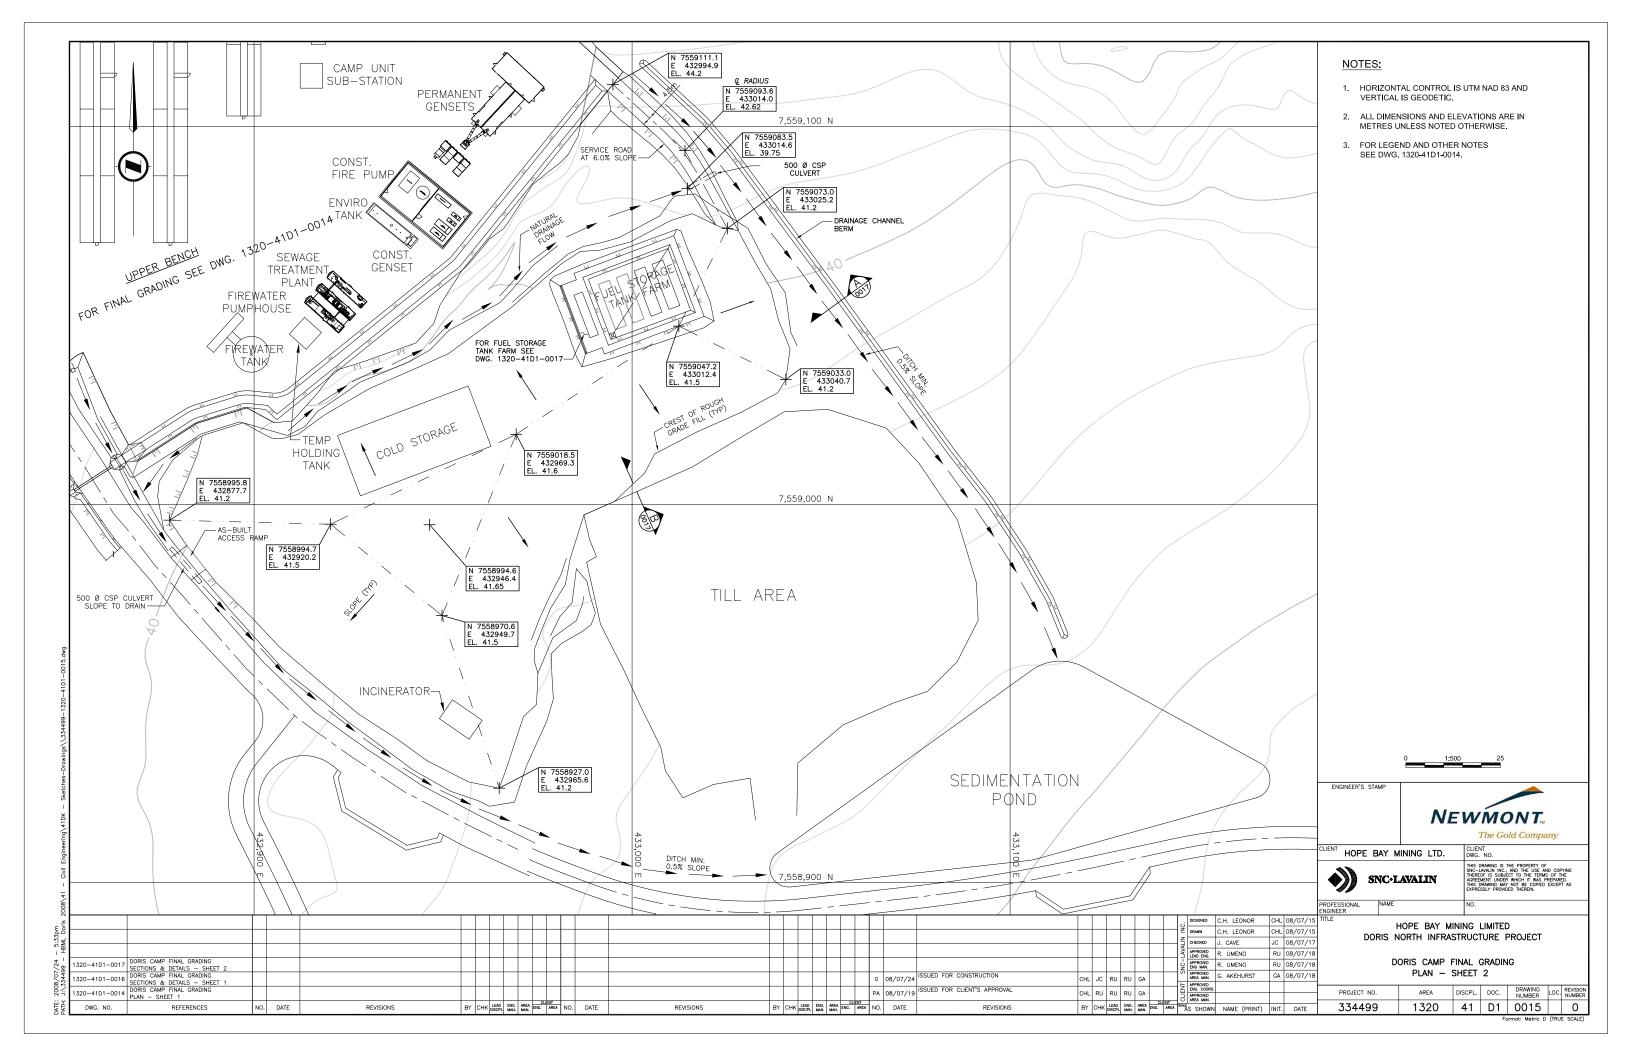



9c As-Built Drawings for Constructed Facilities

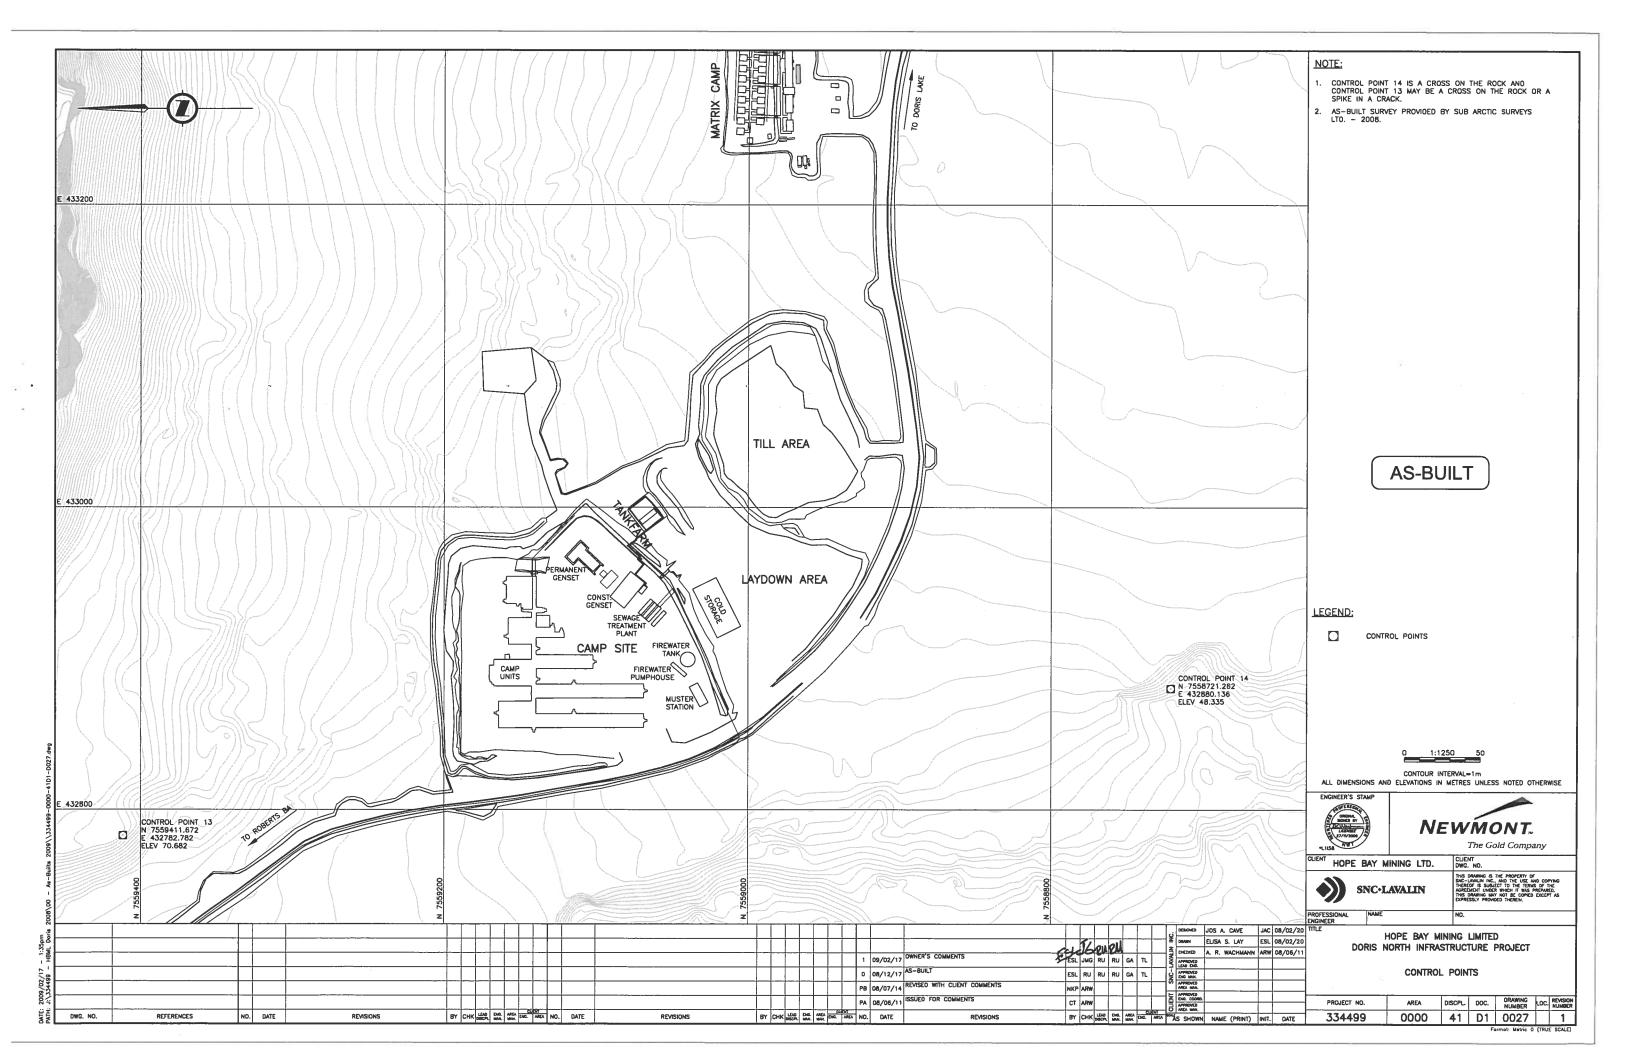


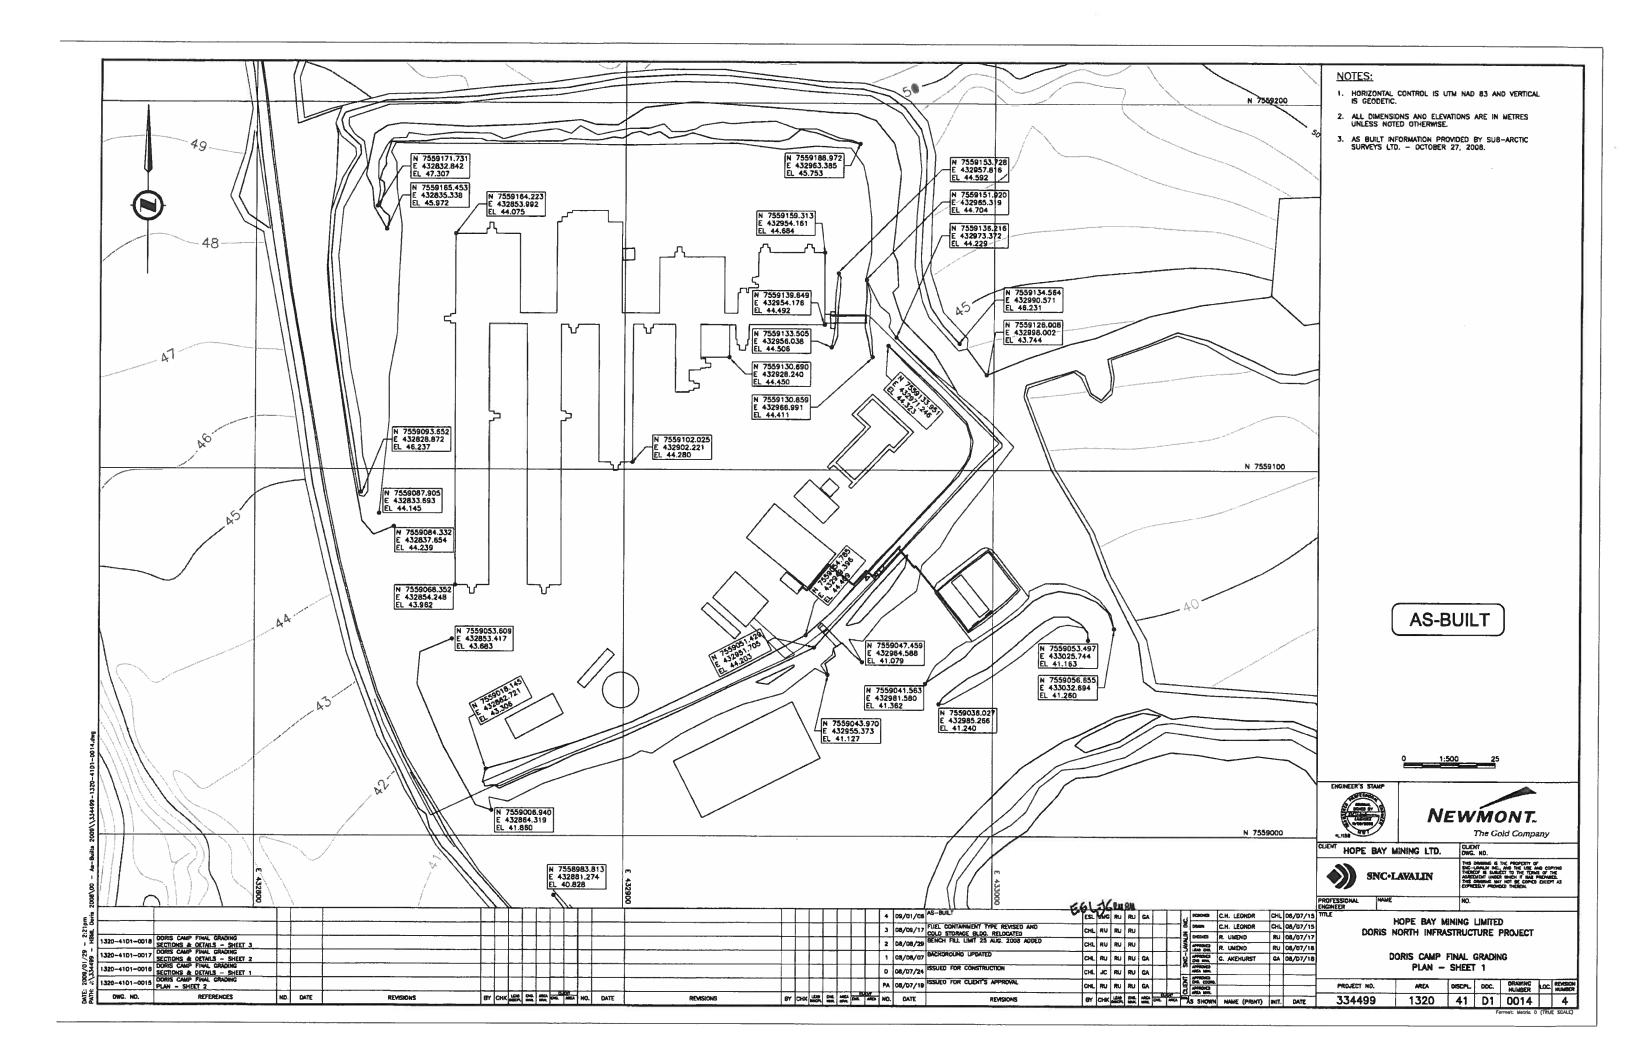


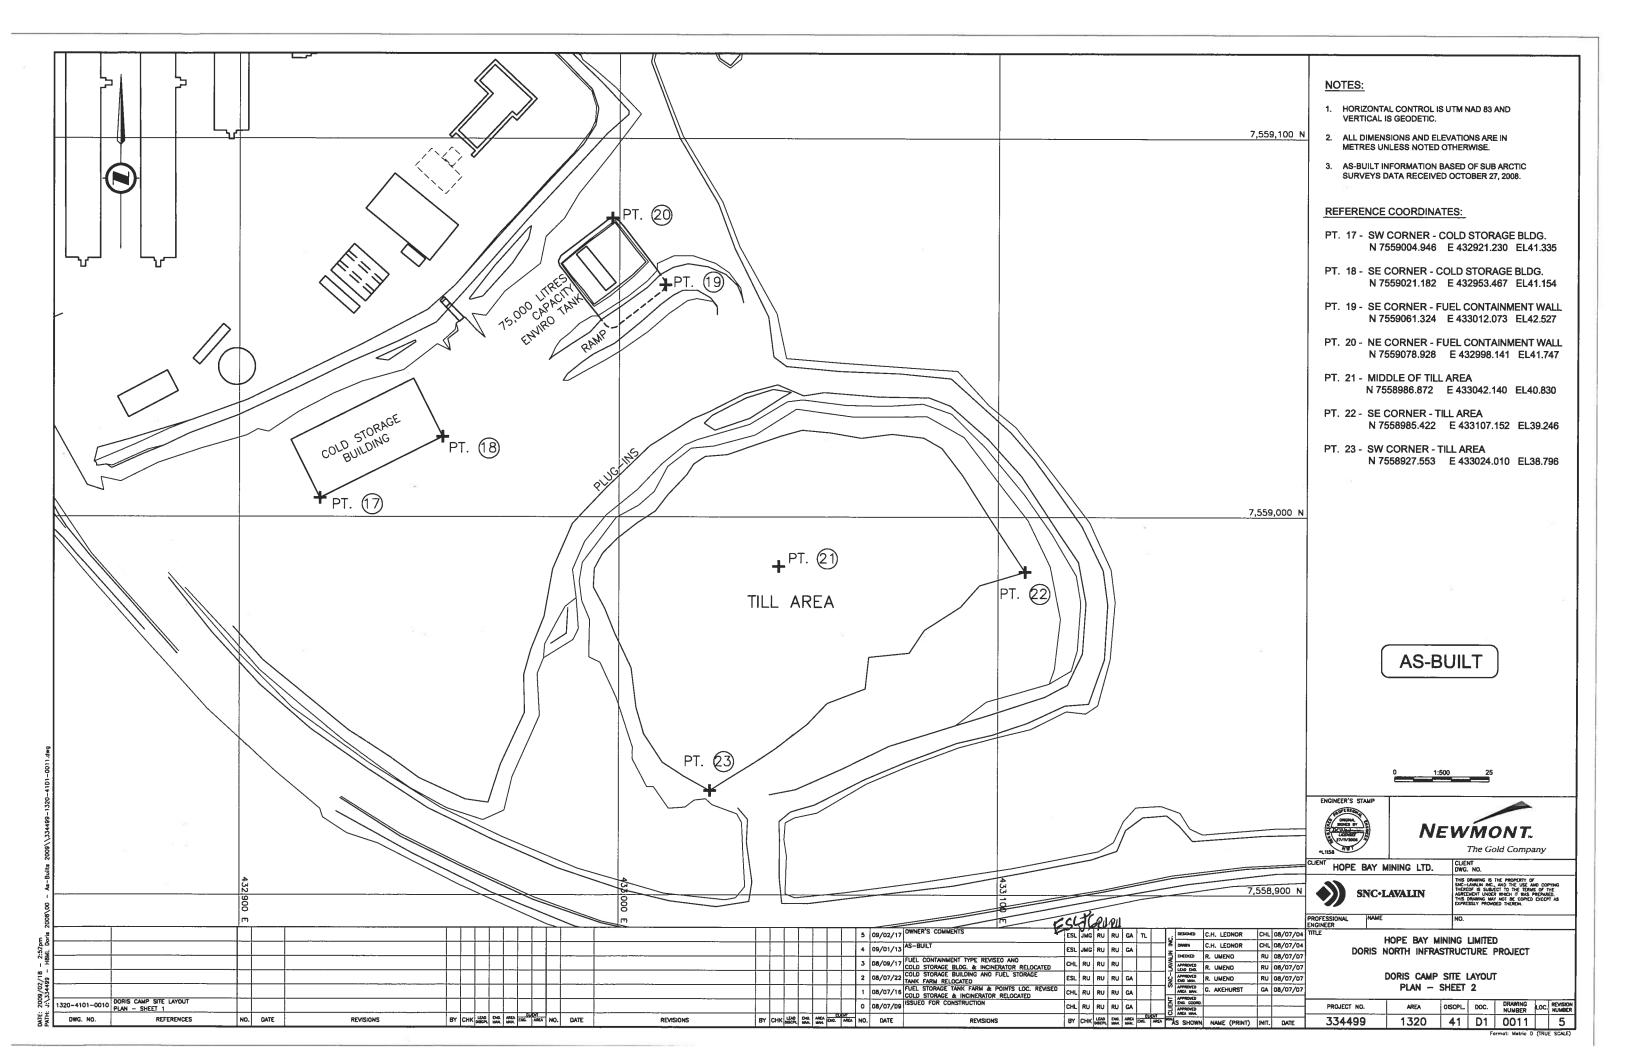


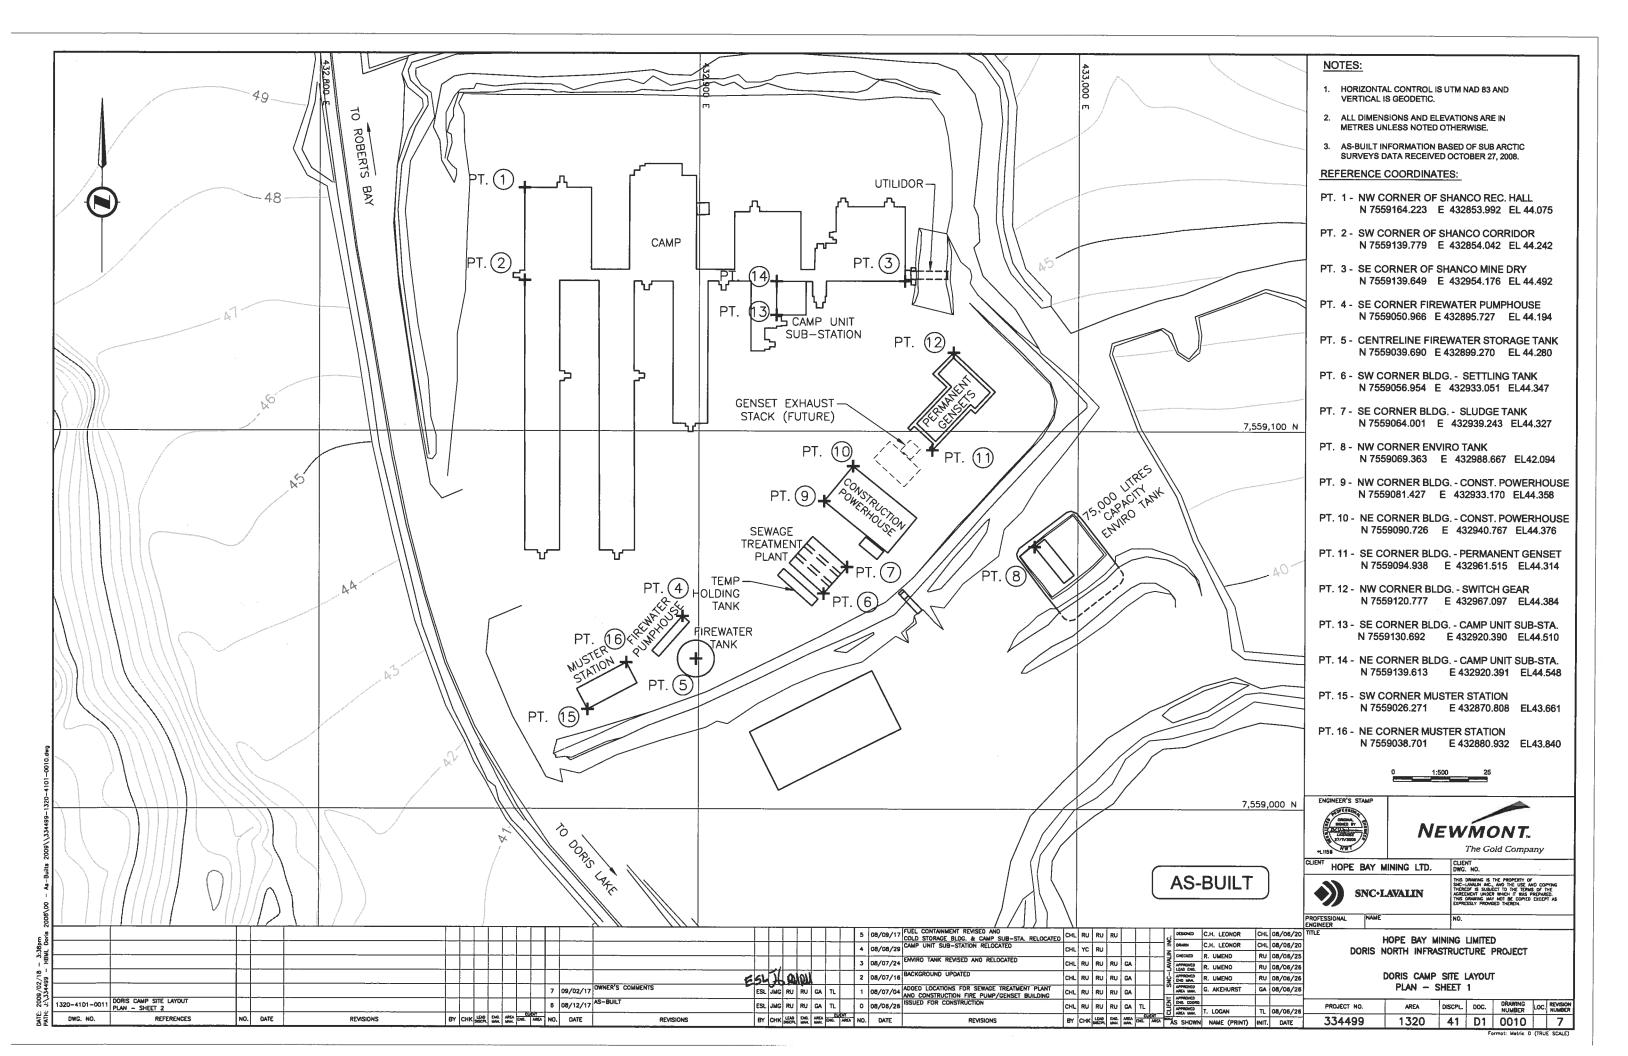

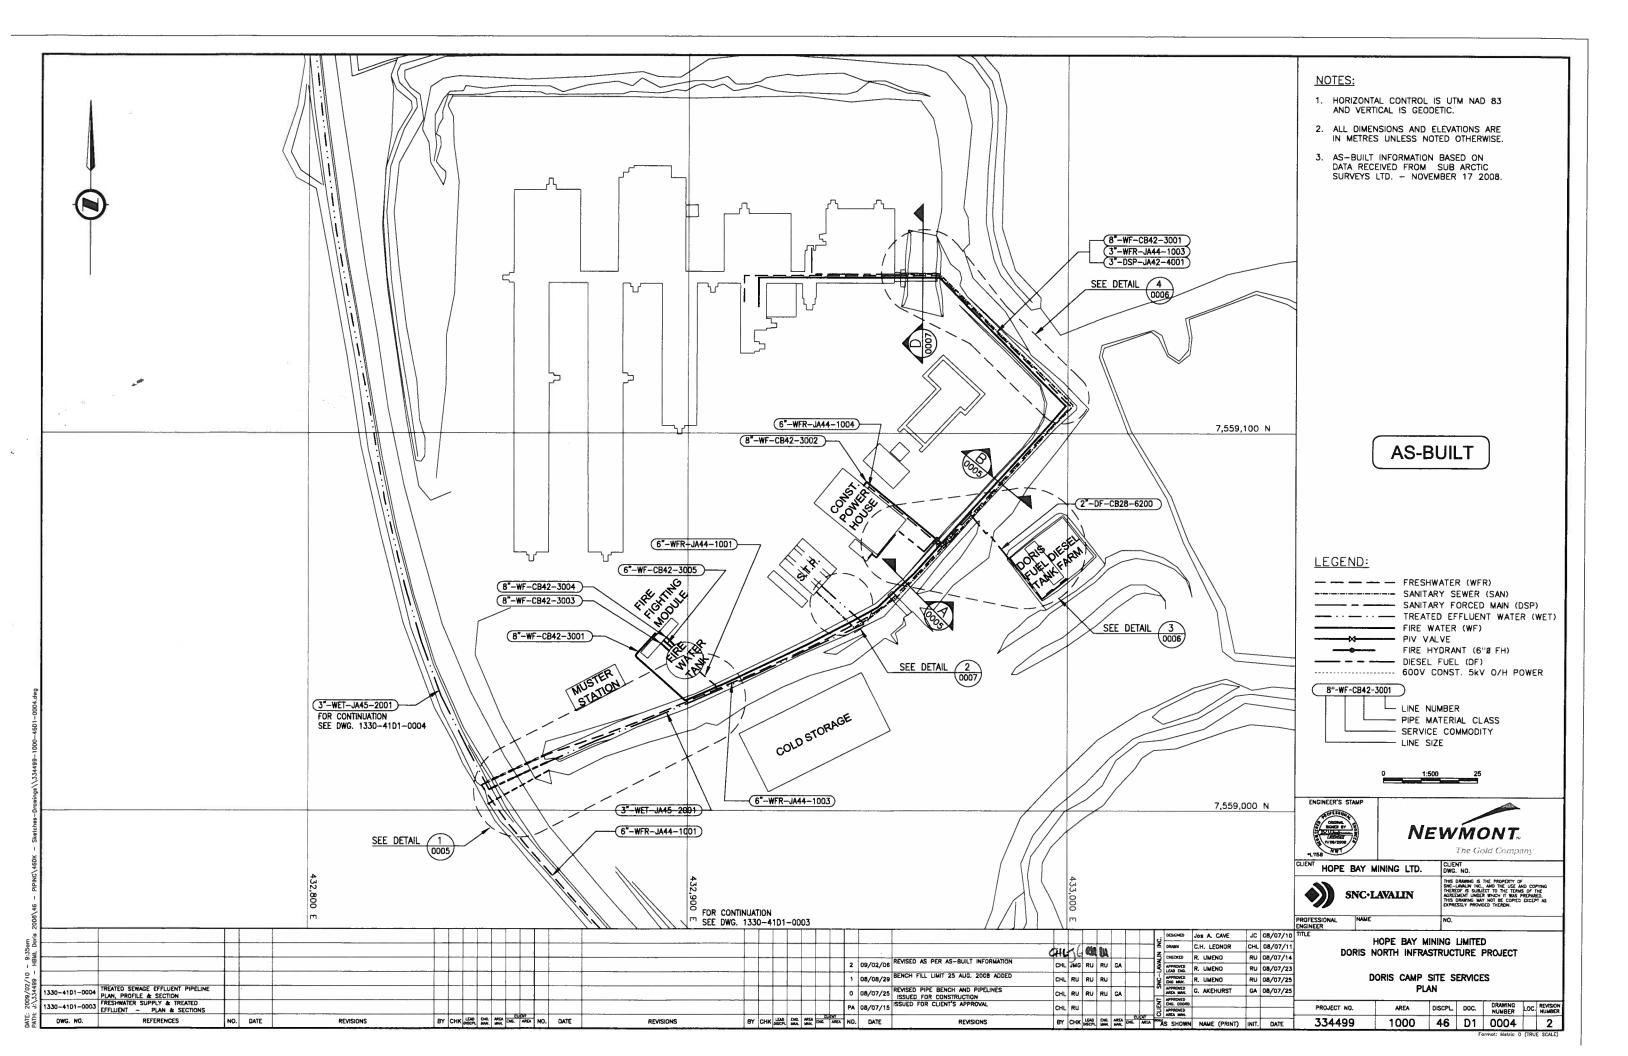

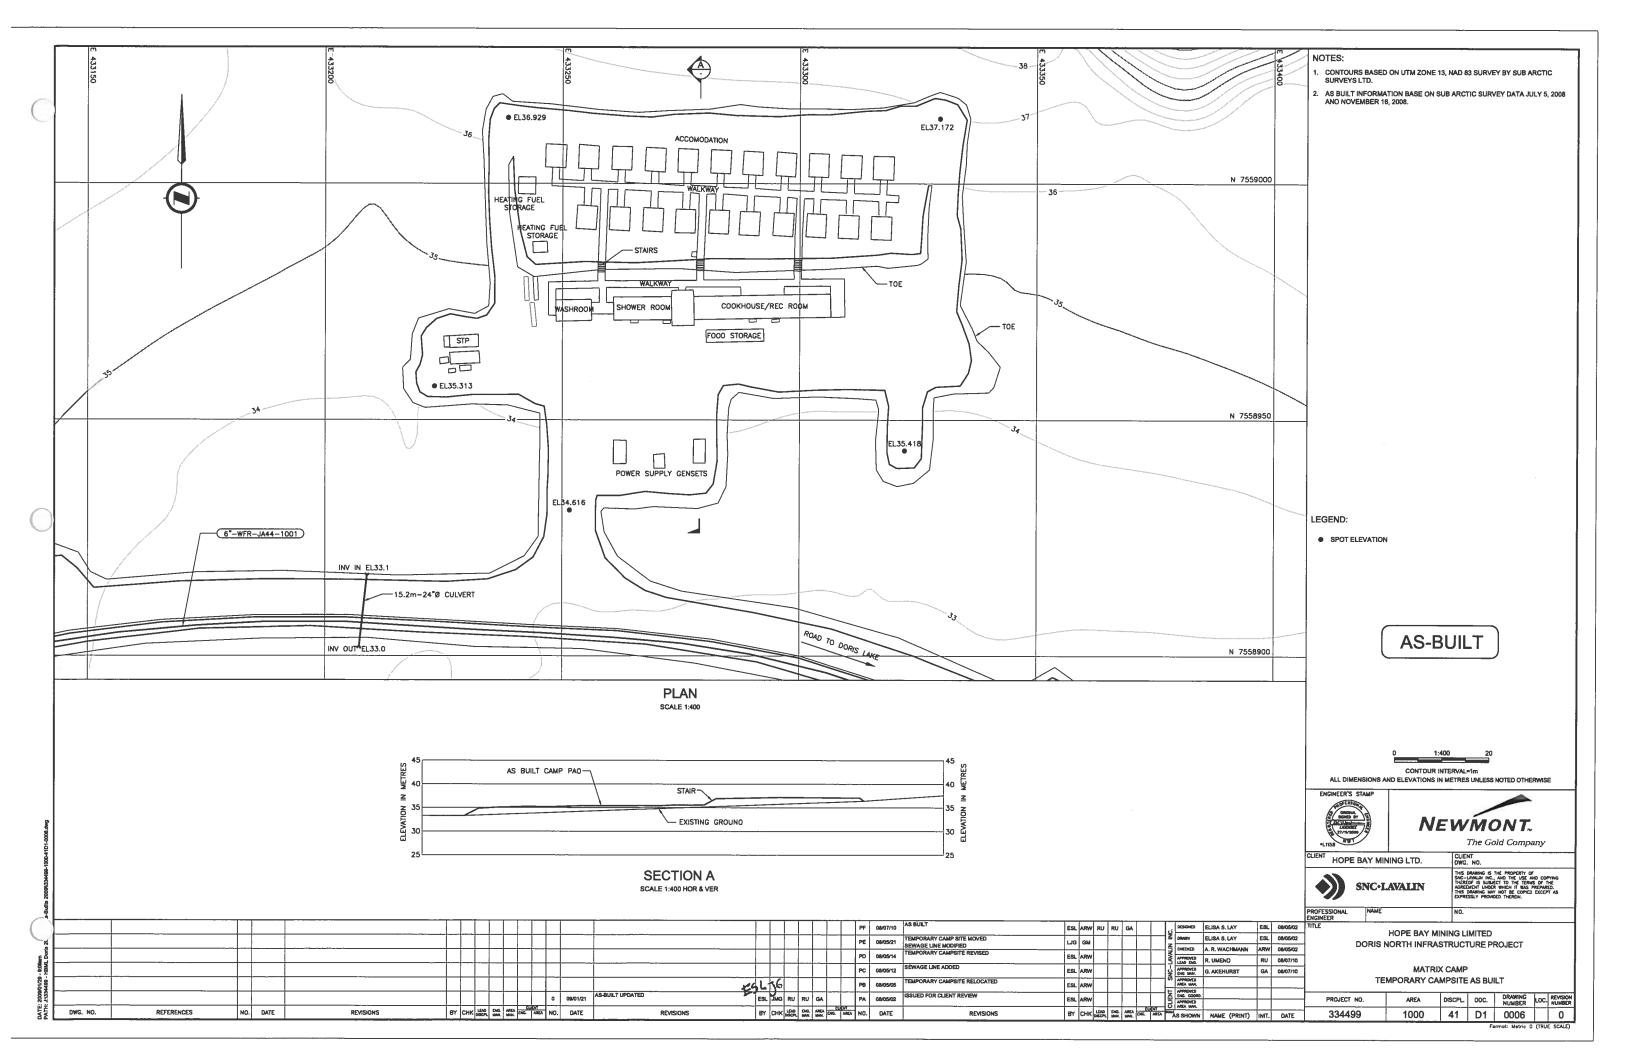


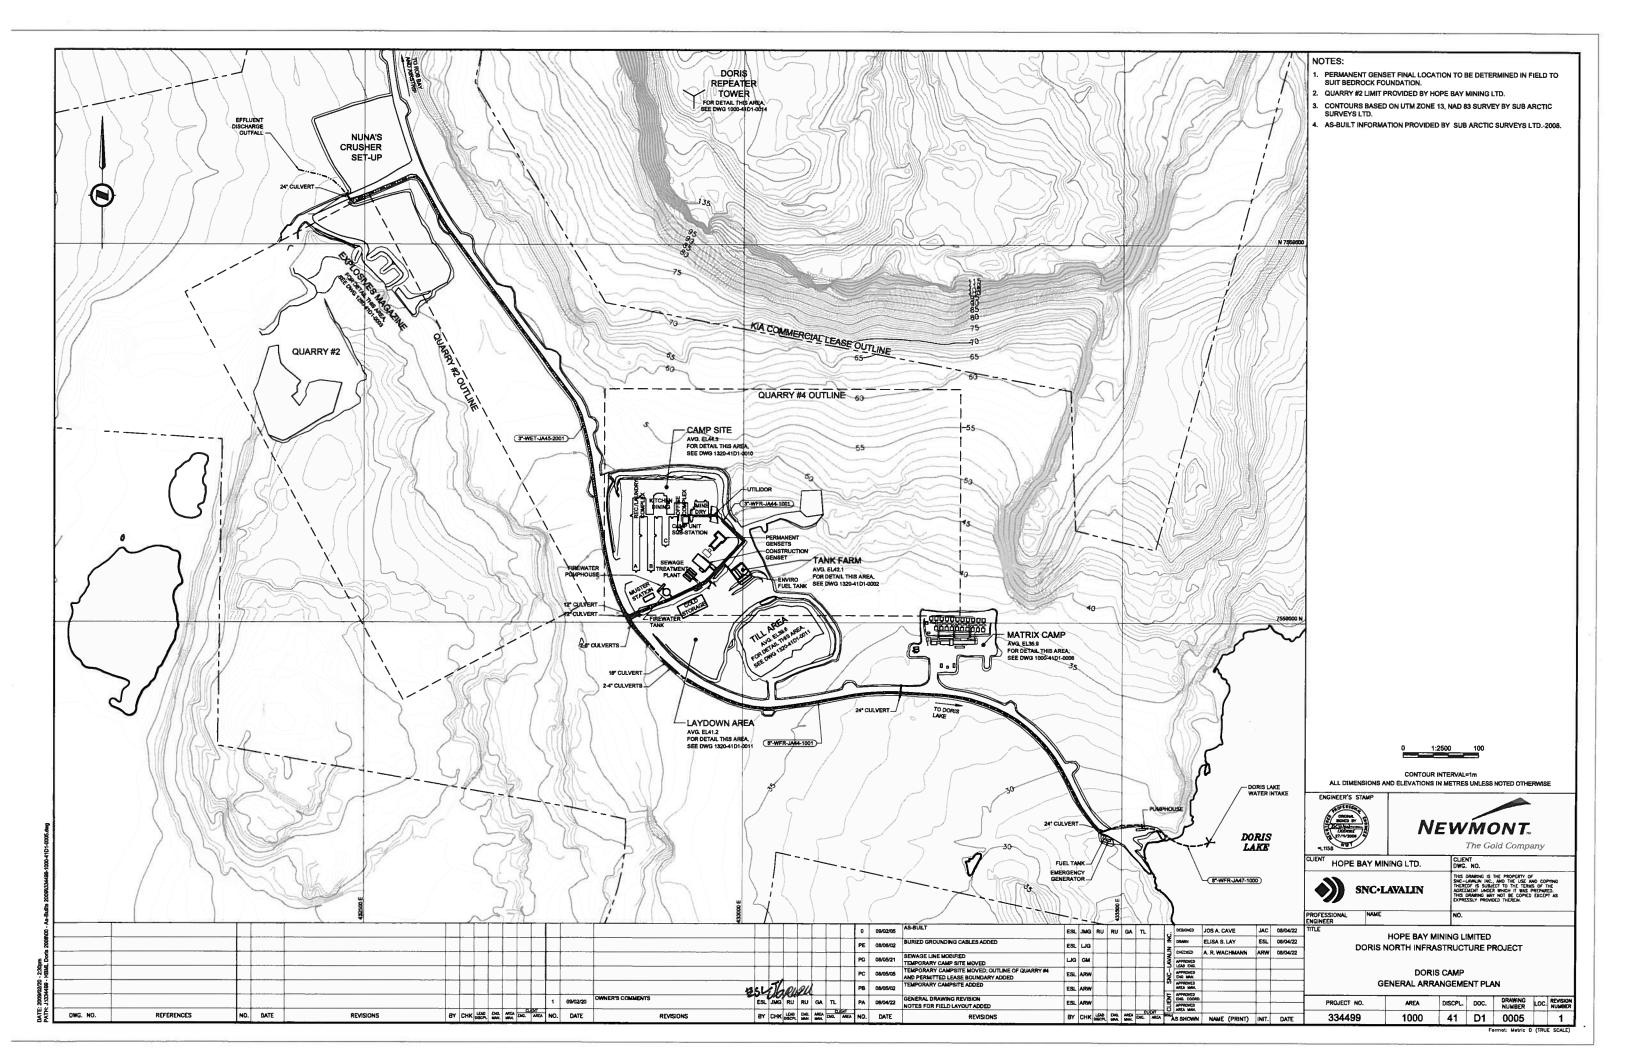


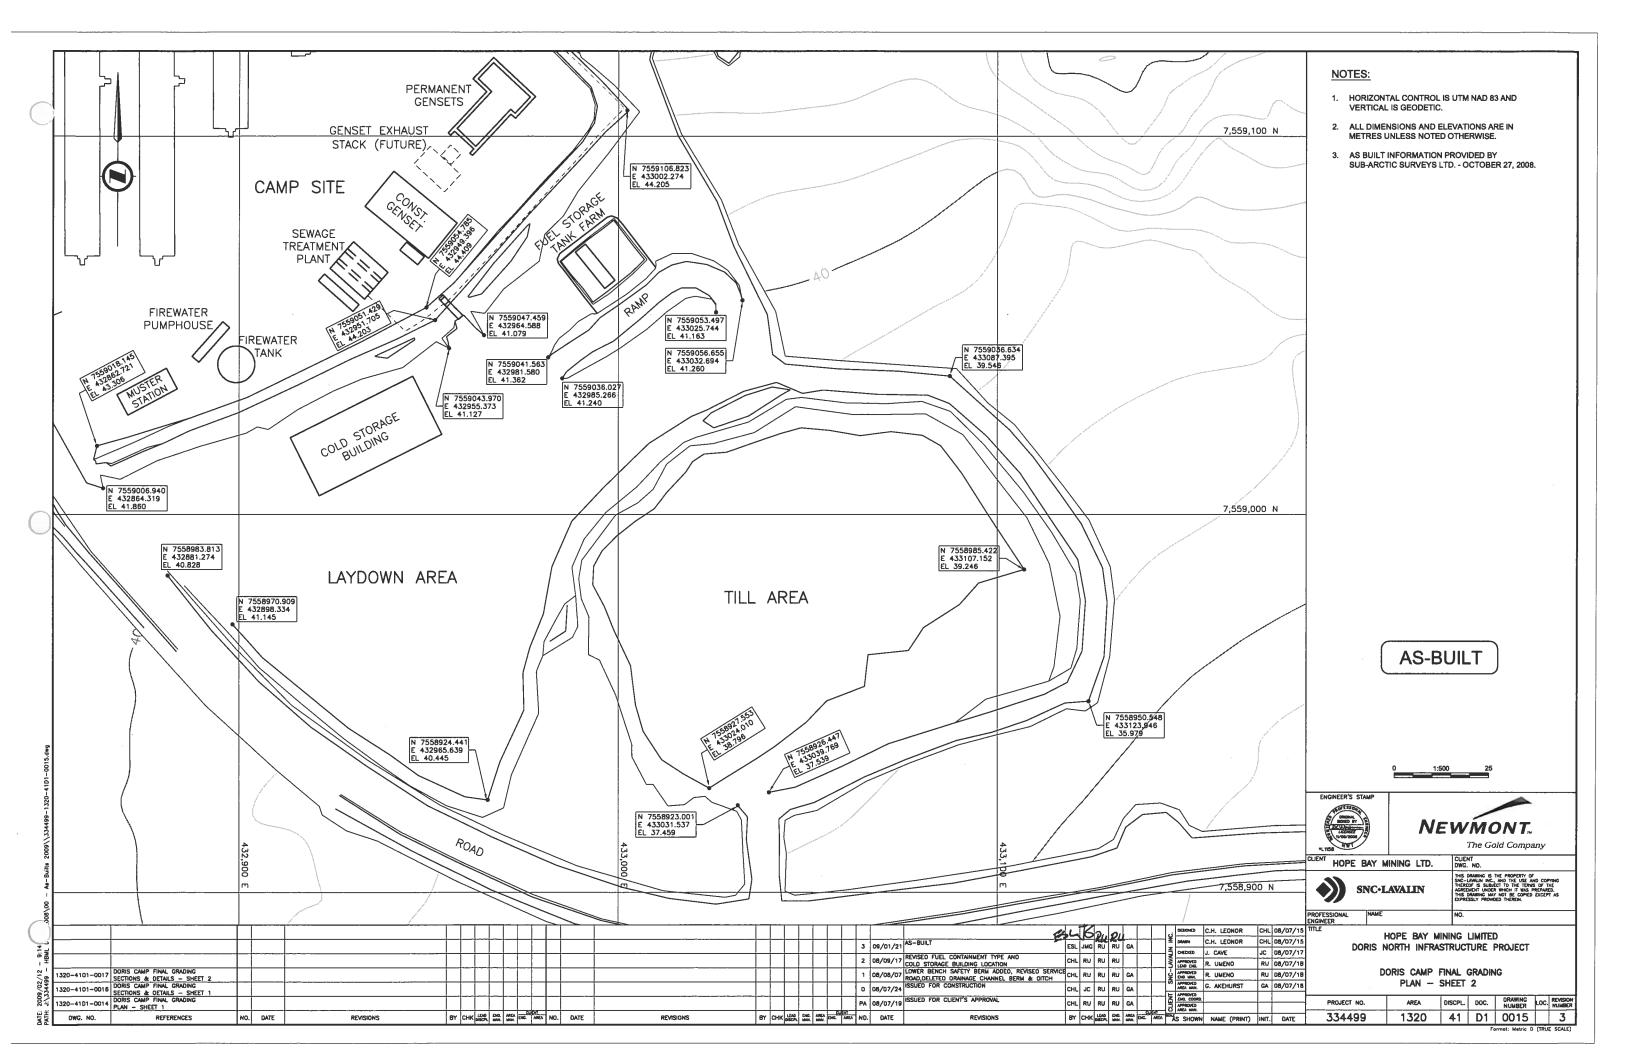


10. Jetty


10a Relevant Drawings Submitted with Original Water License Application

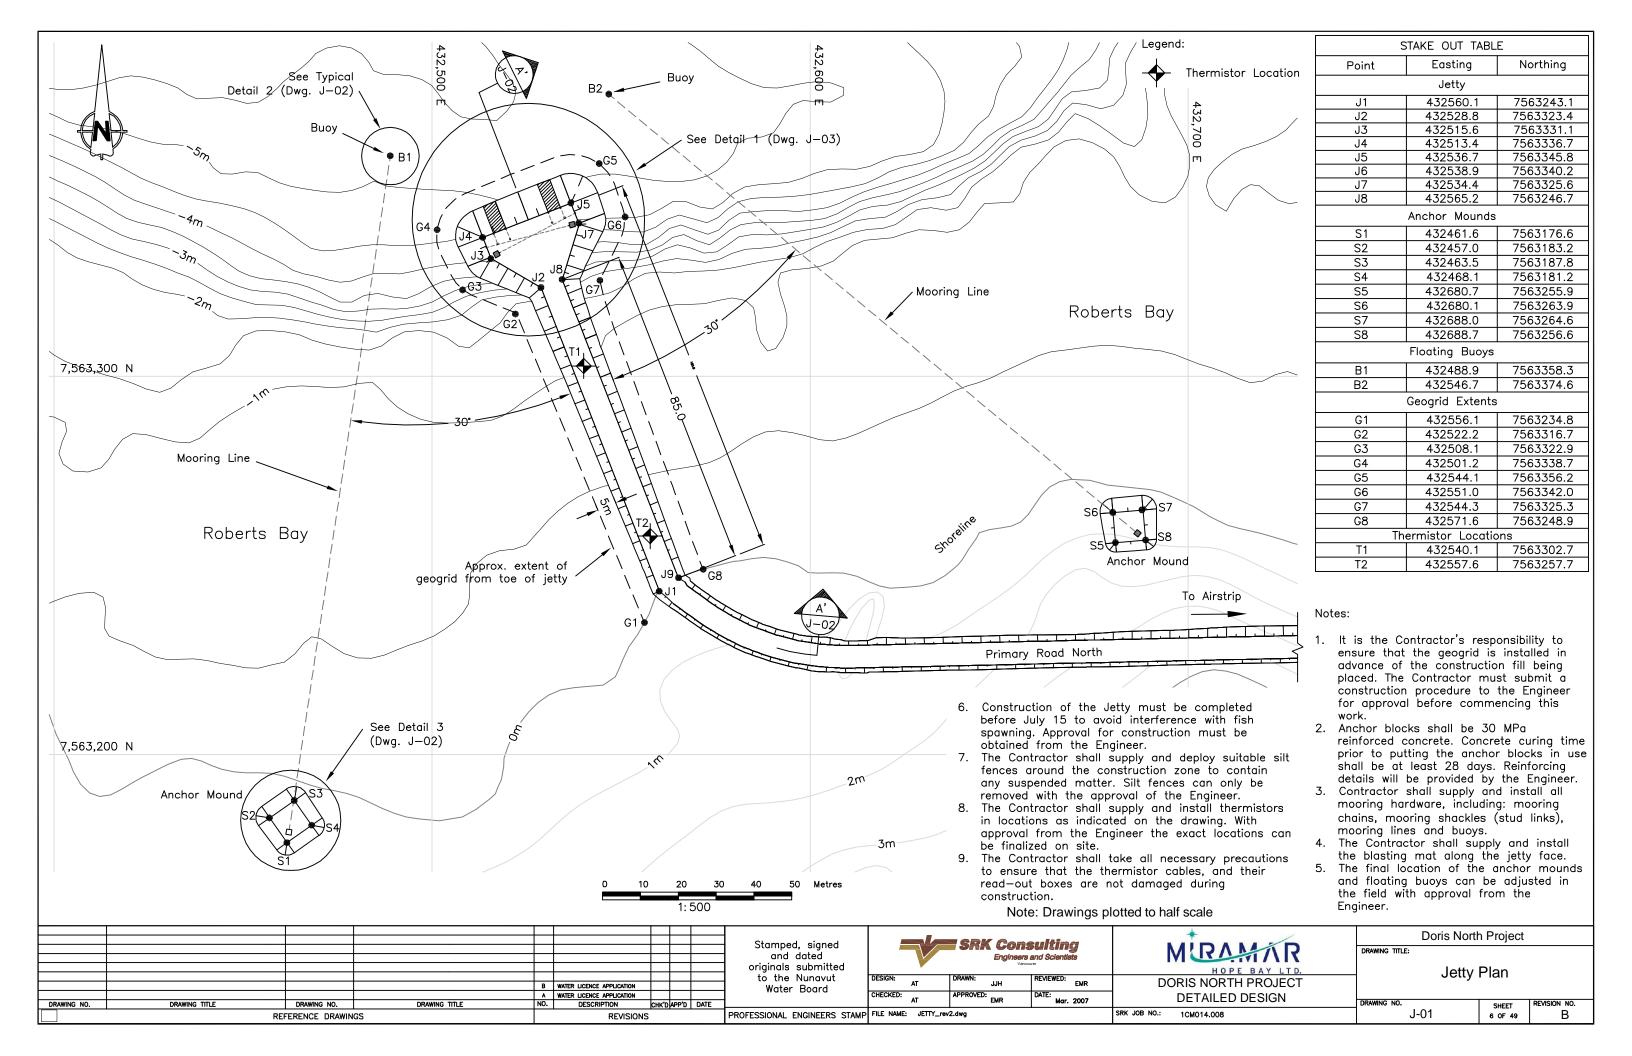


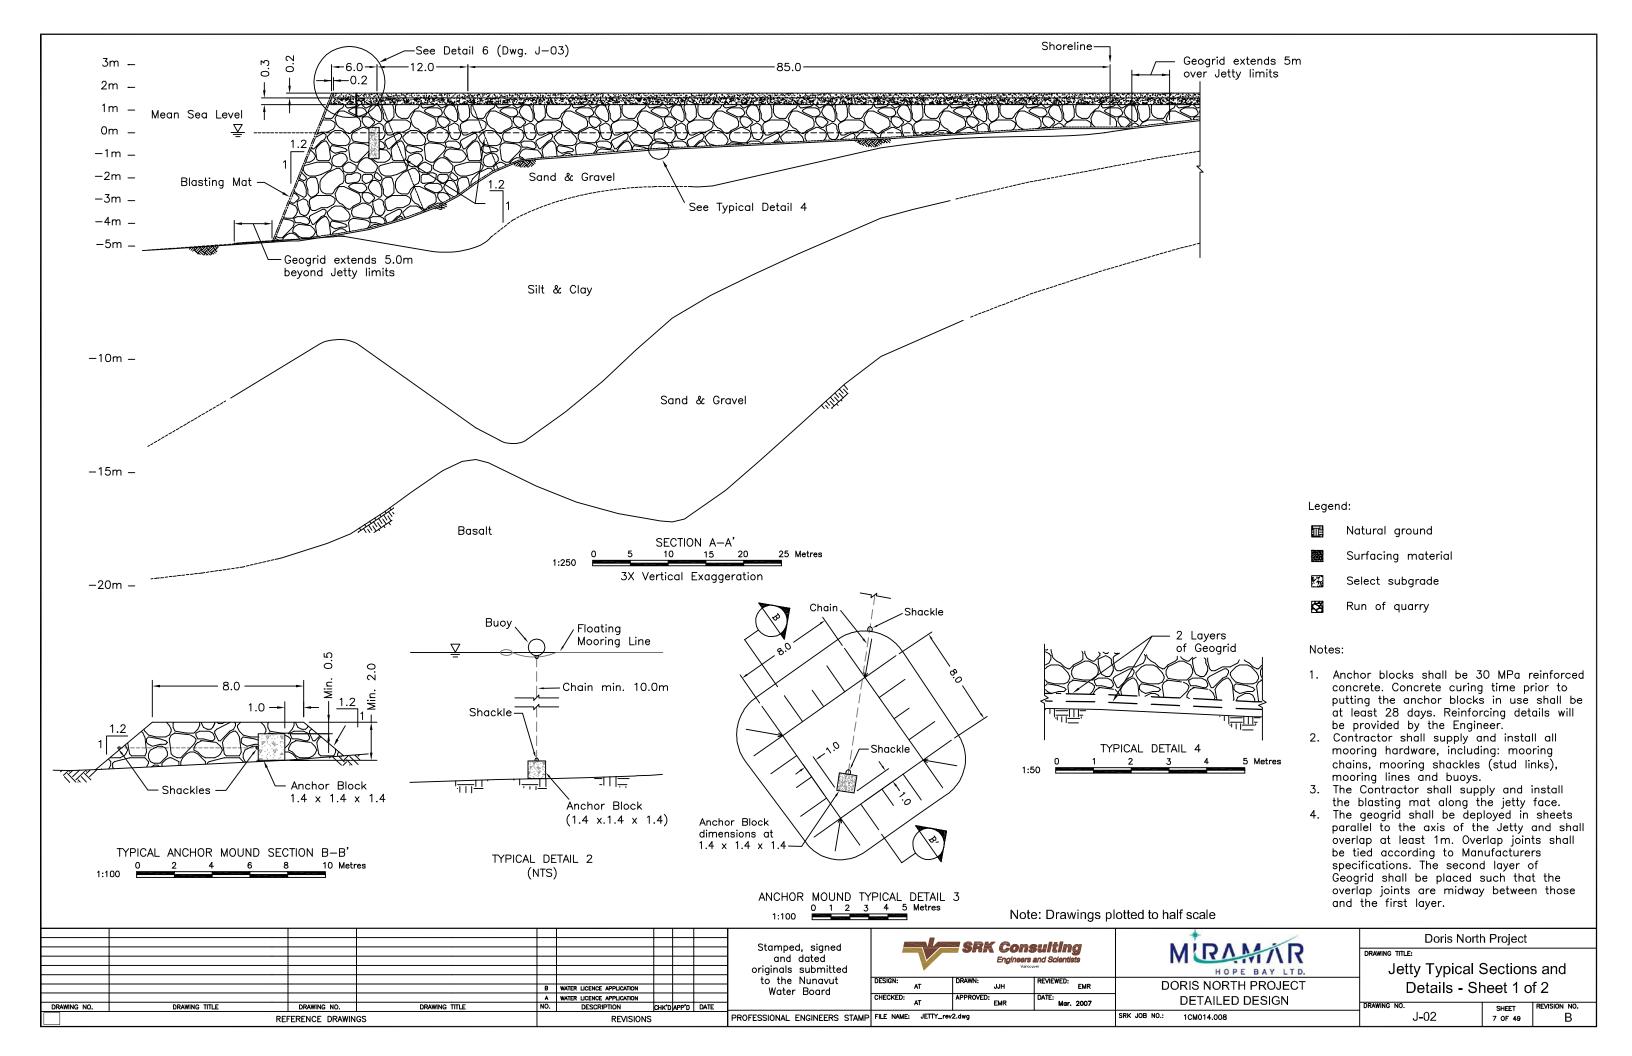


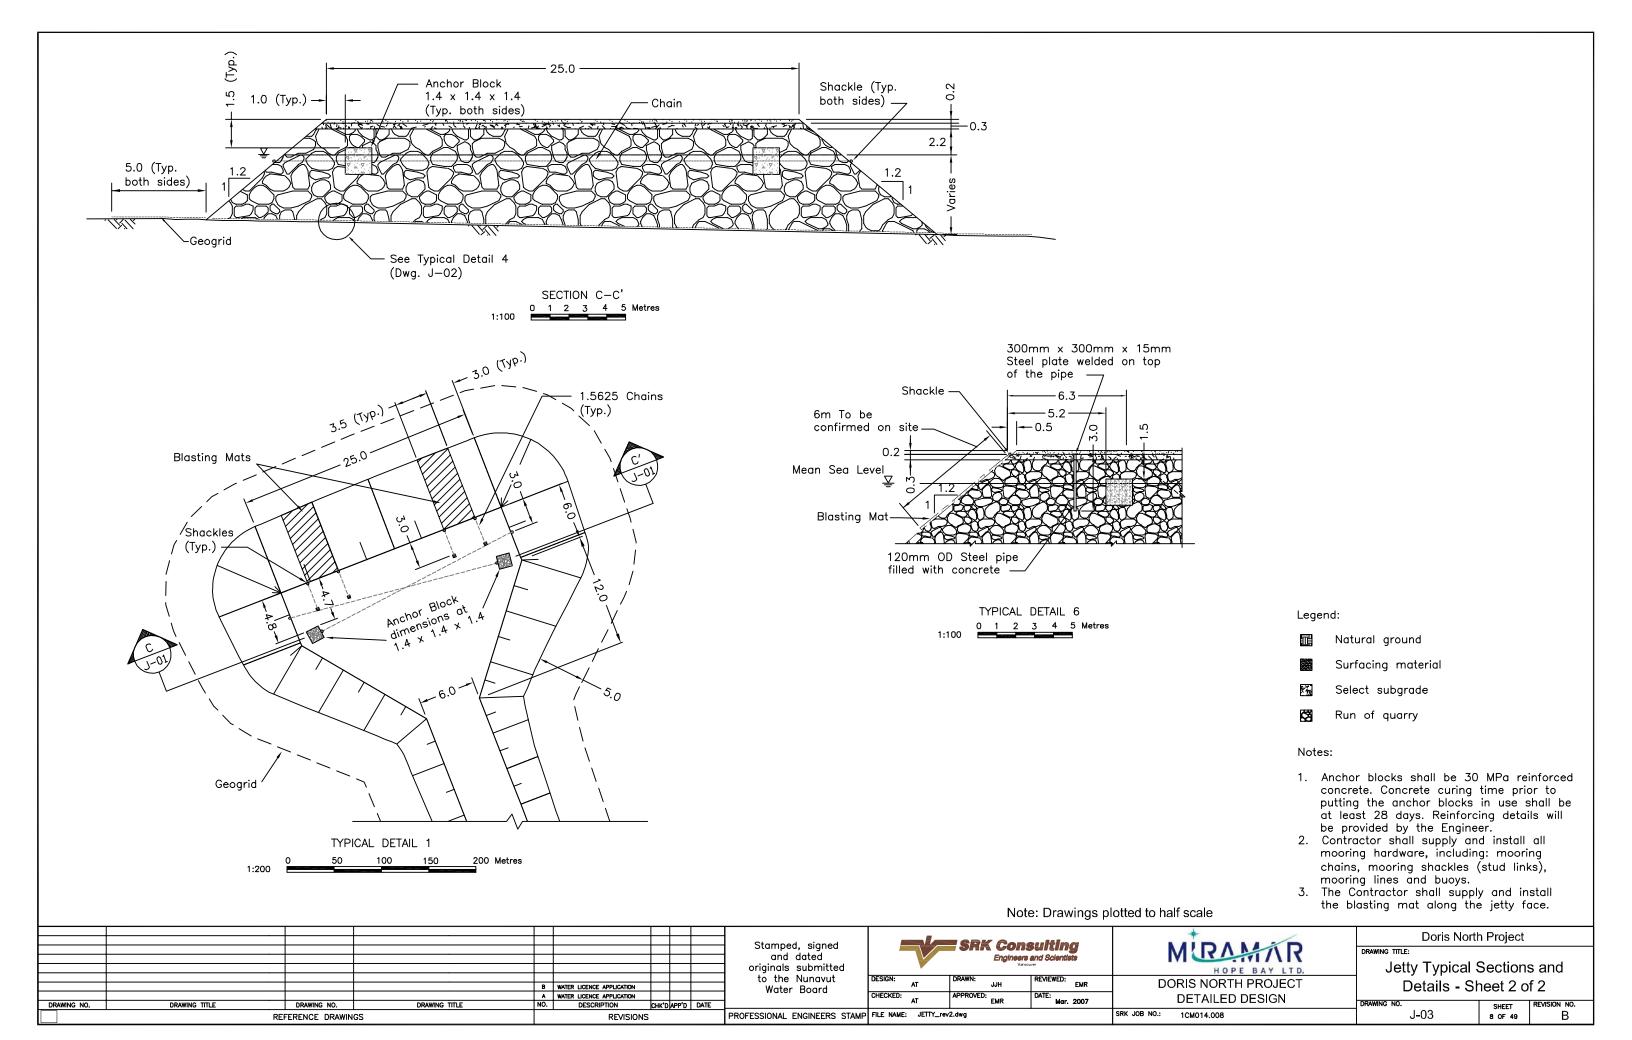


10b Issued for Construction

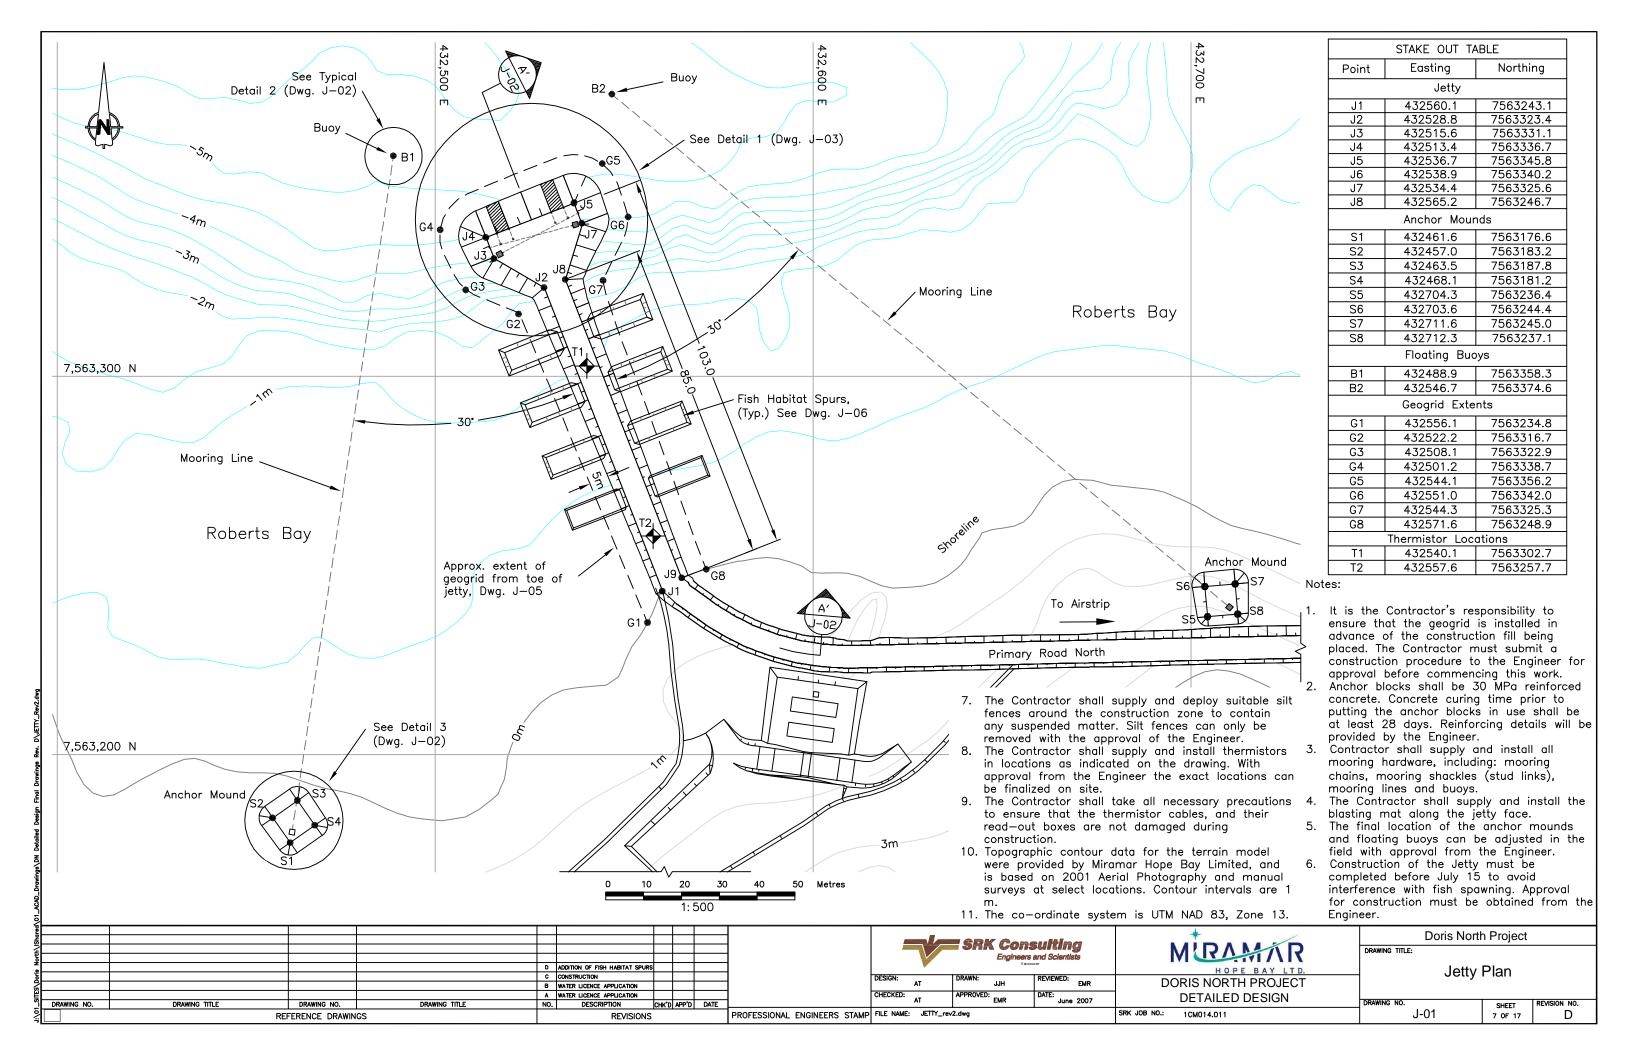

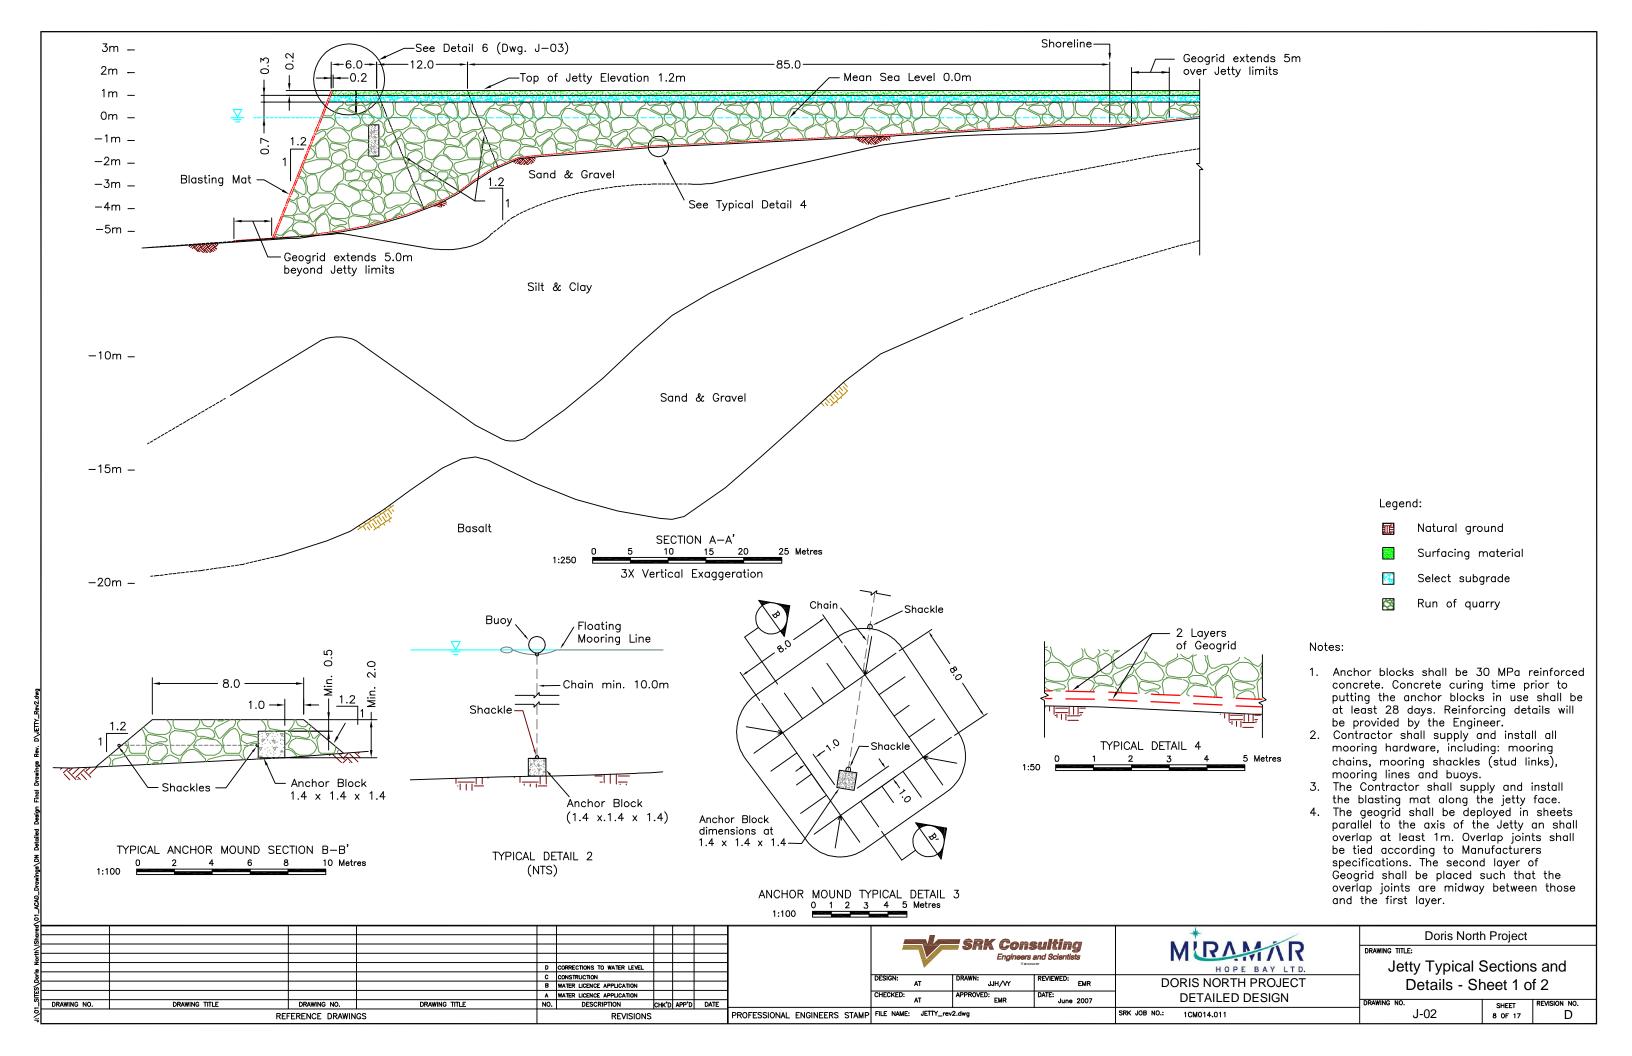

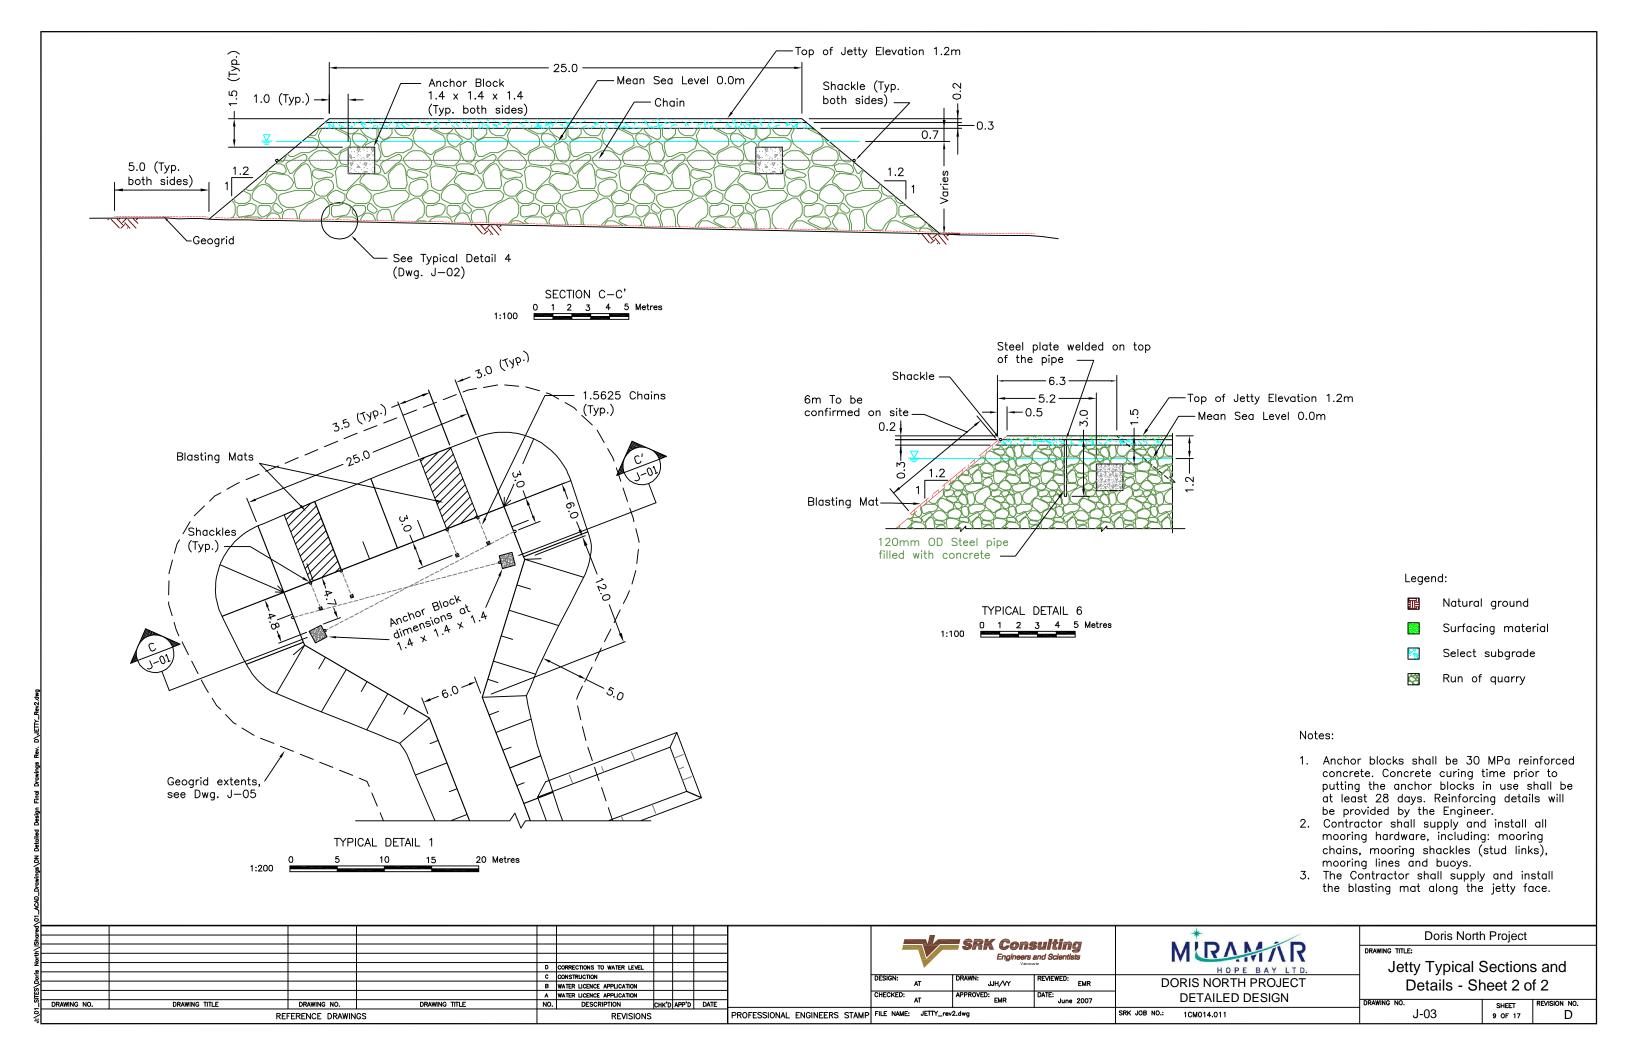

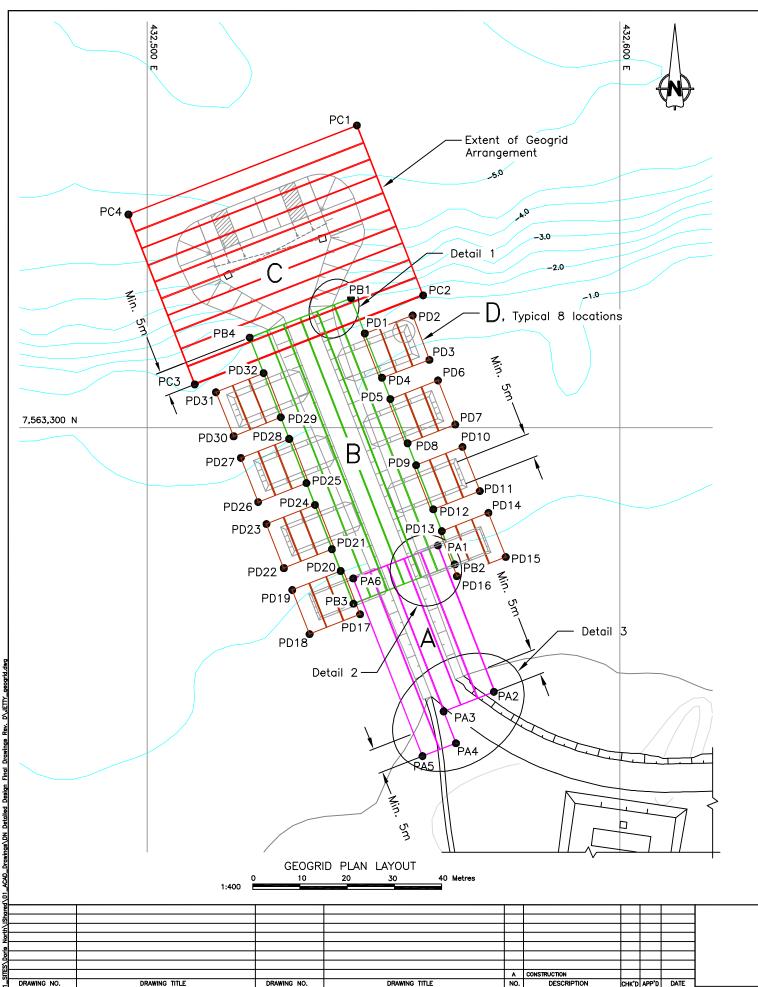



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PA3	432562.71	7563239.91
PA4	432565.32	7563233.20
PA5	432558.23	7563230.45
PA6		7563268.06
FAU	432543.60 Panel B Lo	17363266.06 gyout
PB1	432543.11	
PB2		7563327.40 7563271.06
	432565.06	
PB3	432543.63	7563262.71
PB4	432521.68	7563319.04
D04	Panel C Lo	
PC1	432544.35	7563363.94
PC2	432558.38	7563327.98
PC3	432510.05	7563309.14
PC4	432496.03	7563345.10
	Panel D Lo	
PD1	432546.03	7563319.91
PD2	432556.16	7563323.73
PD3	432559.70	7563314.34
PD4	432549.67	7563310.56
PD5	432551.44	7563306.02
PD6	432561.51	7563309.98
PD7	432565.18	7563300.64
PD8	432555.08	7563296.67
PD9	432556.88	7563292.05
PD10	432566.70	7563295.91
PD11	432570.37	7563286.57
PD12	432560.52	7563282.70
PD13	432562.33	7563278.07
PD14	432572.19	7563281.95
PD15	432575.86	7563272.61
PD16	432565.51	7563268.54
PD17	432545.04	7563260.47
PD18	432534.35	7563256.27
PD19	432530.67	7563265.61
PD20	432540.93	7563269.64
PD21	432539.08	7563274.25
PD22	432528.90	7563270.25
PD23	432525.23	7563279.60
PD24	432535.48	7563283.62
PD25	432533.68	7563288.24
PD26	432523.47	7563284.23
PD27	432519.80	7563293.57
PD28	432530.04	7563297.60
PD29	432528.25	7563302.17
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PROFESSIONAL ENGINEERS STAMP FILE NAME: Jetty_geogrid.dwg


REVISIONS



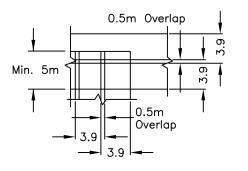

DETAIL 1 — TYPICAL PANEL TIE—IN DEEP WATER DETAIL 2 — TYPICAL PANEL TIE—IN SHALLOW WATER

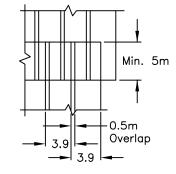

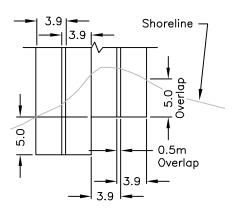

DETAIL 3 — TYPICAL PANEL TIE—IN SHORE

Notes:

- 1. Geogrid panel placement will be Contractor's responsibility and must meet the Standards shown on this drawing. This drawing shows the panel layout proposed by SLEC. Changes and layout deviation from this drawing must be approved by the Engineer prior to construction.
- 2. This layout assumes geogrid roll dimensions of 3.9m by 77.0m
- The setting out coordinates for the panel placements will be Contractor's responsibility and they must be approved by the Engineer prior to deployment.
- 4. The minimum longtitudinal overlap must be 0.5m and minimum transverse overlap must be 5m. More overlap may be required over the transverse joints toward deeper water to reinforce for strength as directed by the Engineer.
- 5. All joints will be permanently secured using heavy duty zip ties at a minimum spacing 1.0m. Heavy duty zip ties will have a minimum tensile strength of 175lbs, 641mm long, 8.6mm wide and 2.3mm thick.
- Two layers of geogrids will be placed at all locations. The second layer of geogrid will be permanently secured to the first using heavy duty zip ties at a minimum 3.0m spacing in all directions.
- 7. The Contractor will provide methods for the Engineer to inspect and perform QA/QC on the work done in all parts of the Jetty.
- 8. The Contractor is responsible for silt and sediment control during the construction. The construction methods by the Contractor must comply with MHBL environmental policies and permits.



DORIS NORTH PROJECT DETAILED DESIGN

1CM014.011

SRK JOB NO.:

Doris North Project


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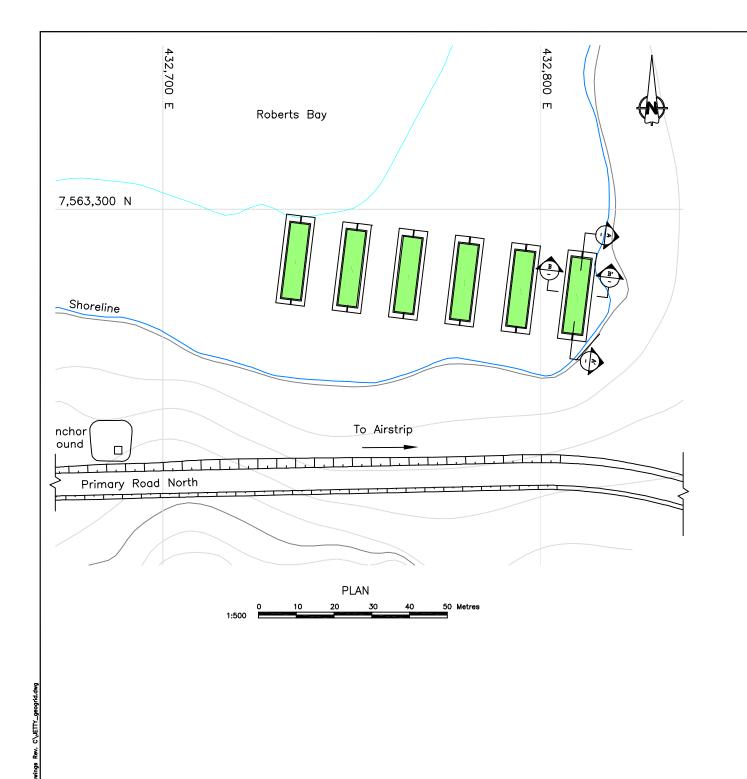
Geogrid Panel Layout


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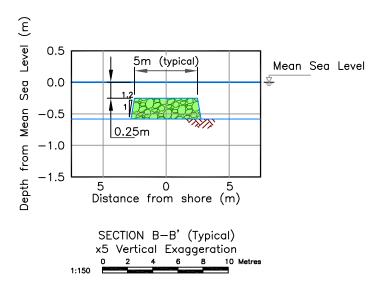
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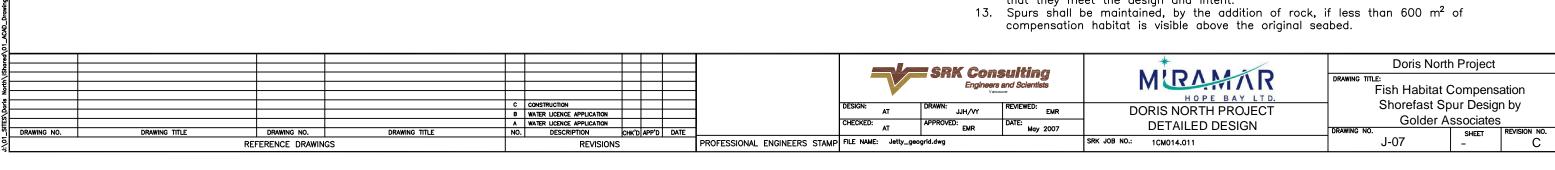






Notes:

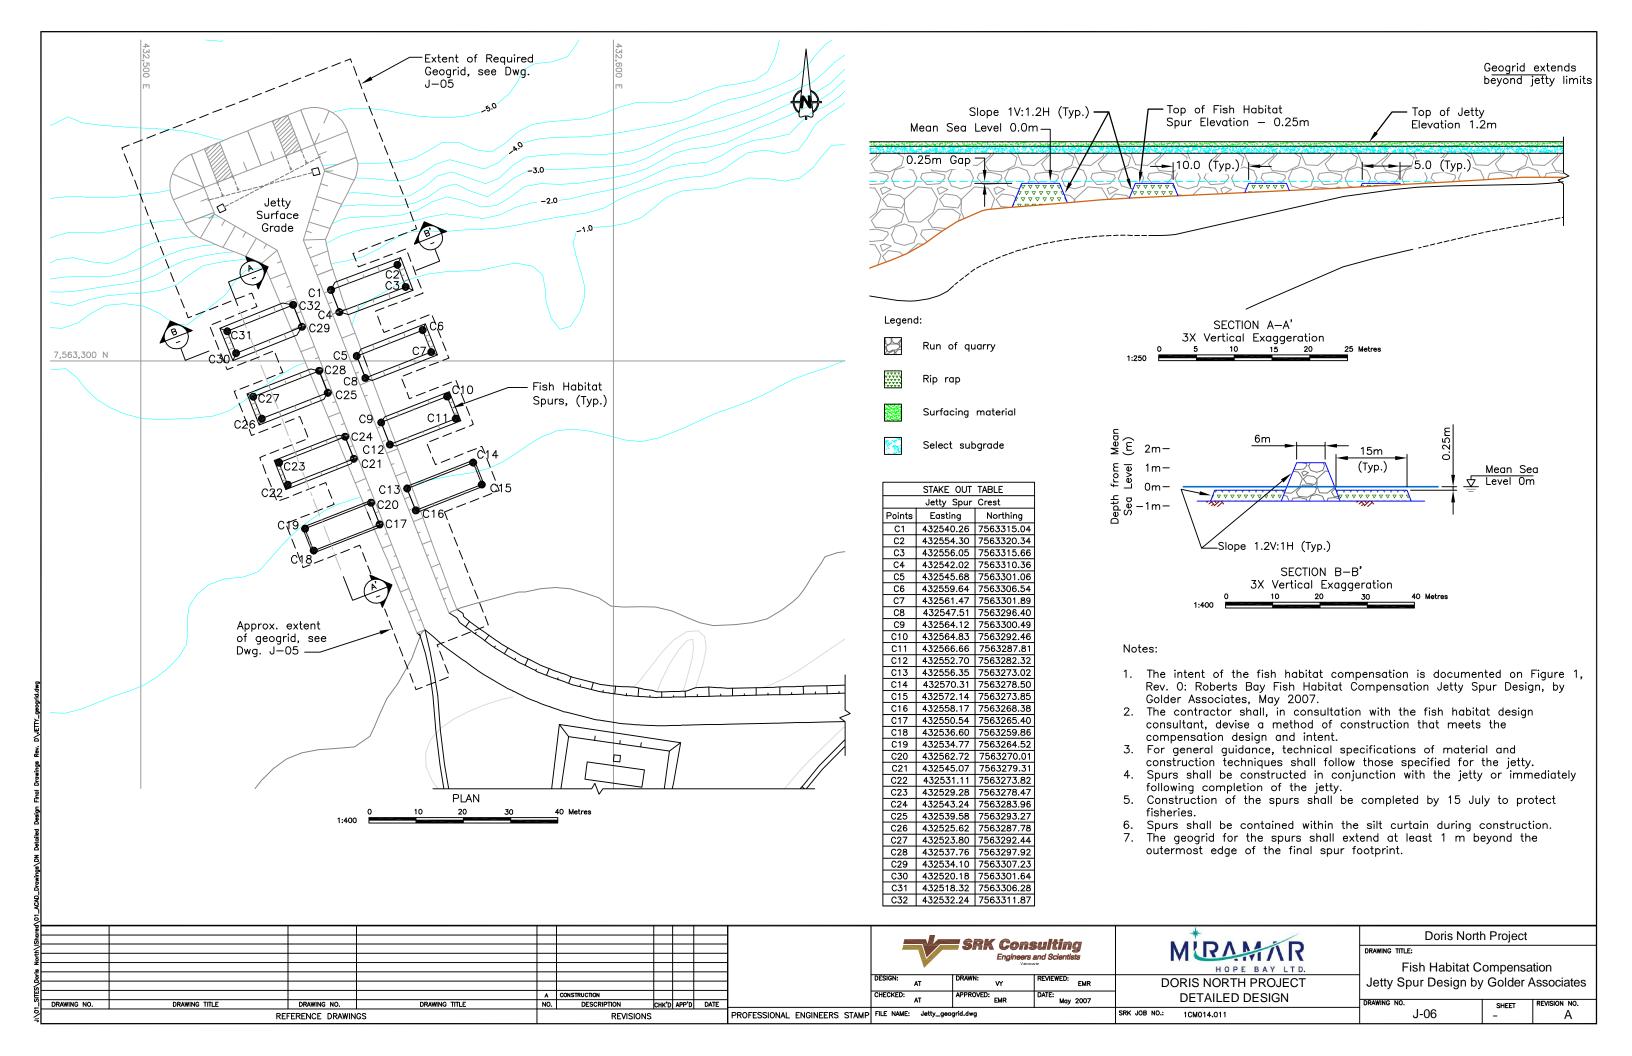- The intent of the fish habitat compensation is to provide 600 m² of fish habitat.
- The contractor shall, in consultation with the fish habitat design consultant, devise a method of construction that meets the compensation design and intent.
- Spurs shall be laid out in field by a qualified person.
- A total of six spurs shall be constructed perpendicular to shore.
- Spurs shall be typically 5 m wide, 20 m long (measured from their root) and spaced approximately 10 m apart.
- Spurs shall be constructed of clean, competent, certified non-acid generating rock.
- Gradation of the rock shall meet the specifications for riprap material as shown on drawing G-05 Revision No. B (SRK, 2007).
 Estimated total quantity of rock is 110 m³.
- Settlement of the rock is expected to be minimal.
- Construction of the spurs shall cease prior to 15 July to protect fisheries.
- 11. Spurs may need to be contained within a silt curtain during construction.
- Spurs shall be inspected annually during jetty operation by a qualified person to ensure that they meet the design and intent.

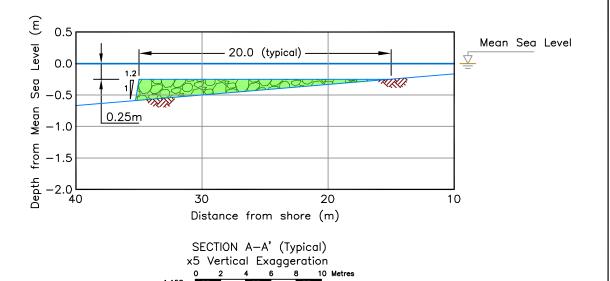

10c As-Built Drawings for Constructed Facilities

