





LEVEL GRADE CROSSINGS

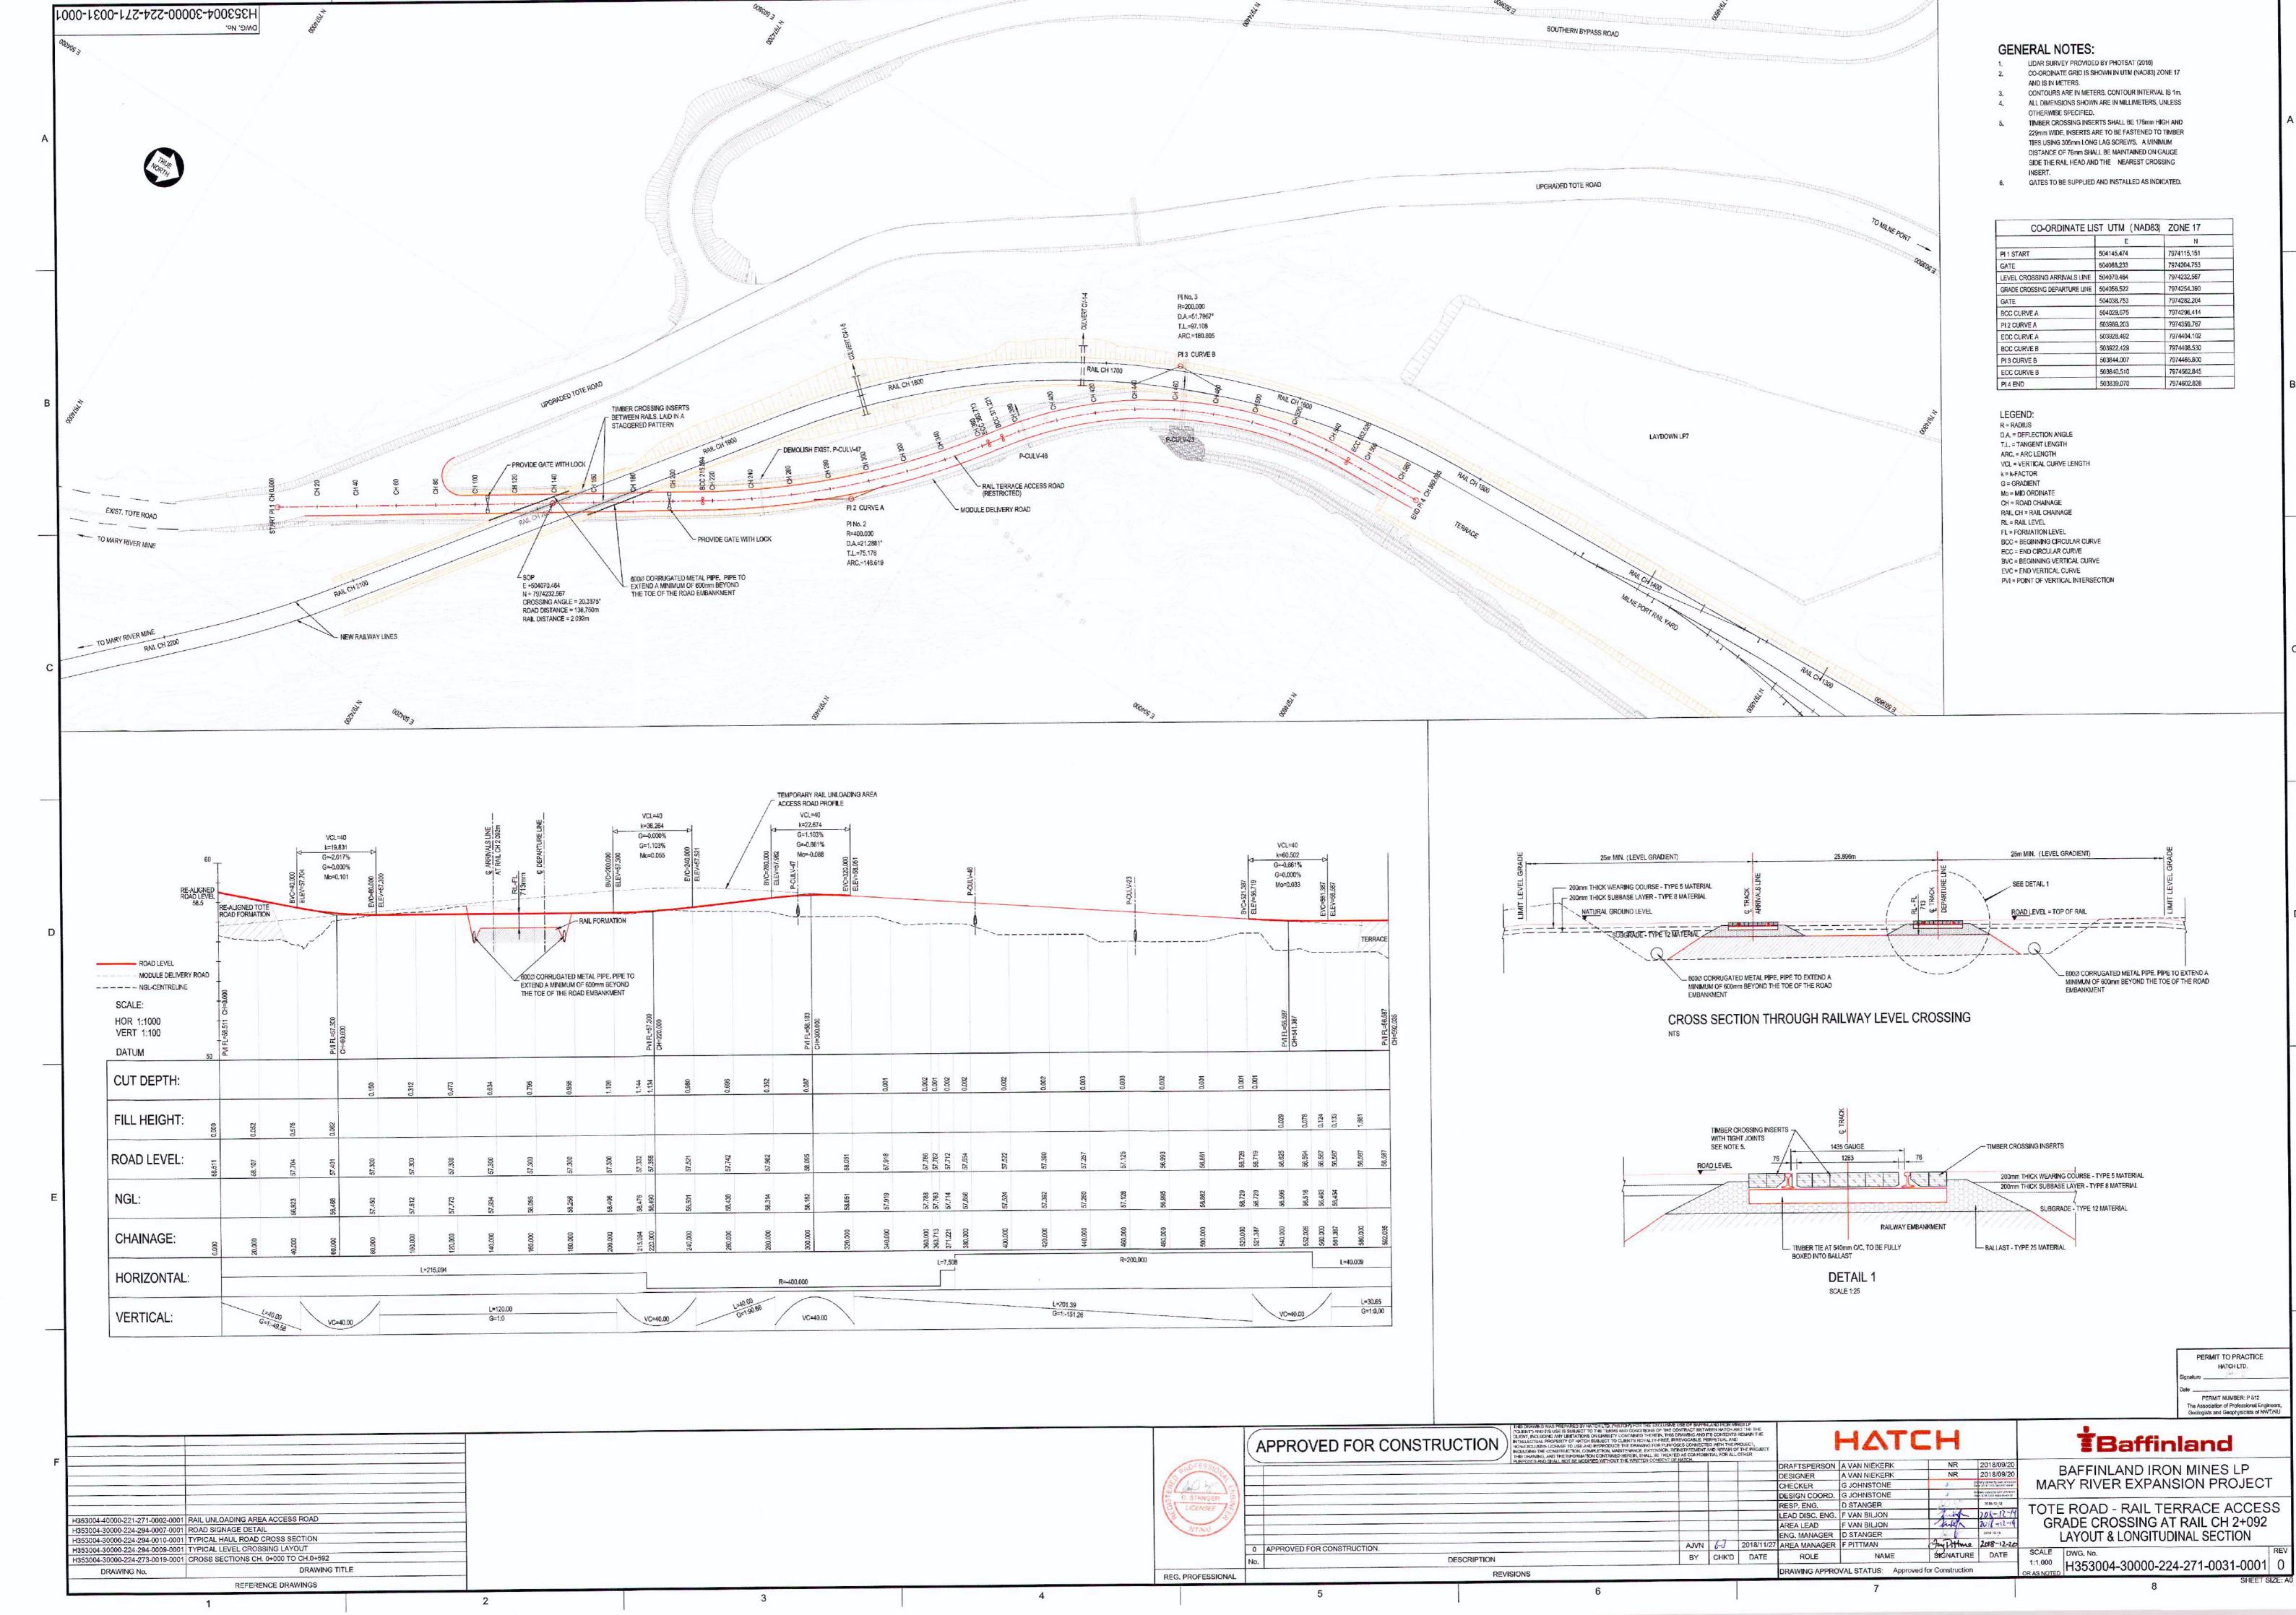

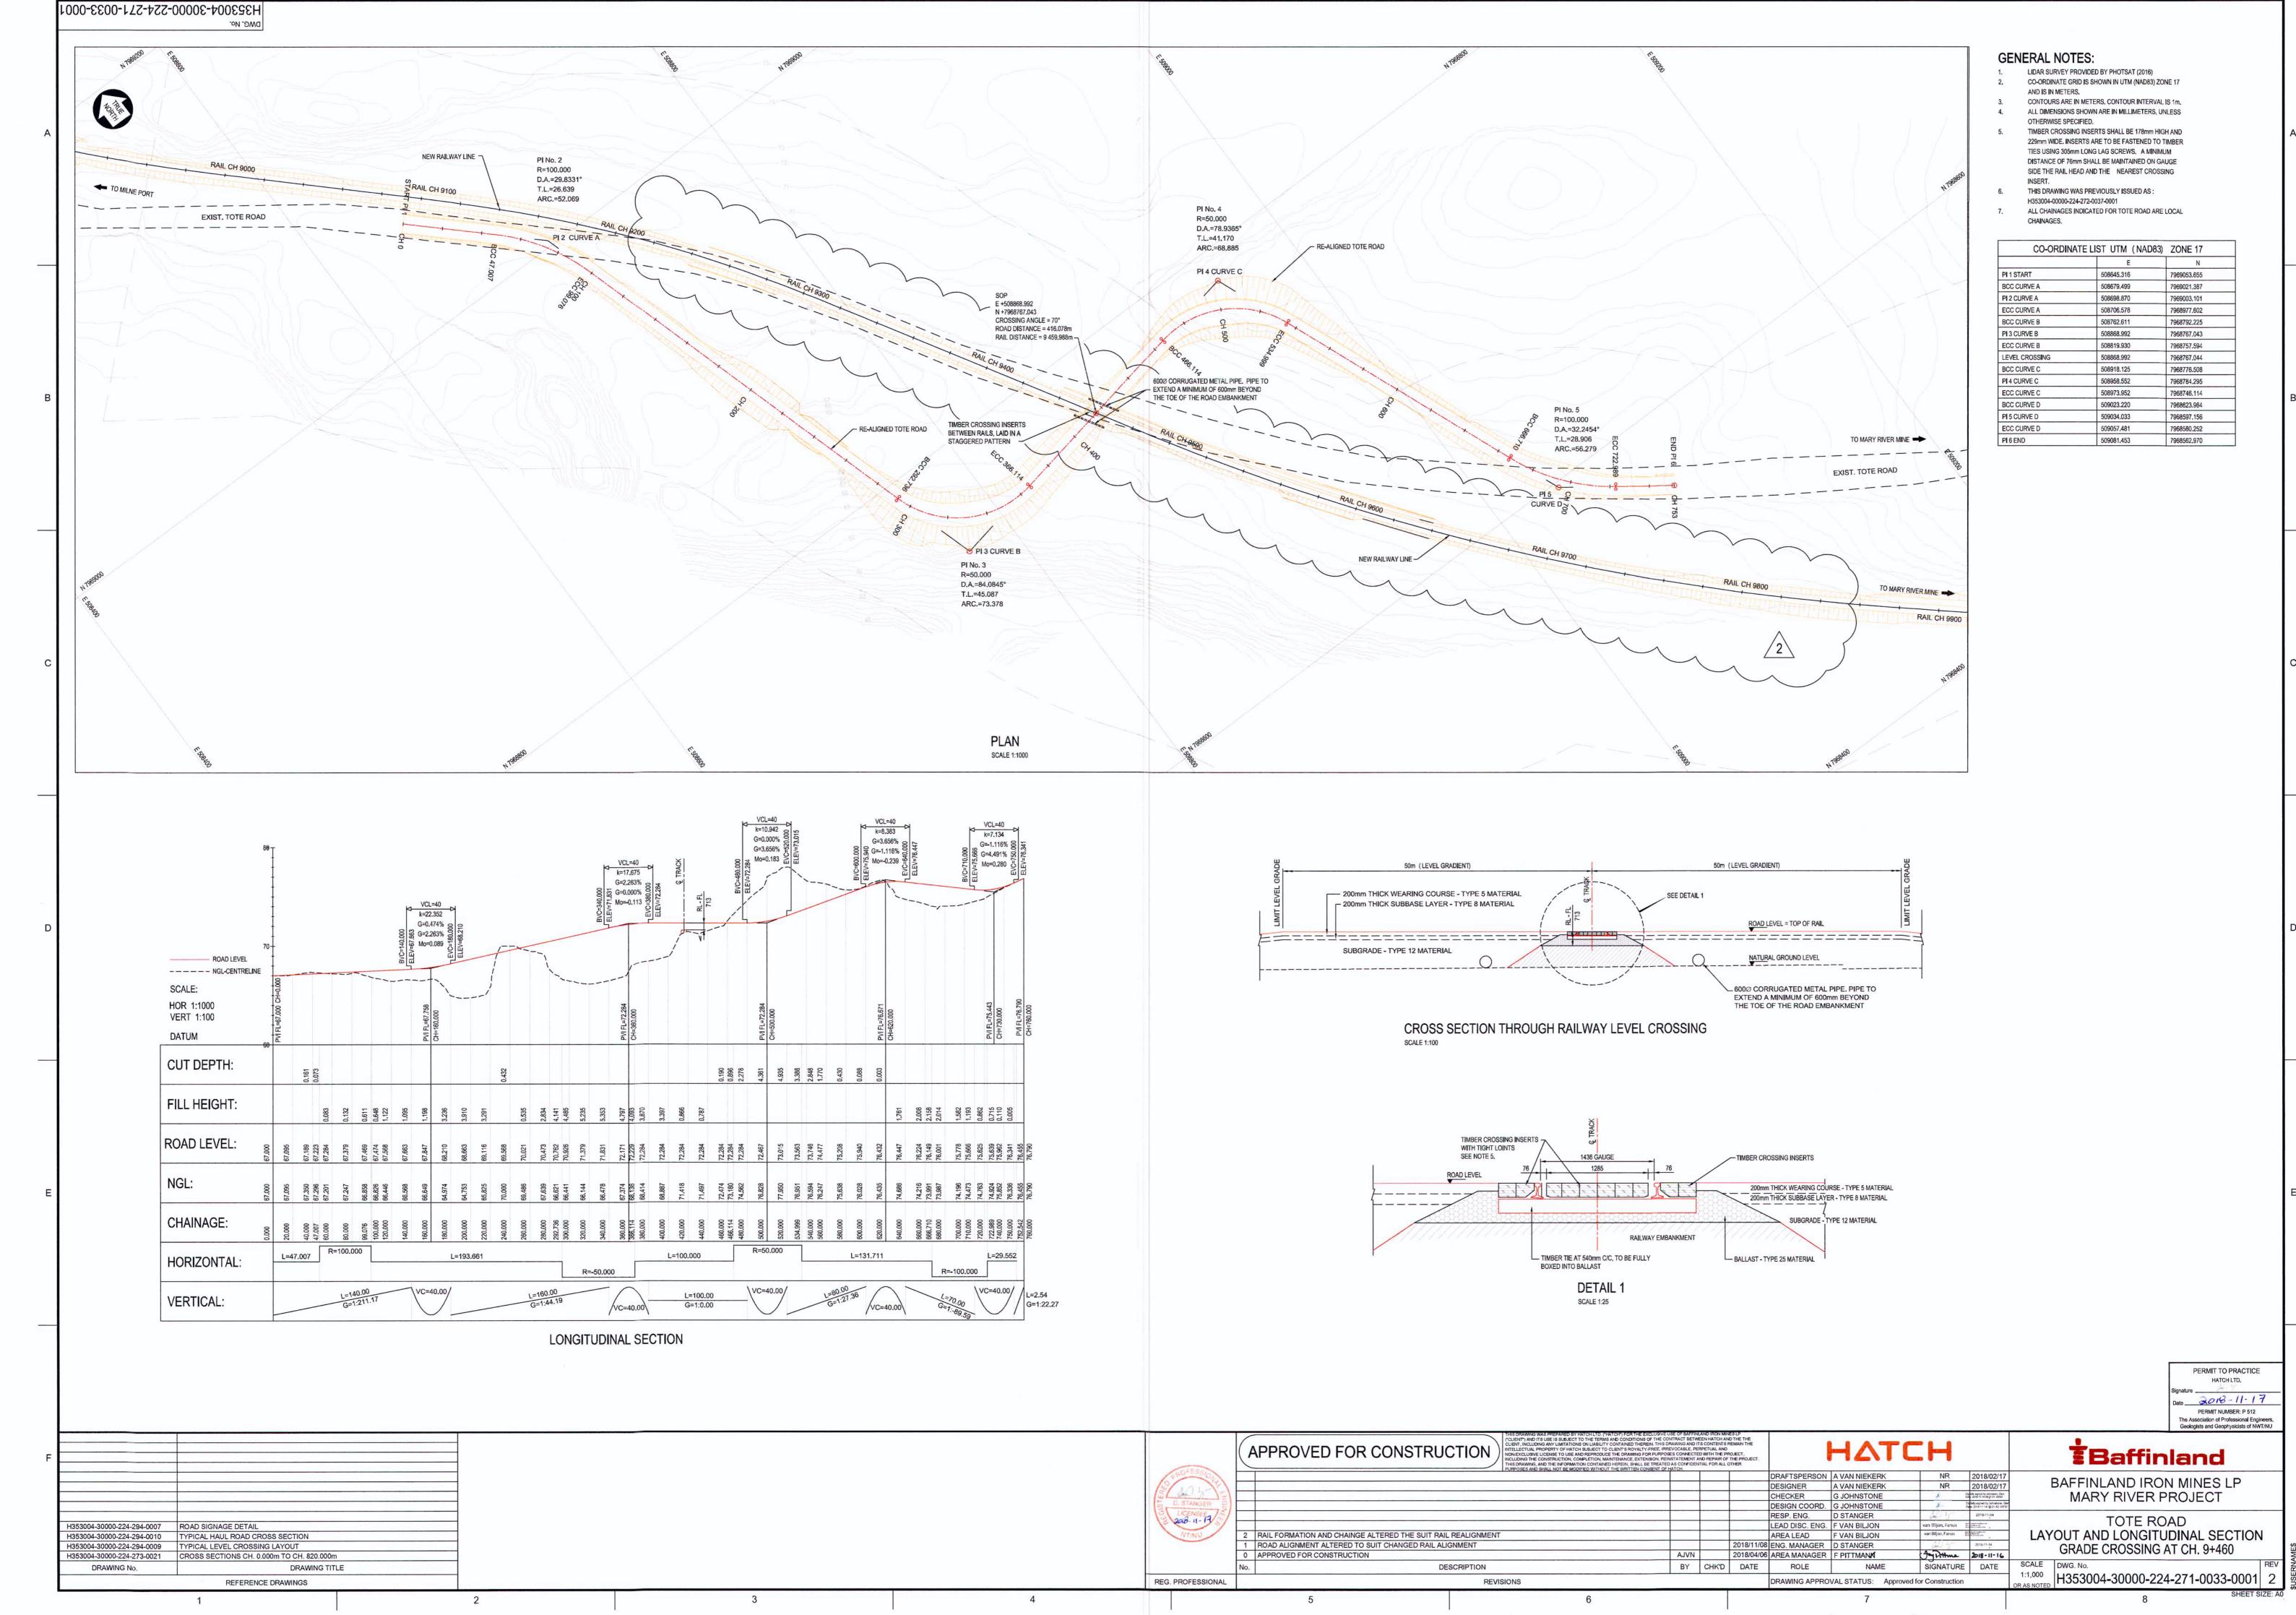

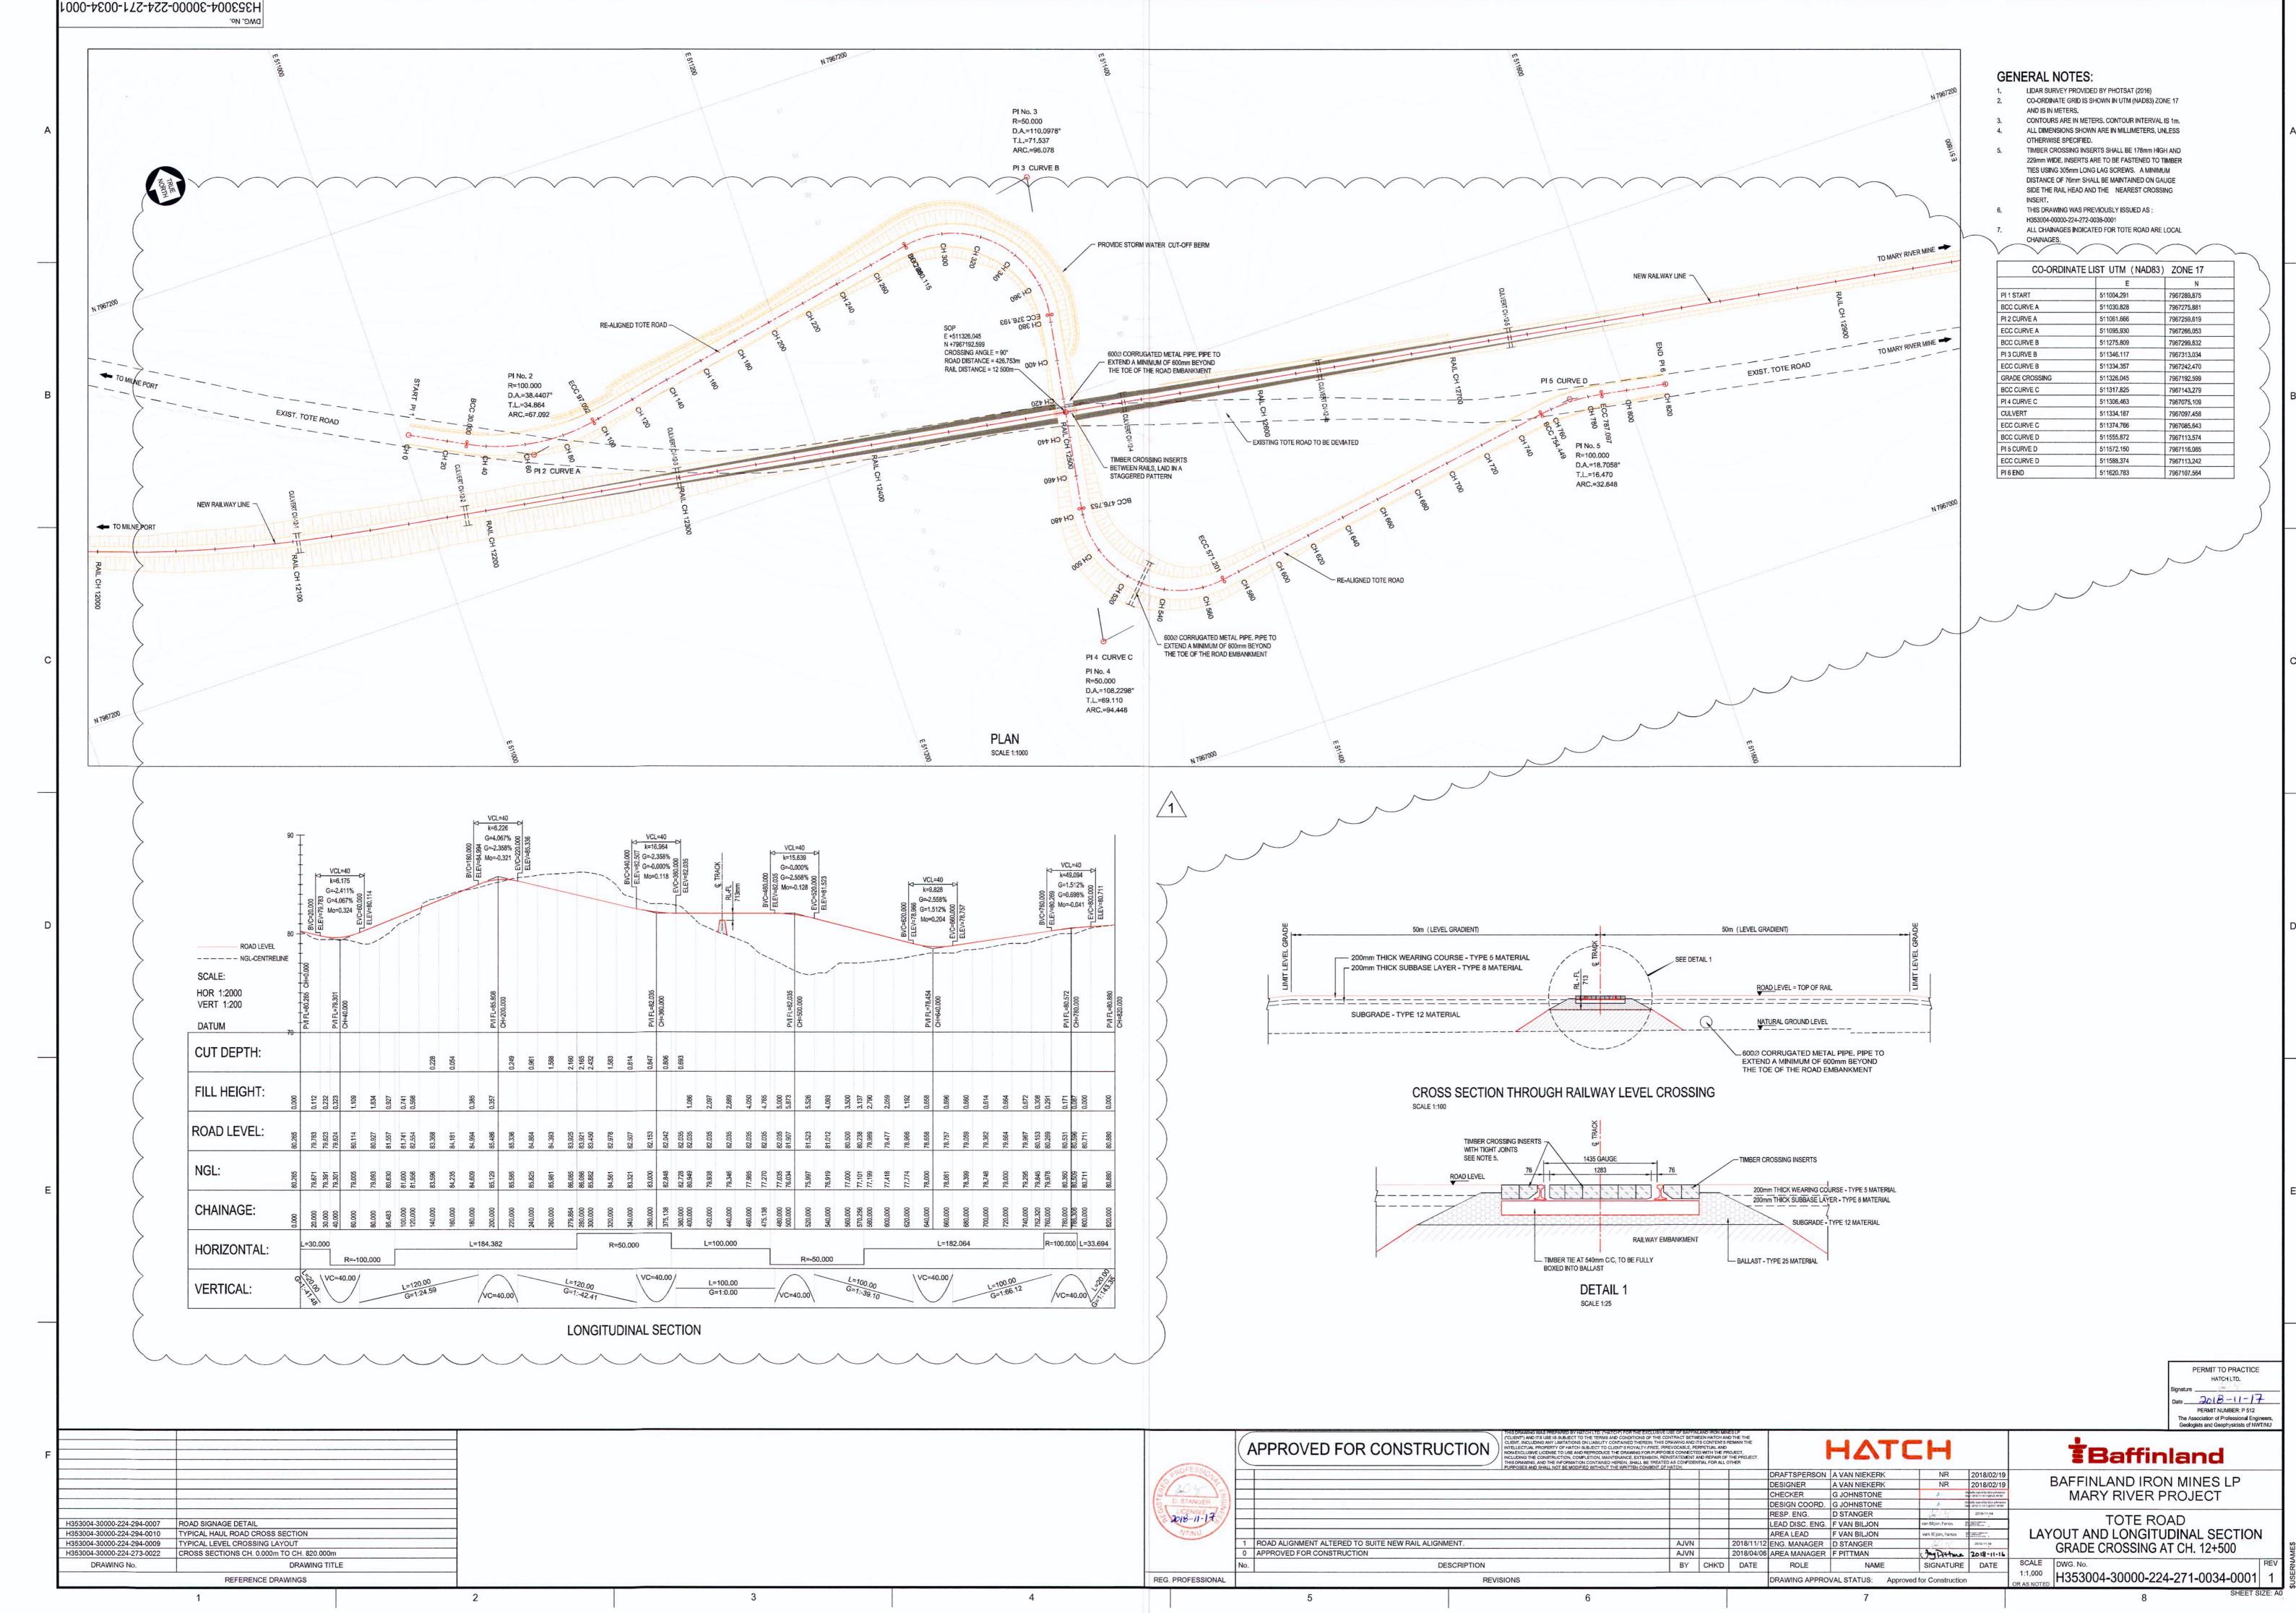



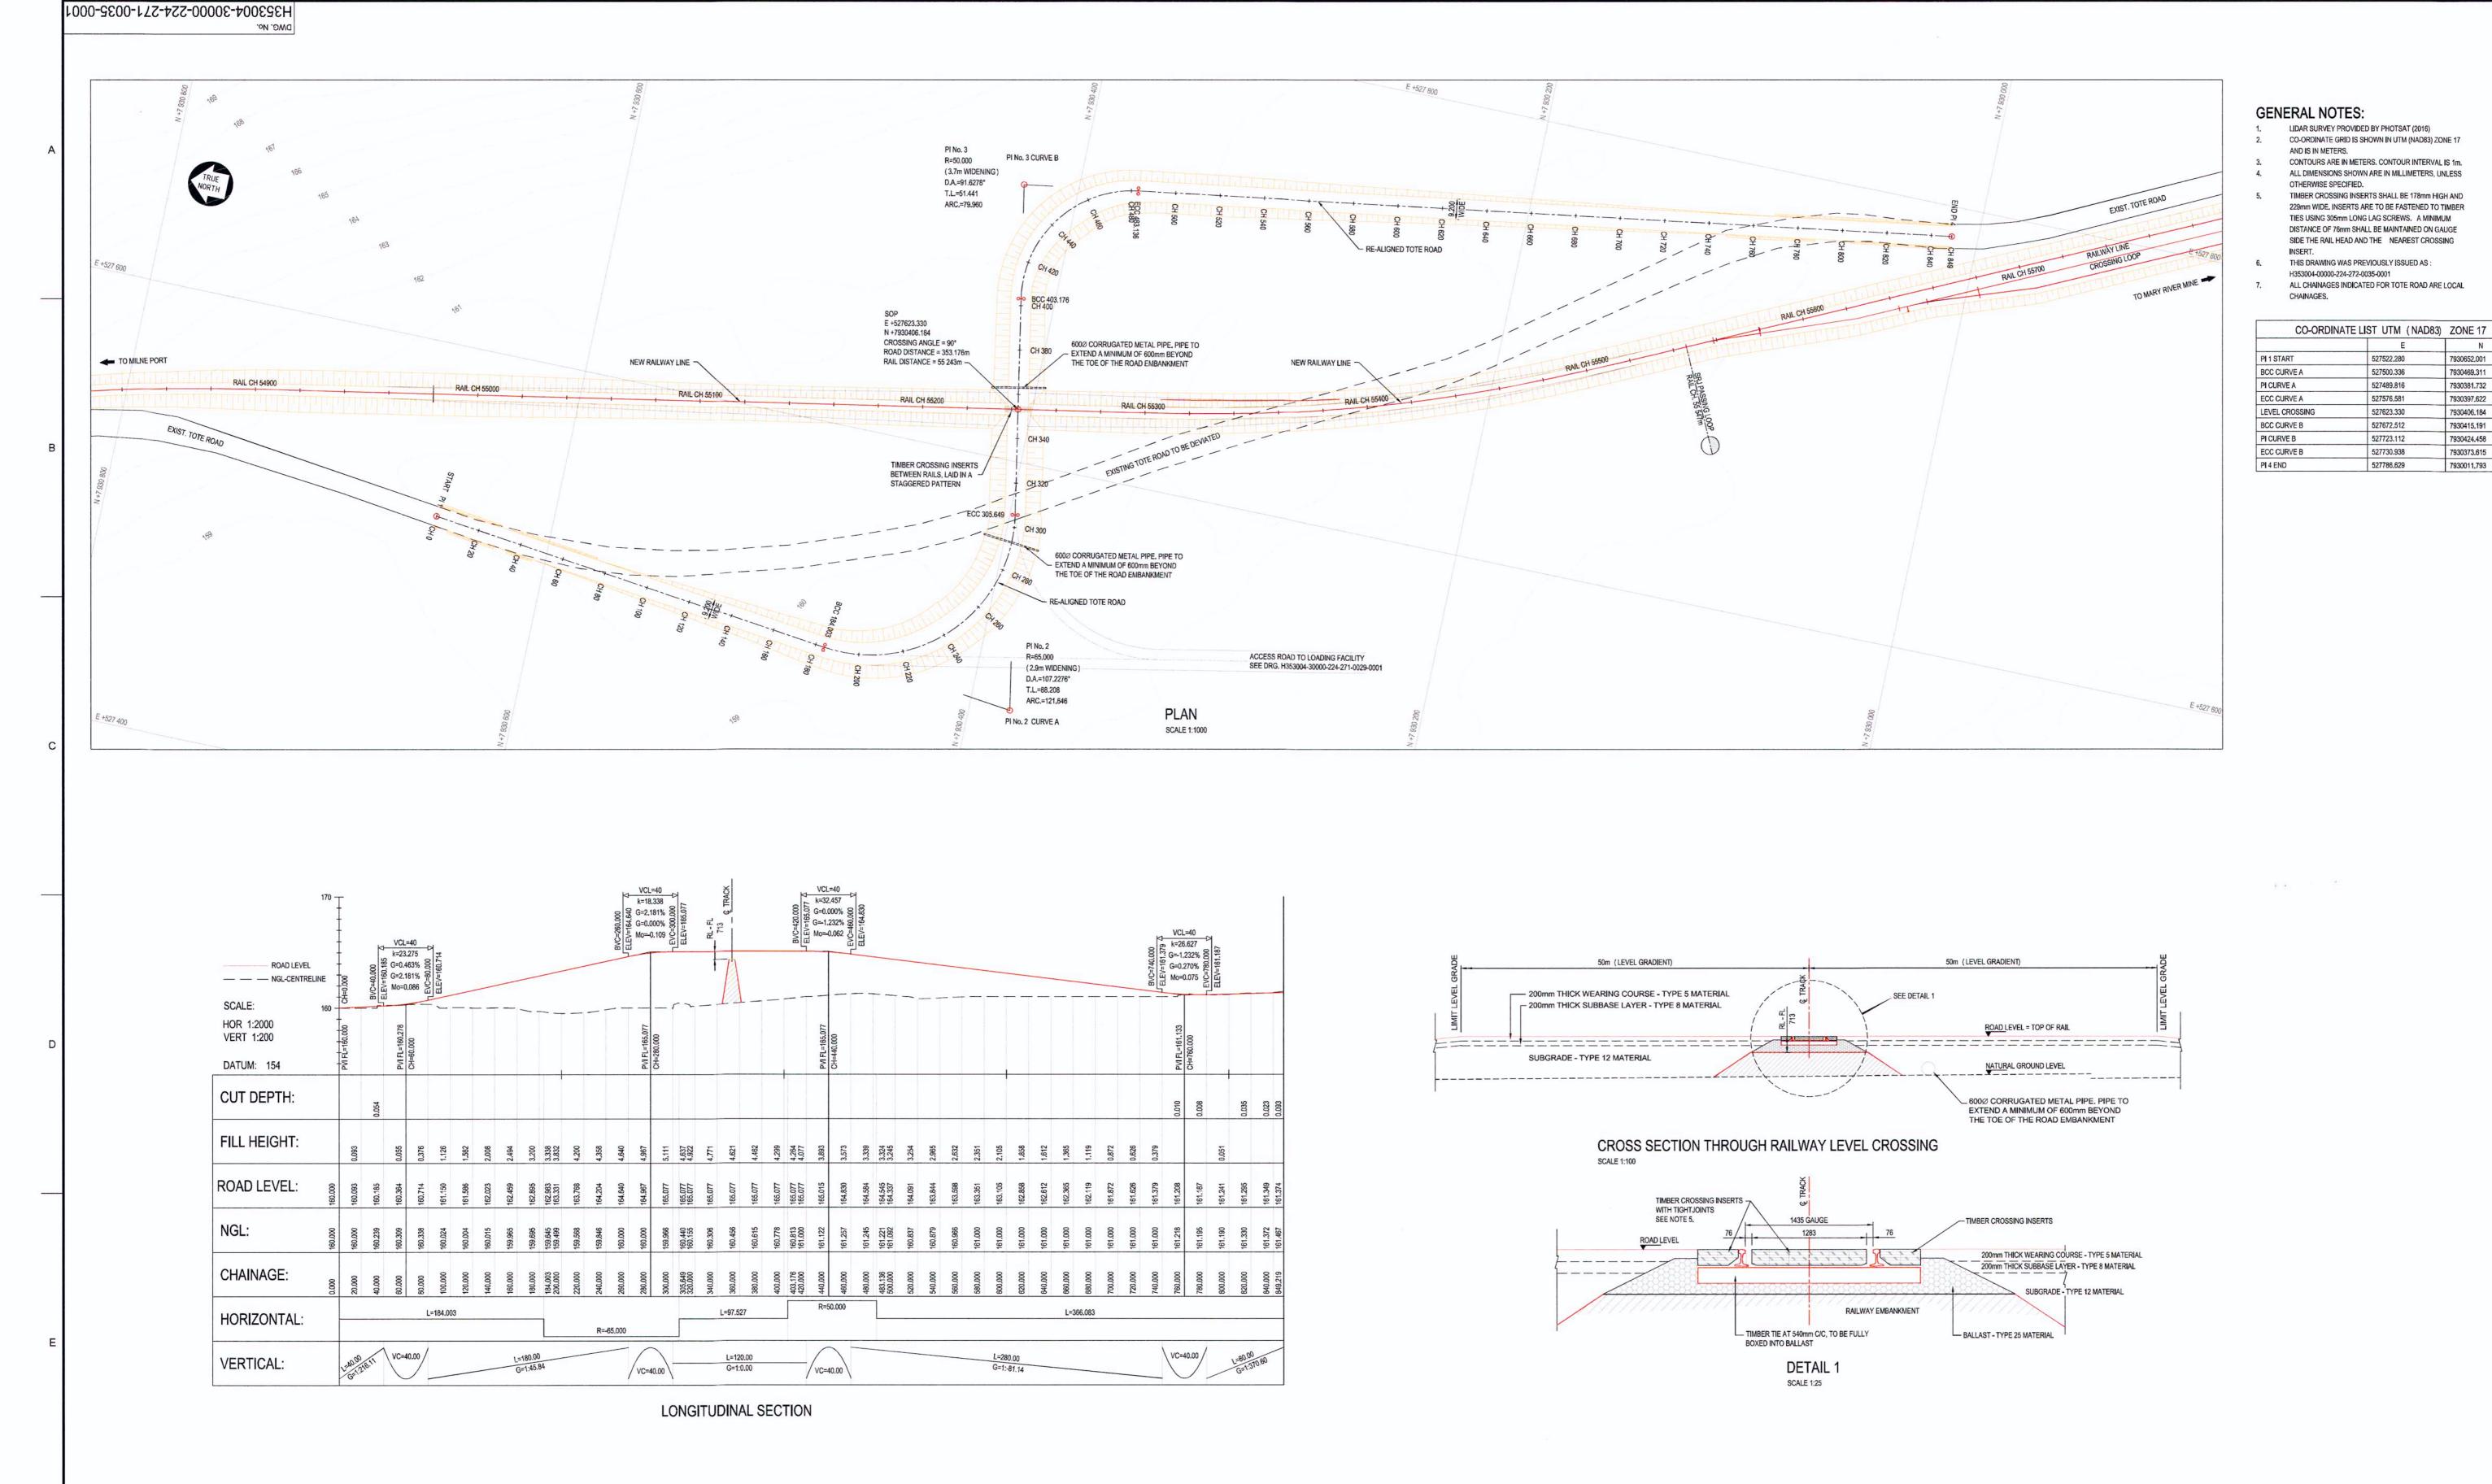

PERMIT TO PRACTICE HATCH LTD. PERMIT NUMBER: P 512 The Association of Professional Engineers, Geologists and Geophysicists of NWT/NU

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7930406.184


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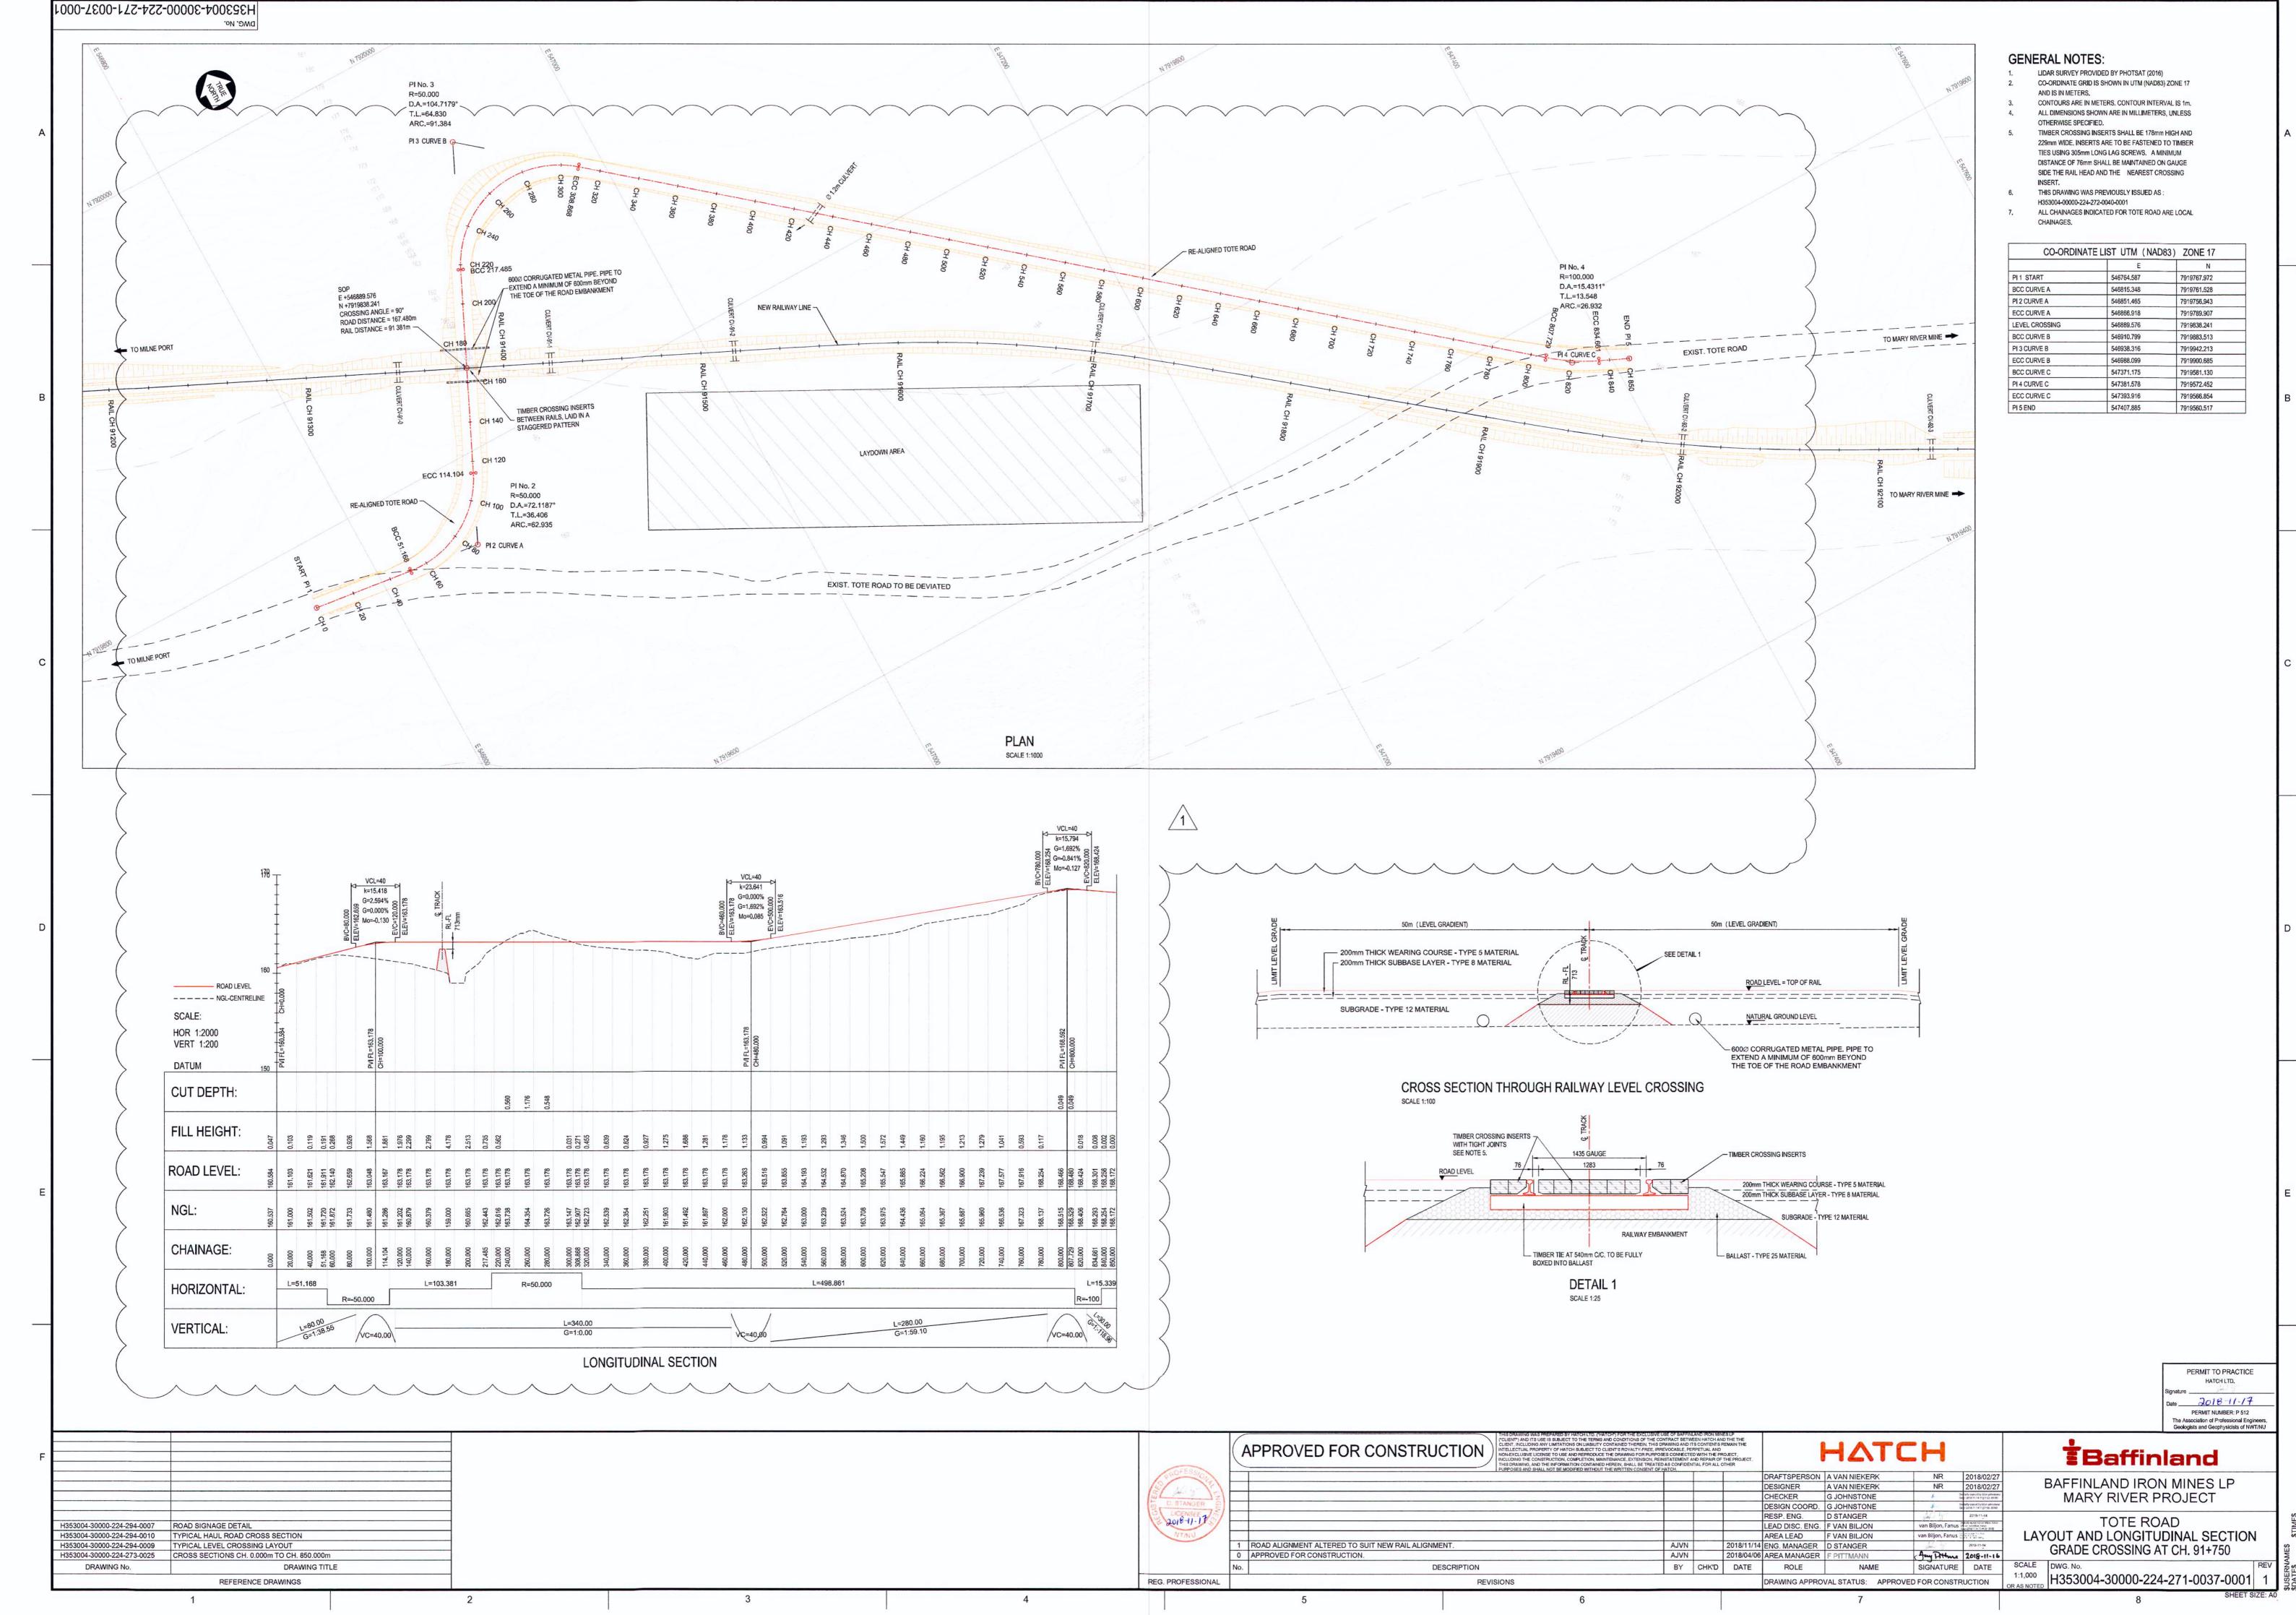
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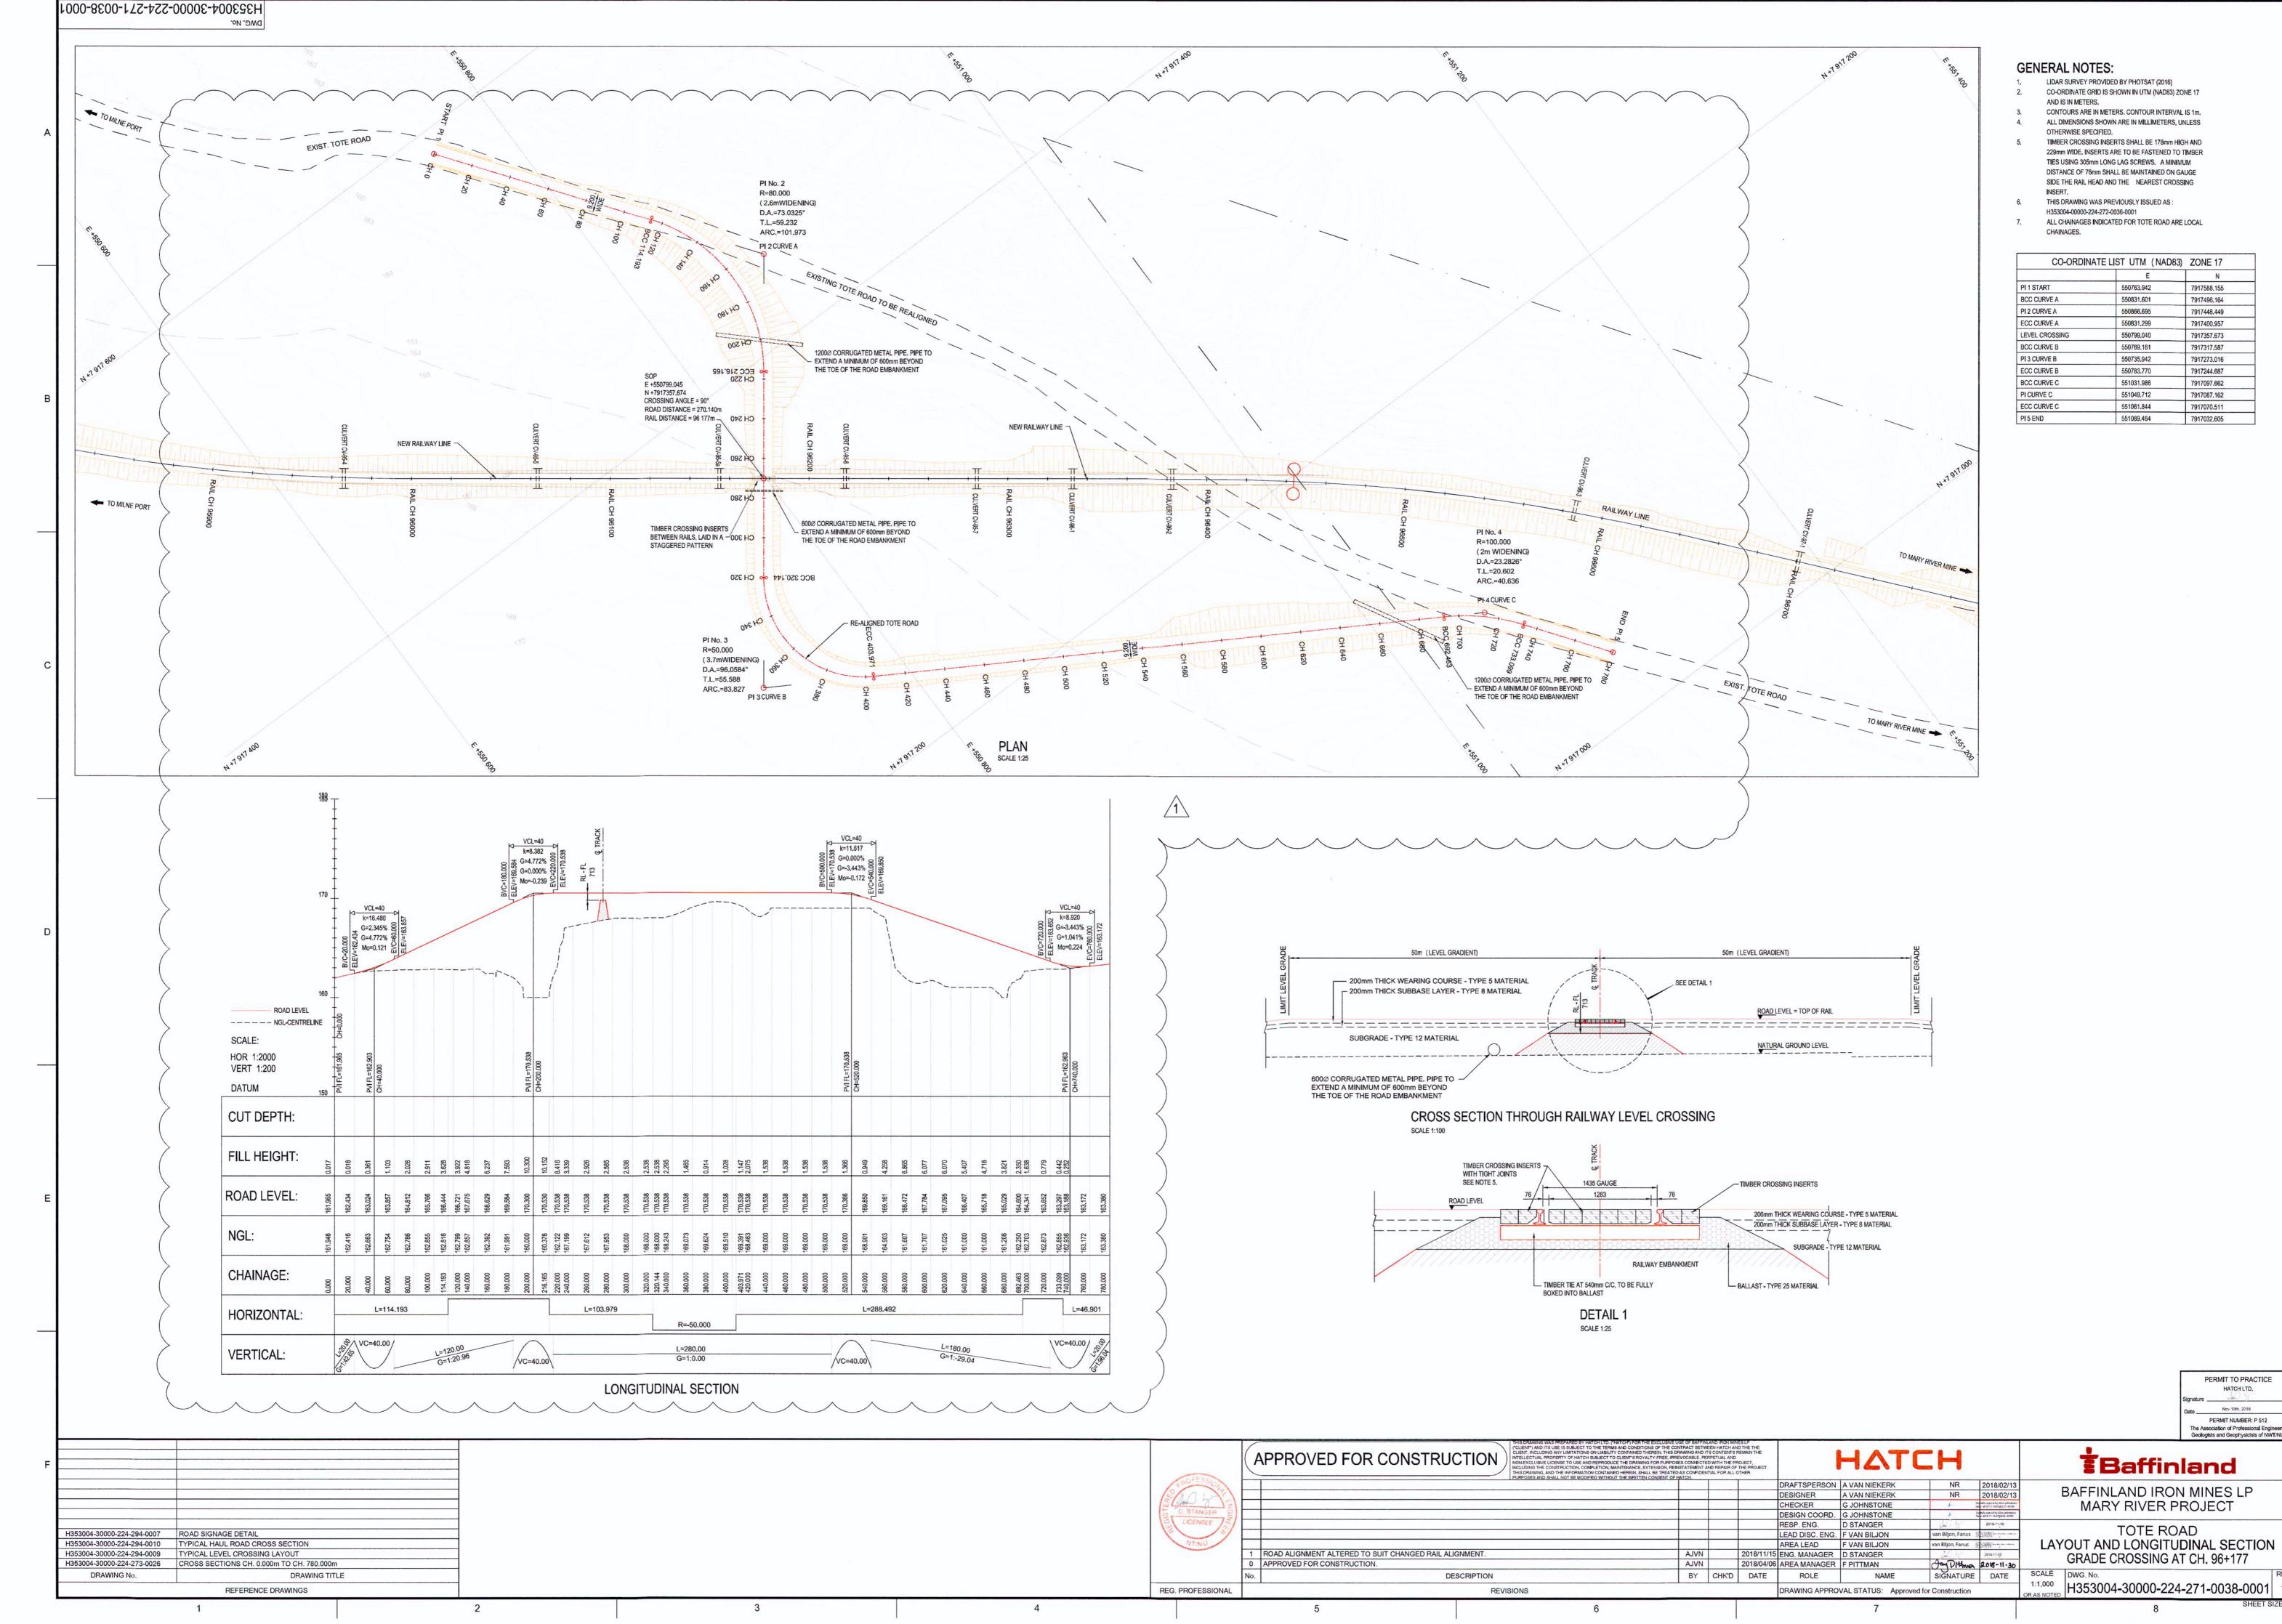
7930373.615

7930011,793

| | | 750 | APPROVED FOR CONSTRUCTIO | THIS DRAWING WAS PREPARED BY HATCH LTD, "HATCH" FOR THE EXCLUSIVE USE OF BAFFINLAND IRON MI (CLIENT) AND ITS USE IS SUBJECT TO THE TERMS AND CONDITIONS OF THE CONTRACT BETWEEN HATCH A CLIENT, INCLUDING ANY LIMITATIONS ON LIBILITY CONTAINED THEREIN. THIS DRAWING AND ITS CONTENTS INTELLECTUAL PROPERTY OF HATCH SUBJECT TO CLIENT'S ROYALTY-FREE, IRREVOCABLE, PERPETUAL AND NONEXCLUSIVE LICENSE TO USE AND REPRODUCE THE DRAWING FOR PURPOSES CONNECTED WITH THE PINCLUDING THE CONSTRUCTION, COMPLETION, MAINTENANCE, EXTENSION, REINSTATEMENT AND REPAIR O THIS DRAWING, AND THE INFORMATION CONTAINED HEREIN, SHALL BE TREATED AS CONFIDENTIAL FOR ALL PURPOSES AND SHALL NOT BE MODIFIED WITHOUT THE WITTEN CONSENT OF HATCH. | ILP THE THE MAIN THE JECT, HE PROJECT. HER | ΗΔΤ | СН | Baffinland |
|----------------------------|---|-------------------|--|---|---|---------------------|--------------------------------------|---|
| | | QROPESSION | | | DRAFTSPER | ON A VAN NIEKERK | NR 09/02 | PAFFINI AND IDON MINES LD |
| 200 | | 18/ 100 101 | | | DESIGNER | A VAN NIEKERK | NR 09/02 | BAFFINLAND IRON MINES LP |
| | | The second second | | | CHECKER | F VAN BILJON | van Biljon, Fanus Statemen Hips Fang | MARY RIVER PROJECT |
| | | D. STANGER | | | DESIGN COO | RD. F VAN BILJON | van Biljon, Fanus | |
| | | LICENSEE IT | | | RESP. ENG. | D STANGER | 2018-11-19 | TOTE DOAD |
| H353004-30000-224-294-0007 | ROAD SIGNAGE DETAIL | 1000 | | | LEAD DISC. E | NG. F VAN BILJON | van Biljon, Fanus | TOTE ROAD |
| H353004-30000-224-294-0010 | TYPICAL HAUL ROAD CROSS SECTION | NTNU | | | AREA LEAD | F VAN BILJON | van Biljon, Fanus | LAYOUT AND LONGITUDINAL SECTION |
| H353004-30000-224-294-0009 | TYPICAL LEVEL CROSSING LAYOUT | | 1 ROAD ALIGNMENT ALTERED TO SUIT CHANGED RAILWAY ALIGNMENT | NT. | ENG. MANAG | ER D STANGER | 2018-10-18 | GRADE CROSSING AT CH. 55+243 |
| H353004-30000-224-273-0023 | CROSS SECTIONS CH. 0.000m TO CH. 860.000m | 1 [| 0 APPROVED FOR CONSTRUCTION | AJVN | 2018/10/16 AREA MANAG | SER FPITTMAN | Jay Pittma 2018-11 | 1-30 GIVADE CINOSSING AT CIT. 35+245 |
| DRAWING No. | DRAWING TITLE | | No. DESCRIPTIO | N BY CHK'D | DATE ROLE | NAME | SIGNATURE DAT | |
| | REFERENCE DRAWINGS | REG. PROFESSIONAL | | REVISIONS | DRAWING AF | PROVAL STATUS: APPE | OVED FOR CONSTRUCTION | 1:1000 OR AS NOTED H353004-30000-224-271-0035-0001 |
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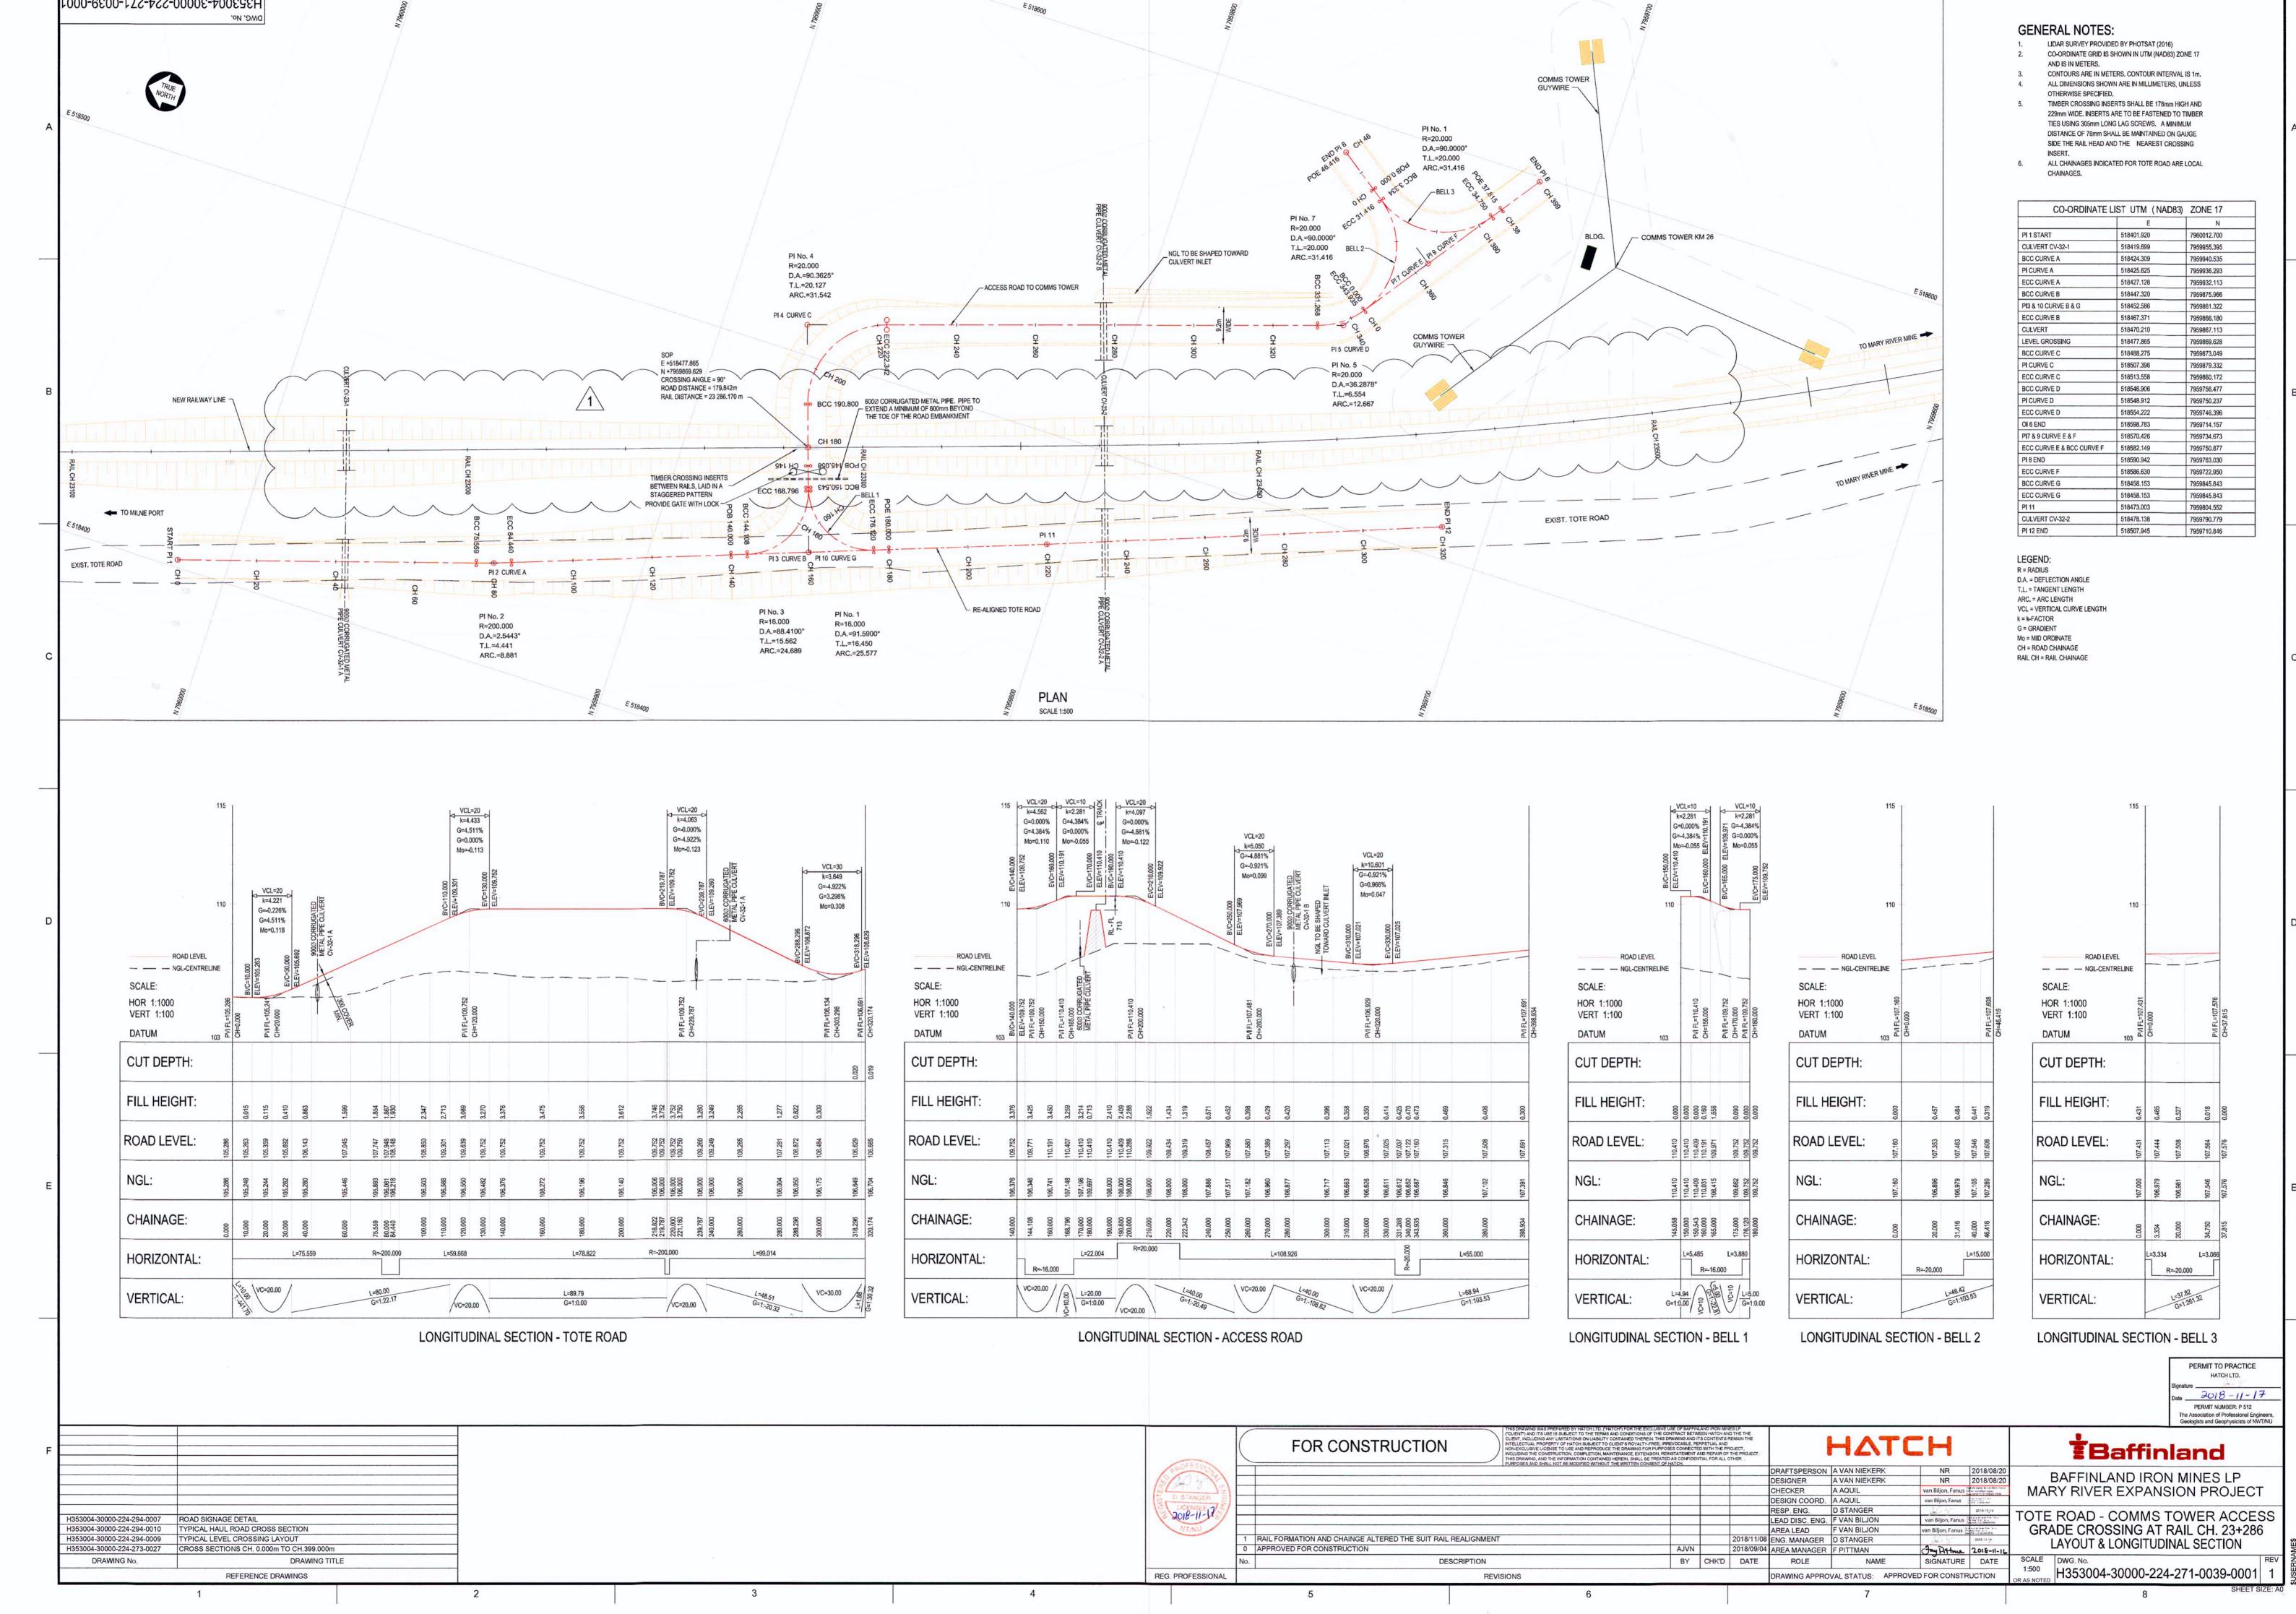




PERMIT TO PRACTICE

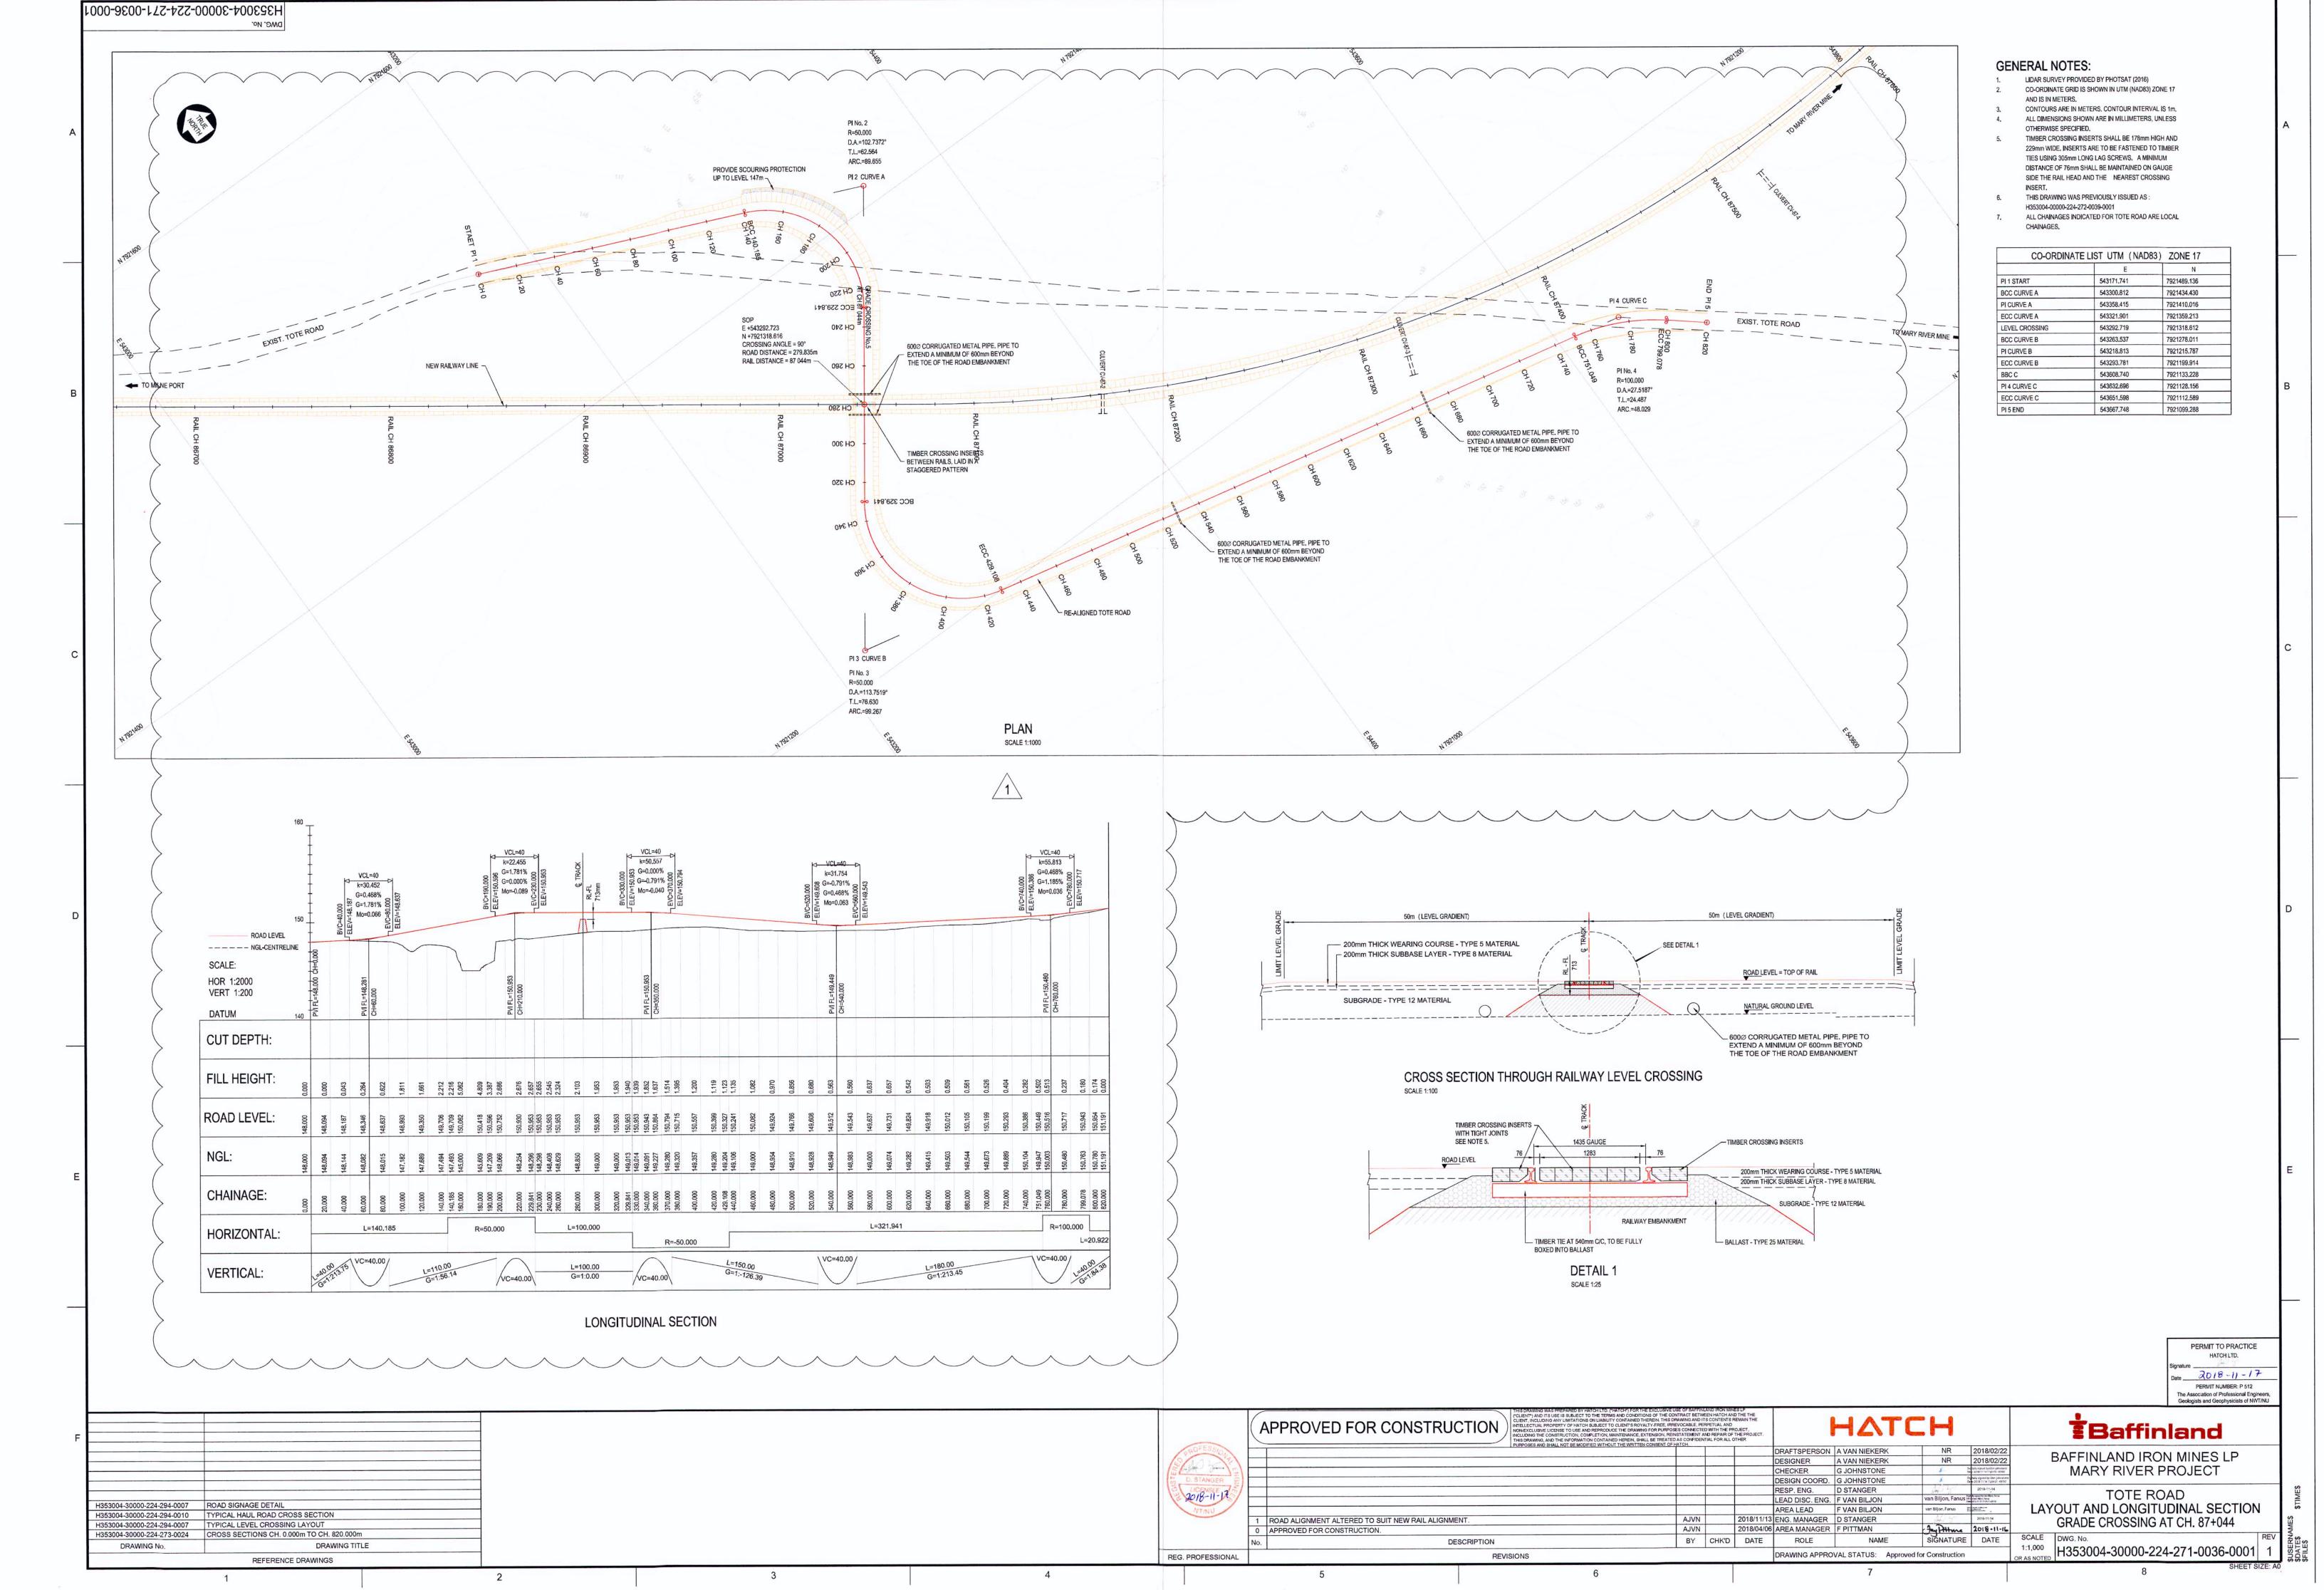
HATCH LTD.


Nov 19th, 2018 PERMIT NUMBER: P 512





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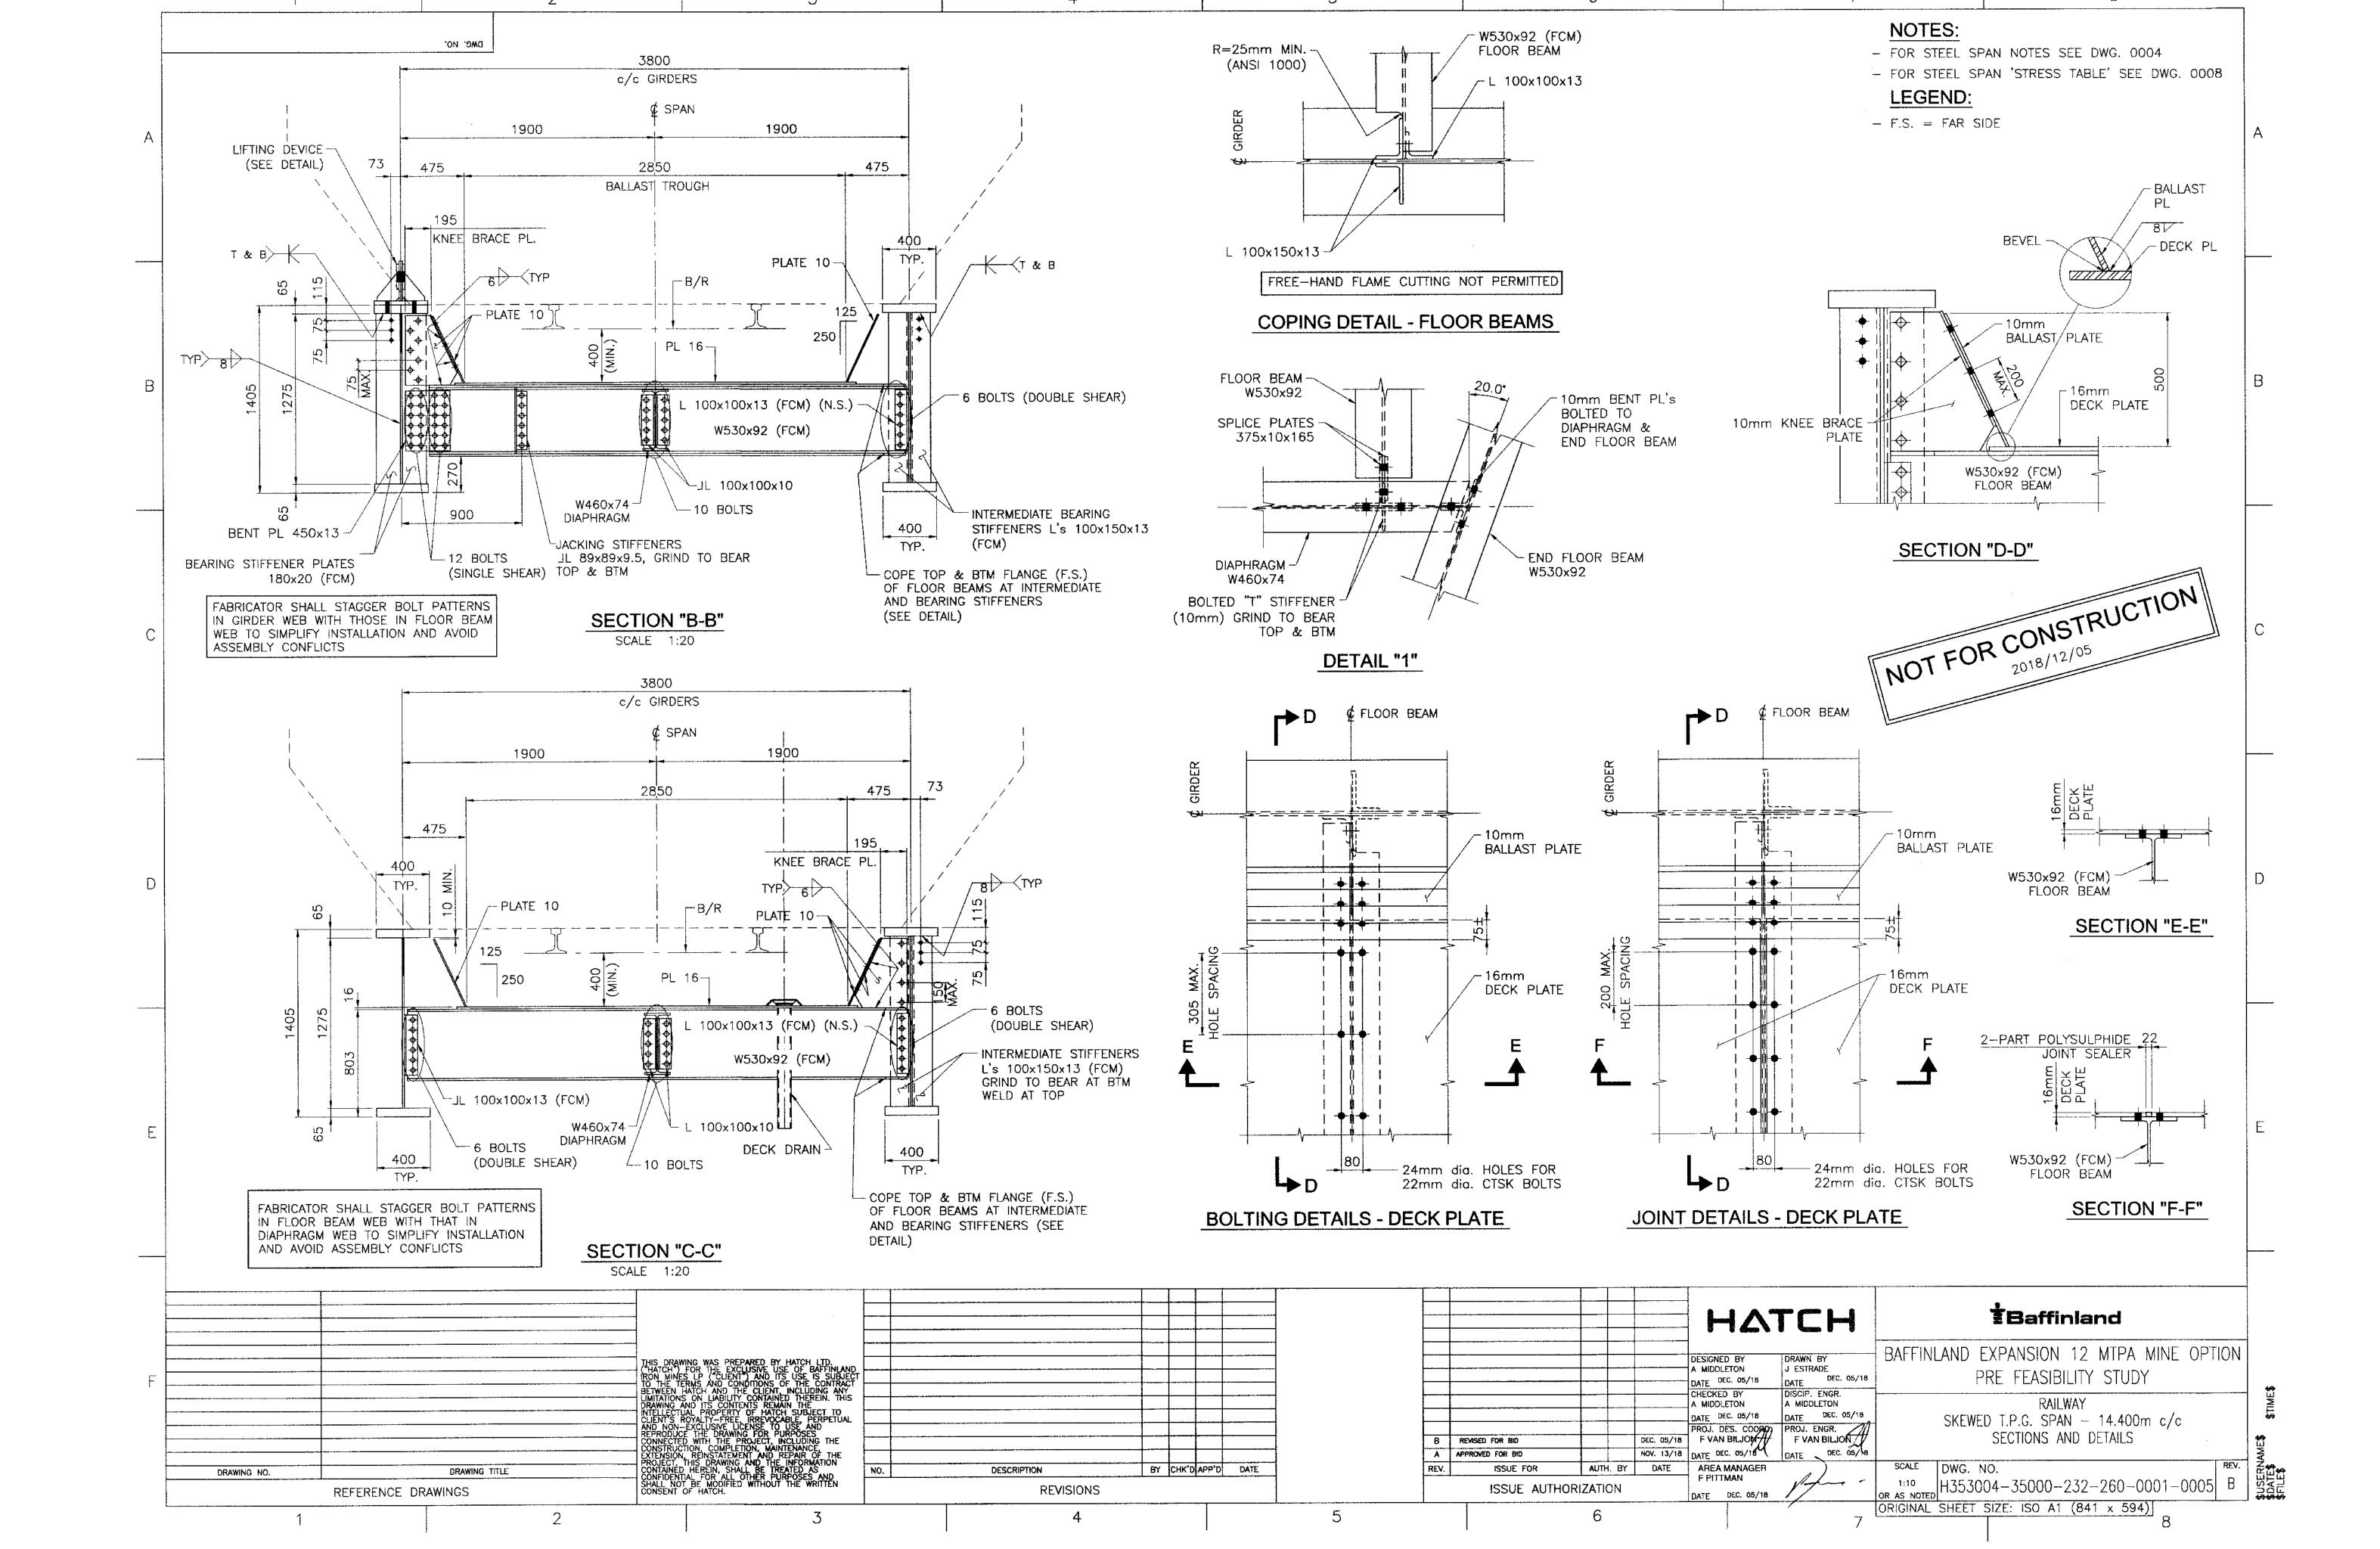





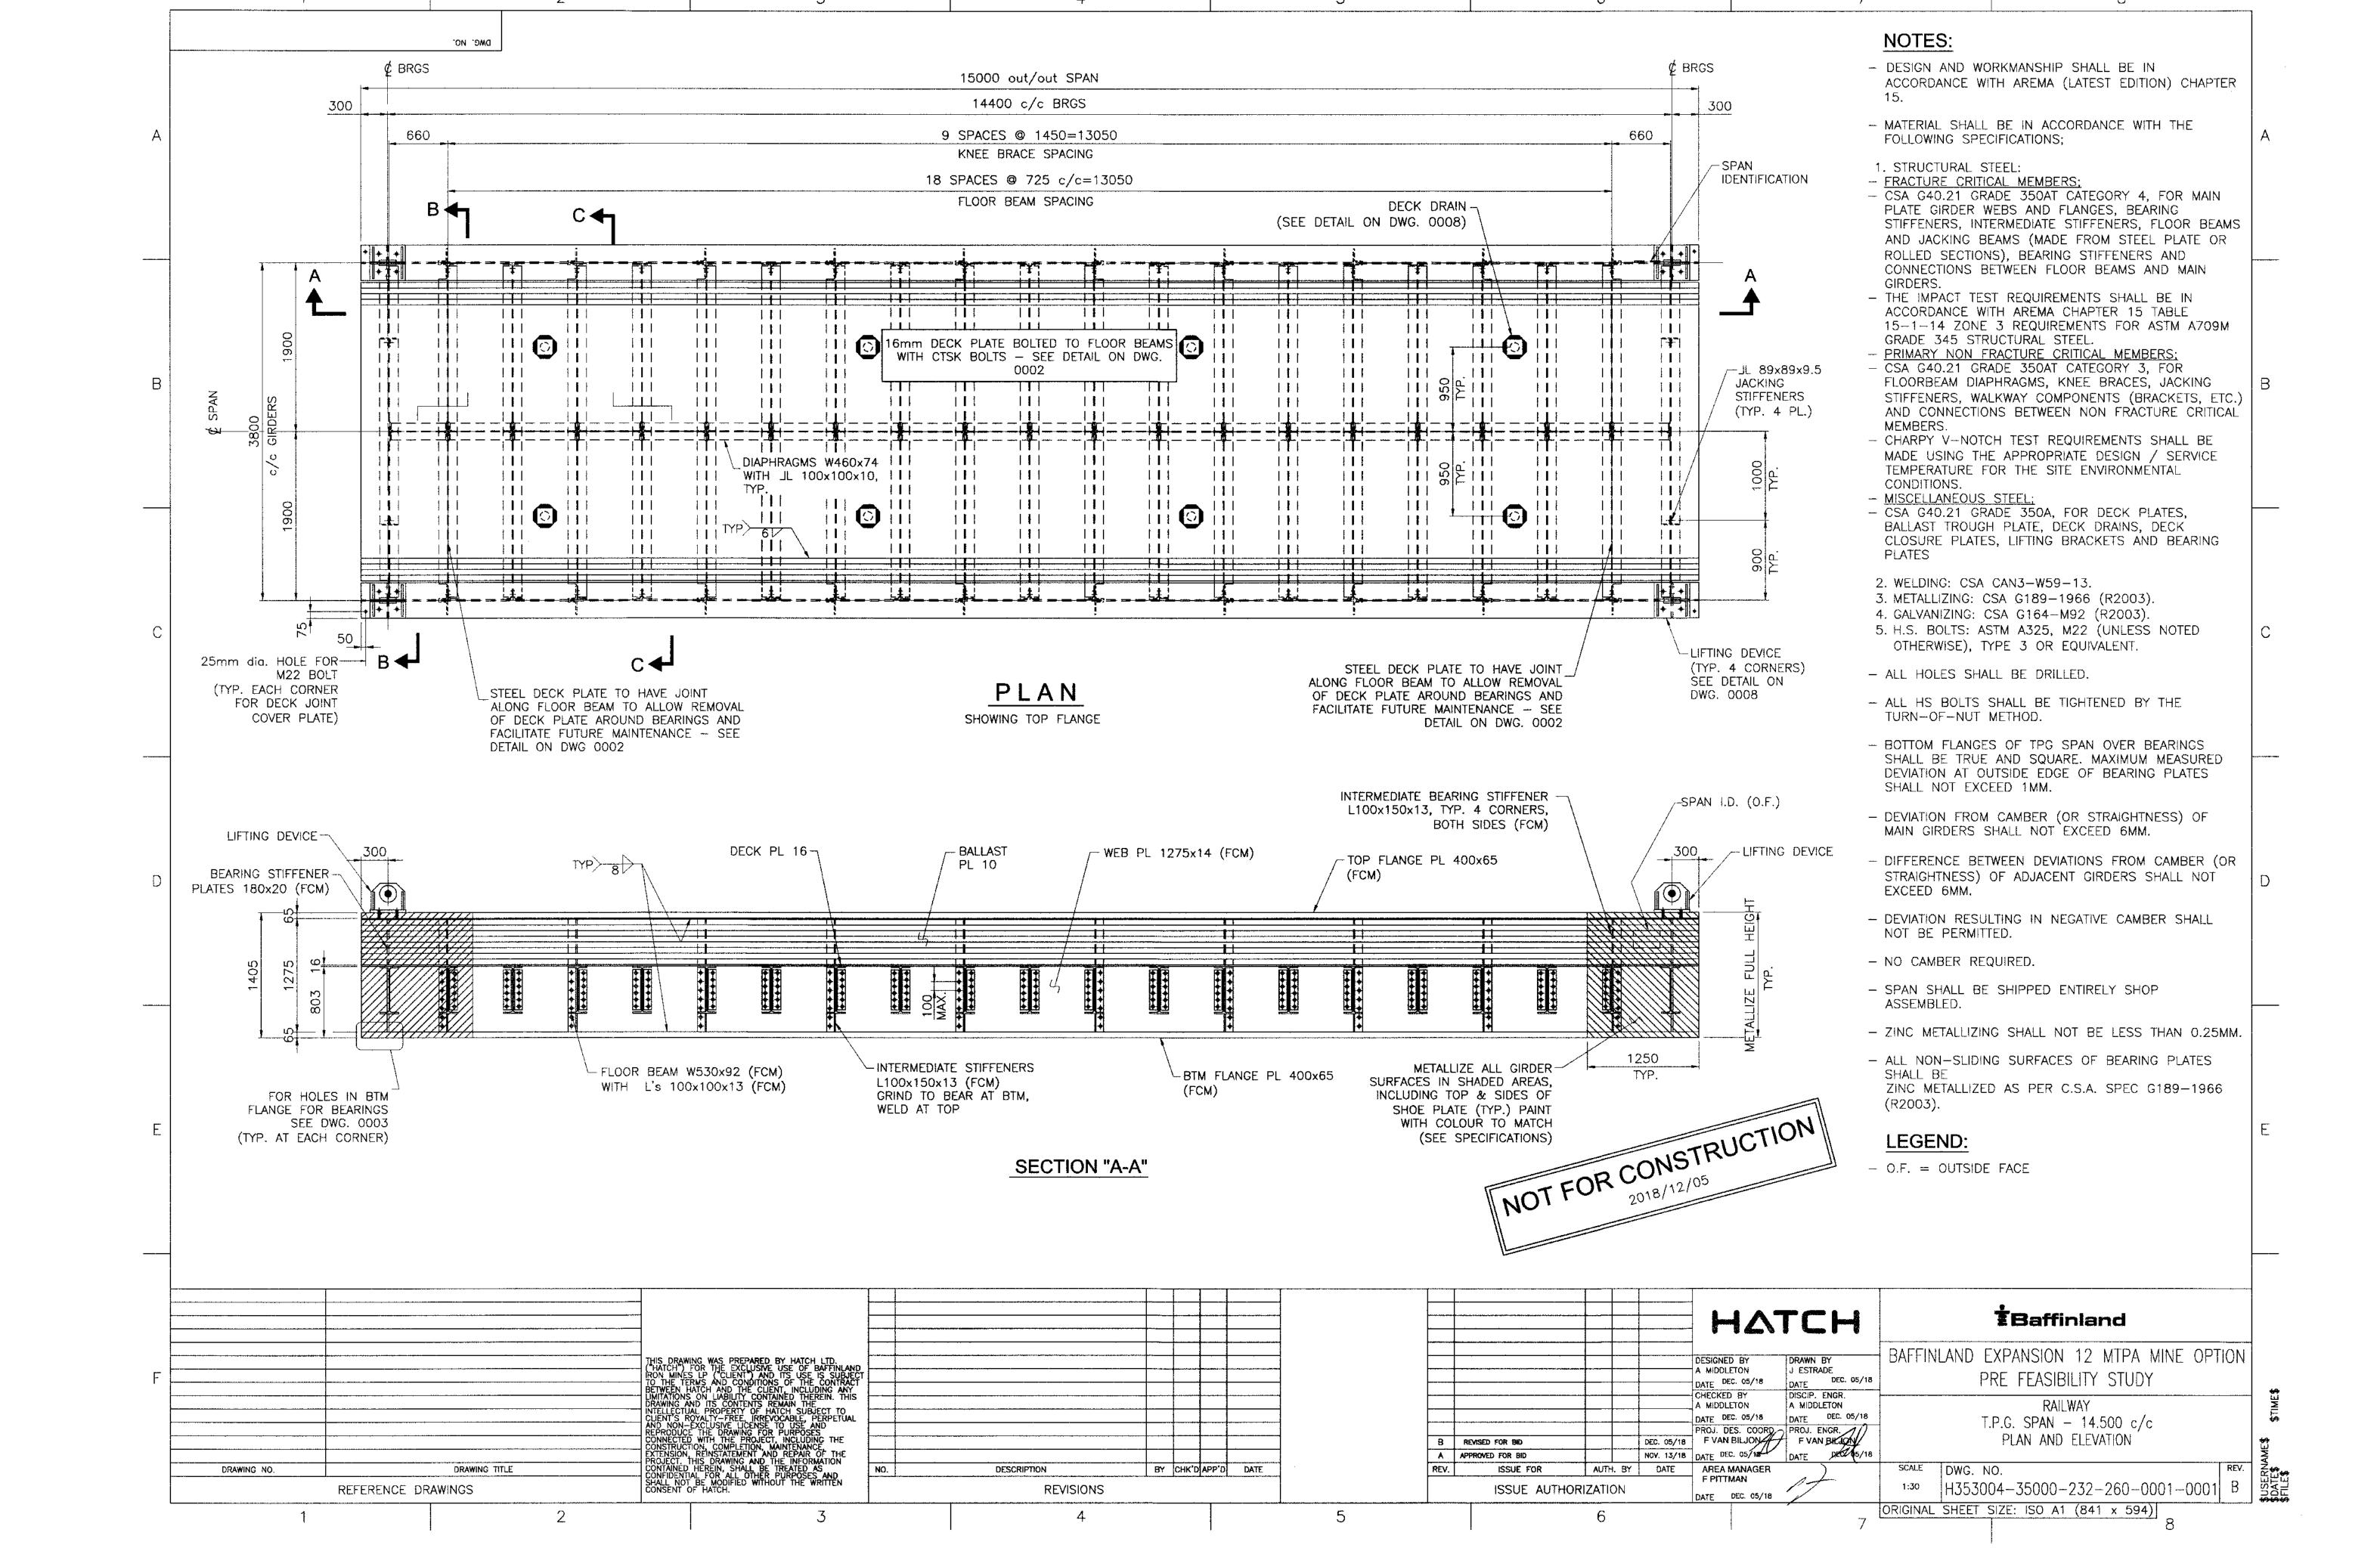


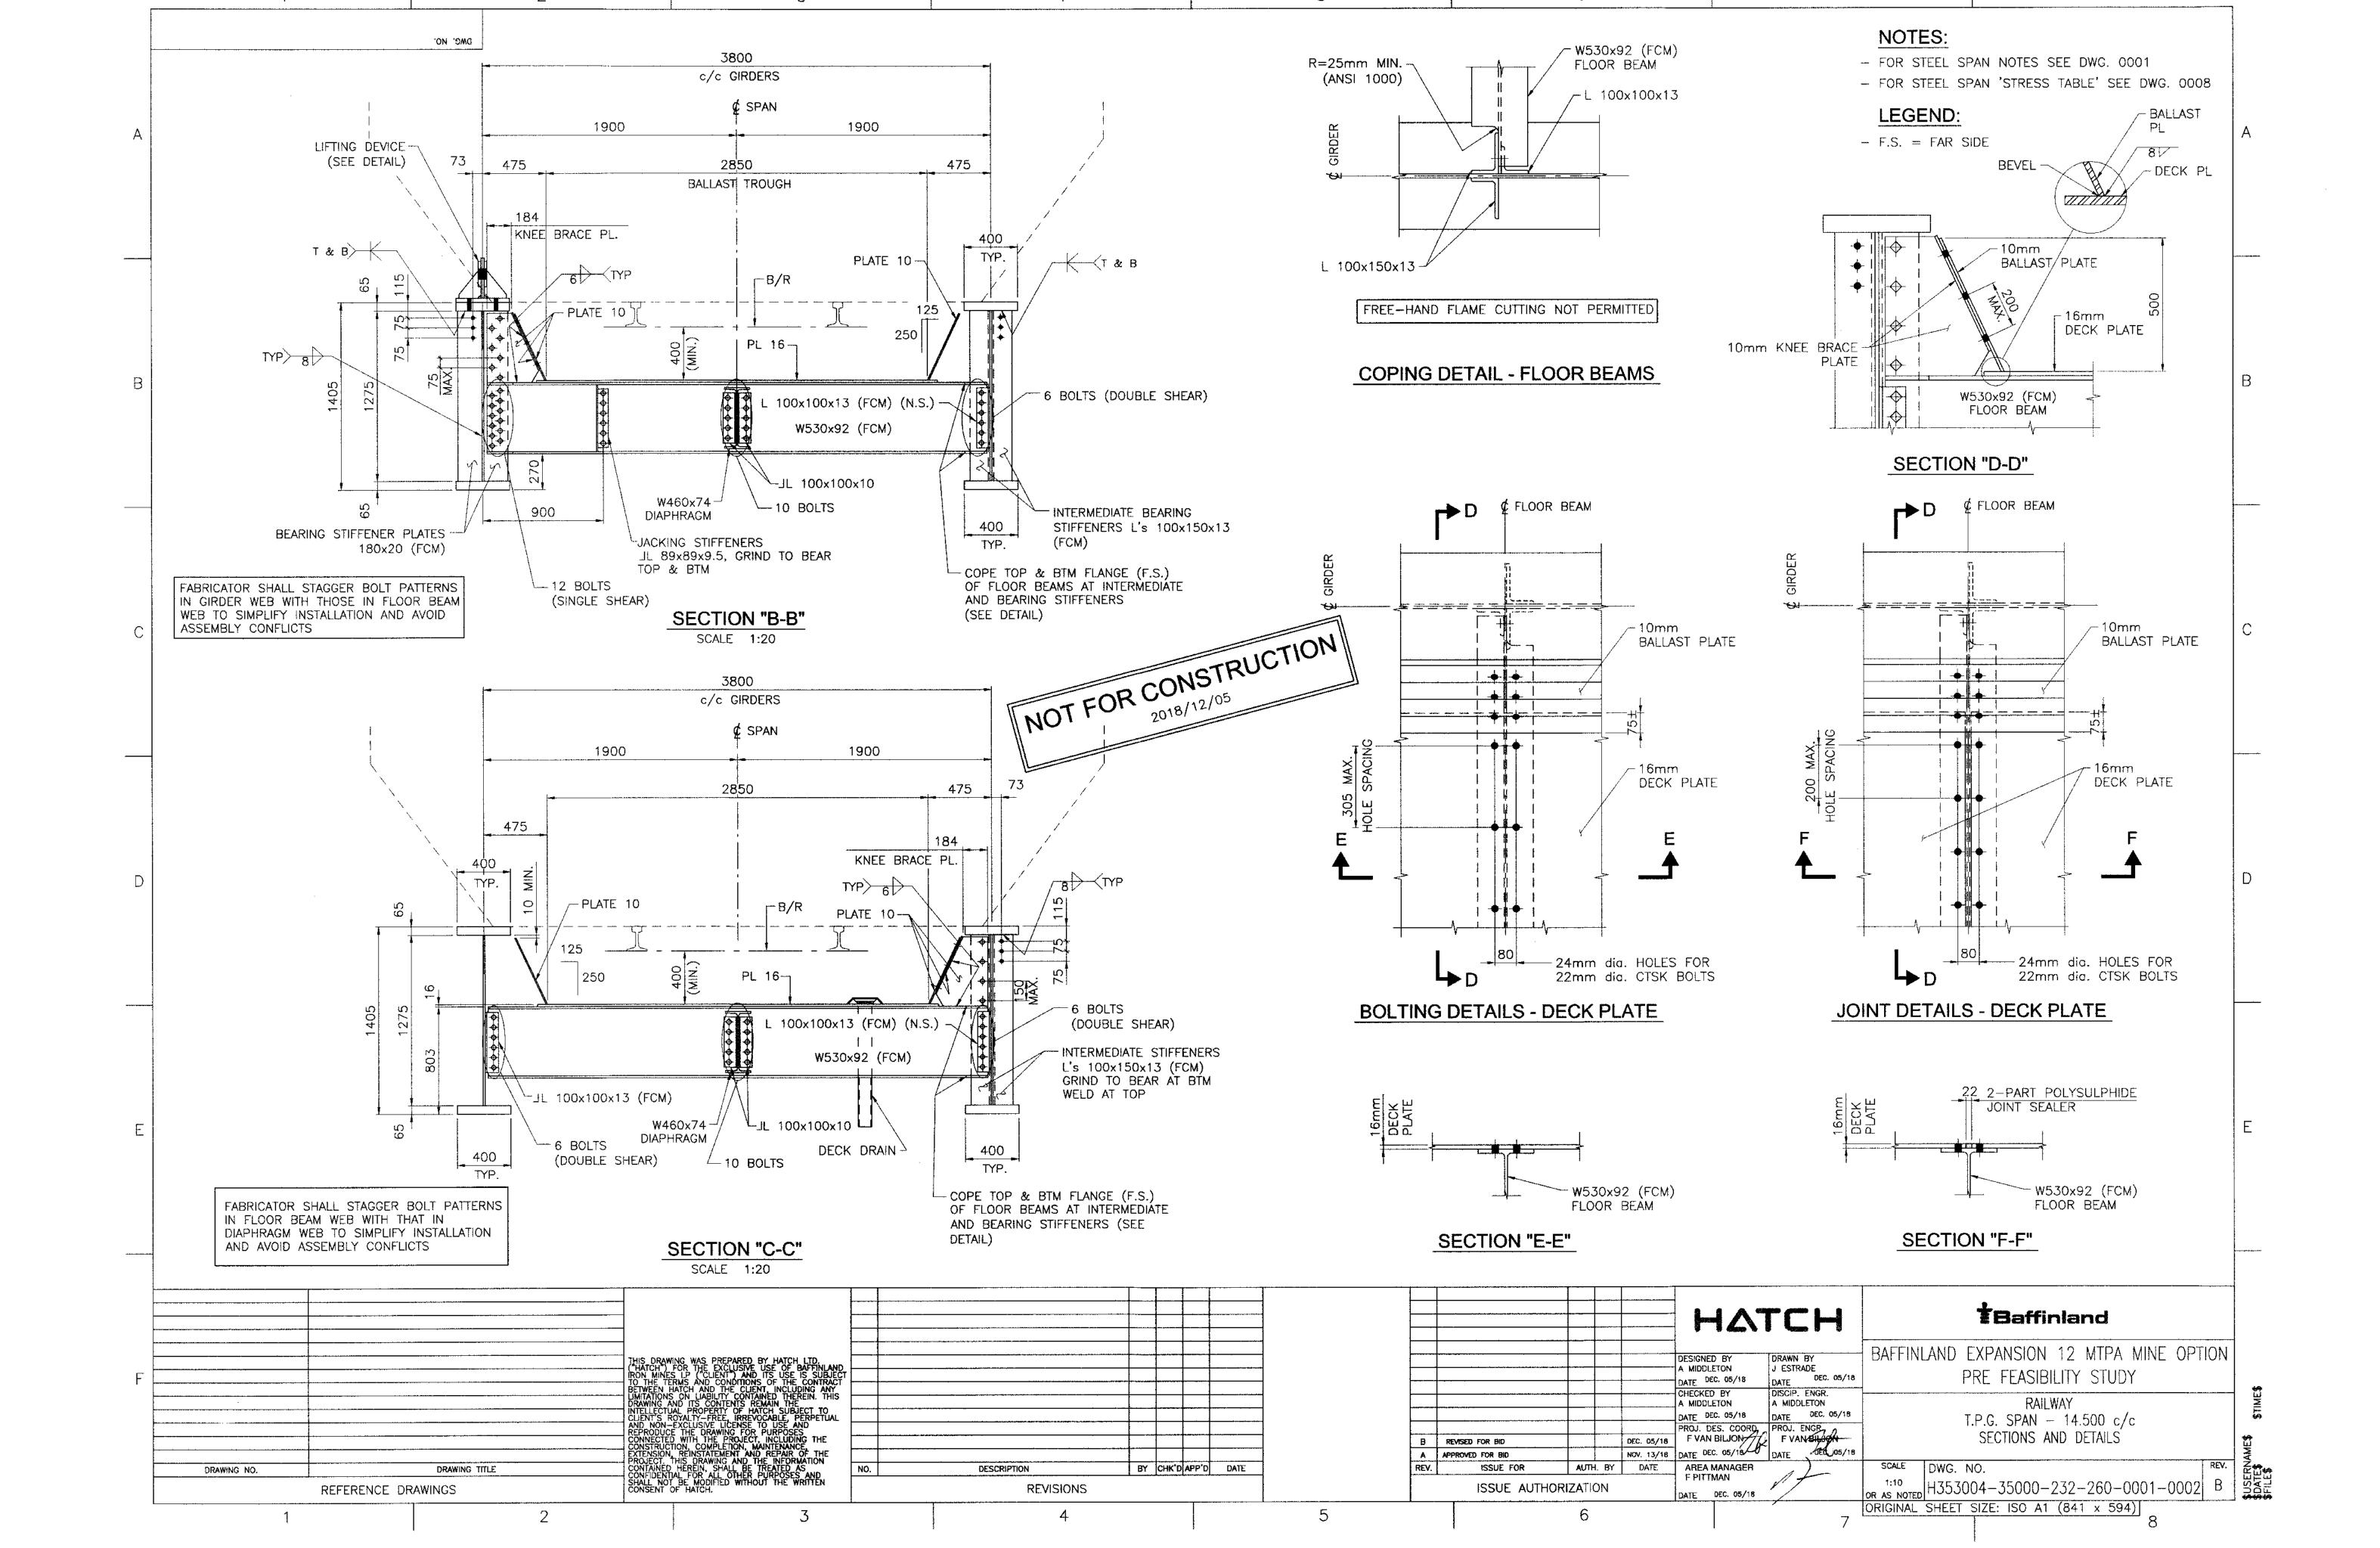


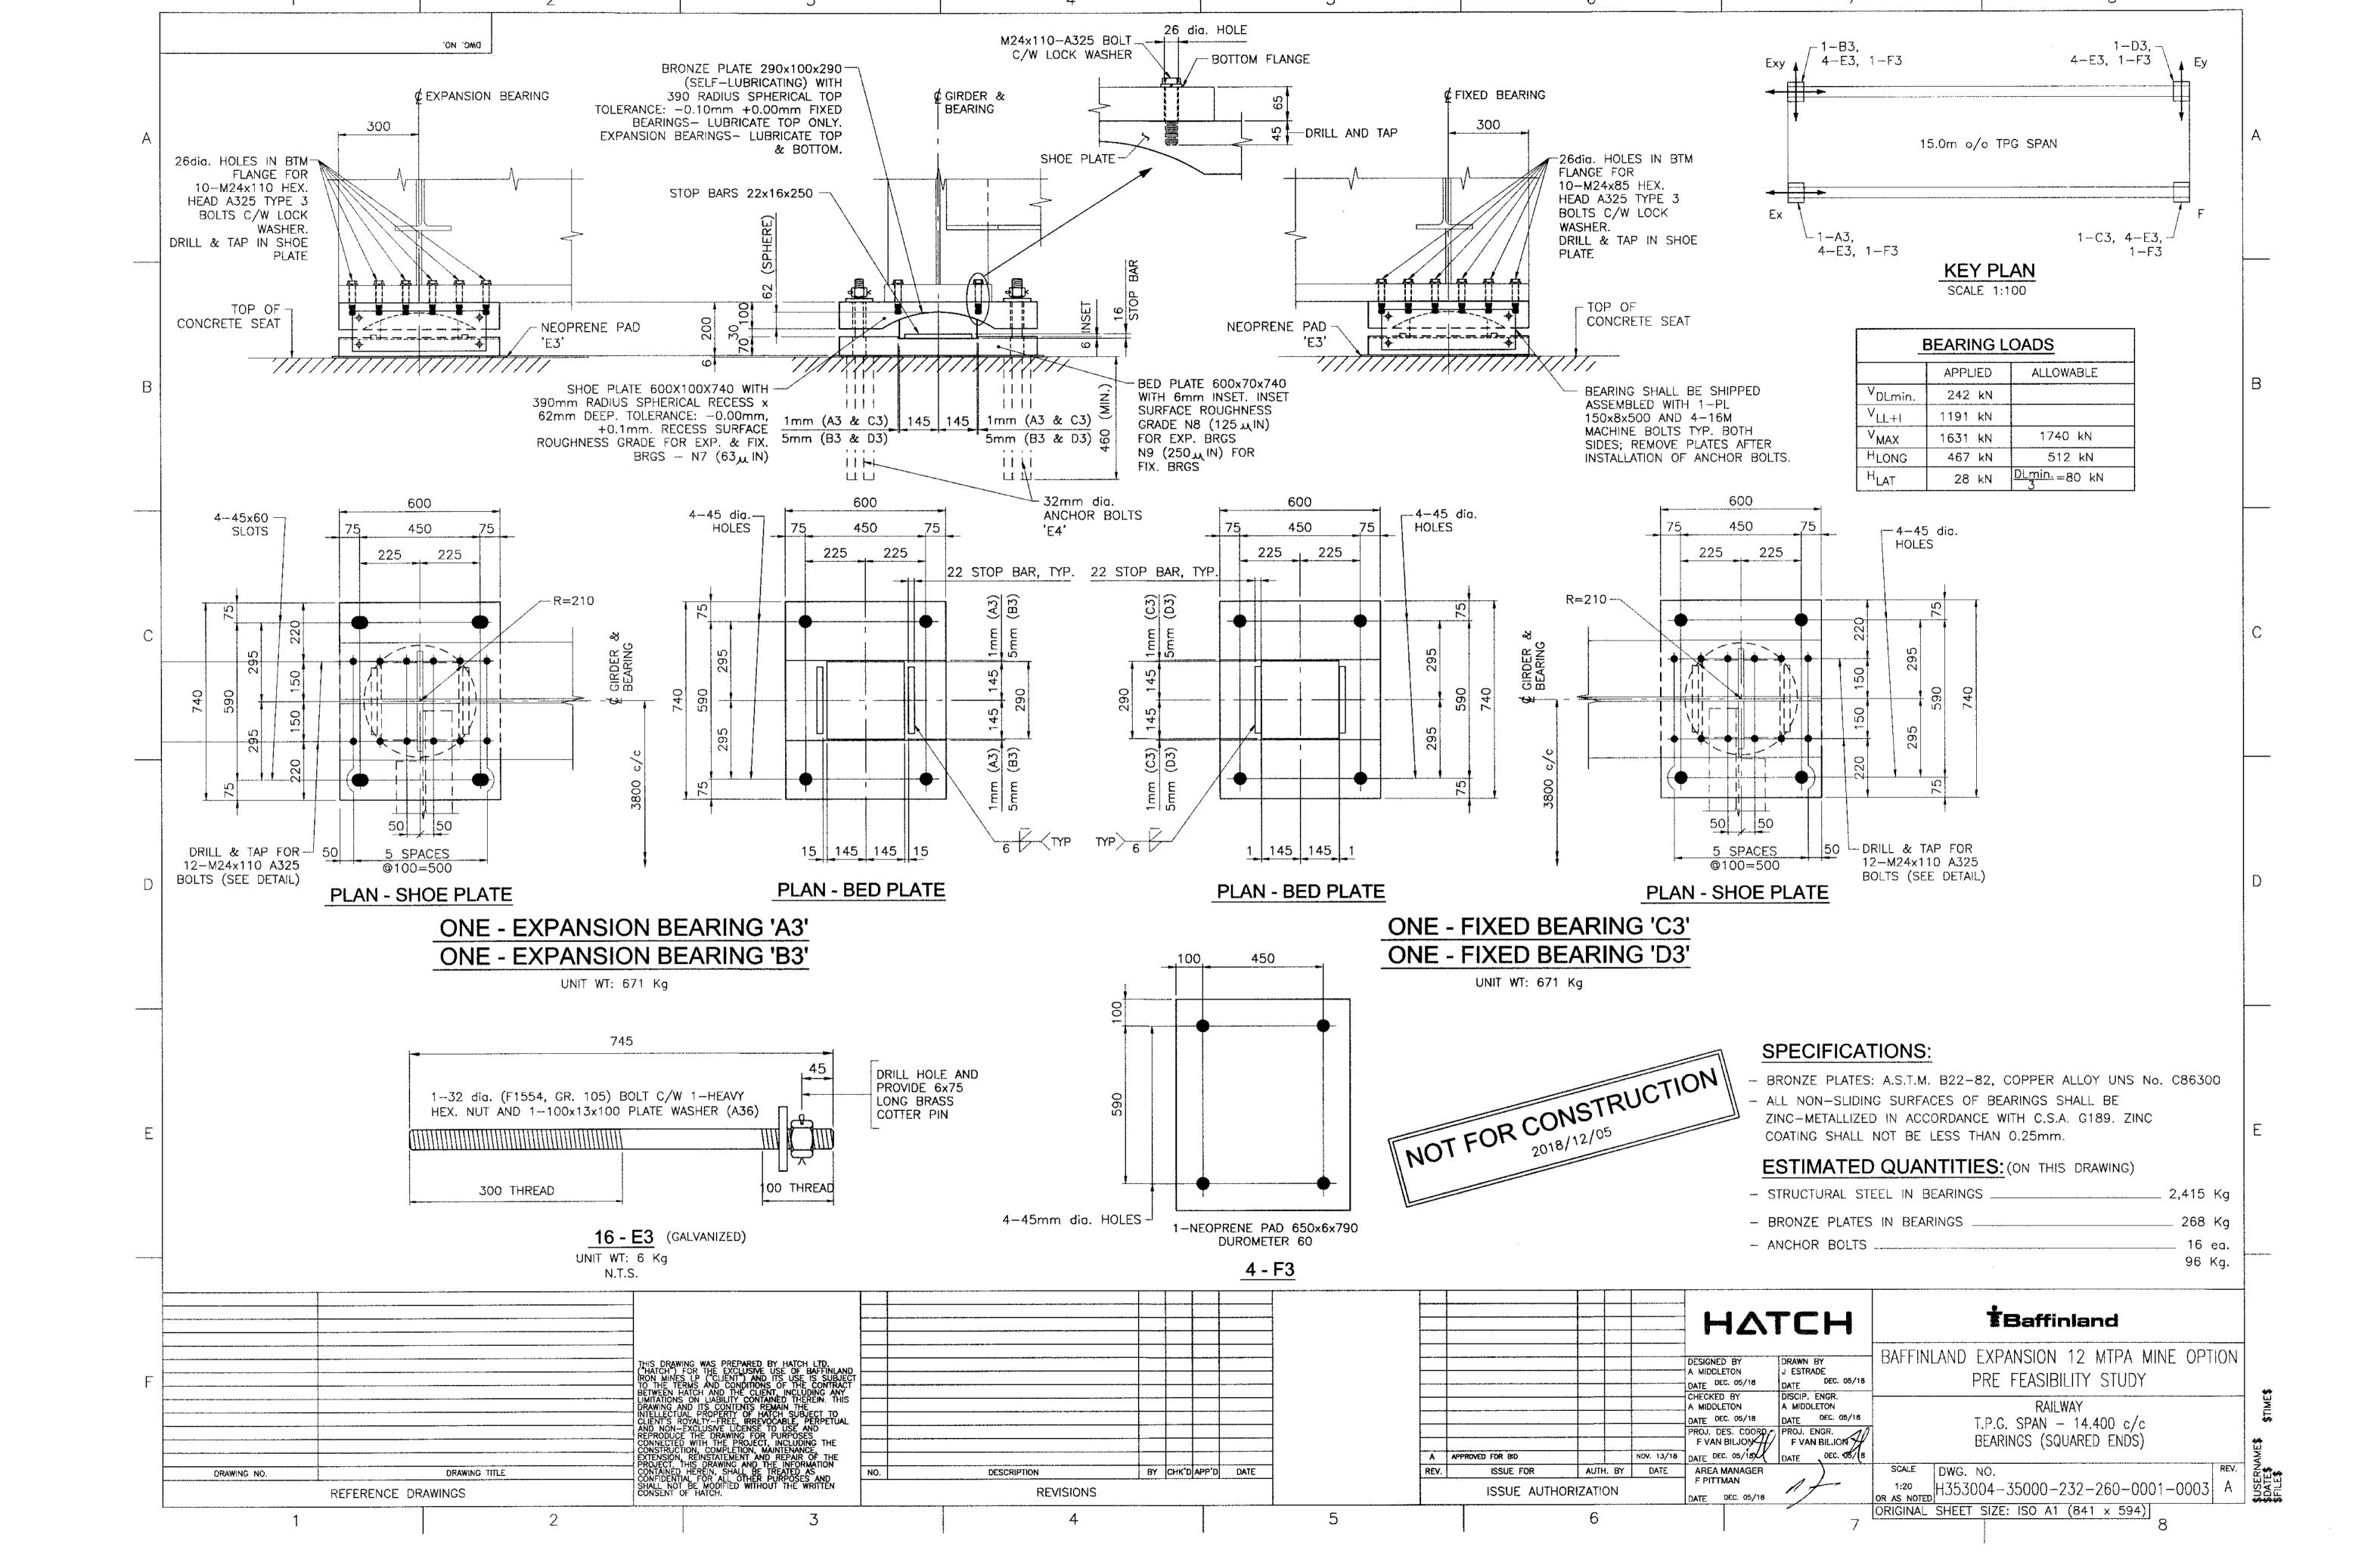


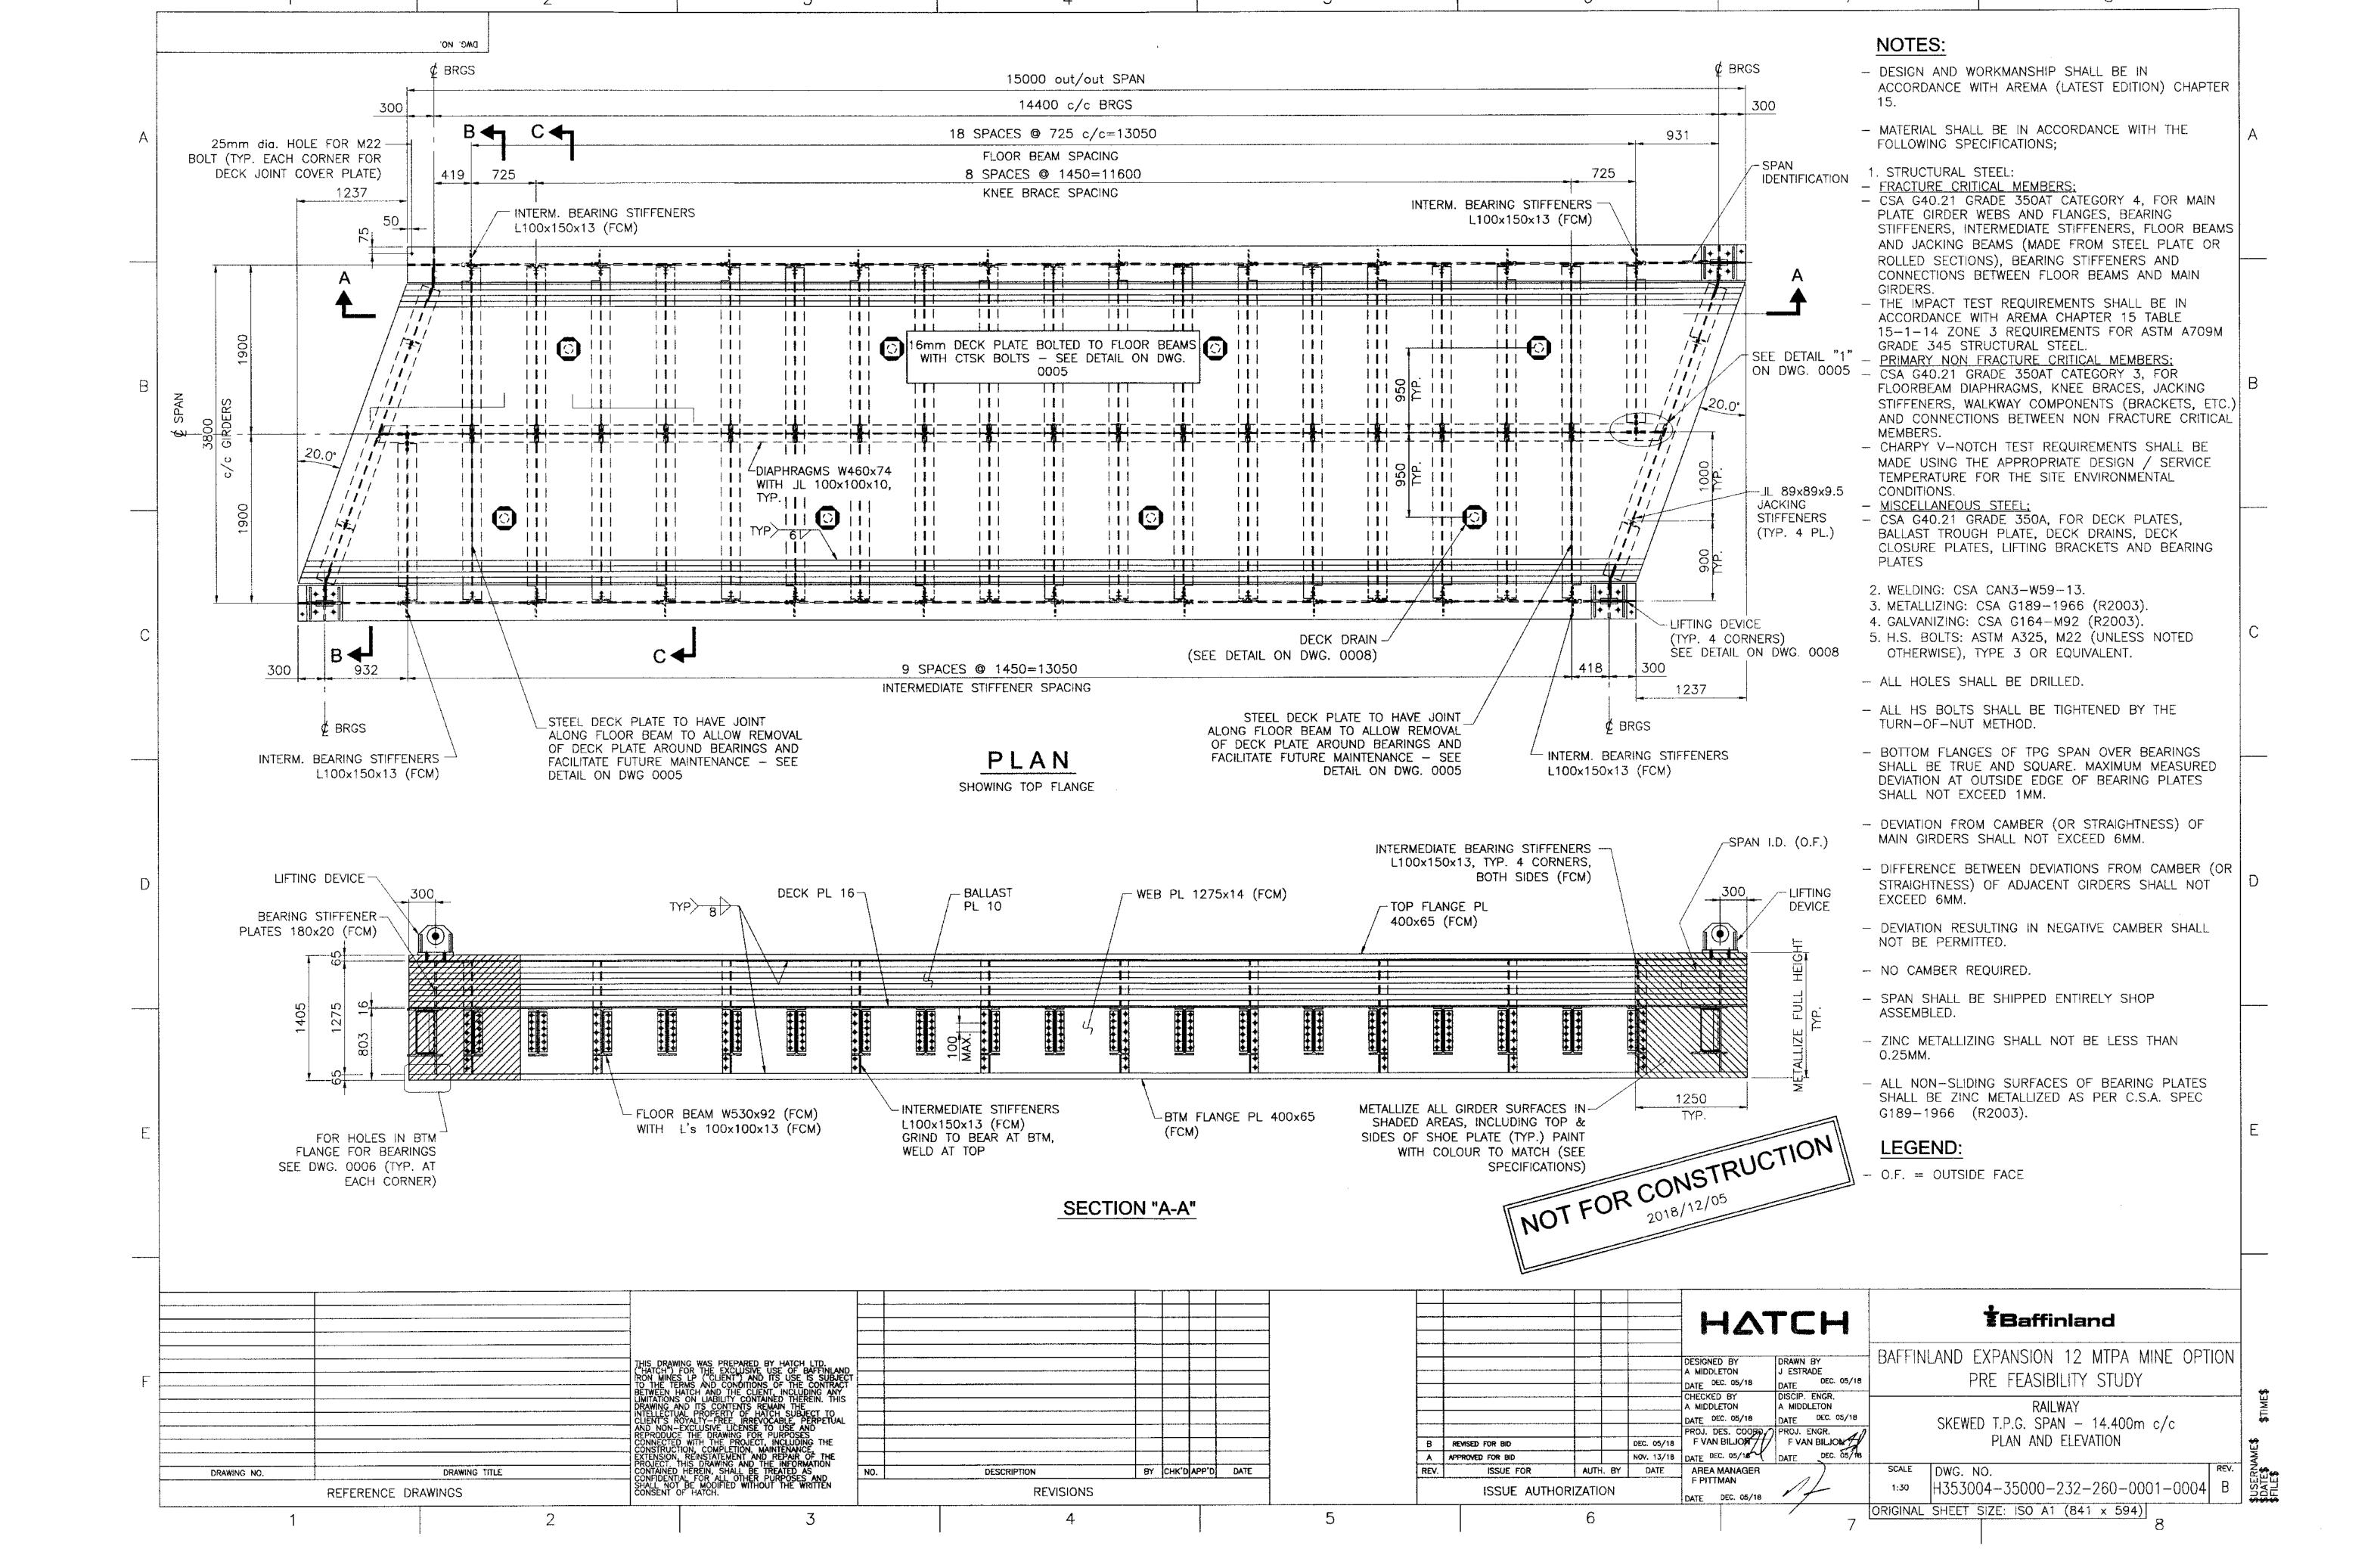

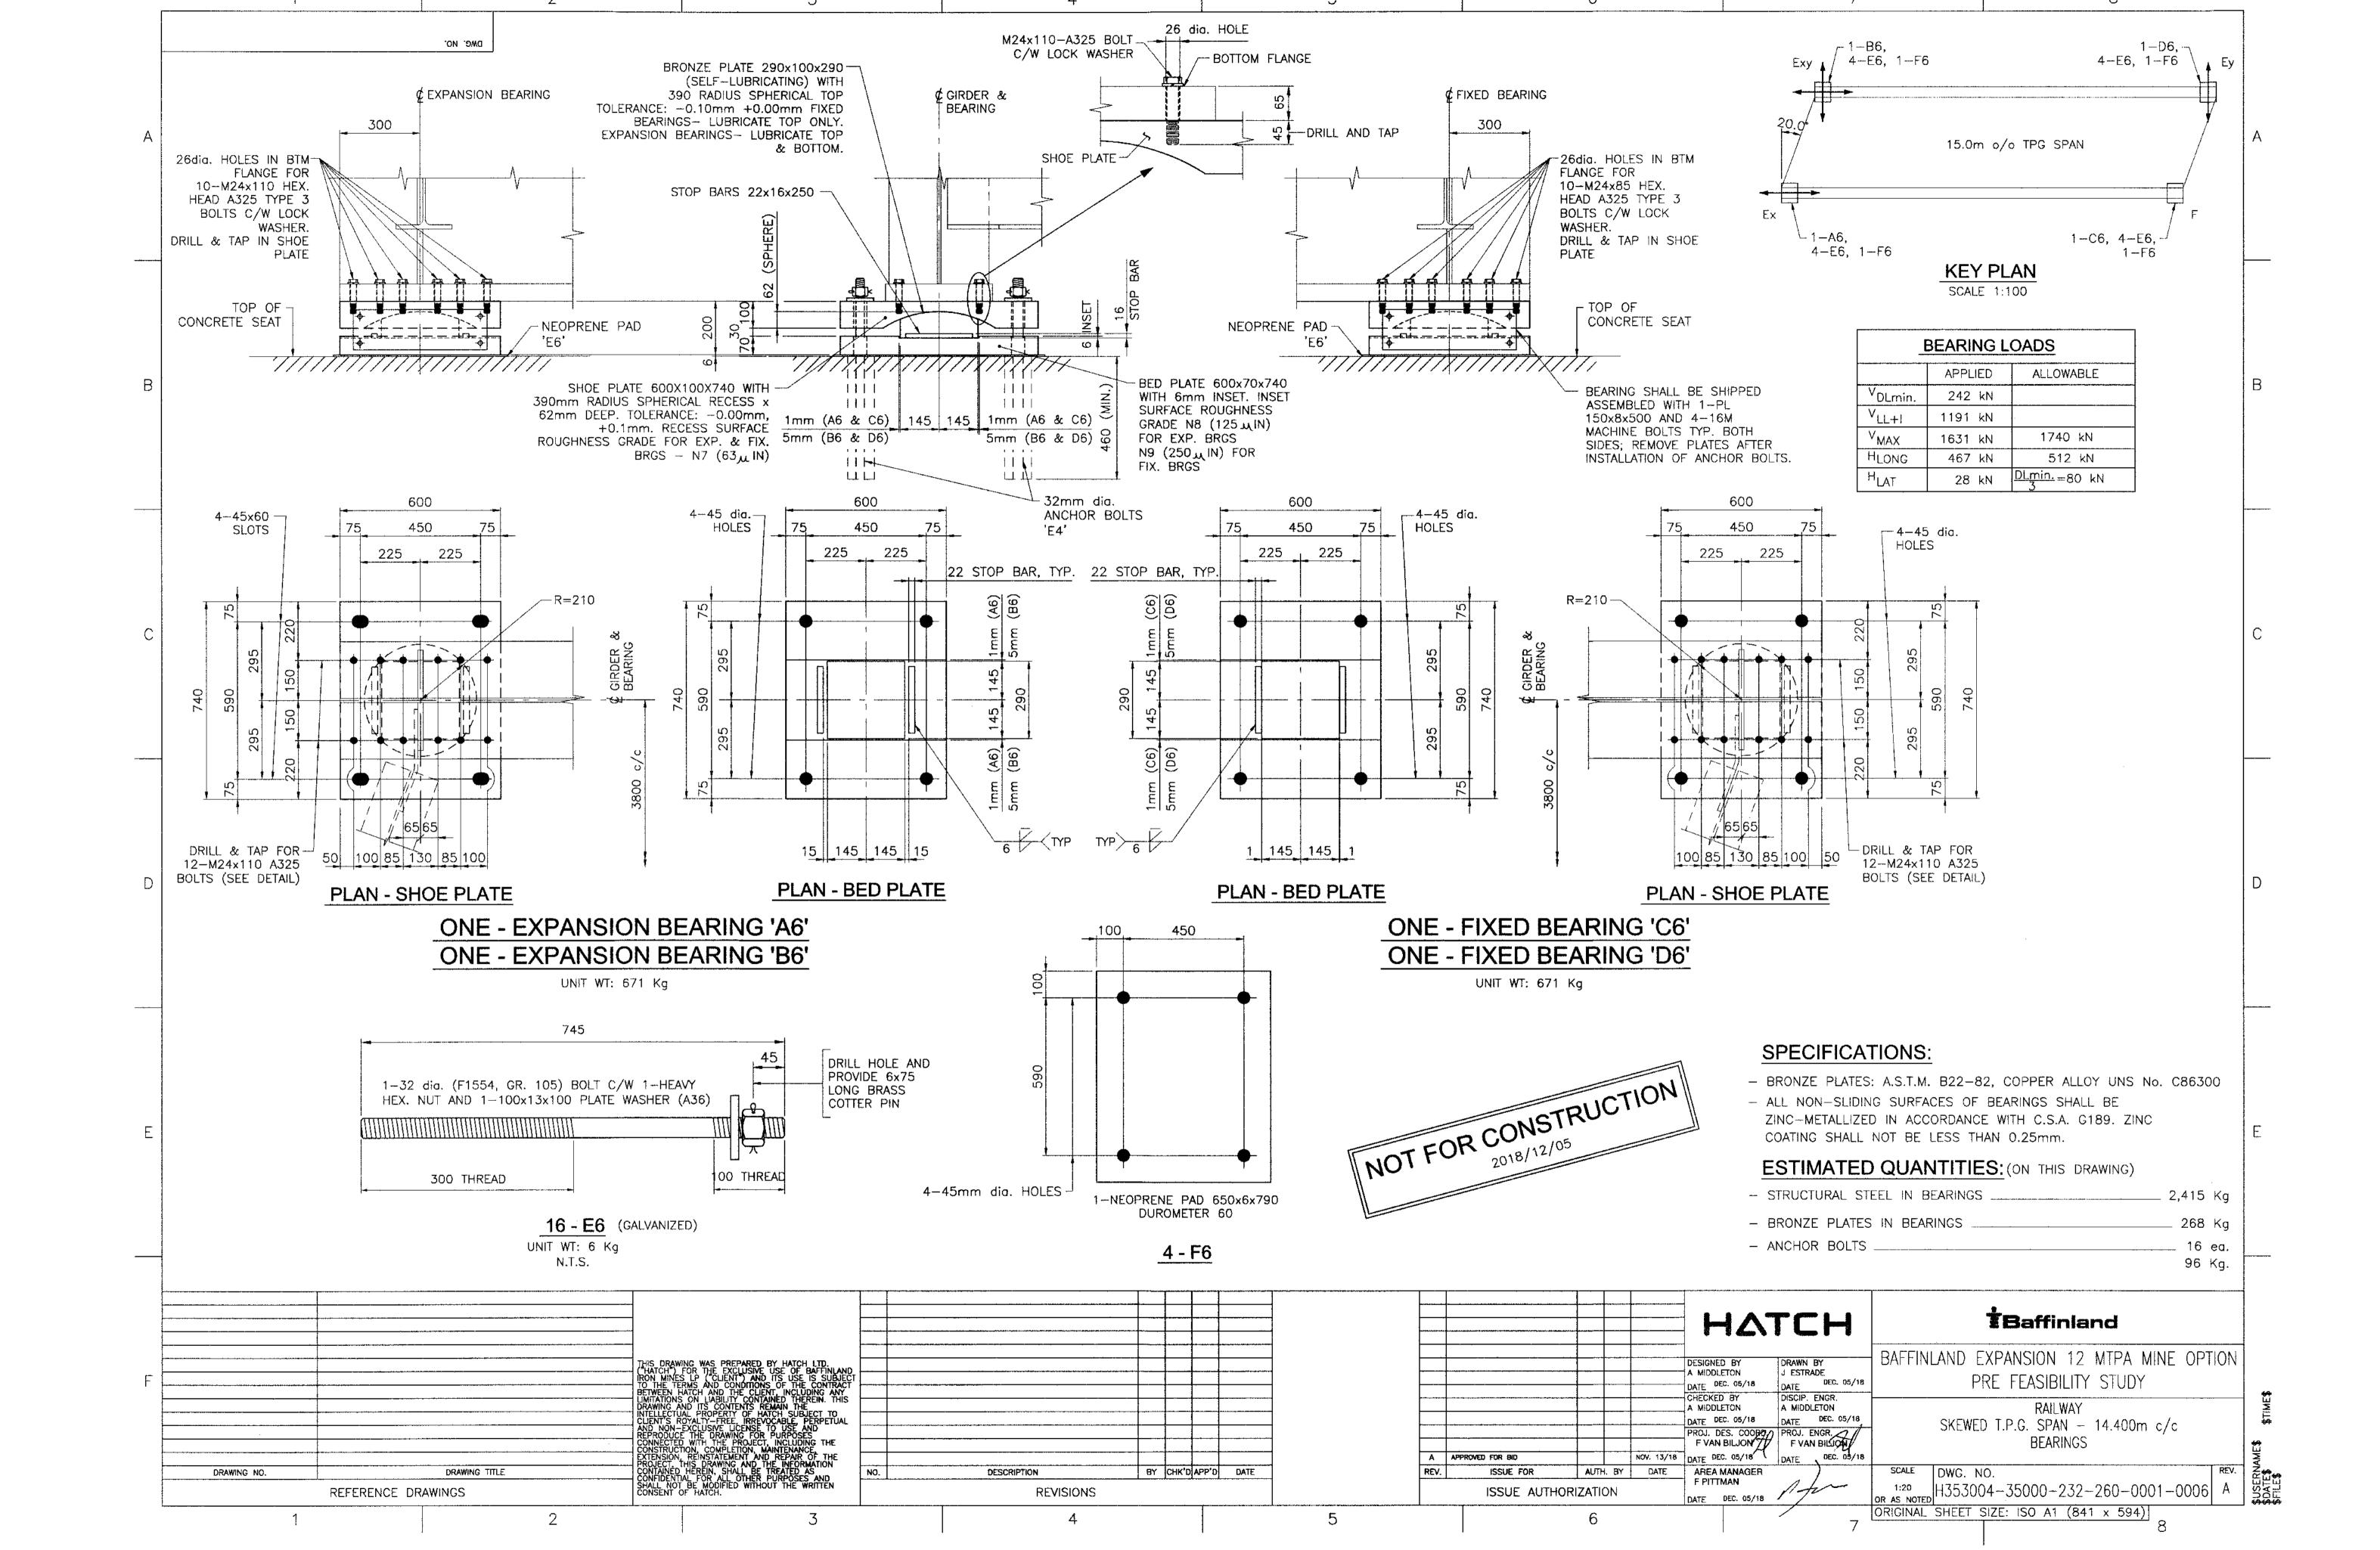

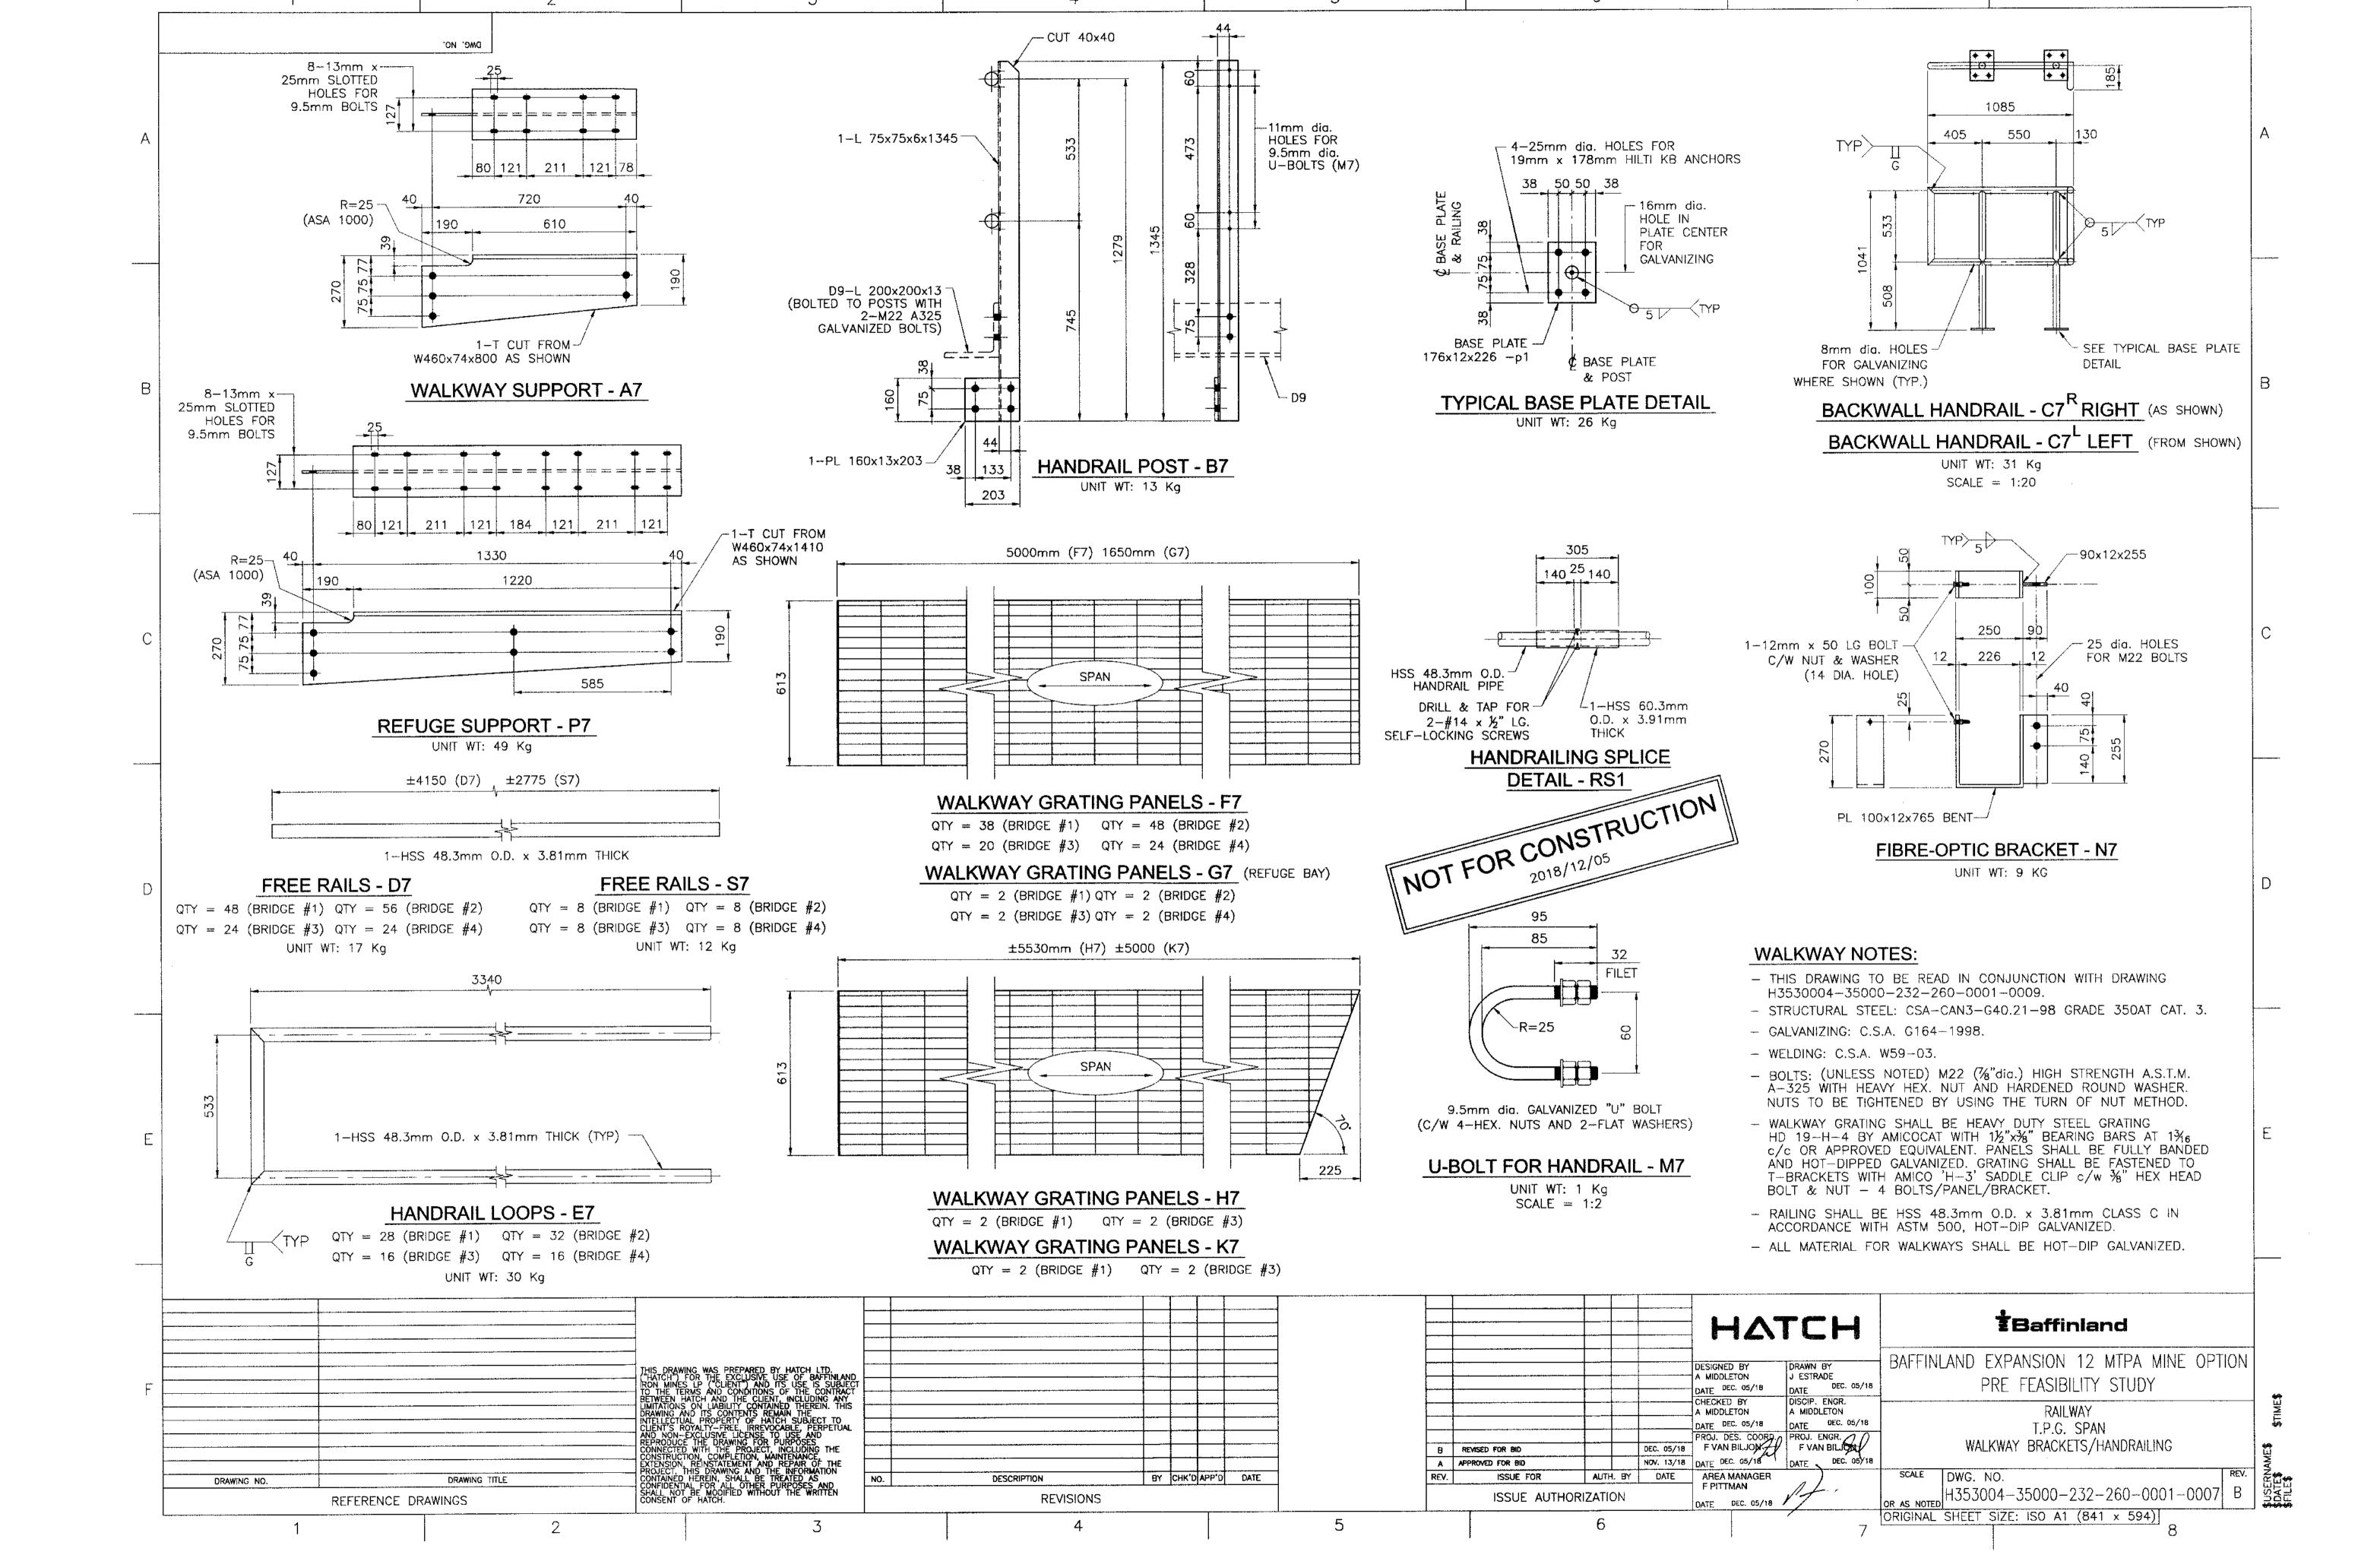

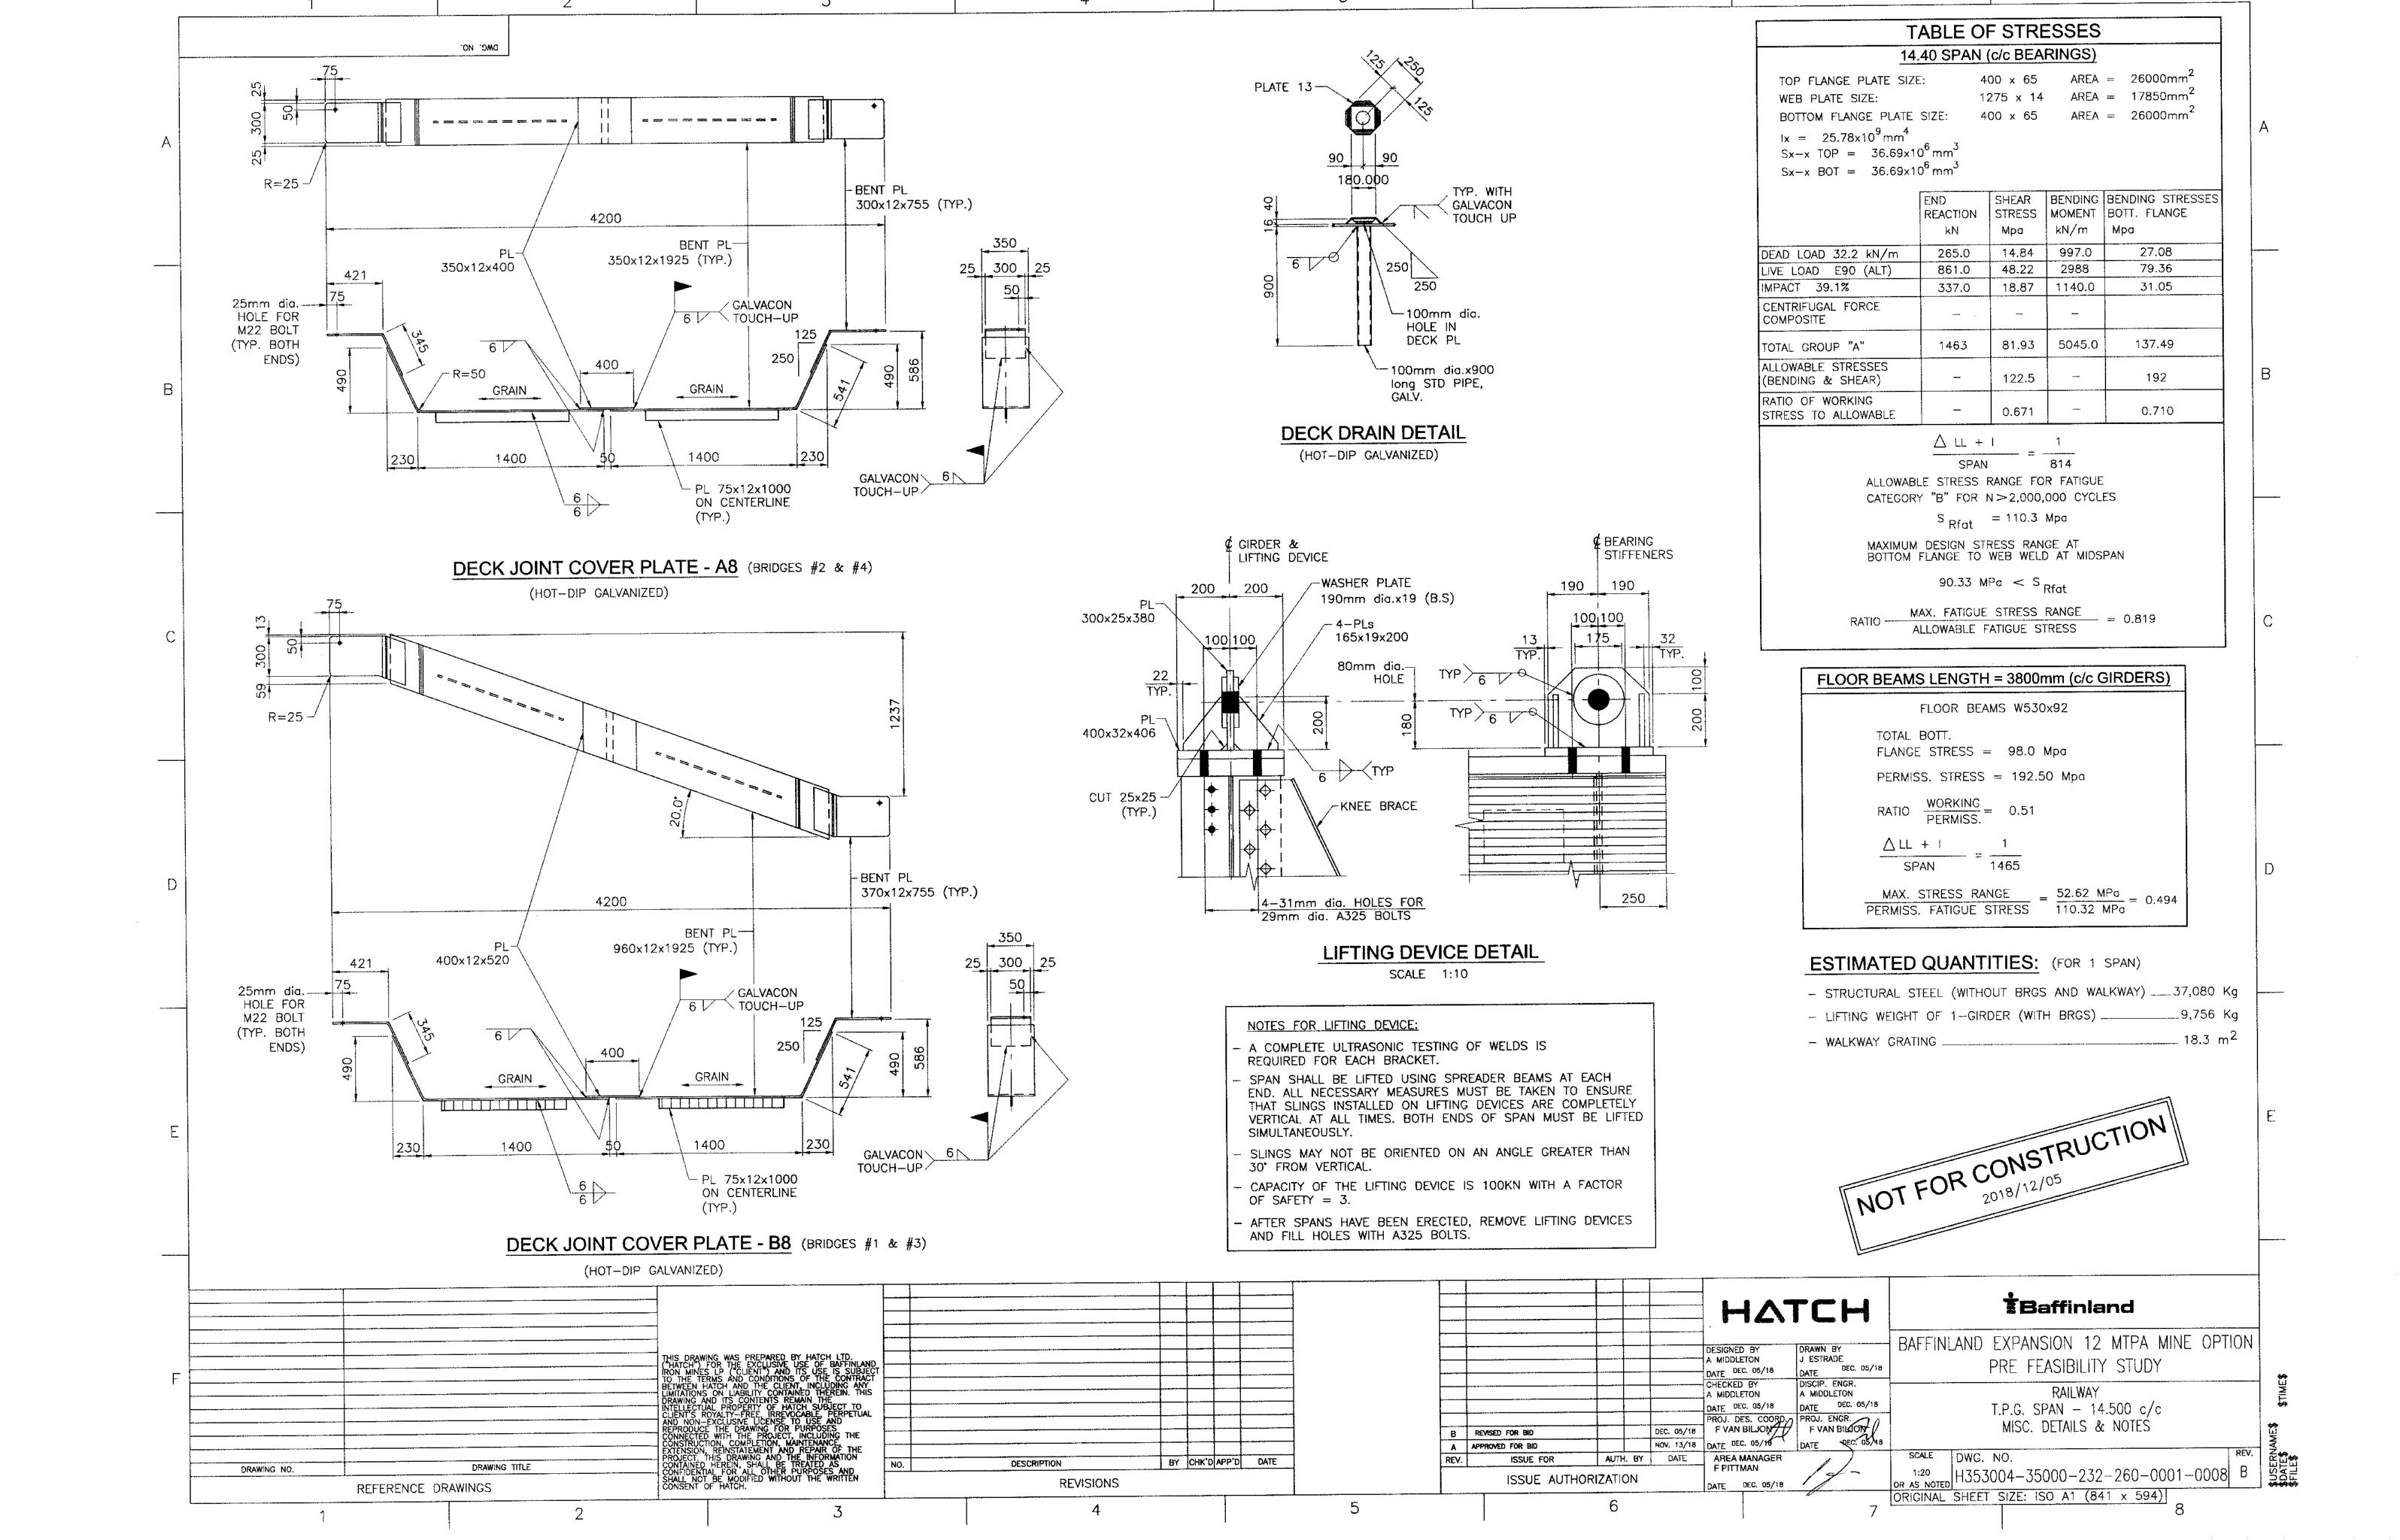

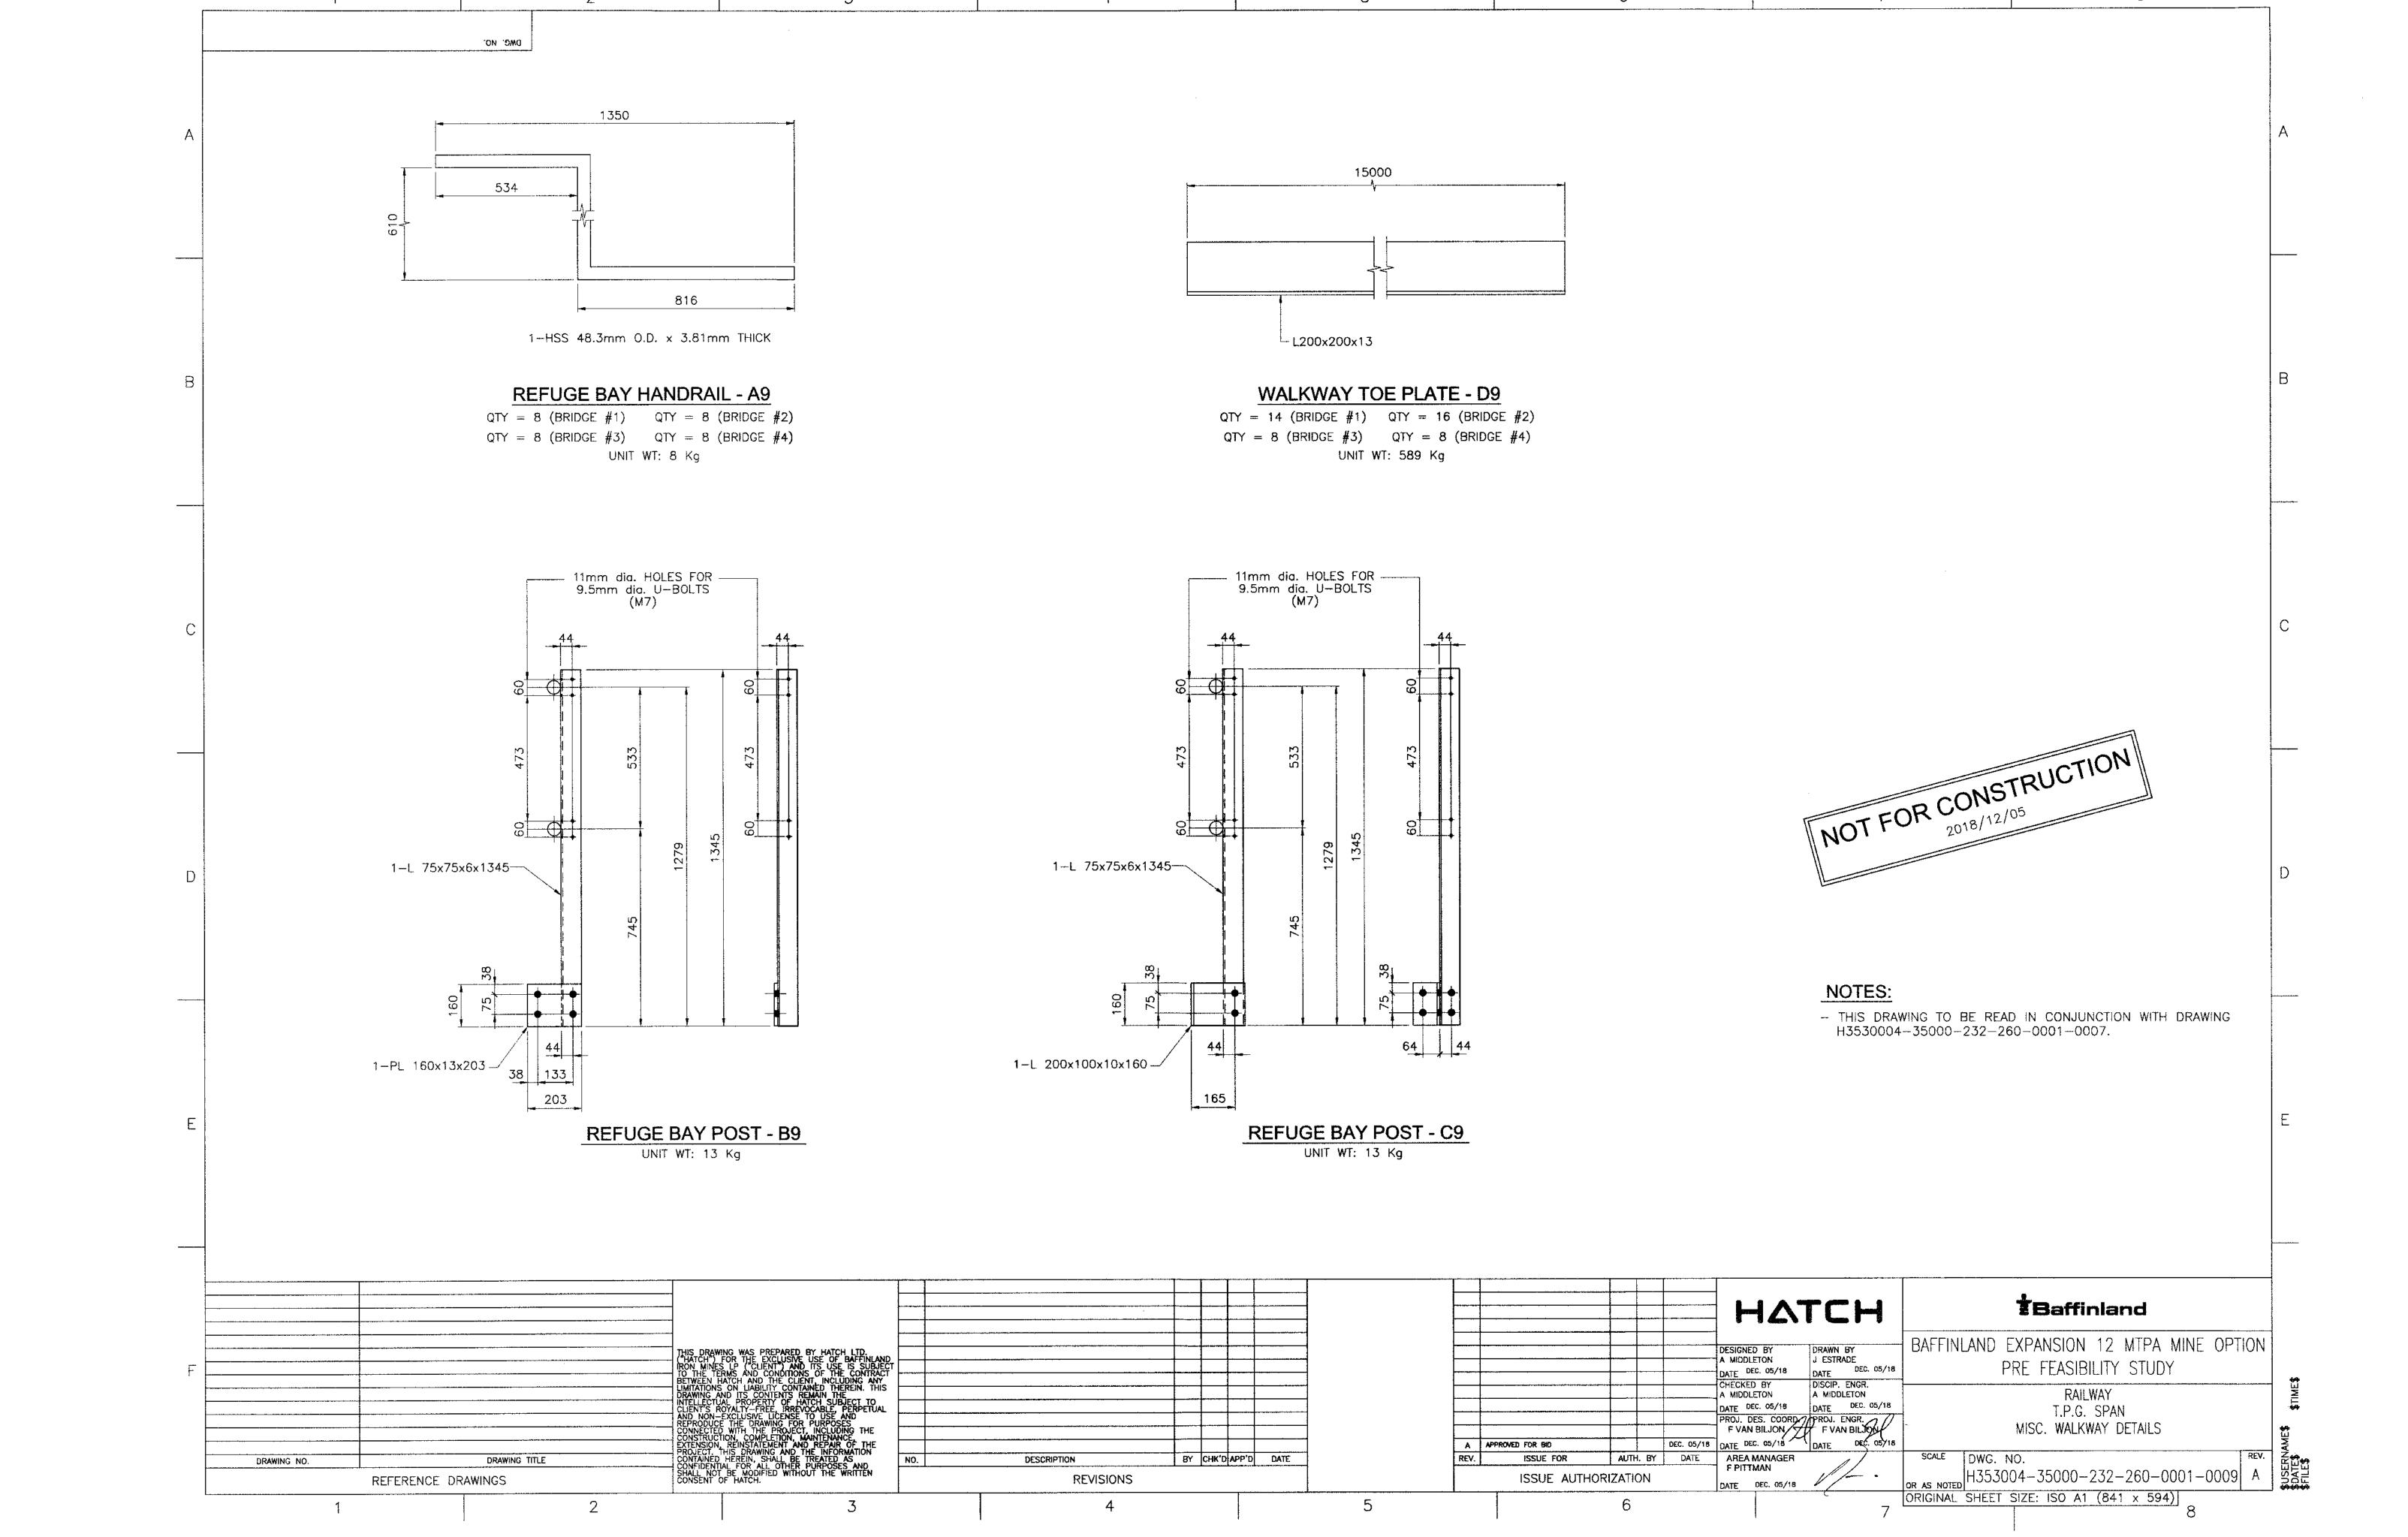

| | STEEL | | | |
|--|-----------------|----------|------|--|
| ITEM | MARK | UNIT | QTY. | DRAWING No. H353004-35000-232- |
| 14.500m c/c BEARINGS T.P.G. SPAN (SKEWED ENDS) | STSD2 | 1 | 7 | 260-0001-0004 |
| | | <u> </u> | | |
| EXPANSION BEARING | A6 | 1 | 7 | 260-0001-0006 |
| EXPANSION BEARING | B6 | 1 | 7 | 260-0001-0006 |
| FIXED BEARING | C6 | 1 | 7 | 260-0001-0006 |
| FIXED BEARING | D6 | 1 | 7 | 260-0001-0006 |
| ANCHOR BOLTS | E6 | 1 | 112 | 260-0001-0006 |
| NEOPRENE PAD | F6 | 1 | 28 | 260-0001-0006 |
| DECK JOINT COVER PLATE (SKEWED) | 88 | 1 | 8 | 260-0001-0008 |
| CO | NCRETE | | | |
| ABUTMENT - PRECAST CONCRETE (SKEWED) | APC2 | 1 | 2 | 260-0002-0005 |
| 2 ROW PILE CAP - PRECAST CONCRETE (SKEWED) | 2RPC2 | 1 | 4 | 260-0002-0003 |
| 3 ROW PILE CAP — PRECAST CONCRETE (SKEWED) | 3RPC2 | 1 | 2 | 260-0002-0004 |
| | | | | |
| W | ALKWAY | <u> </u> | | |
| WALKWAY SUPPORT | A7 | 1 | 164 | 260-0002-0007 |
| HANDRAIL POST | B7 | 1 | 164 | 260-0002-0007 |
| REFUGE BAY POST | B9 | 1 | 4 | 260-0002-0009 |
| REFUGE BAY POST | С9 | 1 | 4 | 260-0002-0009 |
| BACKWALL HANDRAIL | C7 ^R | 1 | 2 | 260-0002-0007 |
| BACKWALL HANDRAIL | C7 ^L | 1 | 2 | 260-0002-0007 |
| FREE RAIL - 4150mm LONG | D7 | 1 | 48 | 260-0002-0007 |
| FREE RAIL - 2775mm LONG | S7 | 1 | 8 | 260-0002-0007 |
| REFUGE BAY HANDRAIL | A9 | 1 | 8 | 260-0002-0009 |
| HANDRAIL LOOP - 3340mm LONG | E7 | 1 | 28 | 26000020007 |
| GRATING PANEL 613 x 5000mm | F7 | 1 | 38 | 260-0002-0007 |
| GRATING PANEL 613 x 1650mm (REFUGE) | G7 | 1 | 2 | 260-0002-0007 |
| GRATING PANEL 613 x 5530mm (SKEWED) | H7 | 1 | 2 | 260-0002-0007 |
| GRATING PANEL 613 x 5000mm (SKEWED) | K7 | 1 | 2 | 260-0002-0007 |
| HANDRAIL SPLICE | RS1 | 1 | 88 | 260-0002-0007 |
| 9.5mm dia. U-BOLT (C/W 4 HEX NUTS & 2 FLAT WASHERS) | M7 | 1 | 360 | 260-0002-0007 |
| FIBRE-OPTIC BRACKET (C/W 12mm dia.x50mm LG. BOLT W/NUT & WASHER) | N7 | 1 | 168 | 260-0002-0007 |
| REFUGE SUPPORT | P7 | 1 | 4 | 260-0002-0007 |
| TYPE 'H-3' SADDLE CLIP C/W M20x70 HEX BOLT & HEX NUT | | 1 | 896 | |
| WALKWAY TOE PLATE L 200×200×13×15000 | D9 | 1 | 14 | 260-0002-0009 |



Baffinland HATCH BAFFINLAND EXPANSION 12 MTPA MINE OPTION DESIGNED BY
A MIDDLETON
DATE DEC. 05/18

CHECKED BY
A MIDDLETON
DATE DEC. 05/18

DATE DEC. 05/18

DATE DEC. 05/18

DATE DEC. 05/18

PROJ. DES. COORD
F VAN BILJON
F VAN BILJON
F VAN BILJON
DATE DEC. 05/18

DATE DEC. 05/18

PROJ. DES. COORD
F VAN BILJON
F VAN BILJON
DATE DEC. 05/18

AUTH. BY
DATE

AREA MANAGER
F PITTMAN

RIZATION PRE FEASIBILITY STUDY RAILWAY BR #15.95 BILL OF MATERIAL BY CHK'D APP'D DATE A APPROVED FOR BID SCALE DWG. NO.

OR AS NOTED H353004-35000-232-260-0002-0008 B

ORIGINAL SHEET SIZE: ISO A1 (841 x 594)]

8 ISSUE FOR DESCRIPTION DRAWING TITLE DRAWING NO. ISSUE AUTHORIZATION REFERENCE DRAWINGS REVISIONS DATE DEC. 05/18/

)

| BILL OF MATERIA | ALS - BR | #70.6 9 | 9 | |
|--|-----------------|---------------------------------------|------|-----------------------------------|
| | STEEL | · · · · · · · · · · · · · · · · · · · | | |
| ITEM | MARK | UNIT | QTY. | DRAWING No. H353004-35000-232- |
| 14.500m c/c BEARINGS T.P.G. SPAN (SQUARED ENDS) | STSD1 | 1 | 8 | 260-0001-0001 |
| | | | | |
| EXPANSION BEARING | A3 | 1 | 8 | 260-0001-0003 |
| EXPANSION BEARING | B3 | 1 | 8 | 260-0001-0003 |
| FIXED BEARING | С3 | 1 | 8 | 260-0001-0003 |
| FIXED BEARING | D3 | 1 | 8 | 260-0001-0003 |
| ANCHOR BOLTS | E3 | 1 | 128 | 260-0001-0003 |
| NEOPRENE PAD | F3 | 1 | 32 | 260-0001-0003 |
| DECK JOINT COVER PLATE (SQUARED) | A8 | 1 | 9 | 260-0001-0008 |
| | NCRETE | | | |
| ABUTMENT - PRECAST CONCRETE (SQUARED) | APC2 | 1 | 2 | 260-0003-0005 |
| 2 ROW PILE CAP - PRECAST CONCRETE (SQUARED) | 2RPC2 | 1 | 5 | 260-0003-0003 |
| 3 ROW PILE CAP - PRECAST CONCRETE (SQUARED) | 3RPC2 | 1 | 2 | 260-0003-0004 |
| | ALKWAY | | | |
| WALKWAY SUPPORT | A7 | 1 | 188 | 260-0002-0007 |
| HANDRAIL POST | B7 | 1 | 188 | 260-0002-0007 |
| REFUGE BAY POST | B9 | 1 | 4 | 260-0002-0009 |
| REFUGE BAY POST | C9 | 1 | 4 | 260-0002-0009 |
| BACKWALL HANDRAIL | C7 ^R | 1 | 2 | 260-0002-0007 |
| BACKWALL HANDRAIL | C7 ^L | 1 | 2 | 260-0002-0007 |
| REFUGE BAY HANDRAIL | A9 | 1 | 8 | 260-0002-0009 |
| FREE RAIL - 4150mm LONG | D7 | 1 | 56 | 260-0002-0007 |
| FREE RAIL - 2775mm LONG | S7 | 1 | 8 | 260-0002-0007 |
| HANDRAIL LOOP - 3340mm LONG | E.7 | 1 | 32 | 260-0002-0007 |
| GRATING PANEL 613 x 5000mm | F7 | 1 | 48 | 260-0002-0007 |
| GRATING PANEL 613 x 1650mm (REFUGE) | G7 | 1 | 2 | 260-0002-0007 |
| HANDRAIL SPLICE | RS1 | 1 | 100 | 260-0002-0007 |
| 9.5mm dia. U-BOLT (C/W 4 HEX NUTS & 2 FLAT WASHERS) | M7 | 1 | 408 | 260-0002-0007 |
| FIBRE-OPTIC BRACKET (C/W 12mm dia.x50mm LG. BOLT W/NUT & WASHER) | N7 | quee | 192 | 260-0002-0007 |
| REFUGE SUPPORT | P7 | 1 | 4 | 260-0002-0007 |
| TYPE 'H-3' SADDLE CLIP C/W M20x70 HEX BOLT & HEX NUT | | 1 | 1024 | |
| WALKWAY TOE PLATE L 200x200x13x15000 | D9 | 1 | 16 | 260-0002-0009 |



İBaffinland HATCH BAFFINLAND EXPANSION 12 MTPA MINE OPTION DESIGNED BY
A MIDDLETON
DATE DEC. 05/18

CHECKED BY
A MIDDLETON
DATE DEC. 05/18

PROJ. DES. COORD.
PROJ. ENGR.
A MIDDLETON
DATE DEC. 05/18

PROJ. DES. COORD.
F VAN BILJON
F VAN BILJON
F VAN BILJON
AUTH. BY
DATE

AREA MANAGER
F PITTMAN

PROJ. DEC. 05/18 PRE FEASIBILITY STUDY RAILWAY BR #70.69 BILL OF MATERIAL REVISED FOR BID A APPROVED FOR 9(D SCALE DWG. NO.

OR AS NOTED H353004-35000-232-260-0003-0008 B

ORIGINAL SHEET SIZE: ISO A1 (841 x 594)

8 BY CHK'D APP'D DATE ISSUE FOR DRAWING TITLE DESCRIPTION DRAWING NO. ISSUE AUTHORIZATION REFERENCE DRAWINGS REVISIONS DATE DEC. 05/18 5 6 2

| BILL OF MATERIA | LS - BR # | / 85.94 | 8 | |
|--|-----------------|--------------------|------|-----------------------------------|
| <u></u> | TEEL | | | |
| ITEM | MARK | UNIT | QTY. | DRAWING No. H353004-35000-232- |
| 14.500m c/c BEARINGS T.P.G. SPAN (SKEWED ENDS) | STSD2 | 1 | 4 | 260-0001-0004 |
| | | | | |
| EXPANSION BEARING | A6 | 1 | 4 | 260-0001-0006 |
| EXPANSION BEARING | B6 | 1 | 4 | 260-0001-0006 |
| FIXED BEARING | C6 | 1 | 4 | 260-0001-0006 |
| FIXED BEARING | D6 | 1 | 4 | 260-0001-0006 |
| ANCHOR BOLTS | E6 | 1 | 64 | 260-0001-0006 |
| NEOPRENE PAD | F6 | 1 | 16 | 260-0001-0006 |
| DECK JOINT COVER PLATE (SKEWED) | B8 | 1 | 5 | 260-0001-0008 |
| COI | NCRETE | | | |
| ABUTMENT - PRECAST CONCRETE (SKEWED) | APC2 | 1 1 | 2 | 260-0004-0005 |
| 2 ROW PILE CAP - PRECAST CONCRETE (SKEWED) | 2RPC2 | 1 | 3 | 260-0004-0003 |
| 2 ROW FILE CAF - FILECAST CONCRETE (SREWED) | 21(1 02 | * | | 200 0001 0000 |
| | | | | |
| <u>WA</u> | LKWAY | | | |
| WALKWAY SUPPORT | A7 | 1 | 92 | 260-0002-0007 |
| HANDRAIL POST | 87 | 1 | 92 | 260-0002-0007 |
| REFUGE BAY POST | B9 | 1 | 4 | 260-0002-0009 |
| REFUGE BAY POST | C9 | 1 | 4 | 260-0002-0009 |
| BACKWALL HANDRAIL | C7 ^R | 1 | 2 | 260-0002-0007 |
| BACKWALL HANDRAIL | C7 ^L | 1 | 2 | 260-0002-0007 |
| REFUGE BAY HANDRAIL | A9 | 1 | 8 | 260-0002-0009 |
| FREE RAIL - 4150mm LONG | D7 | 1 | 24 | 260-0002-0007 |
| FREE RAIL - 2775mm LONG | S7 | 1 | 8 | 260-0002-0007 |
| HANDRAIL LOOP - 3340mm LONG | E7 | 1 | 16 | 260-0002-0007 |
| GRATING PANEL 613 x 5000mm | F7 | 1 | 20 | 260-0002-0007 |
| GRATING PANEL 613 x 1650mm (REFUGE) | G7 | 1 | 2 | 260-0002-0007 |
| GRATING PANEL 613 x 5530mm (SKEWED) | H7 | 1 | 2 | 260-0002-0007 |
| GRATING PANEL 613 x 5000mm (SKEWED) | K7 | 1 | 2 | 260-0002-0007 |
| HANDRAIL SPLICE | RS1 | 1 | 52 | 260-0002-0007 |
| 9.5mm dia. U-BOLT (C/W 4 HEX NUTS & 2 FLAT WASHERS) | M7 | 1 | 216 | 260-0002-0007 |
| FIBRE-OPTIC BRACKET (C/W 12mm dia.x50mm LG. BOLT W/NUT & WASHER) | N7 | 1 | 96 | 260-0002-0007 |
| REFUGE SUPPORT | P7 | 1 | 4 | 260-0002-0007 |
| TYPE 'H-3' SADDLE CLIP C/W M20x70 HEX BOLT & HEX NUT | | 1 | 512 | |
| WALKWAY TOE PLATE L 200×200×13×15000 | D9 | 1 | 8 | 260-0002-0009 |



| | | | | | | | | | | HATC | Н | Baffinland |
|-------------|---------------|---|-------------|---------------|--------|---|-------------|-----------------------------------|--------------------------|--|--------------------------|--|
| | | THIS DRAWING WAS PREPARED BY HATCH LTD. ("HATCH") FOR THE EXCLUSIVE USE OF BAFFINLAND IRON MINES BY CONTRACT TO THE TERMS AND CONDITIONS OF THE CONTRACT | | | | | : | | | DESIGNED BY DRAWN BY A MIDDLETON J ESTRADE DATE DEC. 05/18 DATE | B/ E DEC. 05/18 | AFFINLAND EXPANSION 12 MTPA MINE OPTION PRE FEASIBILITY STUDY |
| | | BETWEEN HATCH AND THE CLIENT, INCLUDING ANY LIMITATIONS ON LIABILITY CONTAINED THEREIN. THIS DRAWING AND ITS CONTENTS REMAIN THE INTELLECTUAL PROPERTY OF HATCH SUBJECT TO CLIENT'S ROYALTY—FREE, IRREVIOLABLE, PERPETUAL | | | | | | | | CHECKED BY DISCIP. EN A MIDDLETON A MIDDLET DATE DEC. 05/18 DATE D | IGR. ON DEC. 05/18 | RAILWAY BR #85.948 |
| | | REPRODUCE THE DRAWING FOR PURPOSES CONNECTED WITH THE PROJECT, INCLUDING THE CONSTRUCTION, COMPLETION, MAINTENANCE, EXTENSION, REINSTATEMENT AND REPAIR OF THE | | | | | | REVISED FOR BID APPROVED FOR BID | DEC. 05/18 NOV. 13/18 | ⊢ | DEC. 05/18 | BILL OF MATERIAL |
| DRAWING NO. | DRAWING TITLE | PROJECT. THIS DRAWING AND THE INFORMATION CONTAINED HEREIN, SHALL BE TREATED AS NO. | DESCRIPTION | BY CHK'D APP' | D DATE | | REV. | <u> </u> | AUTH, BY DATE | AREA MANAGER F PITTMAN | | SCALE DWG. NO. |
| REFEREN | CE DRAWINGS | SHALL NOT BE MODIFIED WITHOUT THE WRITTEN CONSENT OF HATCH. | REVISIONS | | | | | ISSUE AUTHORIZ | ZATION | DATE DEC. 05/18 | . OR A | AS NOTED H353004-35000-232-260-0004-0008 |
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|--|---------------------------------------|----------|------|--|
| | STEEL | | | |
| ITEM | MARK | UNIT | QTY. | DRAWING No. H353004-35000-232- |
| 14.500m c/c BEARINGS T.P.G. SPAN (SQUARED ENDS) | STSD1 | 1 | 4 | 260-0001-0001 |
| | | | | |
| EXPANSION BEARING | A3 | 1 | 4 | 260-0001-0003 |
| EXPANSION BEARING | B3 | 1 | 4 | 260-0001-0003 |
| FIXED BEARING | C3 | 1 | 4 | 260-0001-0003 |
| FIXED BEARING | D3 | 1 | 4 | 260-0001-0003 |
| ANCHOR BOLTS | E3 | 1 | 64 | 260-0001-0003 |
| NEOPRENE PAD | F3 | 1 | 16 | 260-0001-0003 |
| DECK JOINT COVER PLATE (SQUARED) | A8 | 1 | 5 | 260-0001-0008 |
| CO | NCRETE | <u> </u> | | |
| ABUTMENT - PRECAST CONCRETE (SQUARED) | APC2 | 1 | 2 | 260-0005-0005 |
| 2 ROW PILE CAP - PRECAST CONCRETE (SQUARED) | 2RPC2 | 1 | 3 | 260-0005-0003 |
| 2 NOW FIEL ON THEORET CONCINET (COCONICE) | | , ' | | |
| W | ALKWAY | | | |
| WALKWAY SUPPORT | A7 | 1 | 92 | 260-0002-0007 |
| HANDRAIL POST | B7 | 1 | 92 | 260-0002-0007 |
| REFUGE BAY POST | B9 | 1 | 4 | 260-0002-0009 |
| REFUGE BAY POST | C9 | 1 | 4 | 260-0002-0009 |
| BACKWALL HANDRAIL | C7 ^R | 1 | 2 | 260-0002-0007 |
| BACKWALL HANDRAIL | C7 ^L | 1 | 2 | 260-0002-0007 |
| REFUGE BAY HANDRAIL | A9 | 1 | 8 | 260-0002-0009 |
| FREE RAIL — 4150mm LONG | D7 | 1 | 24 | 260-0002-0007 |
| FREE RAIL — 2775mm LONG | S7 | 1 | 8 | 260-0002-0007 |
| HANDRAIL LOOP - 3340mm LONG | E7 | 1 | 16 | 260-0002-0007 |
| GRATING PANEL 613 × 5000mm | F7 | 1 | 24 | 260-0002-0007 |
| GRATING PANEL 613 x 1650mm (REFUGE) | G7 | 1 | 2 | 260-0002-0007 |
| | | | | |
| HANDRAIL SPLICE | RS1 | 1 | 52 | 260-0002-0007 |
| 9.5mm dia. U-BOLT (C/W 4 HEX NUTS & 2 FLAT WASHERS) | M7 | 1 | 216 | 260-0002-0007 |
| FIBRE-OPTIC BRACKET (C/W 12mm dia.x50mm LG. BOLT W/NUT & WASHER) | N7 | 1 | 96 | 260-0002-0007 |
| REFUGE SUPPORT | P7 | 1 | 4 | 260-00020007 |
| TYPE 'H-3' SADDLE CLIP C/W M20x70 HEX BOLT & HEX NUT | | 1 | 512 | |
| WALKWAY TOE PLATE L 200×200×13×15000 | D9 | 1 | 8 | 260-0002-0009 |



Beffinland HATCH BAFFINLAND EXPANSION 12 MTPA MINE OPTION DESIGNED BY
A MIDDLETON
DATE DEC. 05/18

CHECKED BY
A MIDDLETON
DATE DEC. 05/18

PROJ. DES. COORD
F VAN BILJON
F VAN BILJON
DATE DEC. 05/18

DATE DEC. 05/18

DATE DEC. 05/18

DATE DEC. 05/18

AUTH. BY
DATE

AREA MANAGER
F PITTMAN PRE FEASIBILITY STUDY RAILWAY BR #102.217 BILL OF MATERIAL B REVISED FOR BID A APPROVED FOR BID
REV. ISSUE FOR SCALE DWG. NO.

OR AS NOTED H353004-35000-232-260-0005-0008 B


ORIGINAL SHEET SIZE: ISO A1 (841 x 594)


8 BY CHK'D APP'D DATE DRAWING TITLE DESCRIPTION DRAWING NO. ISSUE AUTHORIZATION REVISIONS REFERENCE DRAWINGS DATE DEC. 05/18 /

E

TOTE ROAD – LAYOUT AND LONG




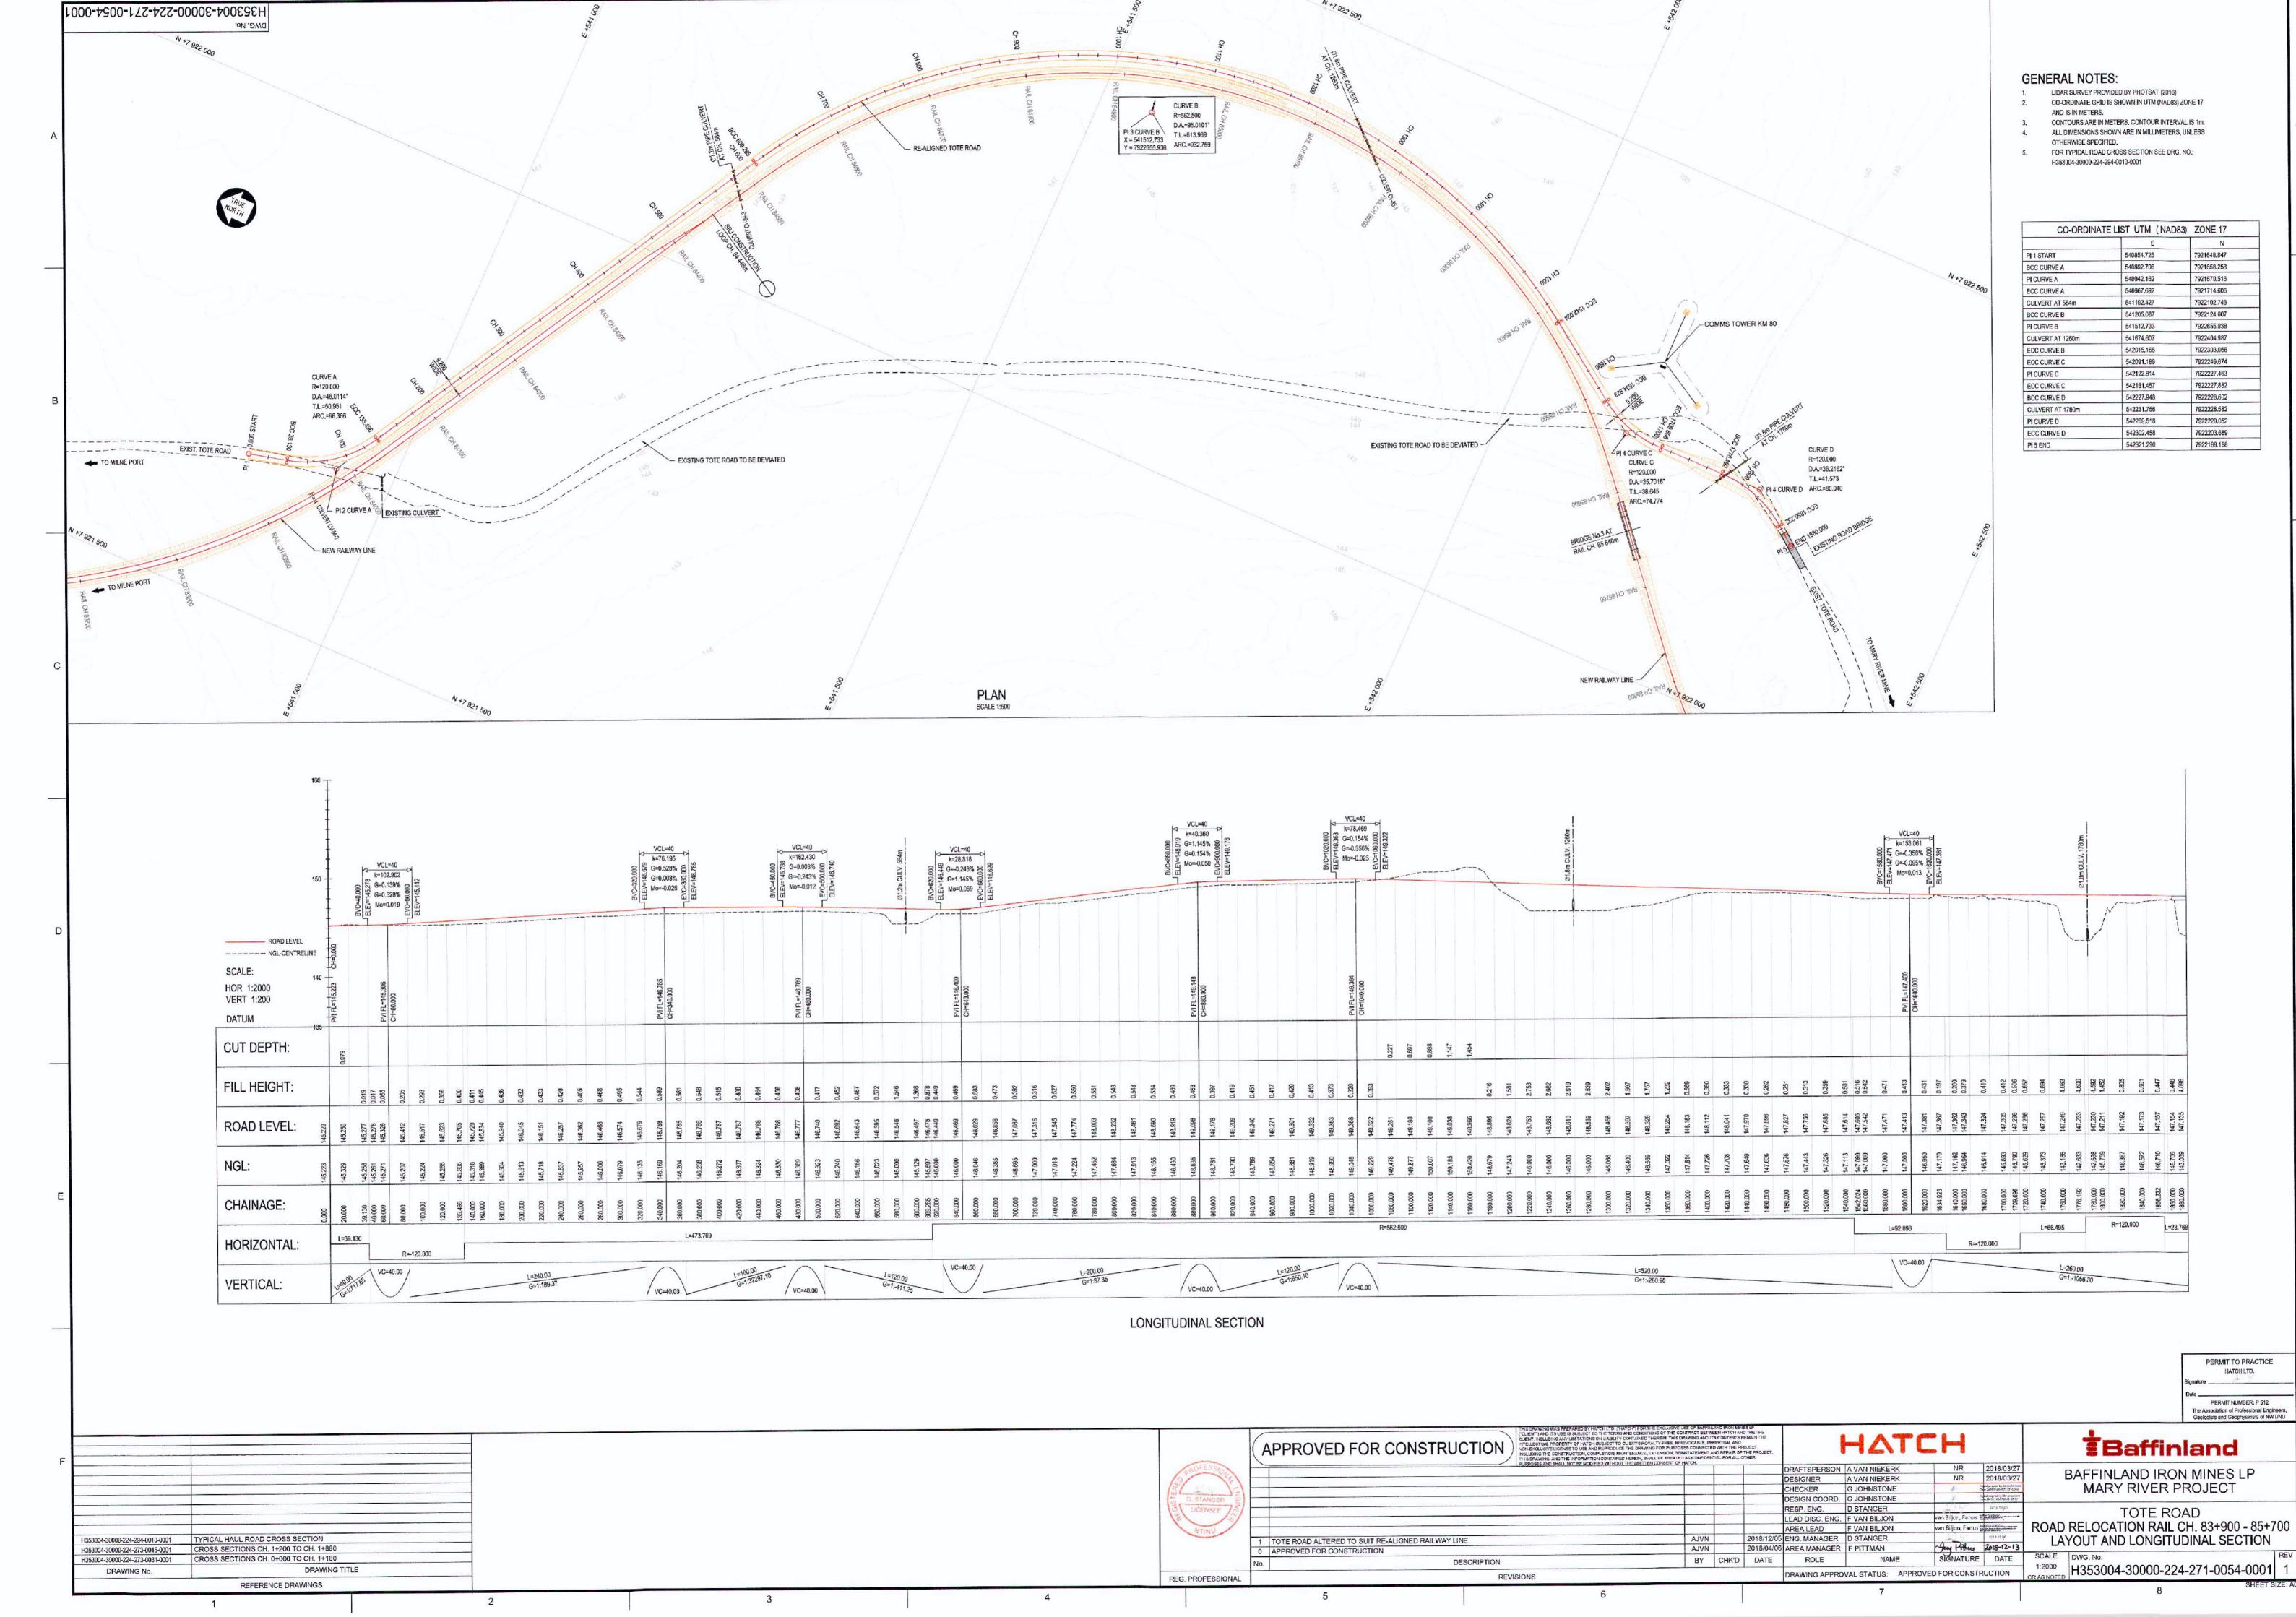


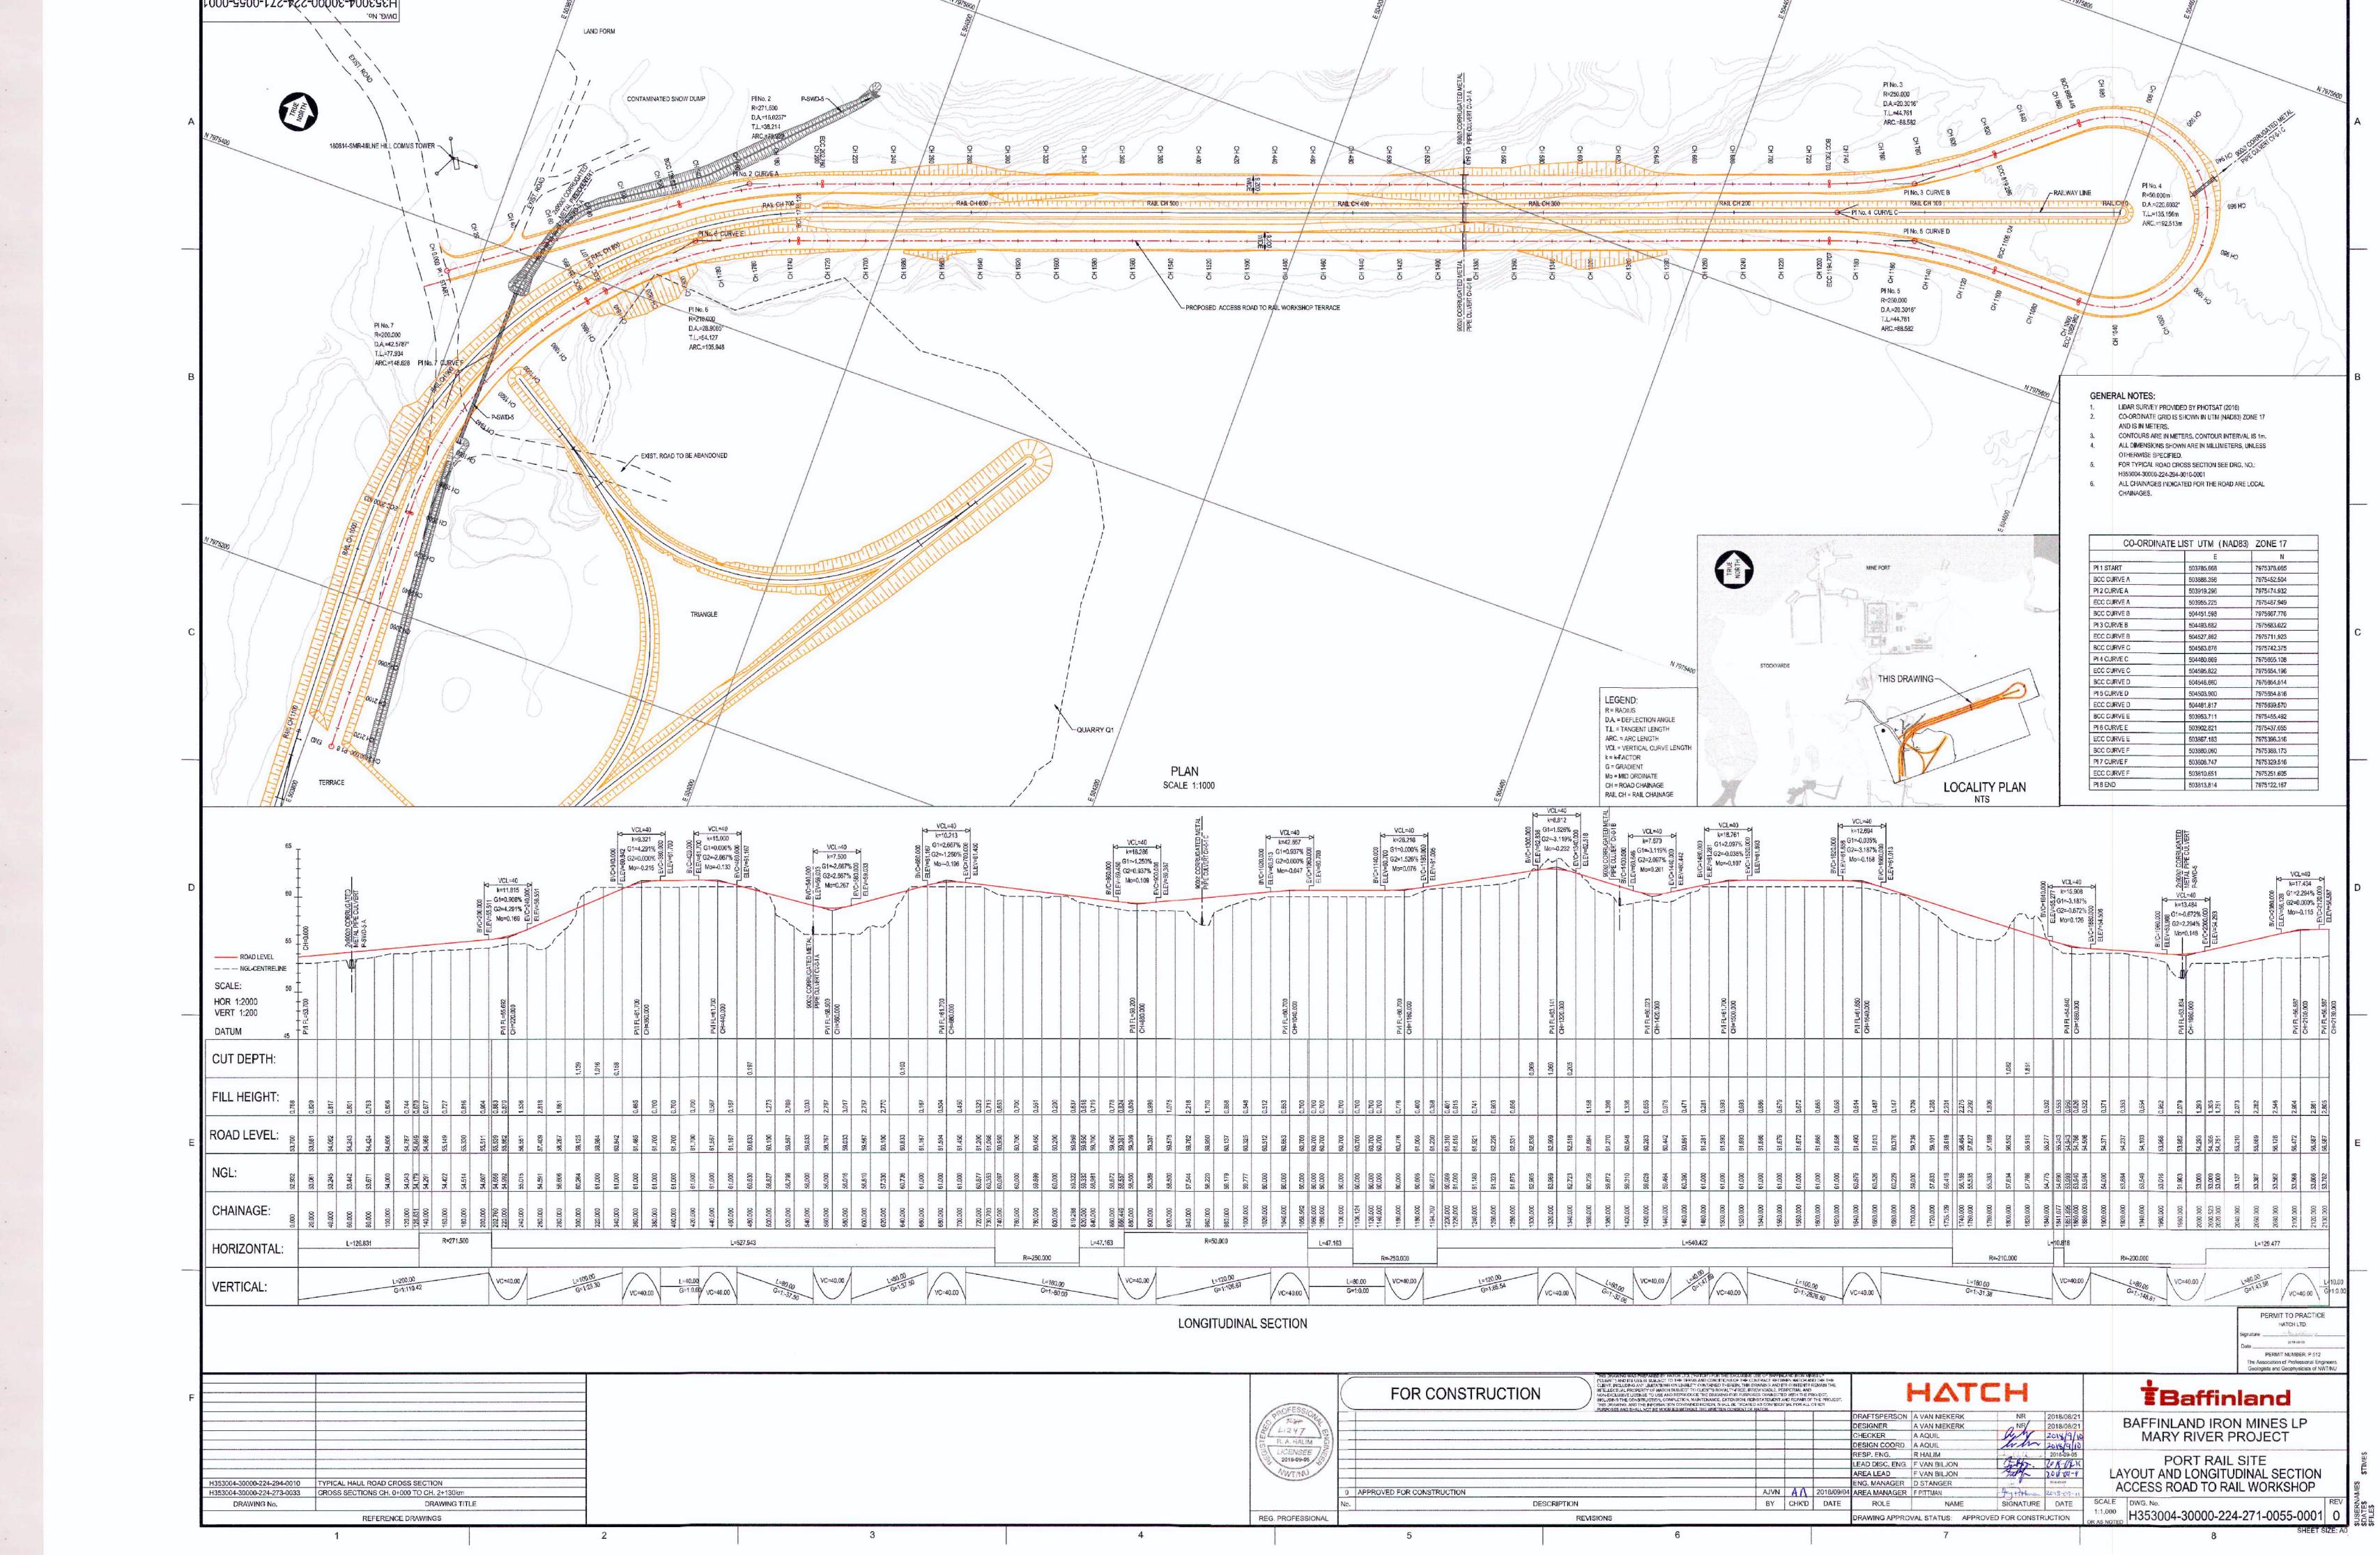



TYPICAL CROSS SECTIONS




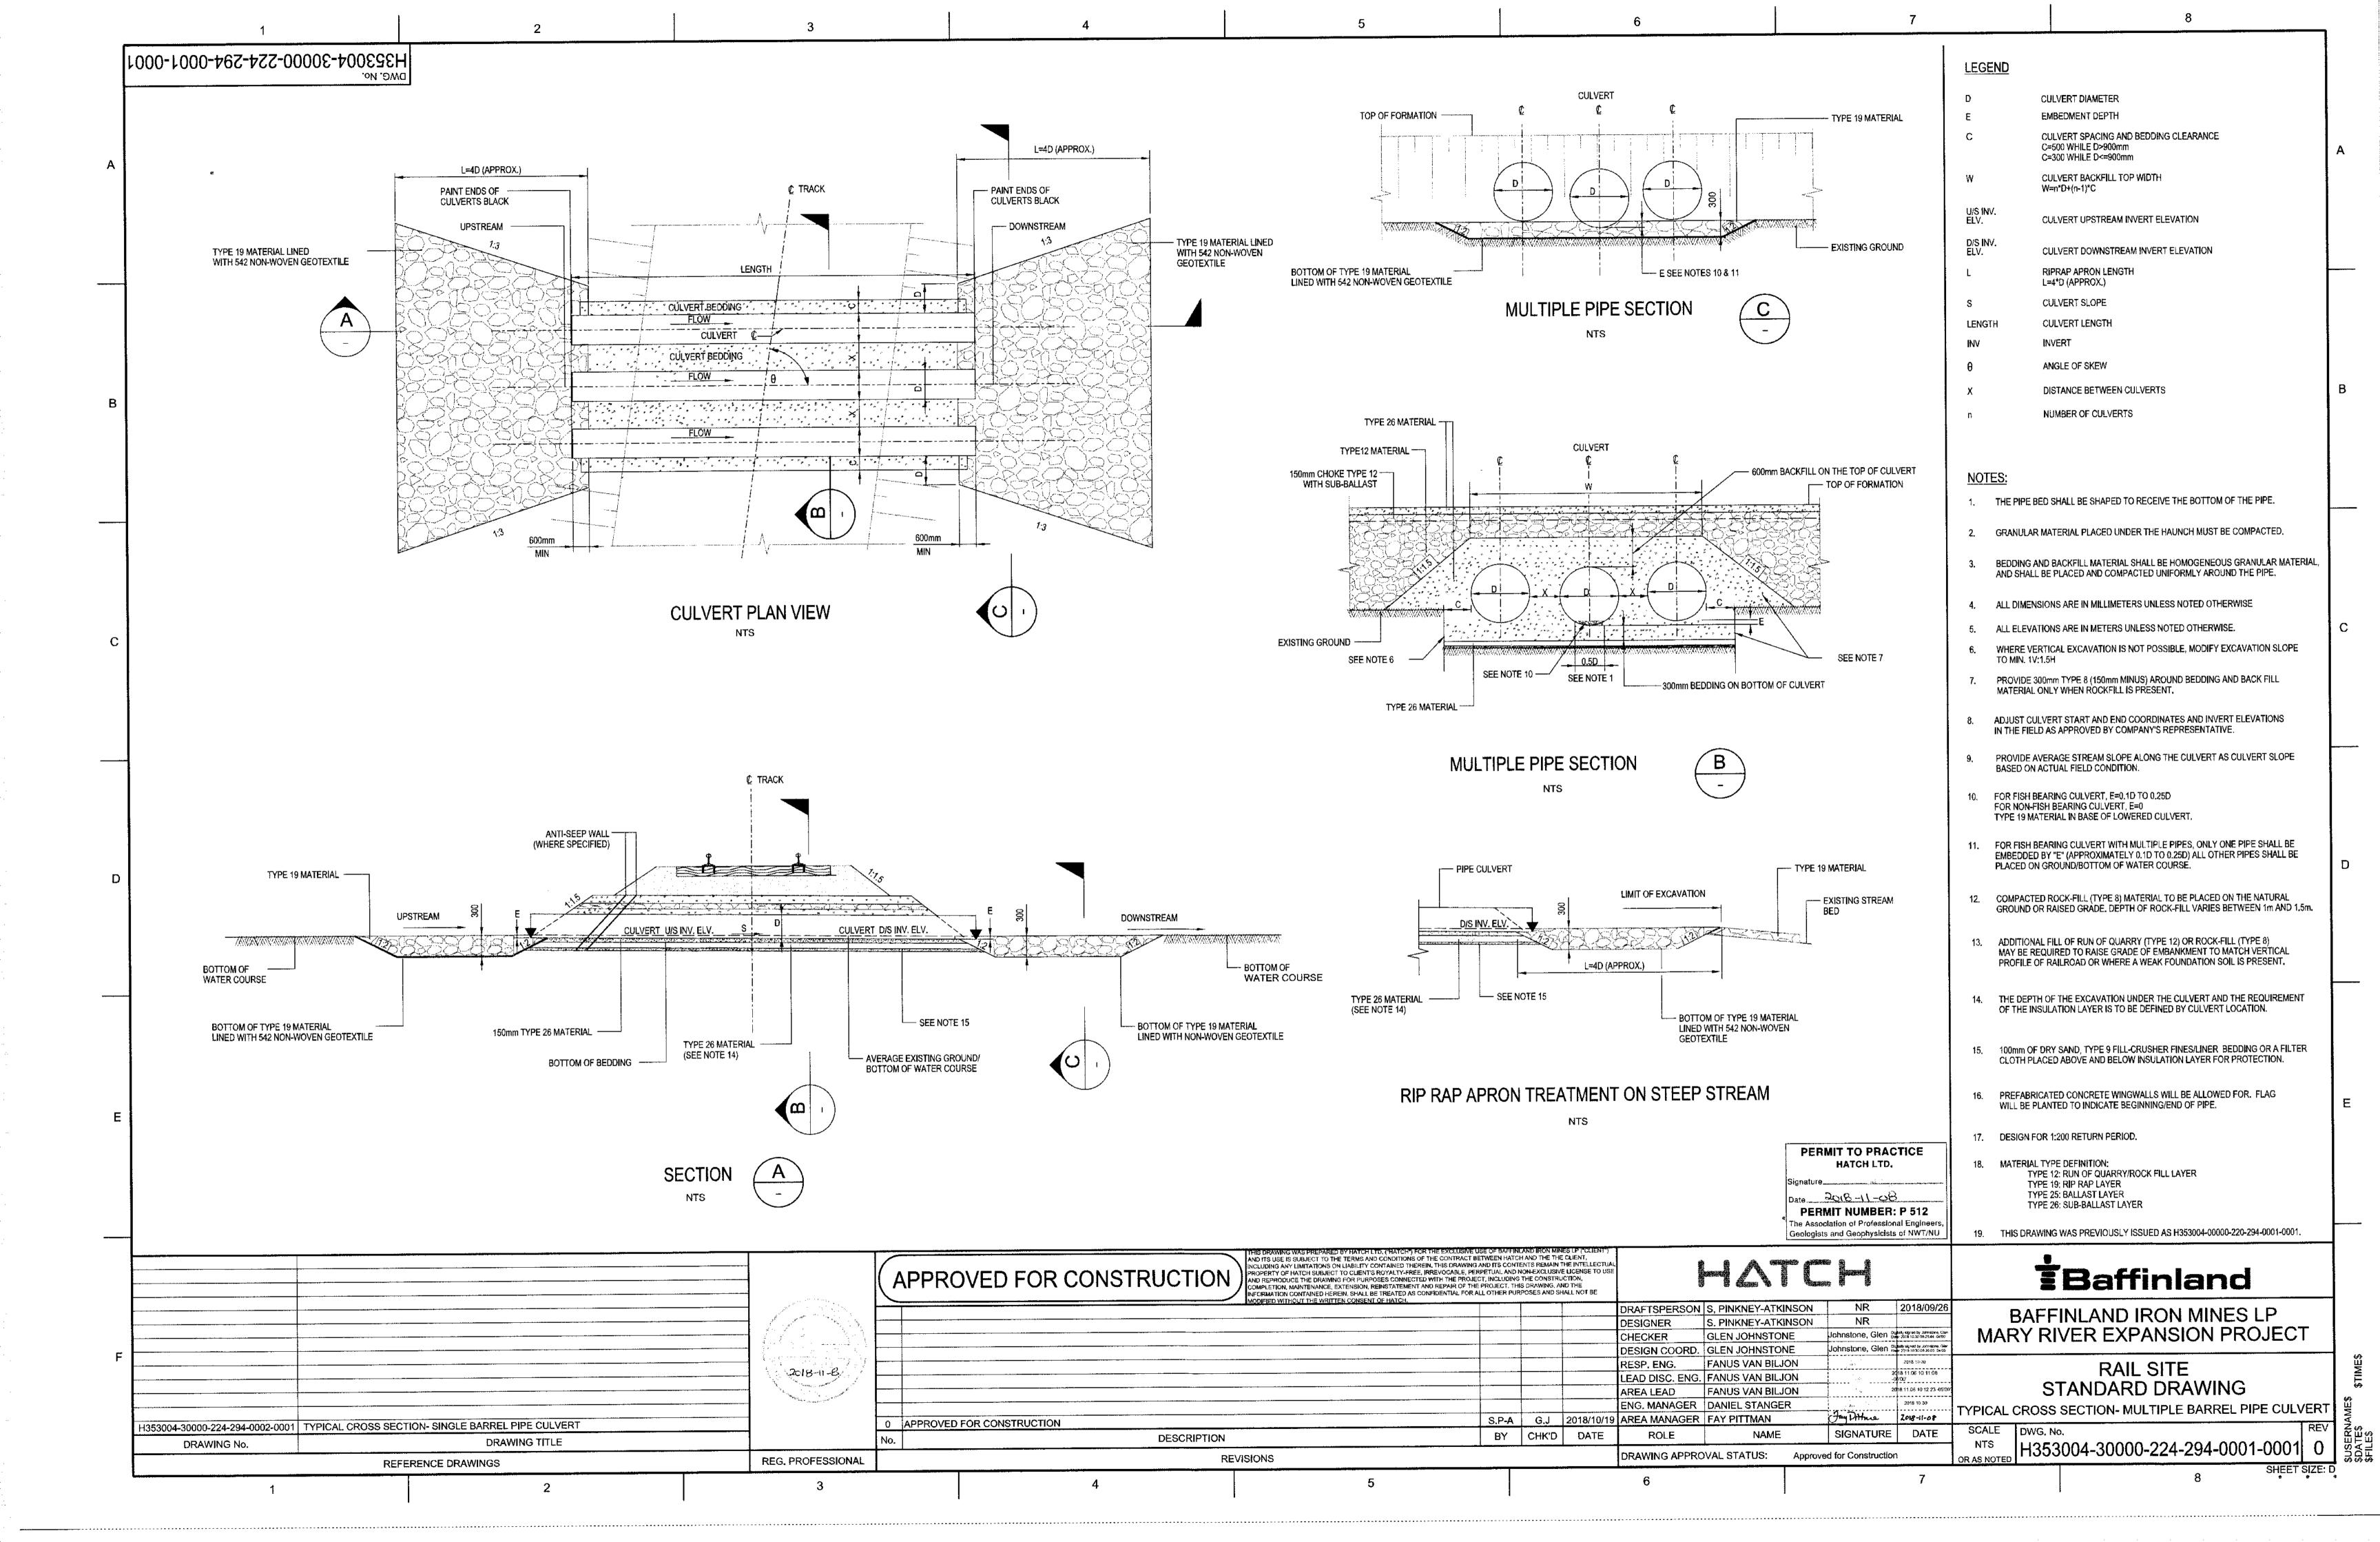


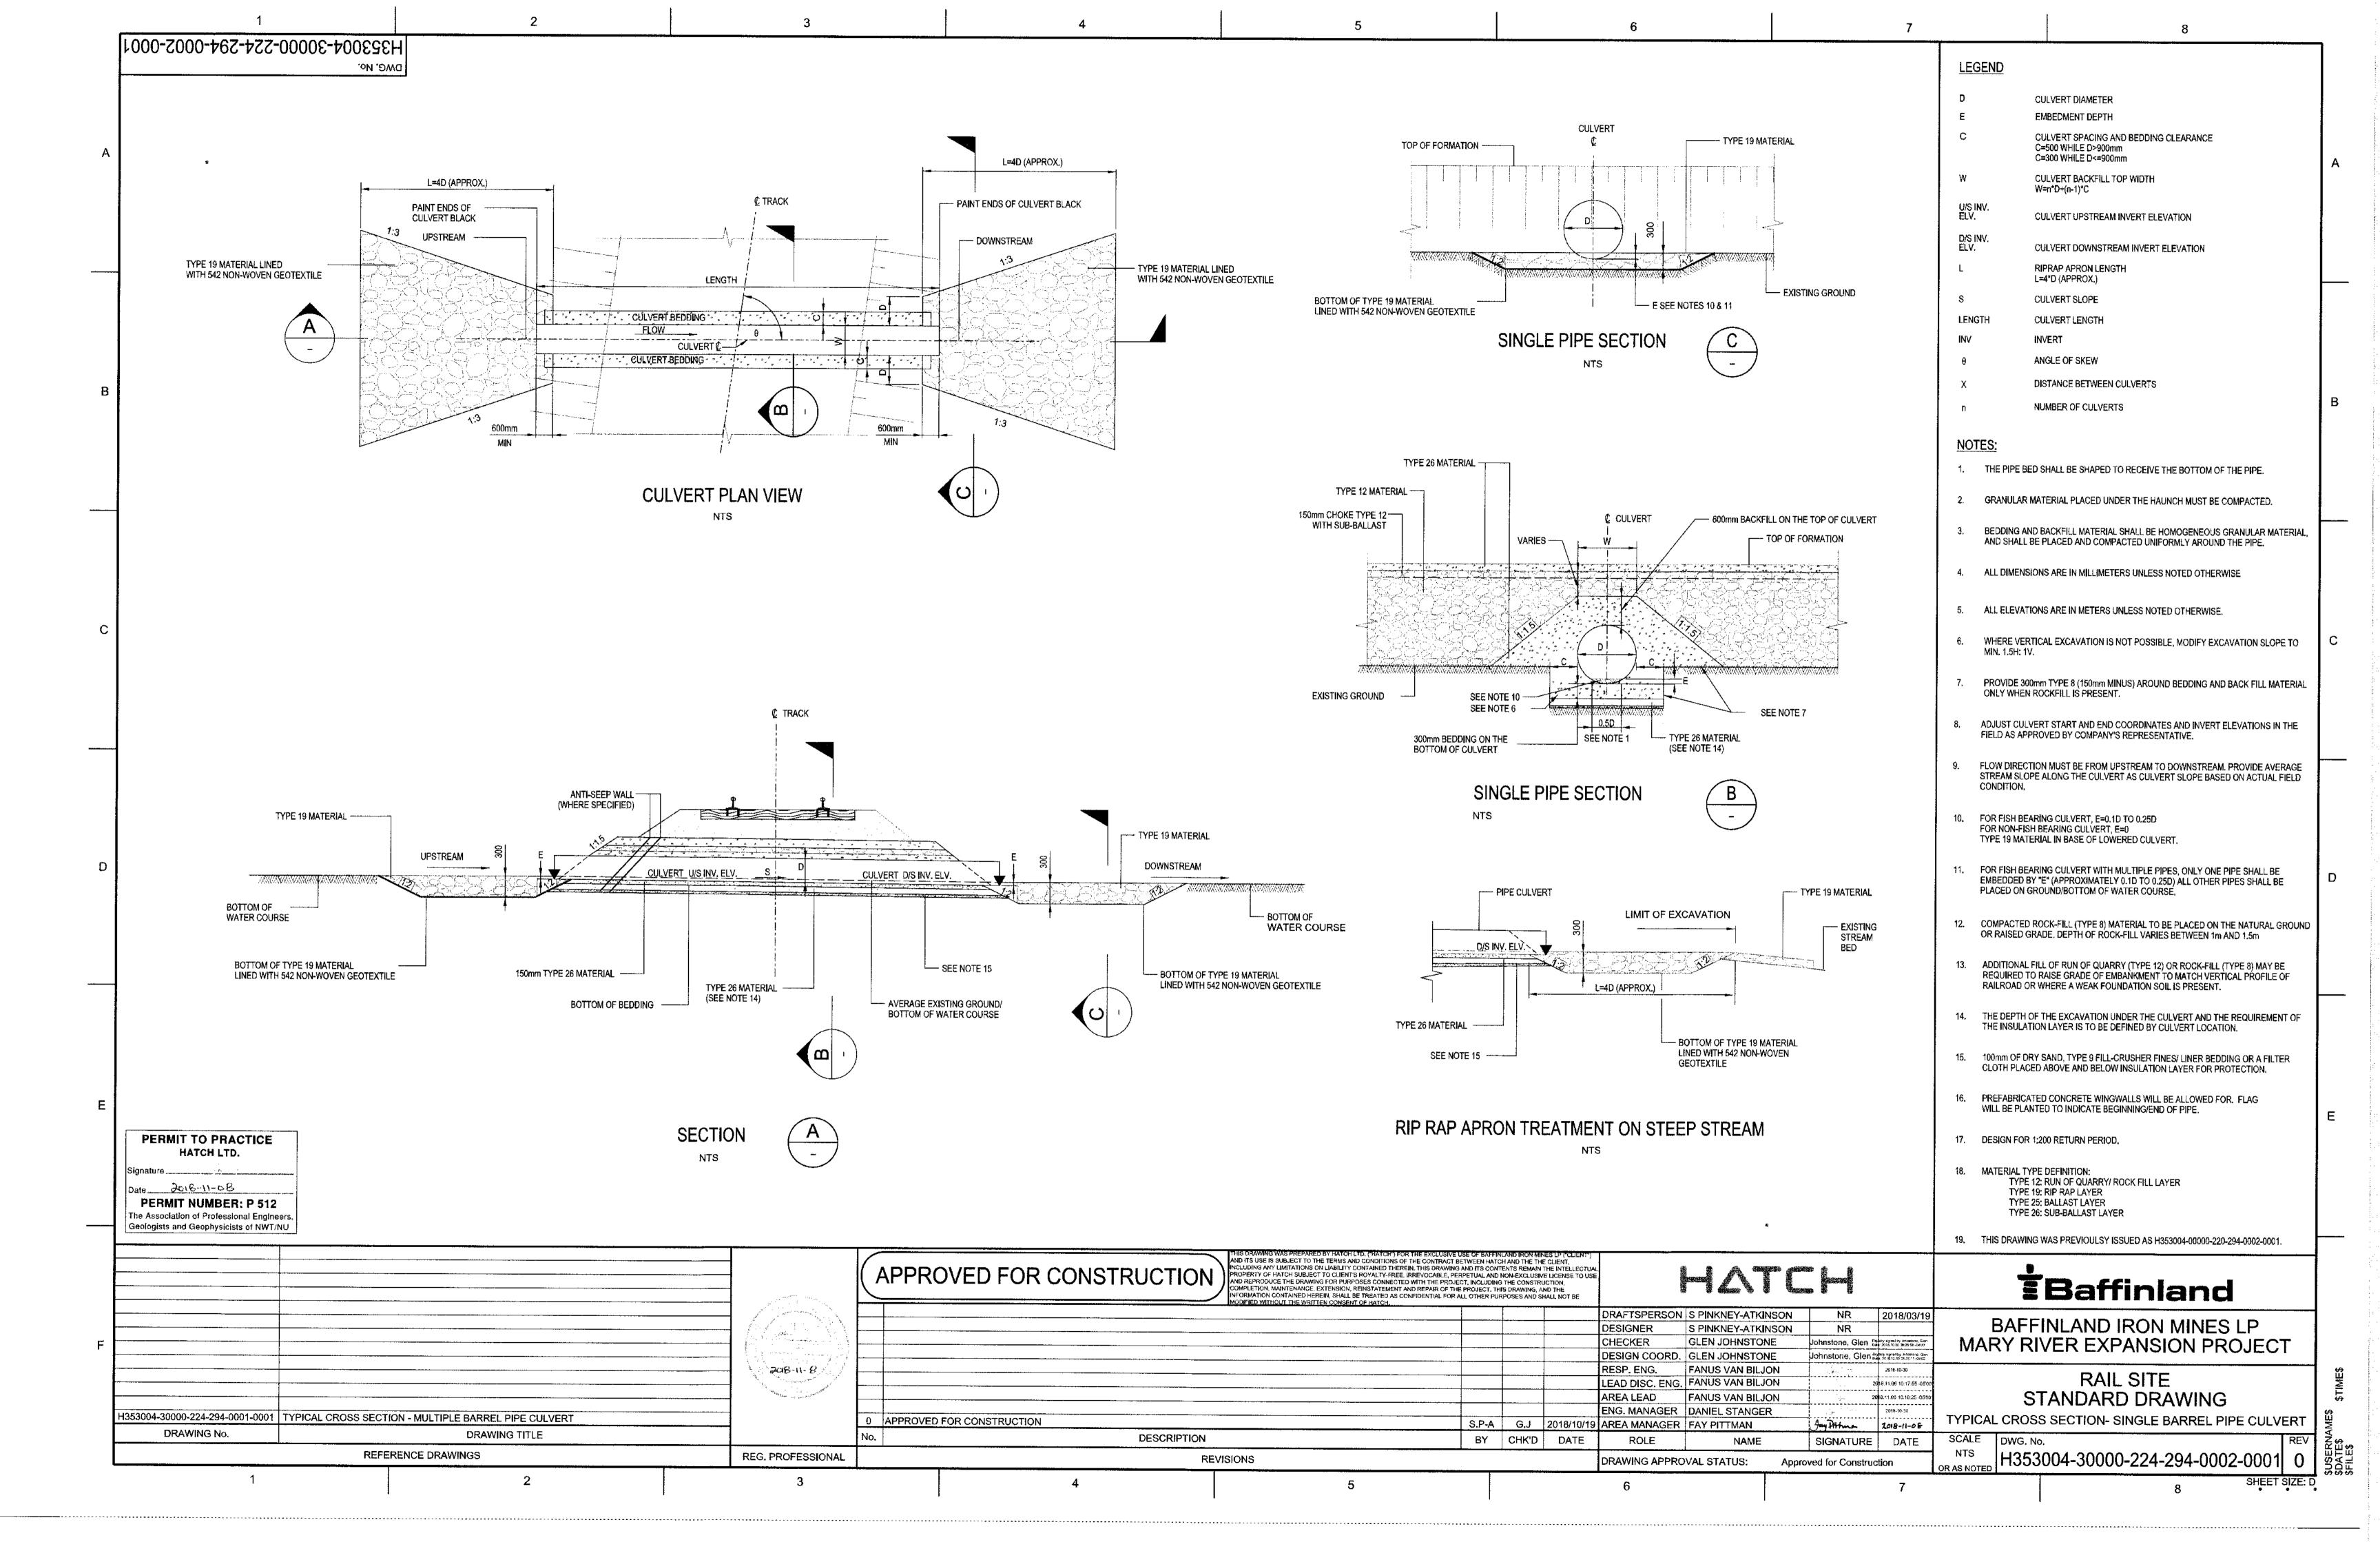


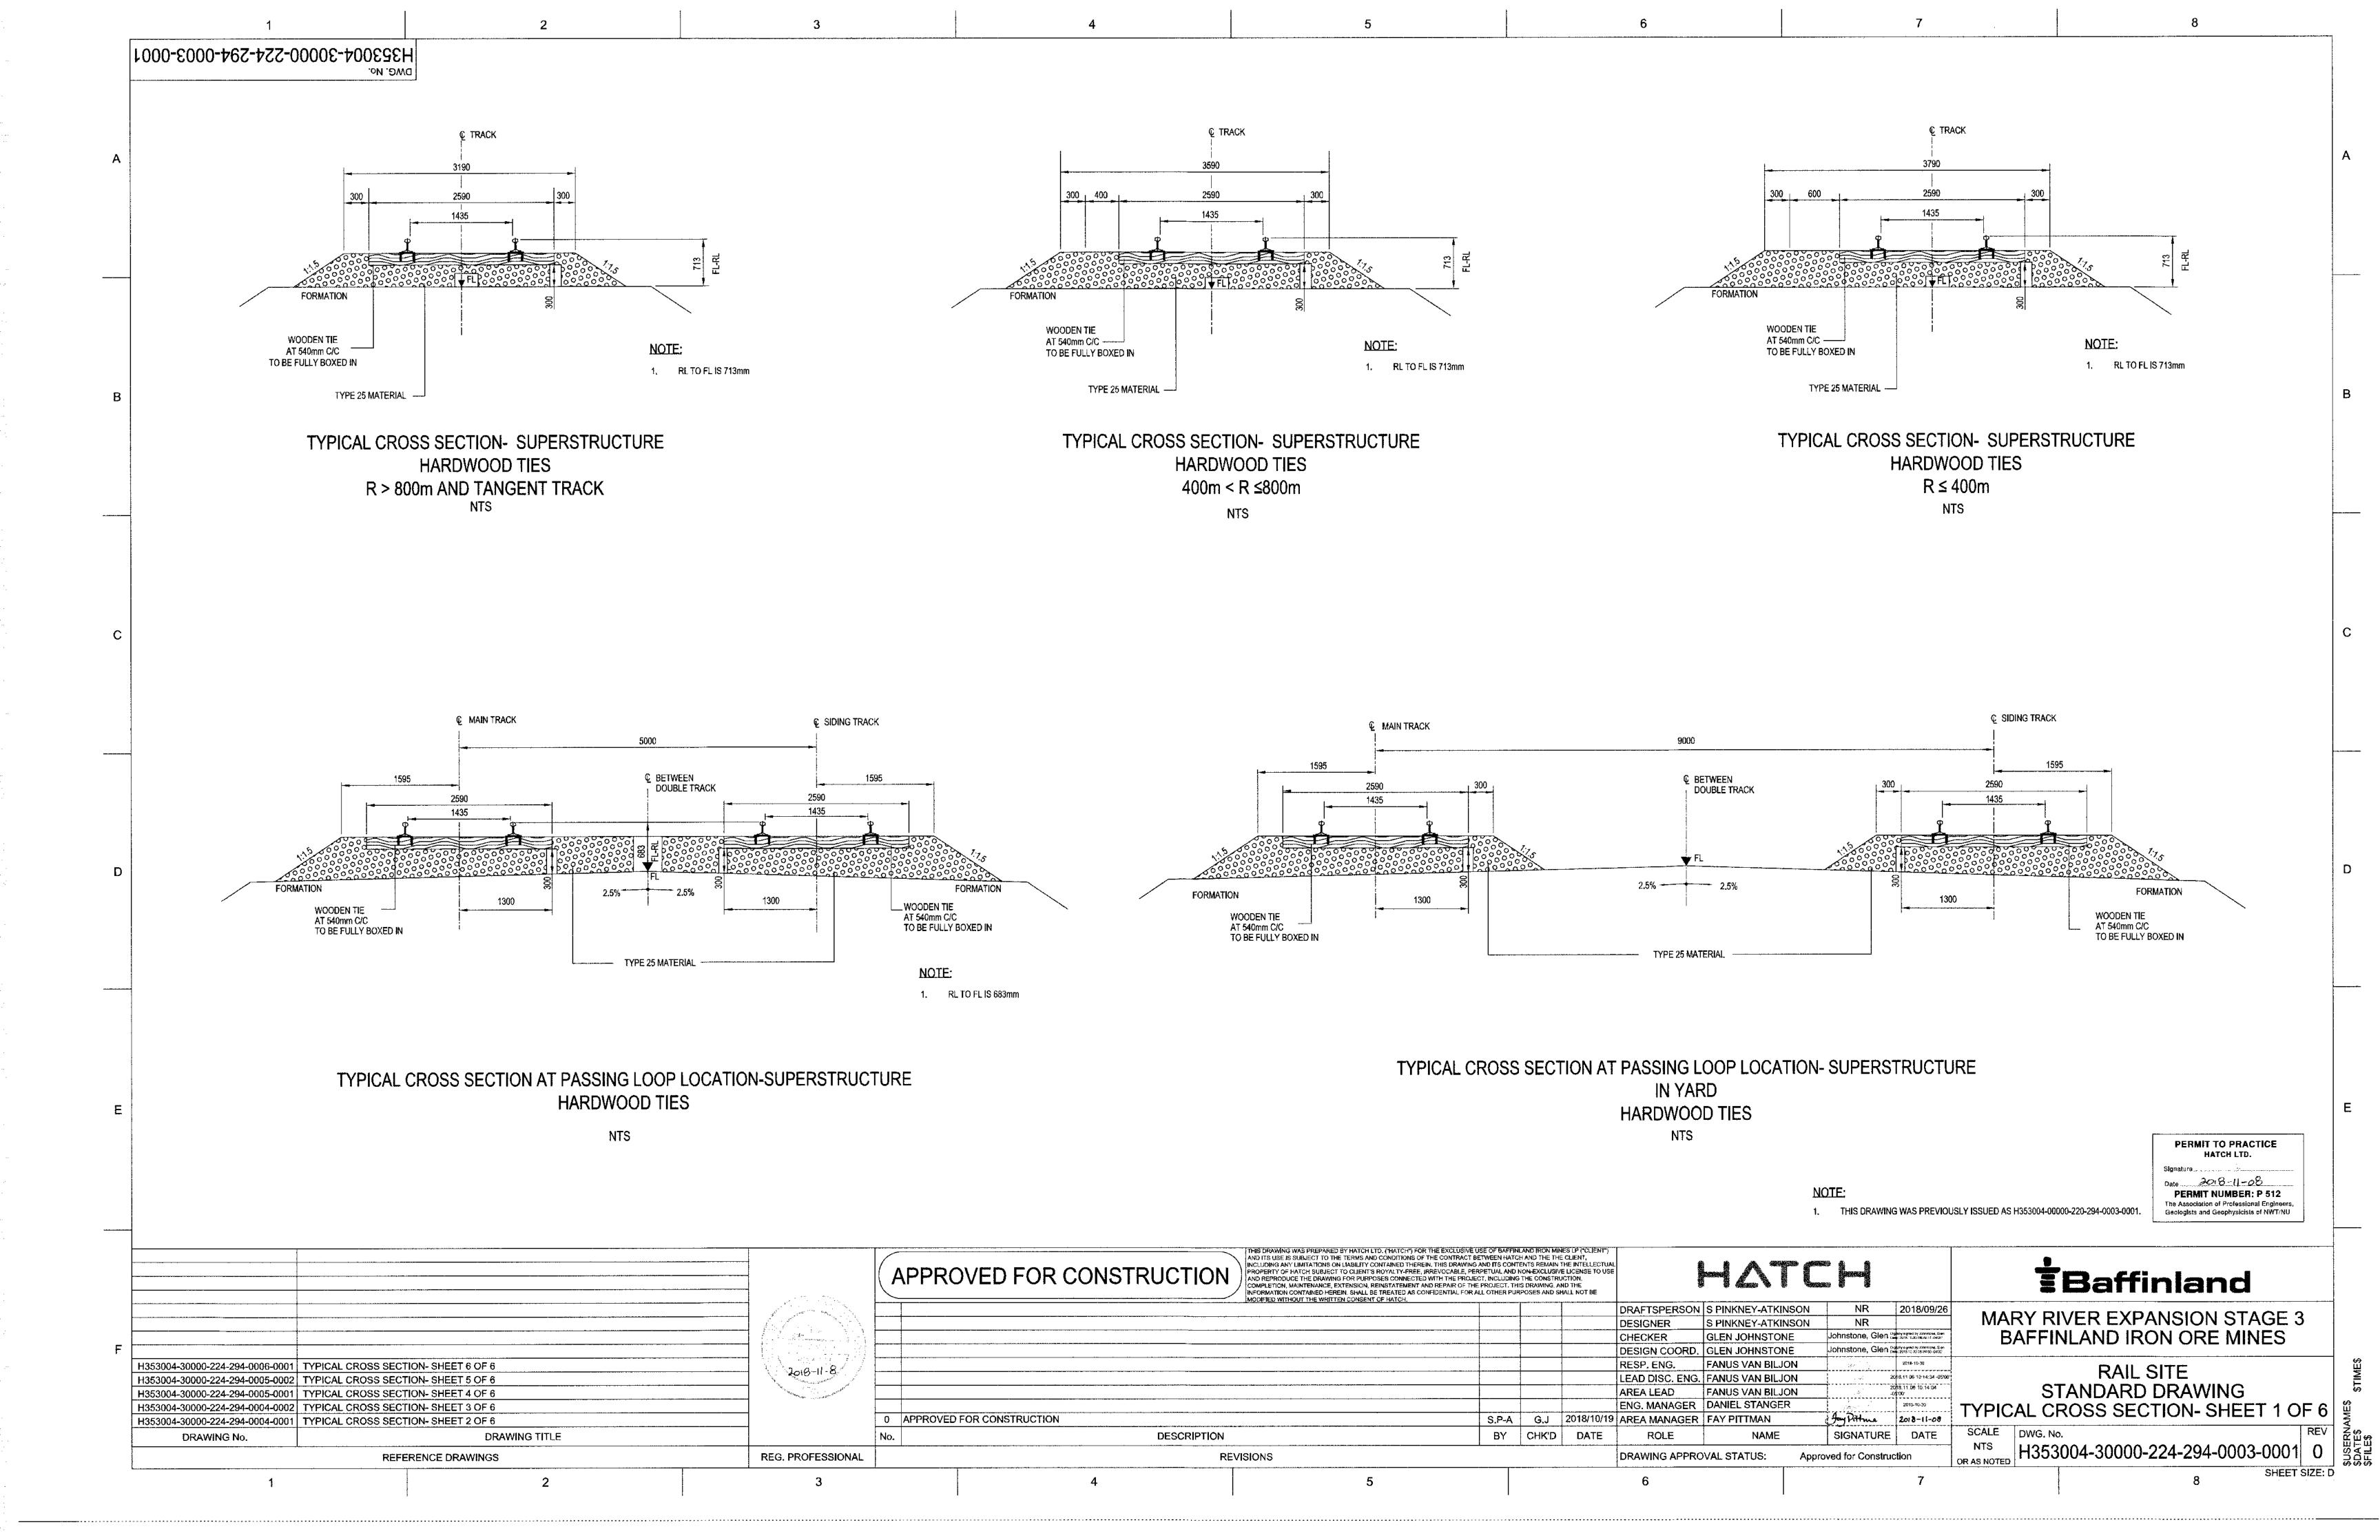


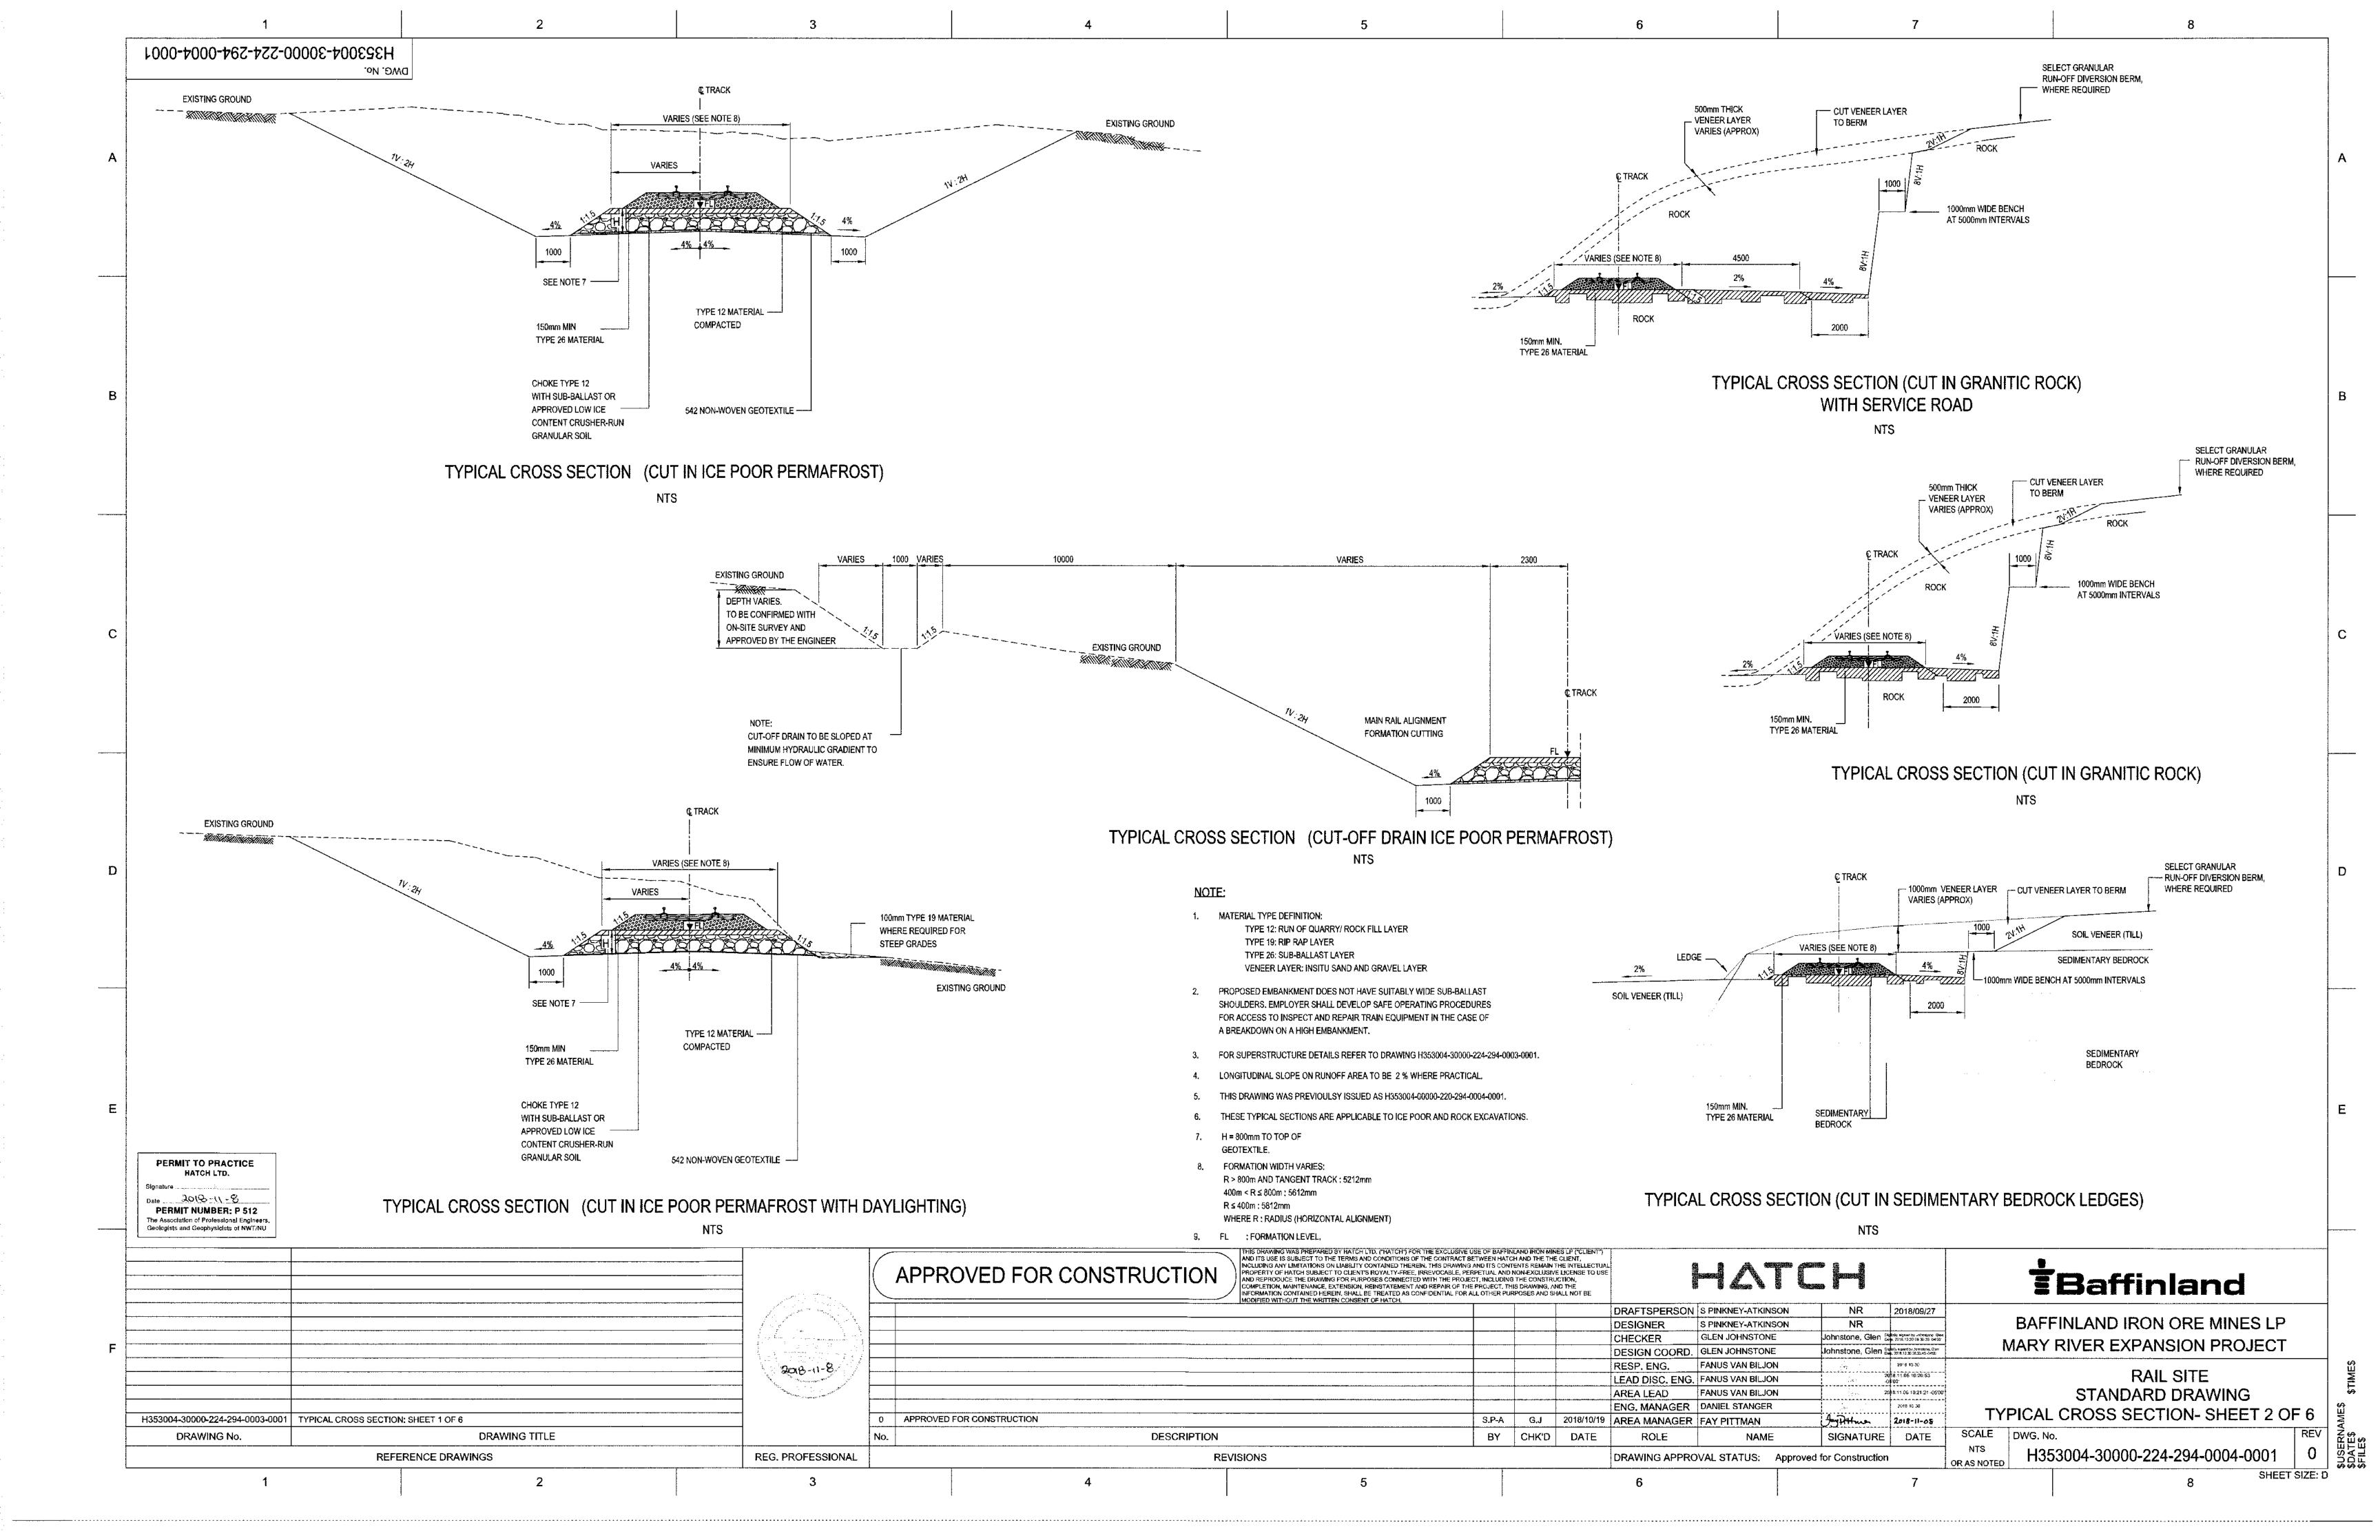


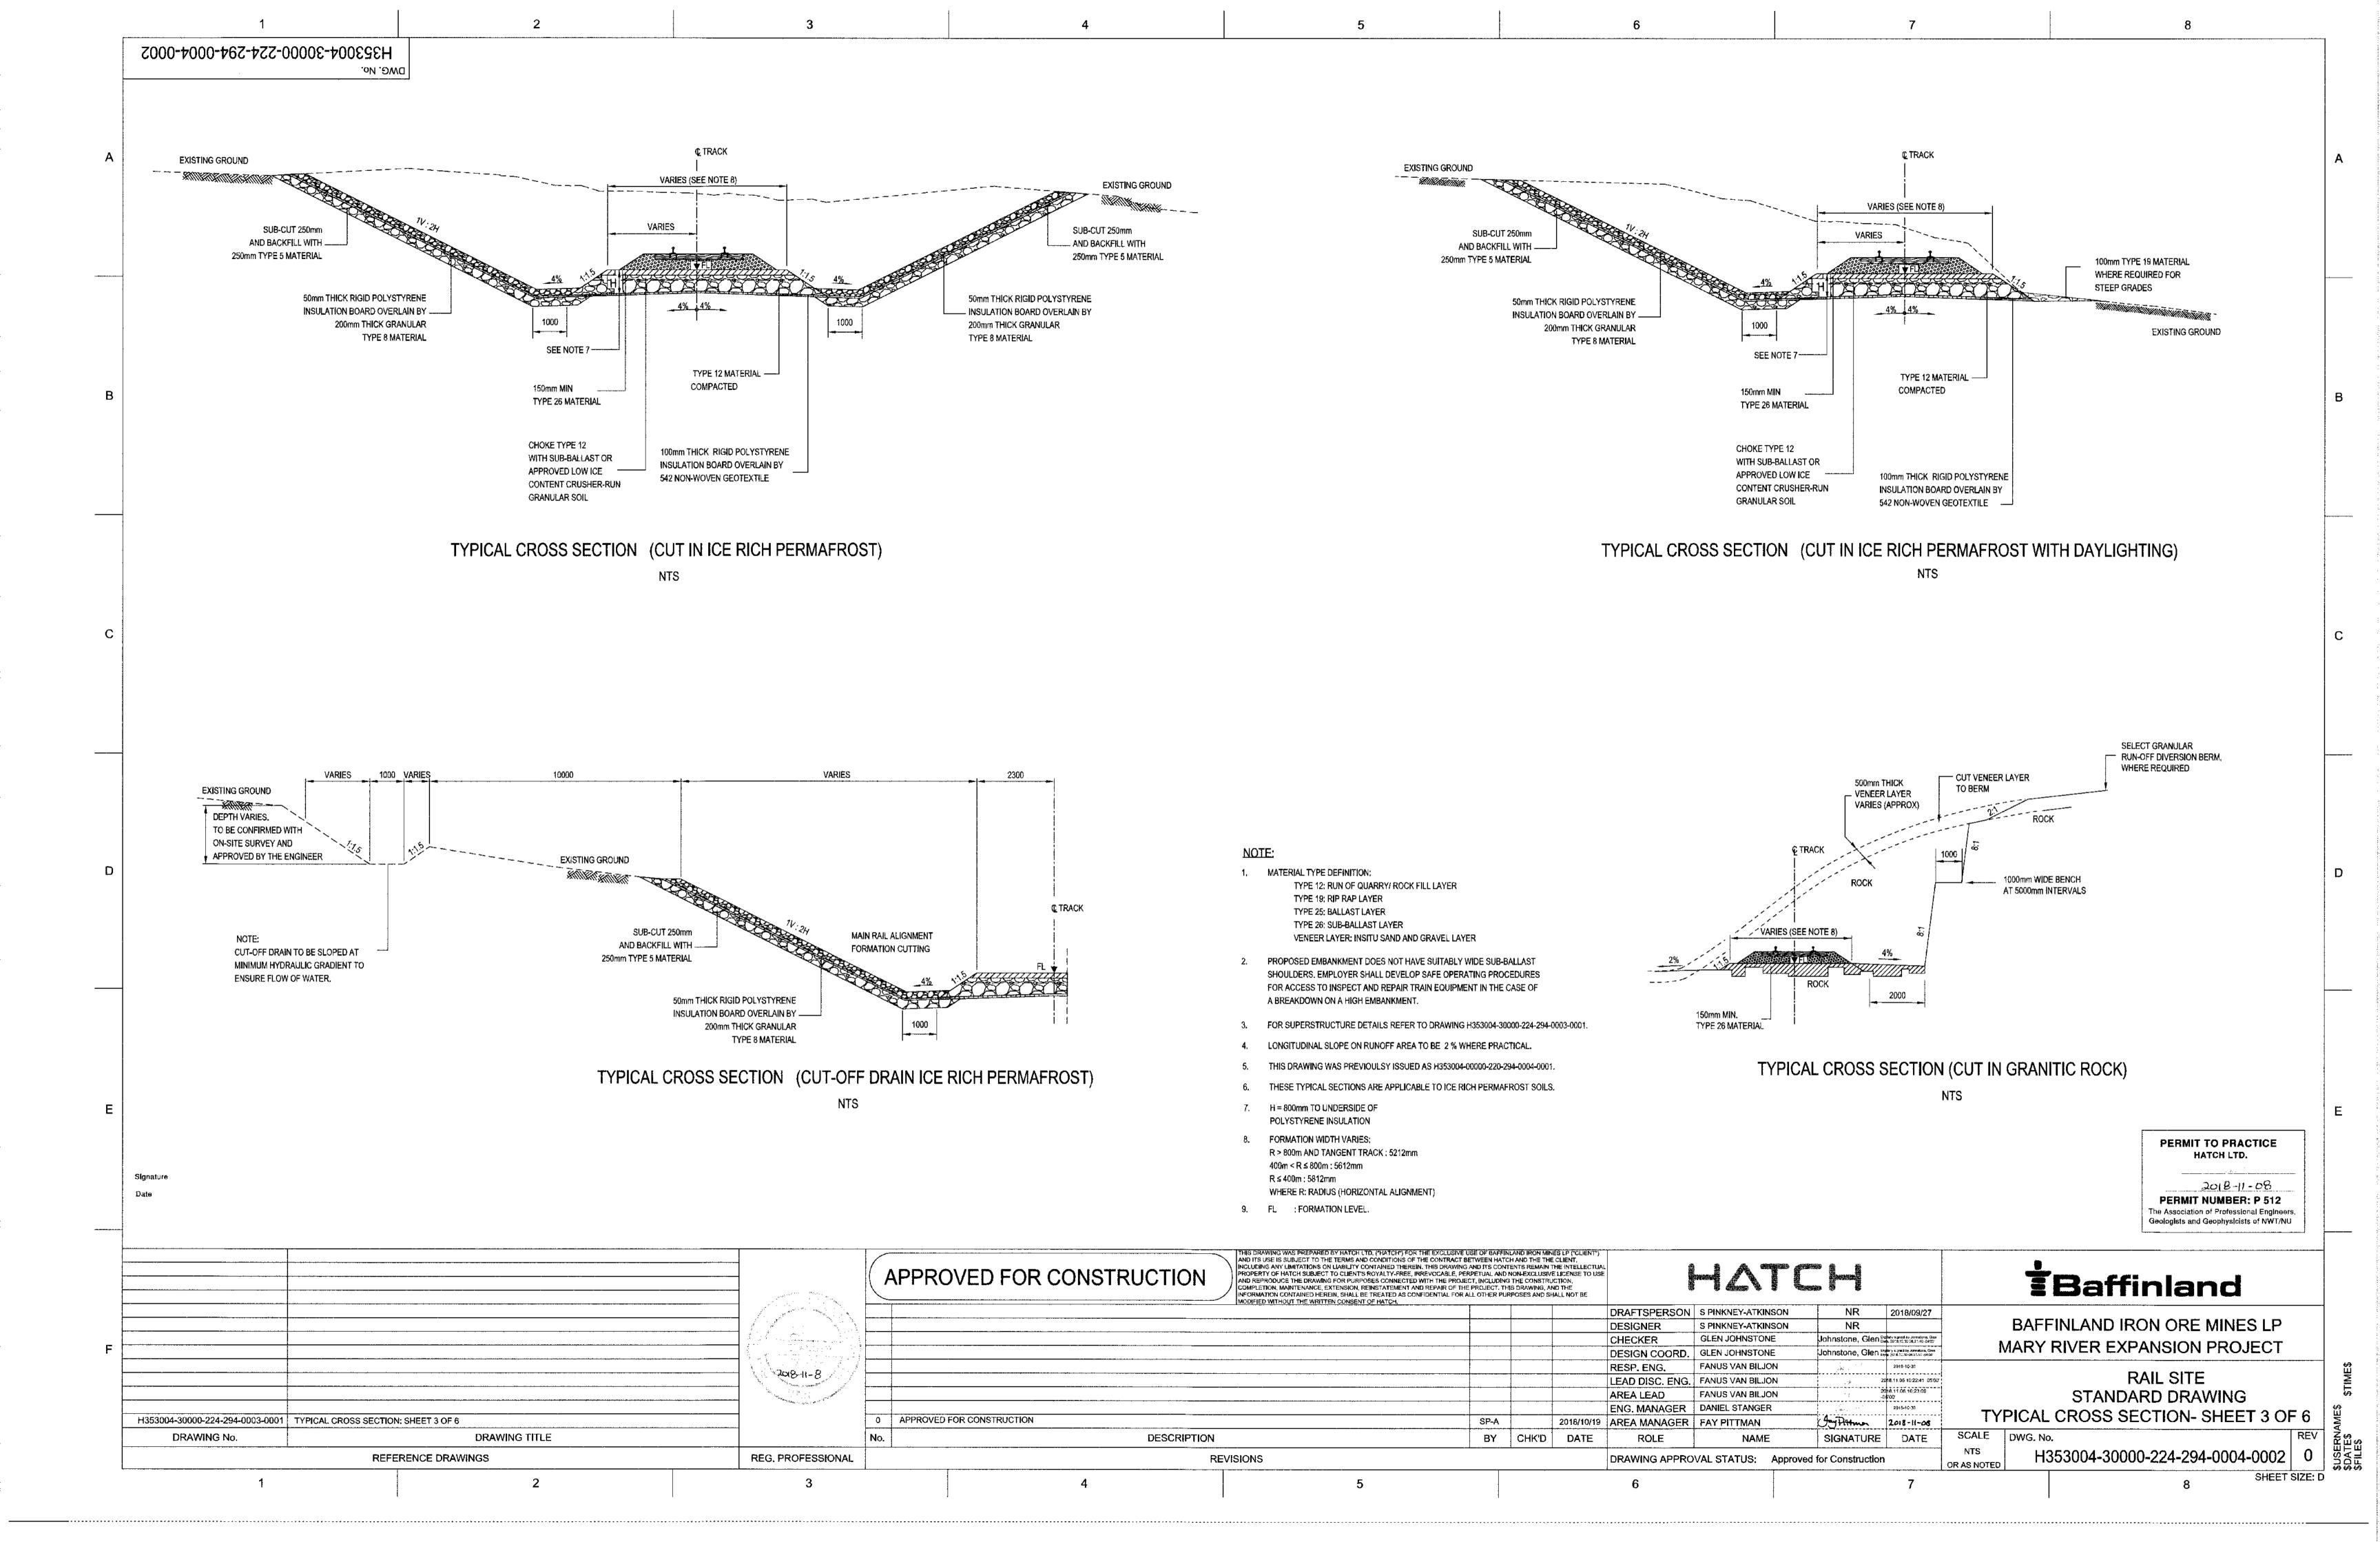


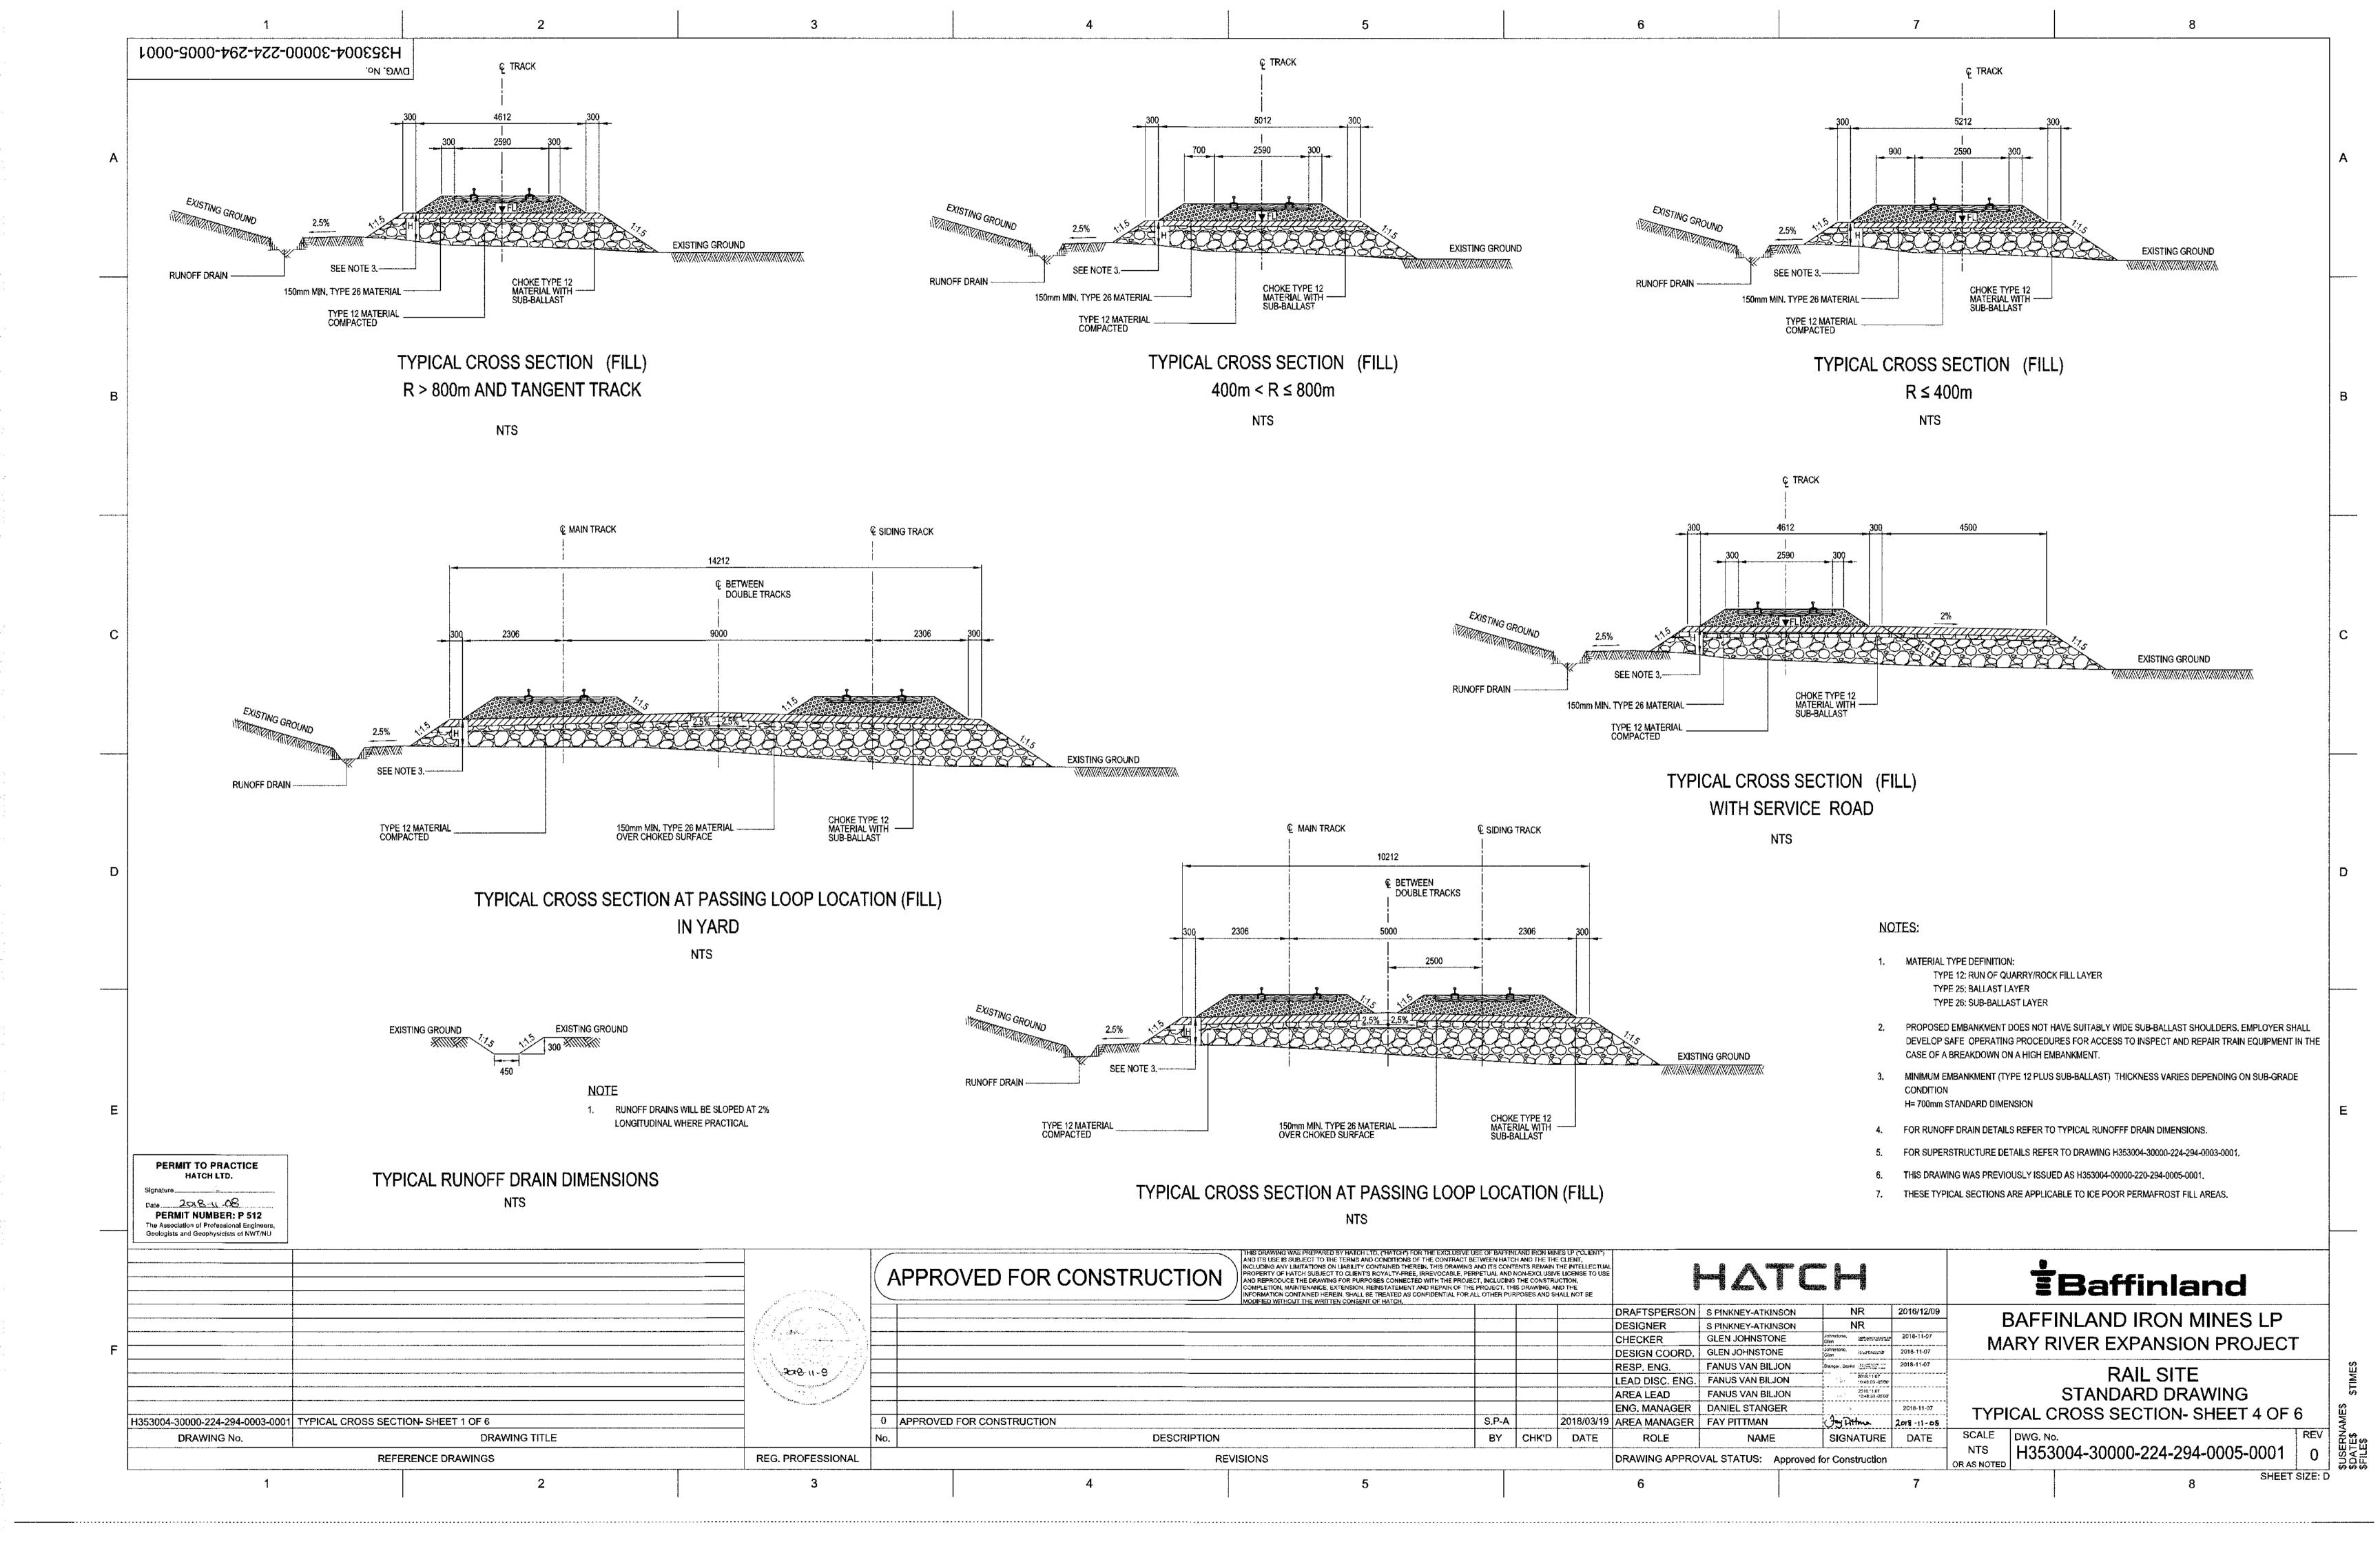

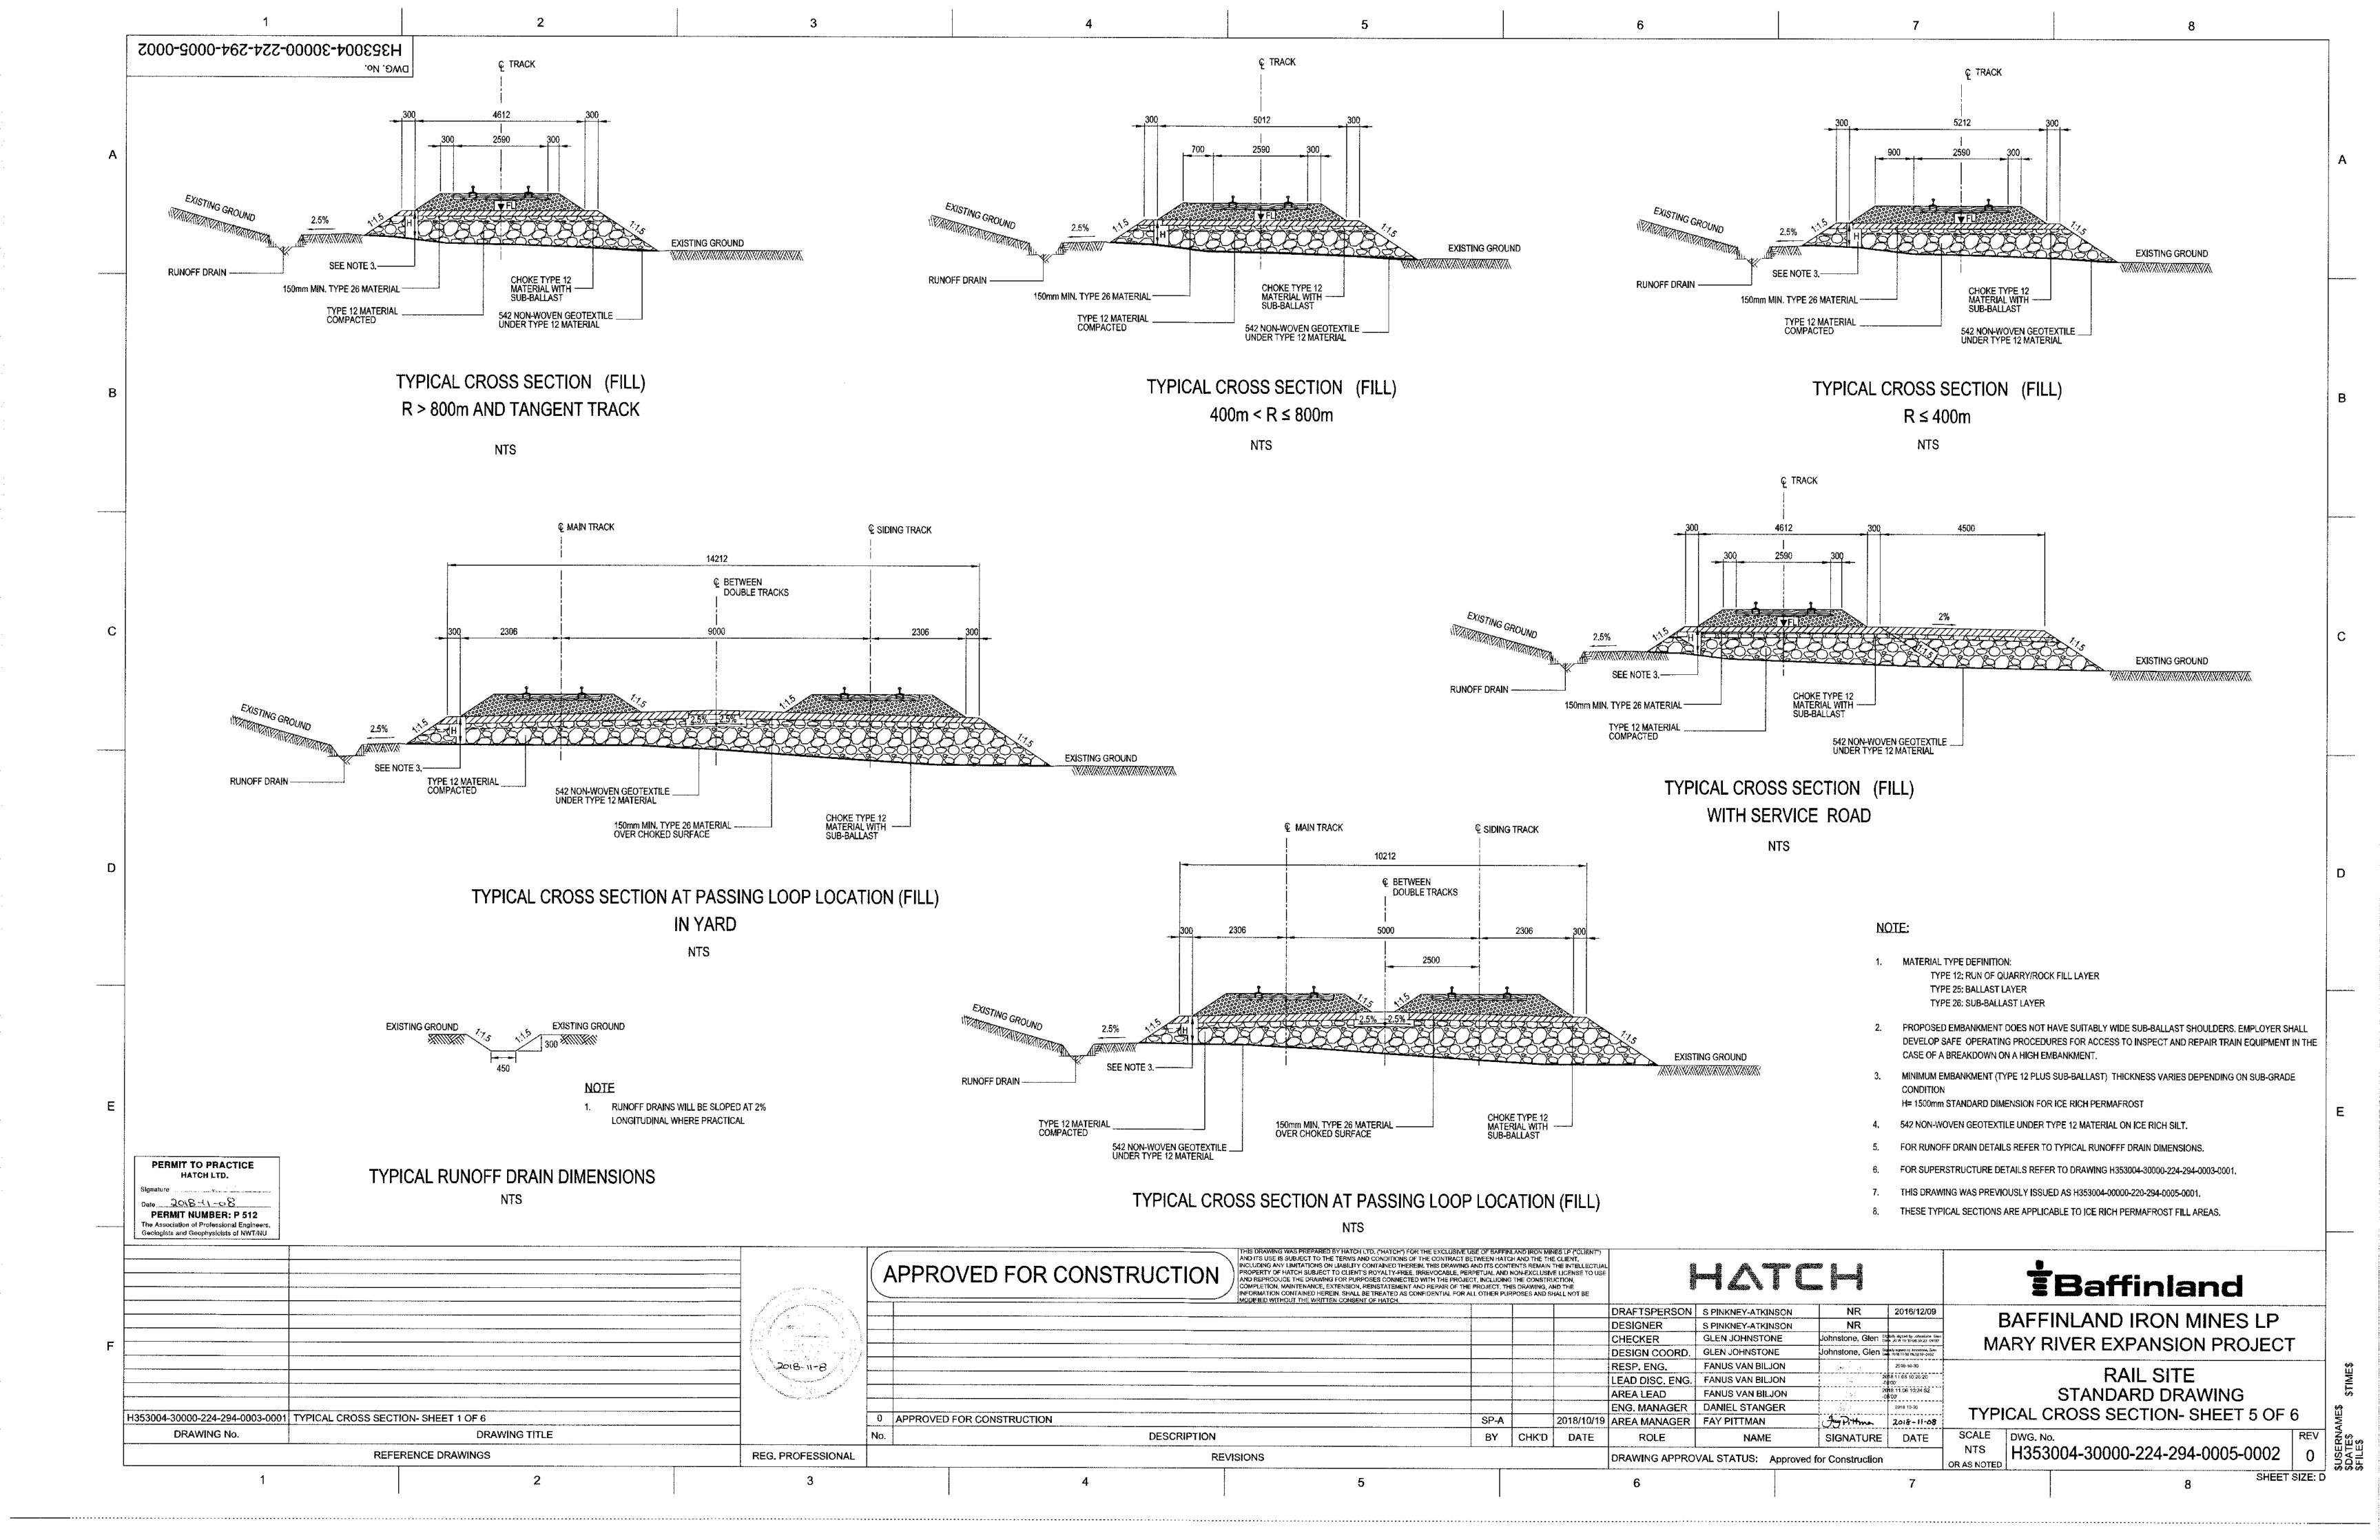

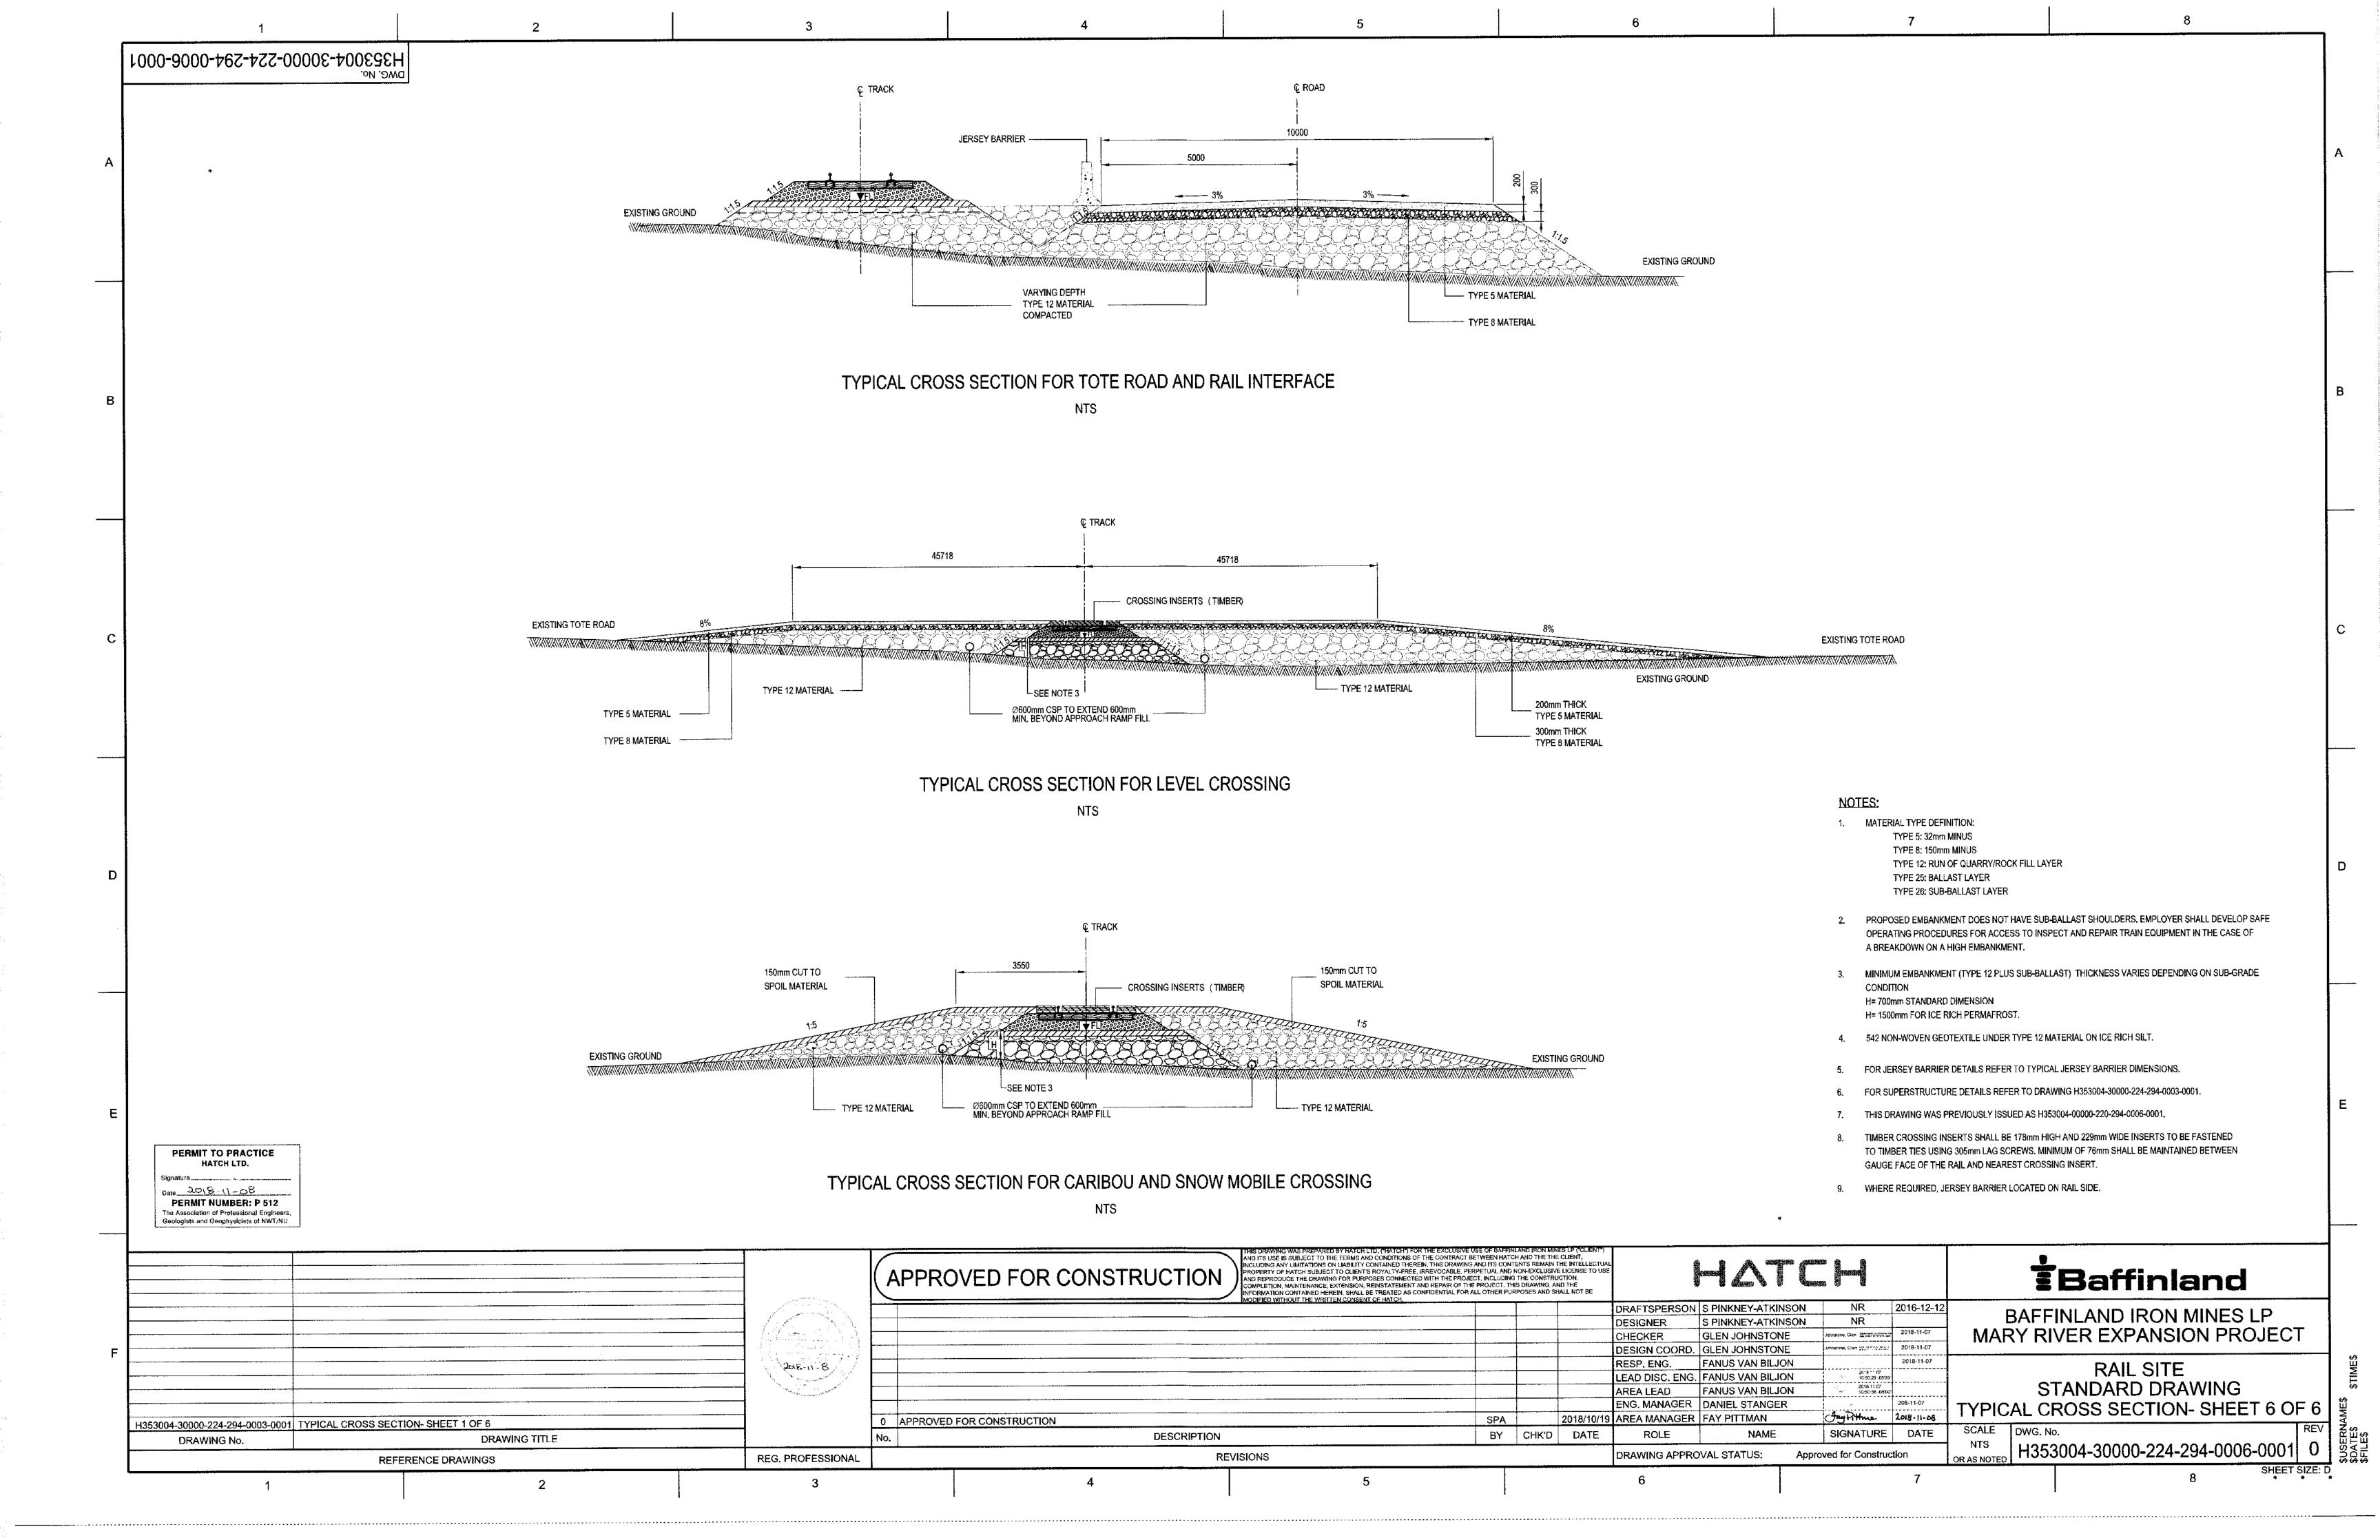

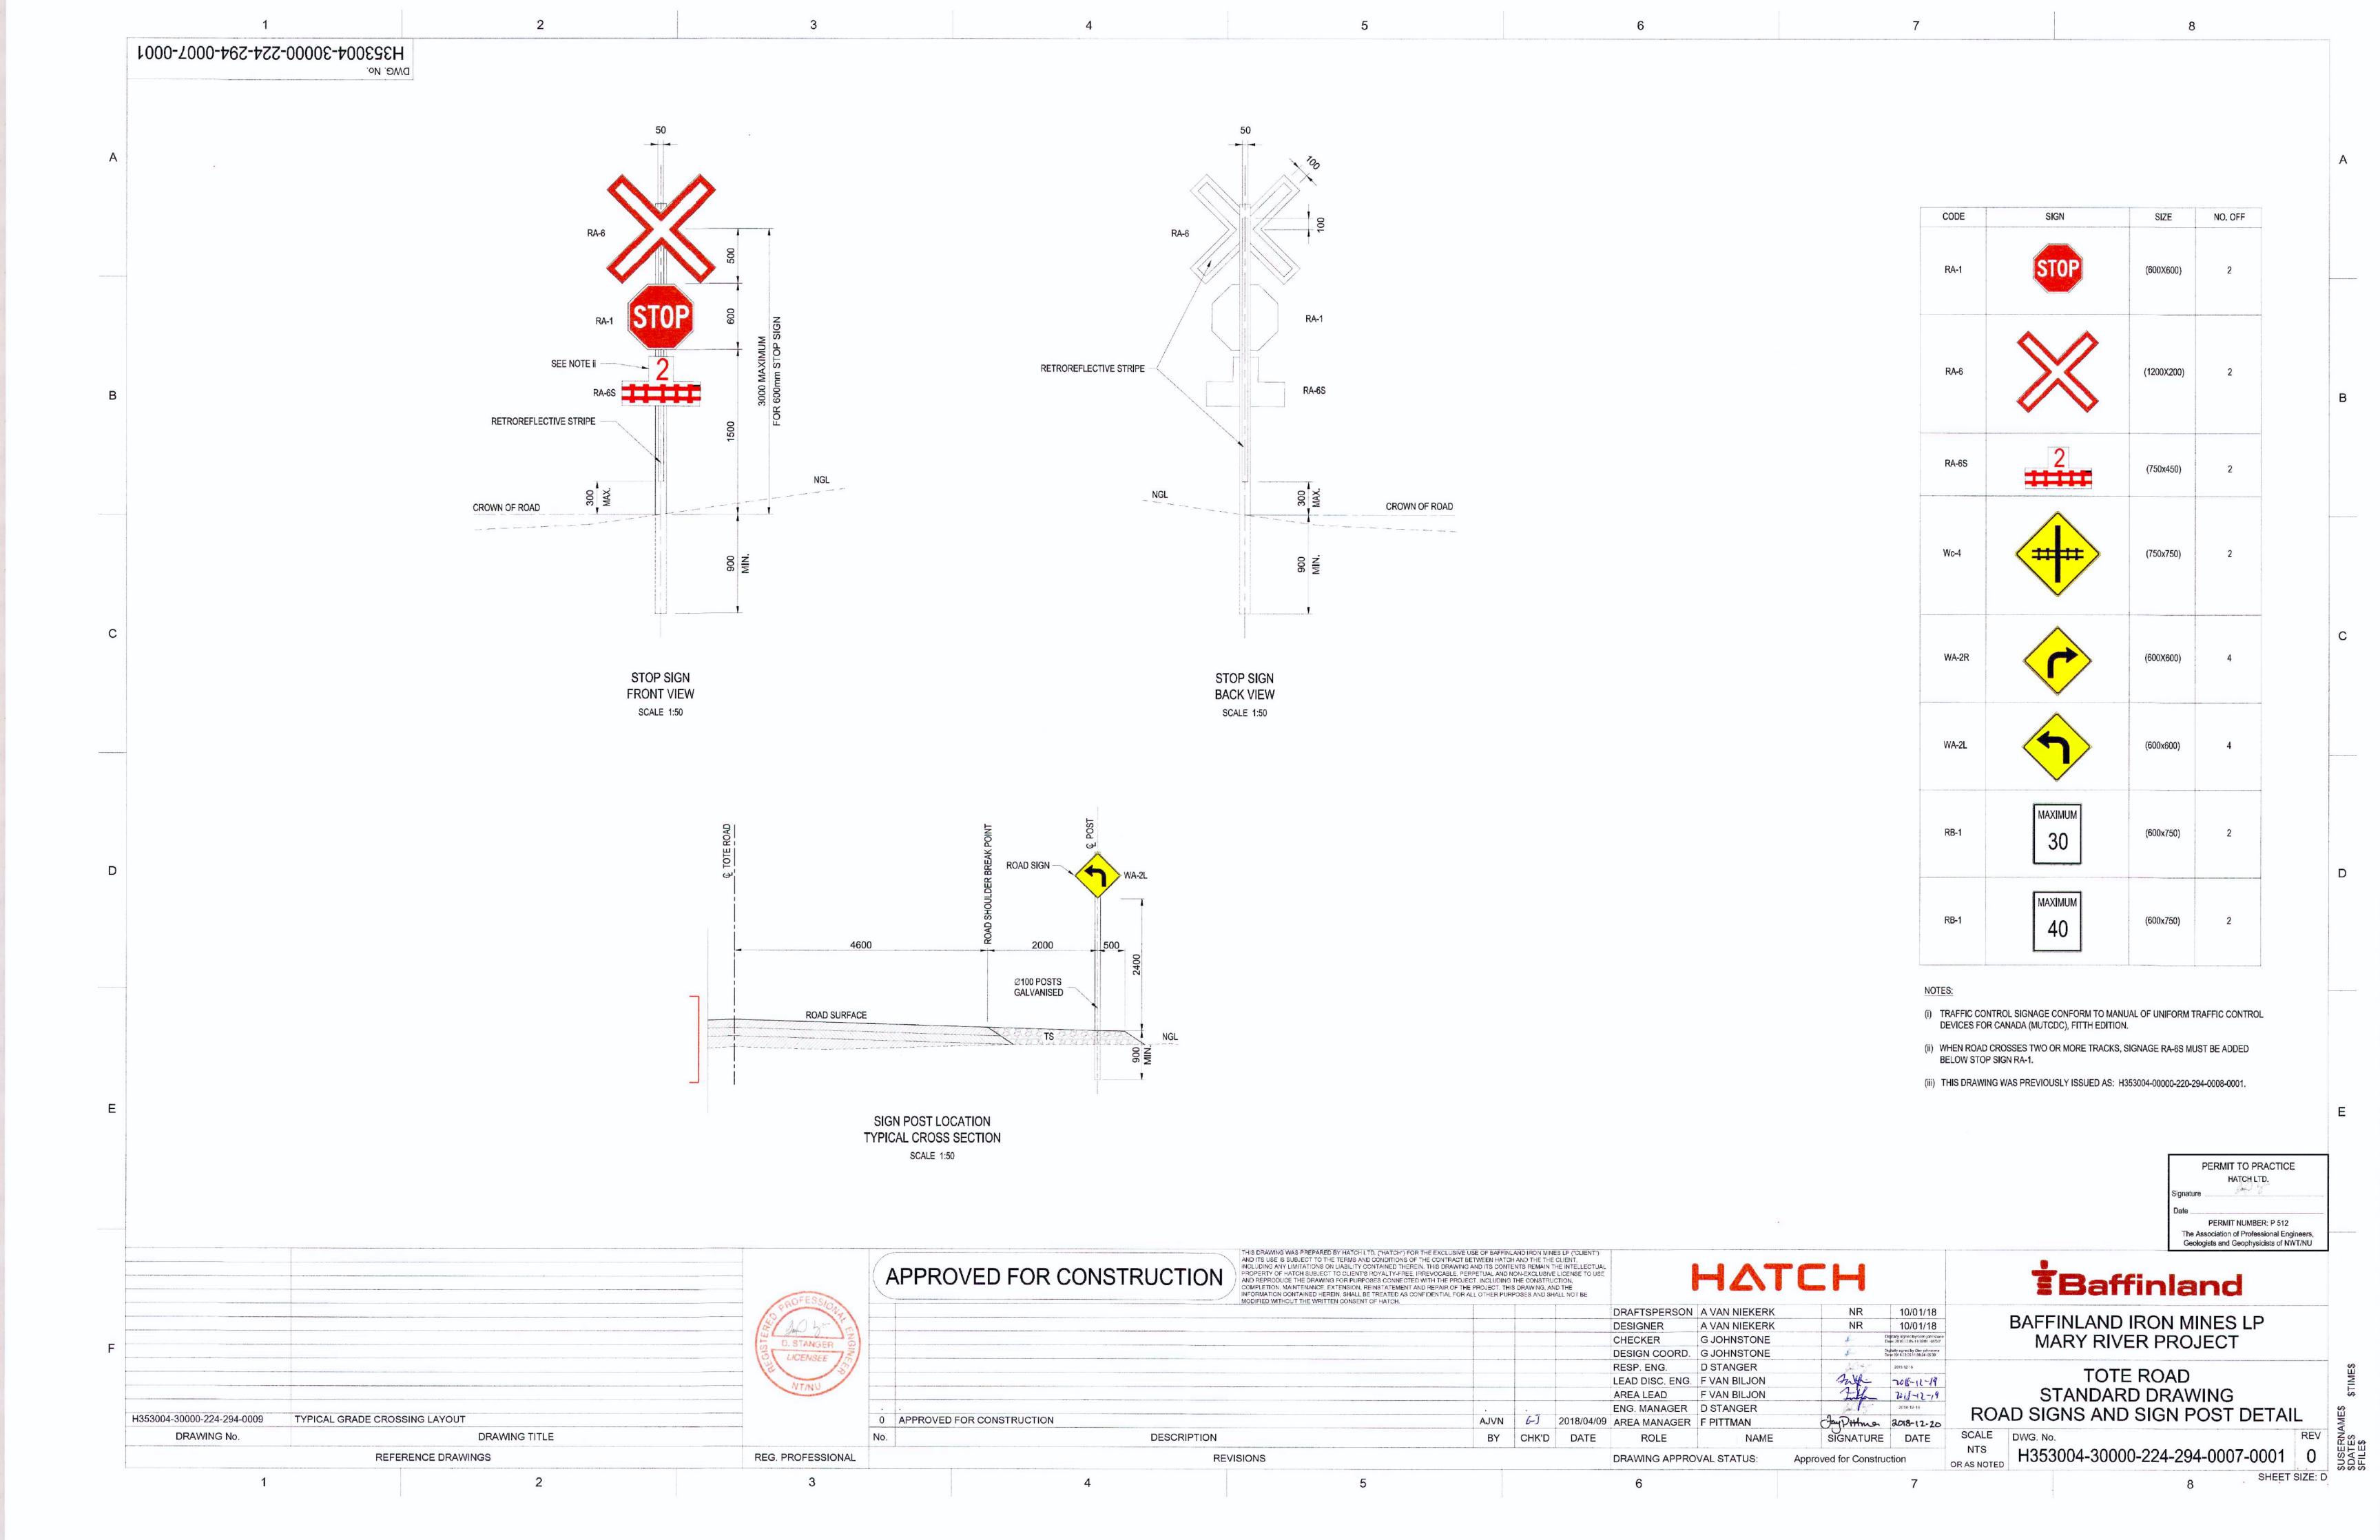

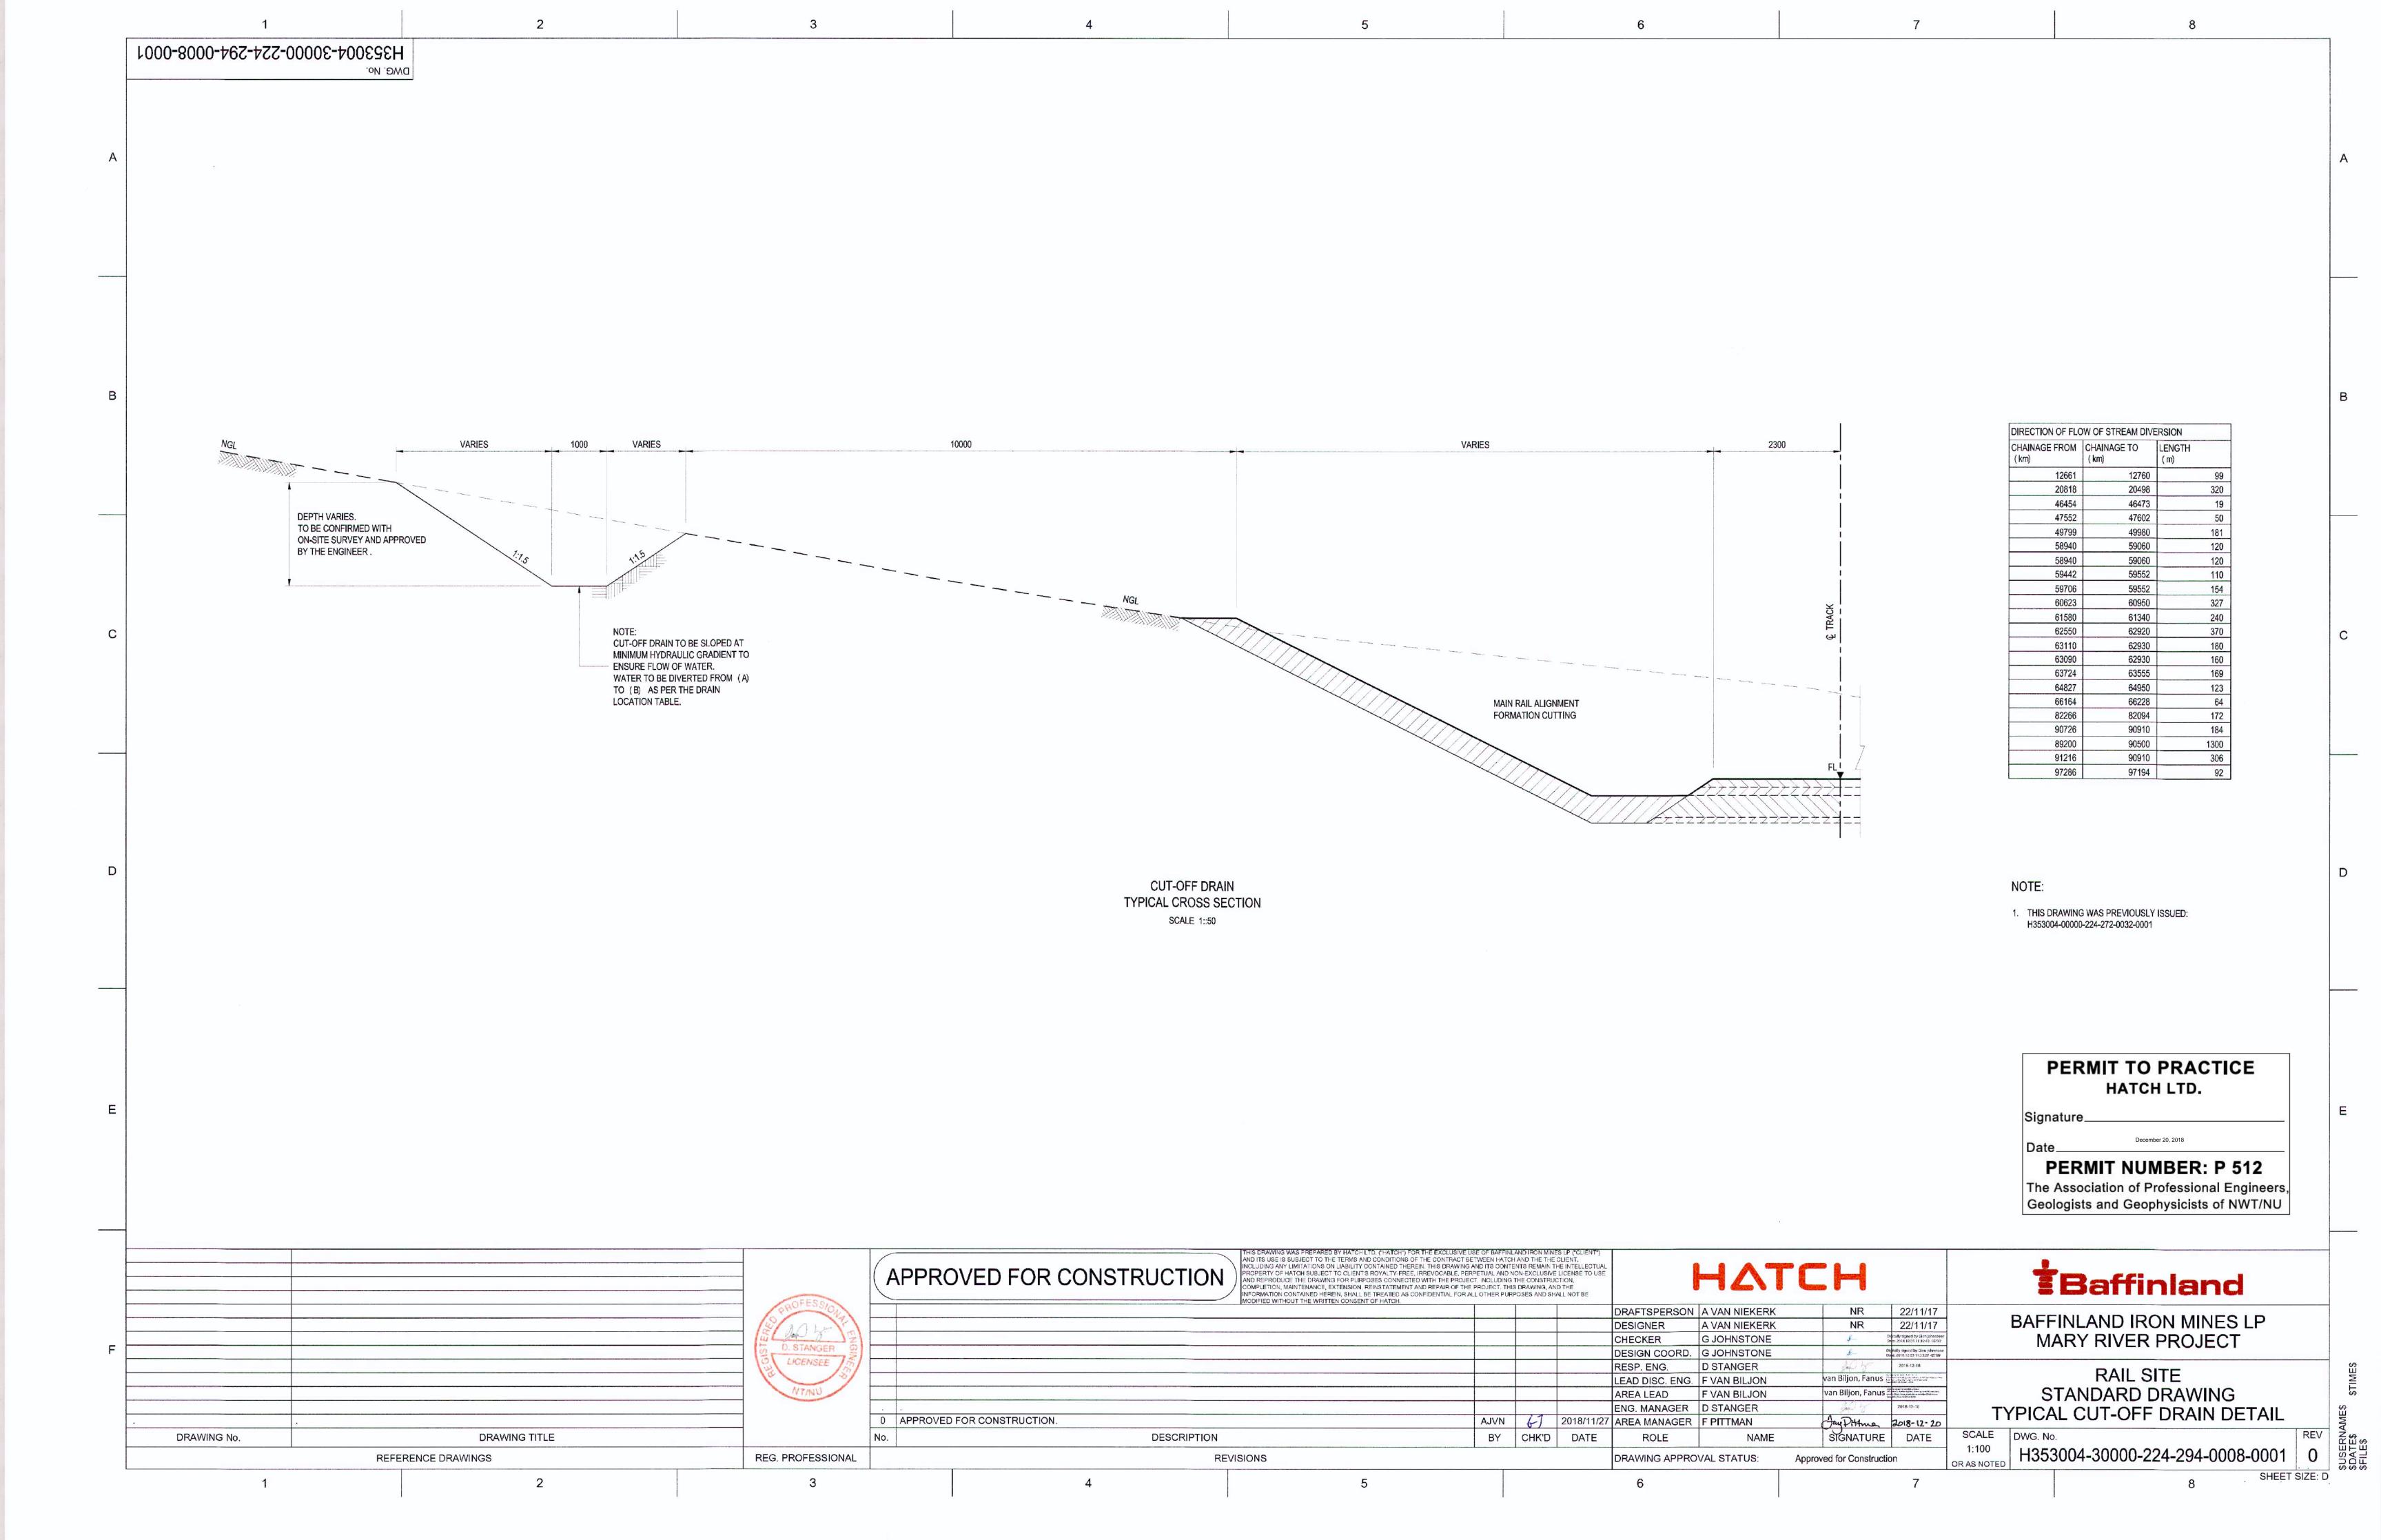

DEVIATED TOTE ROAD

(i) WHEREVER THE WORDS 'ENGINE WISTLE" APPEAR IN THESE RULES THEY ALSO REFER TO "ENGINE HORN". SIGNALS PRESCRIBED BY THIS RULE ARE ILLUSTRATED BY "0" FOR SHORT SOUNDS; "____" FOR LONGER SOUNDS. (ii) ENGINE WHISTLE SGNALS MUST BE SOUNDED AS PRESCRIBED BY THIS RULE, AND SHOULD BE DISTINCT, WITH INTENSITY AND DURATION PROPORTIONATE TO THE DISTANCE TO THE SIGNAL IS TO BE CONVEYED. UNNECESSARY USE OF WHISTLE IS PROHIBITED. (iii) RADIO MUST NOT BE USED IN LIEU OF ENGINE WHISTLE SIGNALS FOR INDICATION PREFIXED BY THE SYMBOL "#". APPLY 3.7m WIDENING WHISTLE SIGNAL MUST BE SOUNDED BY MOVEMENTS: * EXCEEDING 44MPH, AT WHISTLE POST * OPERATING 44MPH OR LESS, IN ORDER TO PROVIDE 20 SECONDS WARNING PRIOR TO ENTERING THE CROSSING. WHISTLE MUST BE PROLONGED OR REPEATED UNTILL THE CROSSING IS OCCUPIED. (v) TRAFFIC CONTROL SIGNAGE CONFORM TO MANUAL OF UNIFORM TRAFFIC CONTROL DEVICES FOR CANADA 45m STRAIGHT ROAD FOR OHT (MUTCDC), FITH EDITION. LEADING TO CROSSING. 0% GRADIENT. (vi) THIS DRAWING WAS PREVIOUSLY ISSUED AS: H353004-00000-224-272-0033-0001. RA-1 (600X600) EXISTING TOTE ROAD DEVIATED TOTE ROAD RA-6 (1200X200) RA-6 + RA-1 RAILWAY FORMATION RA-6 + RA-1 (1200X200) WA-2R (600X600) RA-1 EXISTING TOTE ROAD -(600X600)

TYPICAL LEVEL CROSSING LAYOUT

APPLY 3.7m WIDENING

ALL CURVES LEADING UP TO THE LEVEL CROSSING SHALL BE 50m MINIMUM RADIUS. ROAD WIDENING FOR 50m RADIUS CURVES TO BE APPLIED IN ACCORDANCE WITH DRAWING NO. H349000-3000-10-041-0008

PERMIT TO PRACTICE


HATCH LTD.

Signature

Date

PERMIT NUMBER: P 512

The Association of Professional Engineers,
Geologists and Geophysicists of NWT/NU

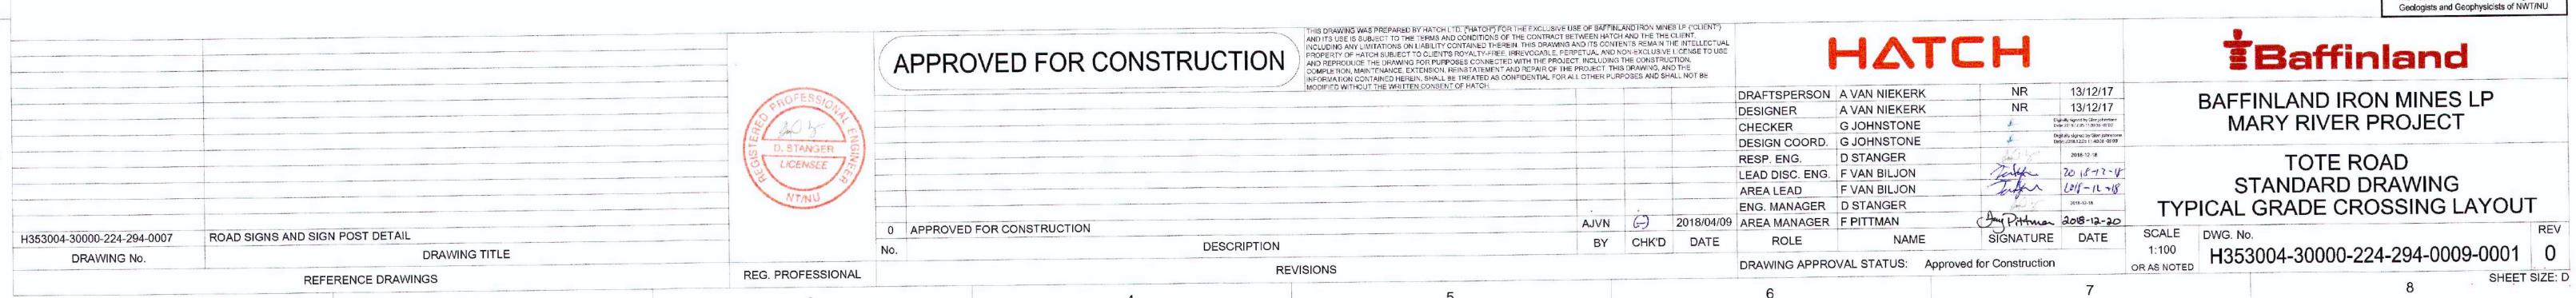

H353004-30000-224-294-0010-0001 TYPE 5 (32mm MINUS) FINISHED SUBGRADE TYPE 8 (150mm MINUS) SUBGRADE TYPICAL HAUL ROAD CROSS SECTION SCALE 1::50 NOTE: IS DRAWING WAS PREPARED BY HATCH LTD. ("HATCH") FOR THE EXCLUSIVE USE OF BAFFINLAND IRON MINES LP ("CLIENT") THIS DRAWING WAS PREPARED BY HATCH LTD. ("HATCH") FOR THE EXCLUSIVE USE OF BAFFINLAND IRON MINES LP ("CLIENT")
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2016/04/23 CHECKER DESIGN COORD. A AQUIL D STANGER RESP. ENG. LEAD DISC. ENG. F VAN BILJON AREA LEAD ENG. MANAGER OSTANGER. AVV AA 2016/20/20 AREA MANAGER F.PITTMAN
BY CHK'D DATE ROLE NAM 0 APPROVED FOR CONSTRUCTION DESCRIPTION SIGNATURE DATE DRAWING TITLE DRAWING No. REVISIONS DRAWING APPROVAL STATUS: APPROVED FOR CONSTRUCTION REFERENCE DRAWINGS REG. PROFESSIONAL

2

| ROAD PAVEMENT | STRUCTURE BY SOIL | TYPE |
|--------------------------------------|----------------------|----------------------|
| SOIL TYPE BY FROST SUSCEPTIBILITY | TYPE 8 DEPTH (mm) | TYPE 5 DEPTH (mm) |
| HIGHLY SUSCEPTIBLE (HS) | 150 | 150 |
| MODERATELY SUSCEPTIBLE (MS) | 150 | 150 |
| POTENTIALLY SUSCEPTIBLE (PS) | | 150 |
| NON SUSCEPTIBLE | 2 | 150 |

| | | WIDENIN | NG TABLE | | | | | |
|-----------|---------------|-----------|---------------|-----------------------|----------|--|--|--|
| DESIGN SI | PEED: 65 km/h | DESIGN SI | PEED: 65 km/h | DESIGN SPEED: 65 km/h | | | | |
| RADIUS | WIDENING | RADIUS | WIDENING | RADIUS | WIDENING | | | |
| 10000 | 0 | 475 | 0.3 | 190 | 1 | | | |
| 5000 | 0 | 390 | 0.4 | 180 | 1.1 | | | |
| 3000 | 0 | 380 | 0.5 | 170 | 1.2 | | | |
| 2000 | 0 | 370 | 0.5 | 160 | 1.3 | | | |
| 1500 | 0 | 360 | 0.5 | 150 | 1.4 | | | |
| 1200 | 0 | 350 | 0.5 | 140 | 1.5 | | | |
| 1000 | 0 | 340 | 0.5 | 130 | 1.6 | | | |
| 950 | 0 | 330 | 0.5 | 120 | 1.7 | | | |
| 900 | 0 | 320 | 0.6 | 110 | 1.9 | | | |
| 850 | 0.1 | 310 | 0.6 | 100 | 2 | | | |
| 800 | 0.1 | 300 | 0.6 | 90 | 2.3 | | | |
| 750 | 0.1 | 290 | 0.6 | 80 | 2.6 | | | |
| 700 | 0.1 | 280 | 0.7 | 70 | 2.9 | | | |
| 650 | 0.2 | 270 | 0.7 | 60 | 3.3 | | | |
| 600 | 0.2 | 260 | 0.7 | 55 | 3.5 | | | |
| 575 | 0.2 | 250 | 0.8 | 50 | 3.7 | | | |
| 550 | 0.2 | 240 | 0.8 | | | | | |
| 525 | 0.2 | 200 | 1 | | | | | |

- ALL DIMENSIONS ARE IN MILLIMETERS UNLESS OTHERWISE INDICATED.
- 2. 'W' REFER TO WIDENING TABLE FOR WIDTH OF WIDENING.

THIS DRAWING WAS PREVIOUSLY ISSUED: H353004-00000-224-272-0034-0001

PERMIT TO PRACTICE HATCH LTD. 2018-4-24 PERMIT NUMBER: P 512 The Association of Professional Engineers, Geologists and Geophysicis:s of NWT/NU


Baffinland BAFFINLAND IRON MINES LP MARY RIVER EXPANSION PROJECT


TOTE ROAD STANDARD DRAWING TYPICAL HAUL ROAD CROSS SECTION


1:100 H353004-30000-224-294-0010-0001

WORKSHOPS




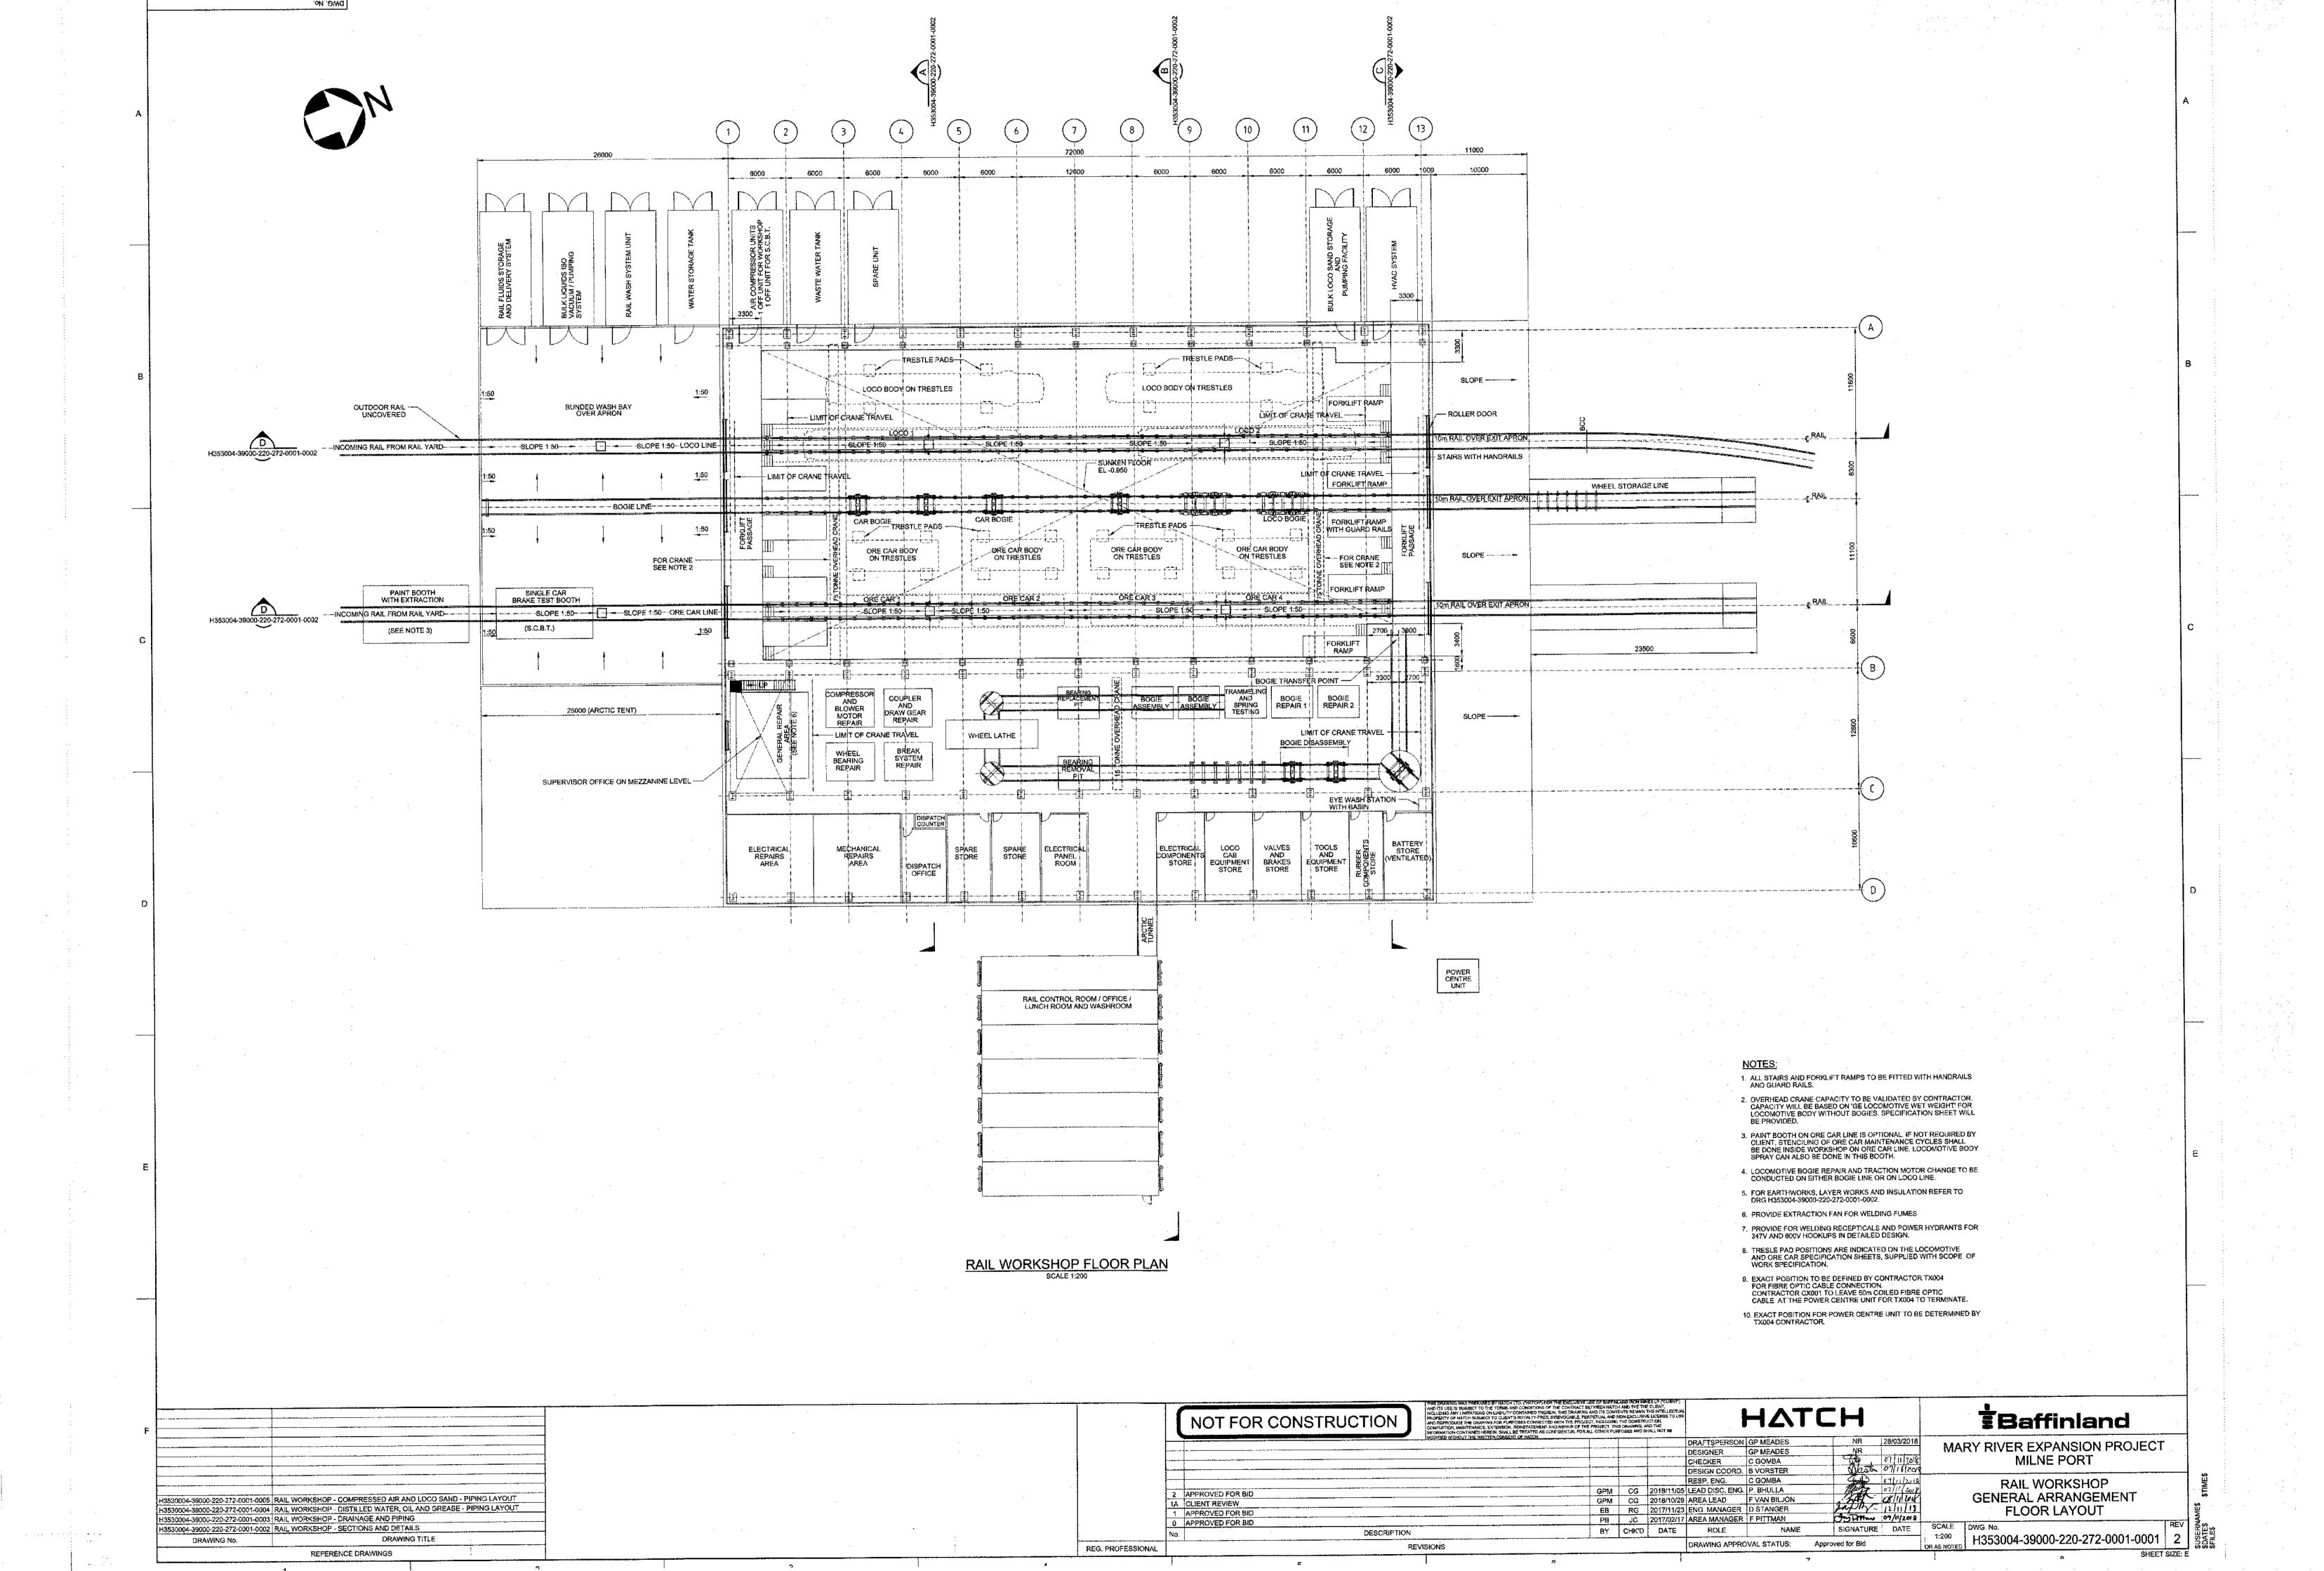

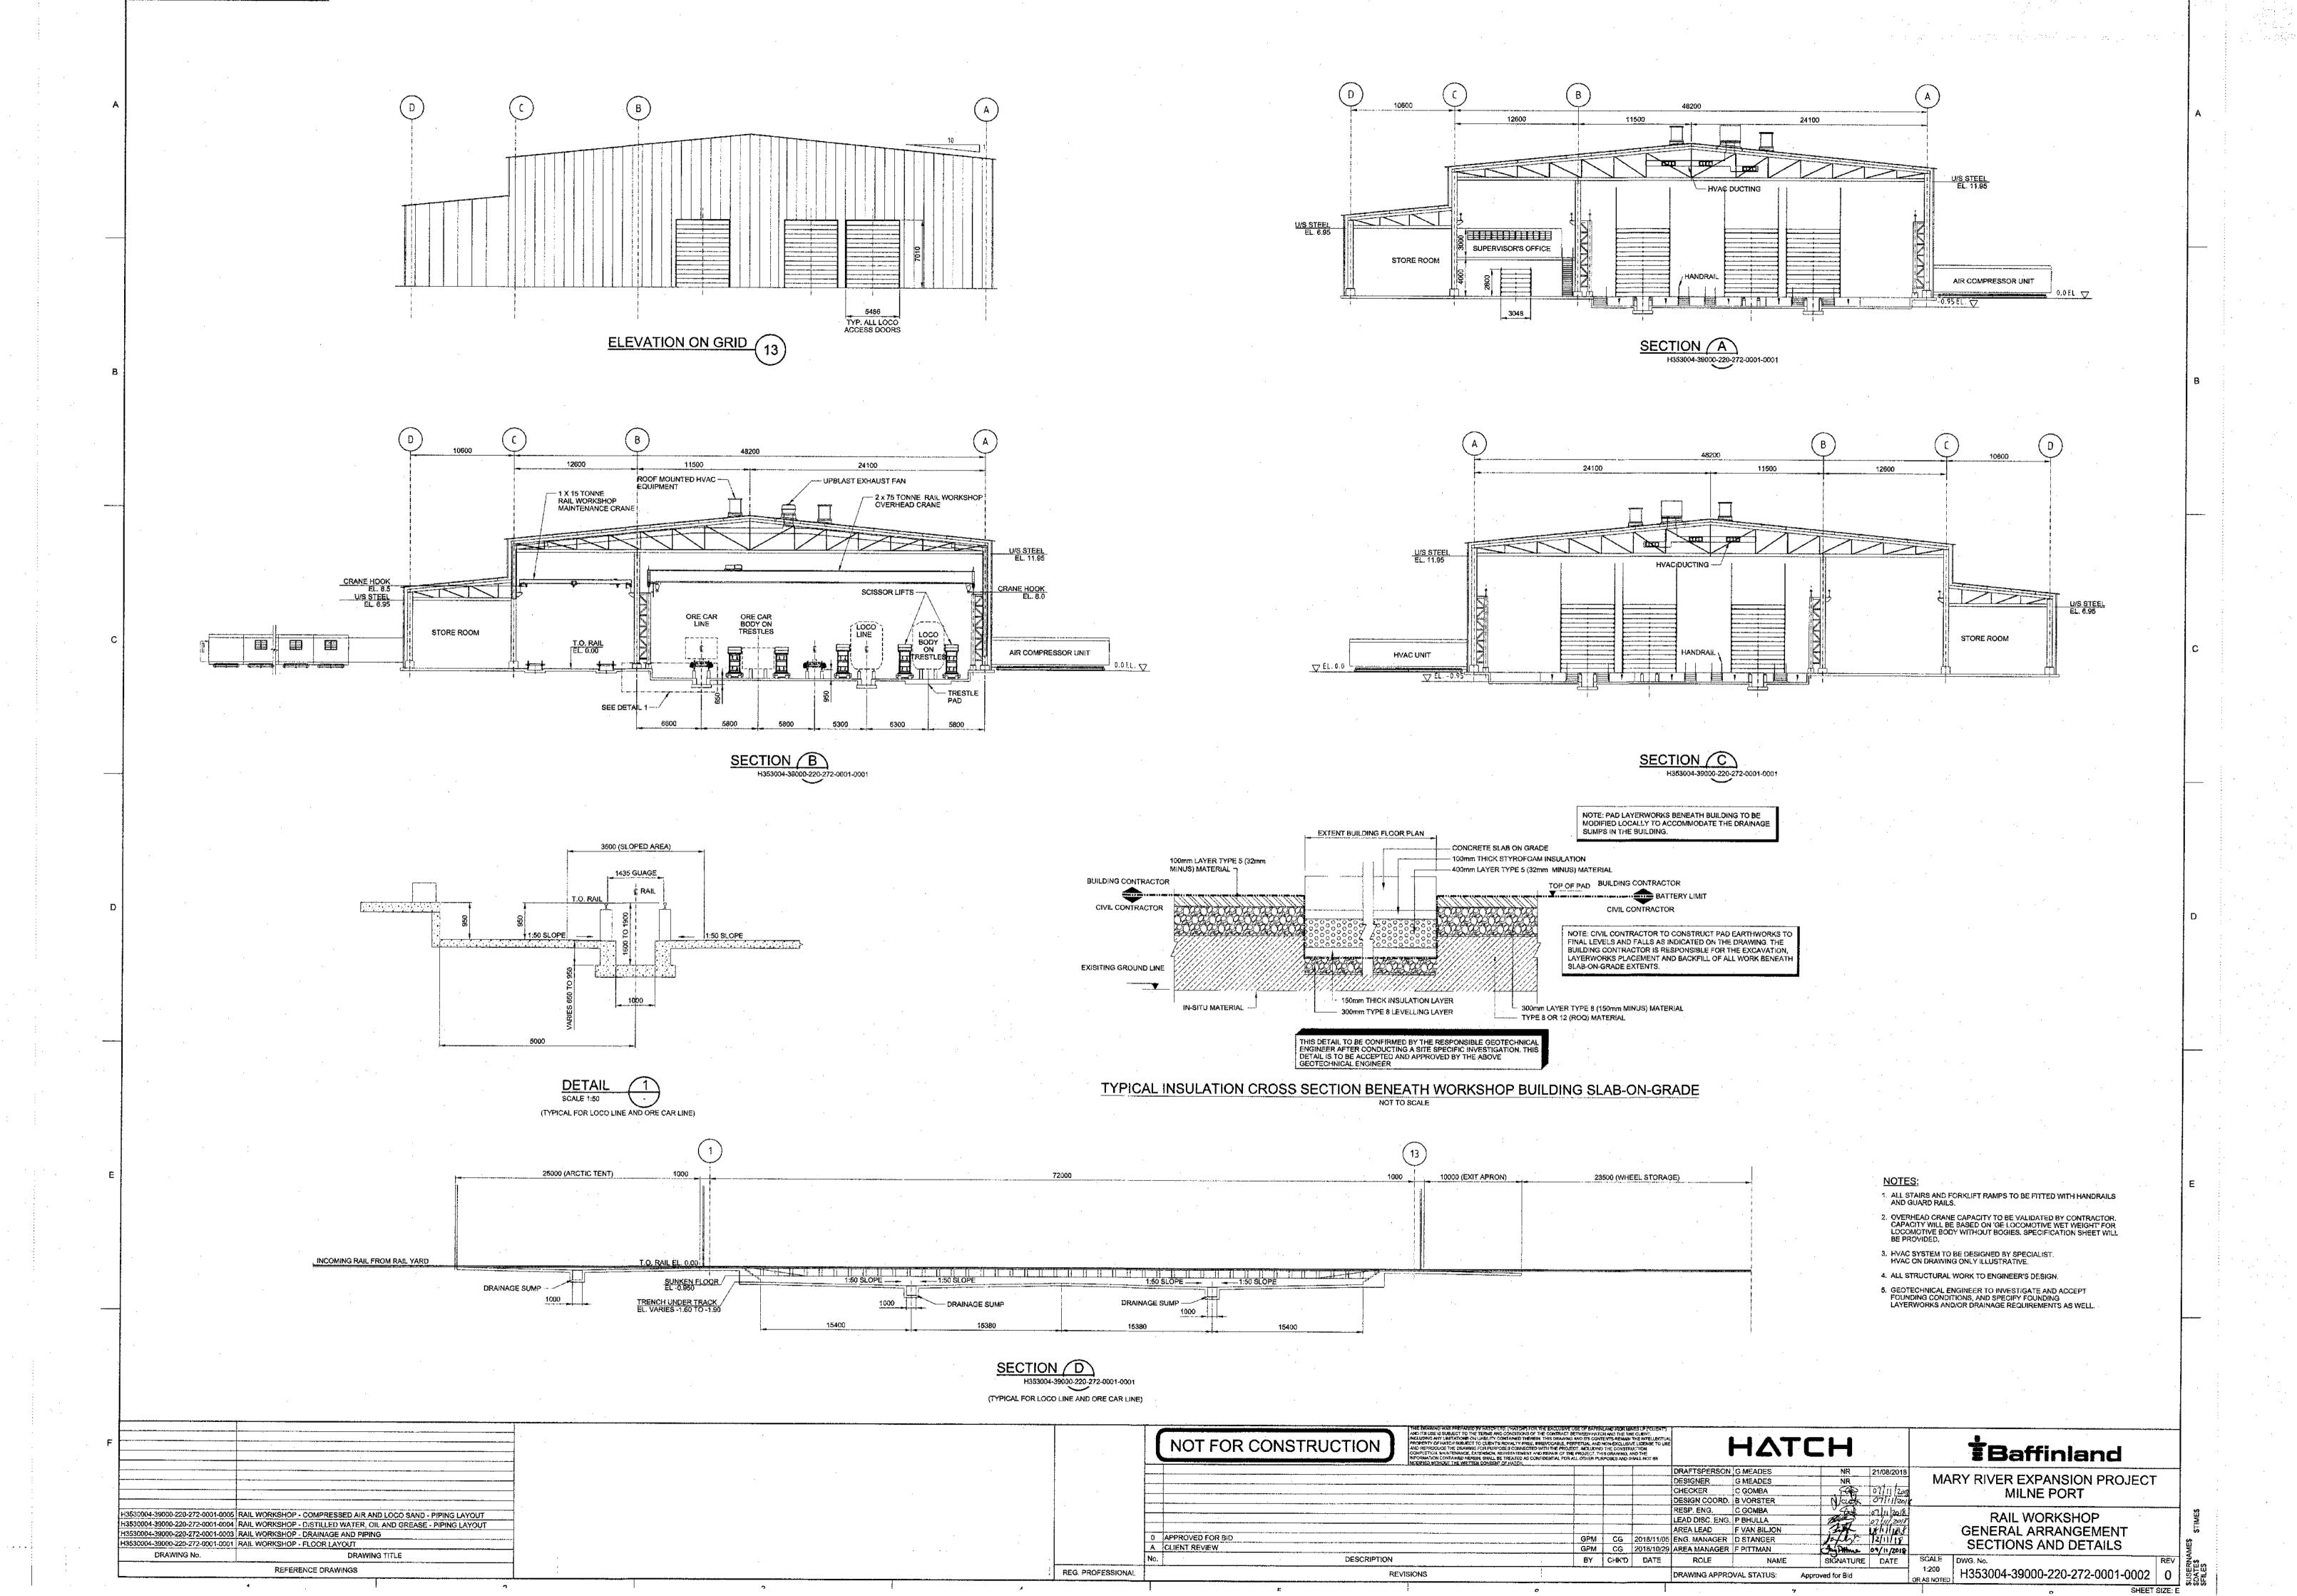

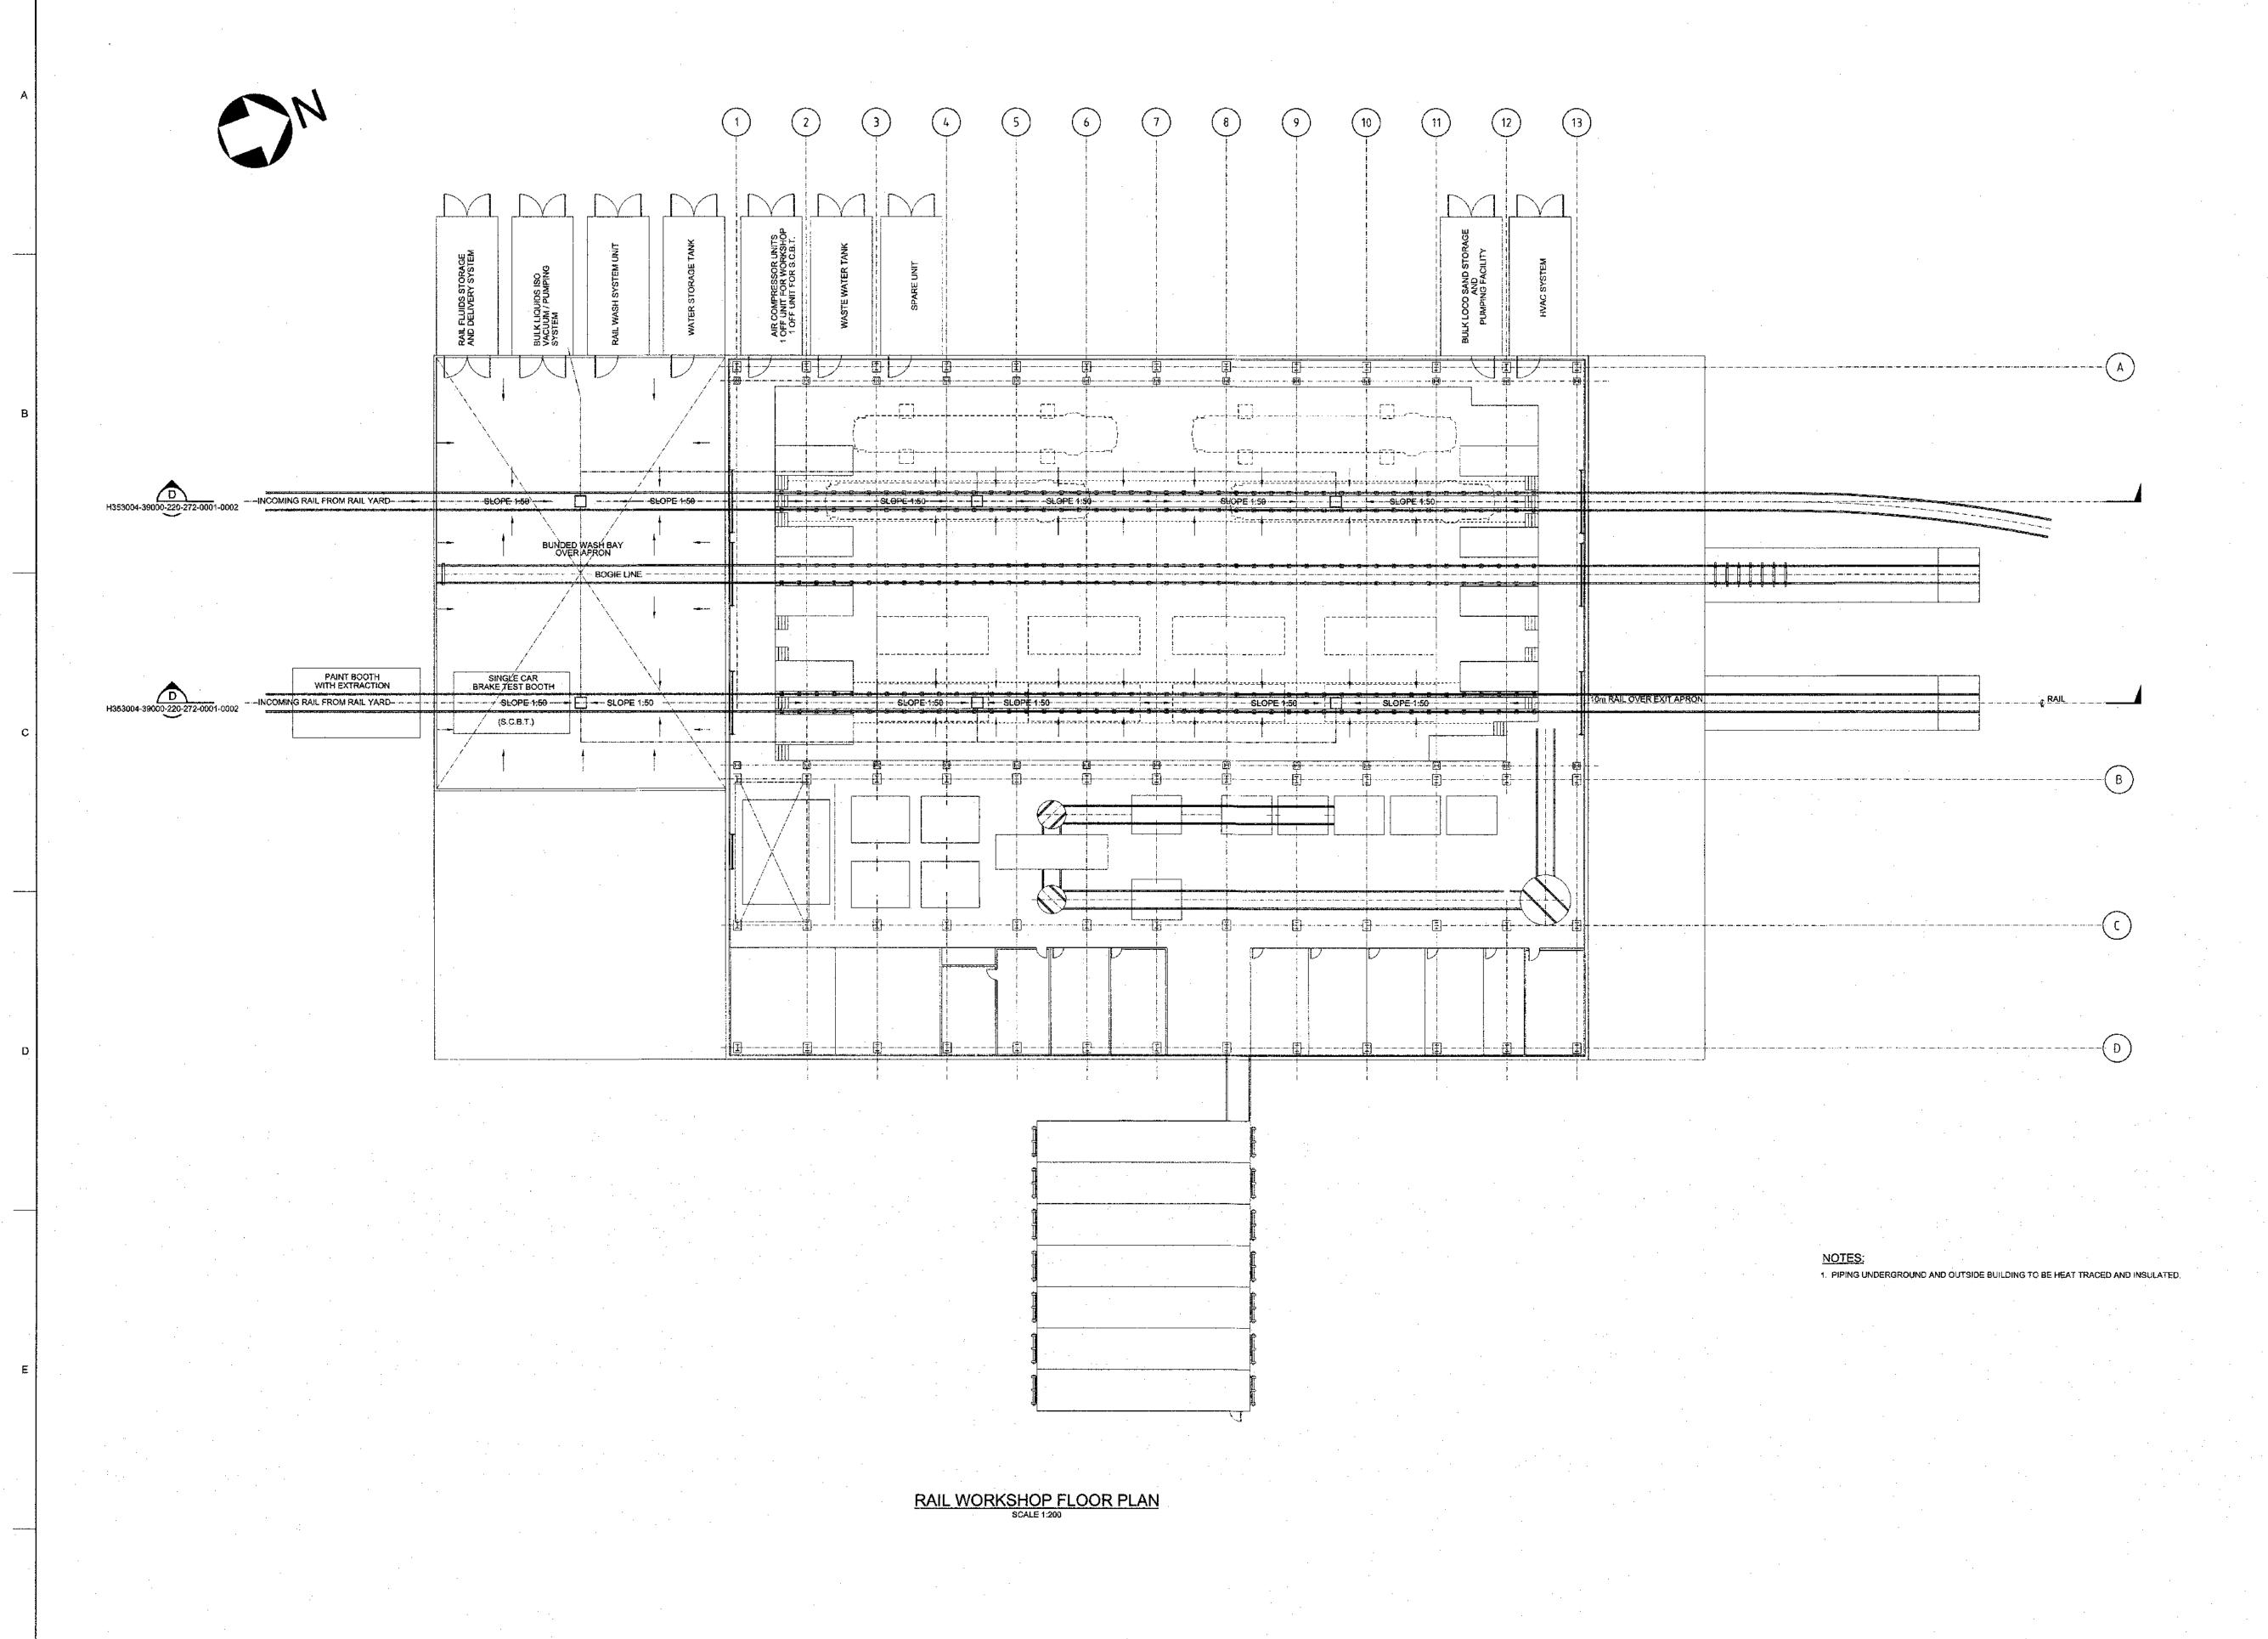

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|--|---|-------------------|--|---|---------------------------------------|----------------|----------------------|---------------------------------------|
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| | | | | | DRAFTSPERSON C | MEADES | NR 22/10/2018 | 14 DV DD ED EVD INICION DD 0 18 08 |
| | | | | | | MEADES | NR | MARY RIVER EXPANSION PROJECT |
| | | | | | CHECKER C | GOMBA | 5 CAD, 07 11/2018 | MILNE PORT |
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| | | | | | RESP. ENG. | GOMBA | 971 07111Rol8 | DAU MODION |
| 0004-39000-220-272-0001-0005 RAIL WORKSHOP - COMPRESSED AIR AND LOCO SAND - PIPING LAYOUT | | | The state of the s | 1 | LEAD DISC, ENG. L | GRESSE | 1.6 - 2/u/ia | RAIL WORKSHOP |
| 0004-39000-220-272-0001-0004 RAIL WORKSHOP - DISTILLED WATER, OIL AND GREASE - PIPING LAYOUT | | | | | AREA LEAD F | VAN BILJON | Int. 9/1/201 | GENERAL ARRANGEMENT |
| 0004-39000-220-272-0001-0002 RAIL WORKSHOP - SECTIONS AND DETAILS | | | 0 APPROVED FOR BID | GPM CG 2018 | 8/11/05 ENG. MANAGER D | STANGER | Jan 1211118 | DRAINAGE AND PIPING |
| 0004-39000-220-272-0001-0001 RAIL WORKSHOP - FLOOR LAYOUT | | | A CLIENT REVIEW | GPM CG 2018 | 8/10/29 AREA MANAGER F | | Aug Dithun 9/11/2018 | DRAINAGE AND PIPING |
| DRAWING No. DRAWING TITLE | | | No. DESCRIPTIO | N BY CHK'D DA | ATE ROLE | NAME | SIGNATURE DATE | SCALE DWG. No. |
| REFERÊNCE DRAWINGS | ! | REG. PROFESSIONAL | ! | REVISIONS | DRAWING APPROV | AL STATUS: App | roved for Bid | 1:200 H353004-39000-220-272-0001-0003 |
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Baffinland HATCH NOT FOR CONSTRUCTION MARY RIVER EXPANSION PROJECT MILNE PORT RAIL WORKSHOP DISTILLED WATER, OIL AND GREASE PIPING LAYOUT 13530004-39000-220-272-0001-0005 RAIL WORKSHOP - COMPRESSED AIR AND LOCO SAND - PIPING LAYOUT H3530004-39000-220-272-0001-0003 RAIL WORKSHOP - DRAINAGE AND PIPING 0 APPROVED FOR BID
A CLIENT REVIEW 530004-39000-220-272-0001-0002 RAIL WORKSHOP - SECTIONS AND DETAILS H3530004-39000-220-272-0001-0001 RAIL WORKSHOP - FLOOR LAYOUT SCALE 1:200 DWG. No. REV H353004-39000-220-272-0001-0004 0 DESCRIPTION BY CHKD DATE ROLE NAME DRAWING TITLE DRAWING No. DRAWING APPROVAL STATUS: Approved for Bid REVISIONS REG. PROFESSIONAL REFERENCE DRAWINGS
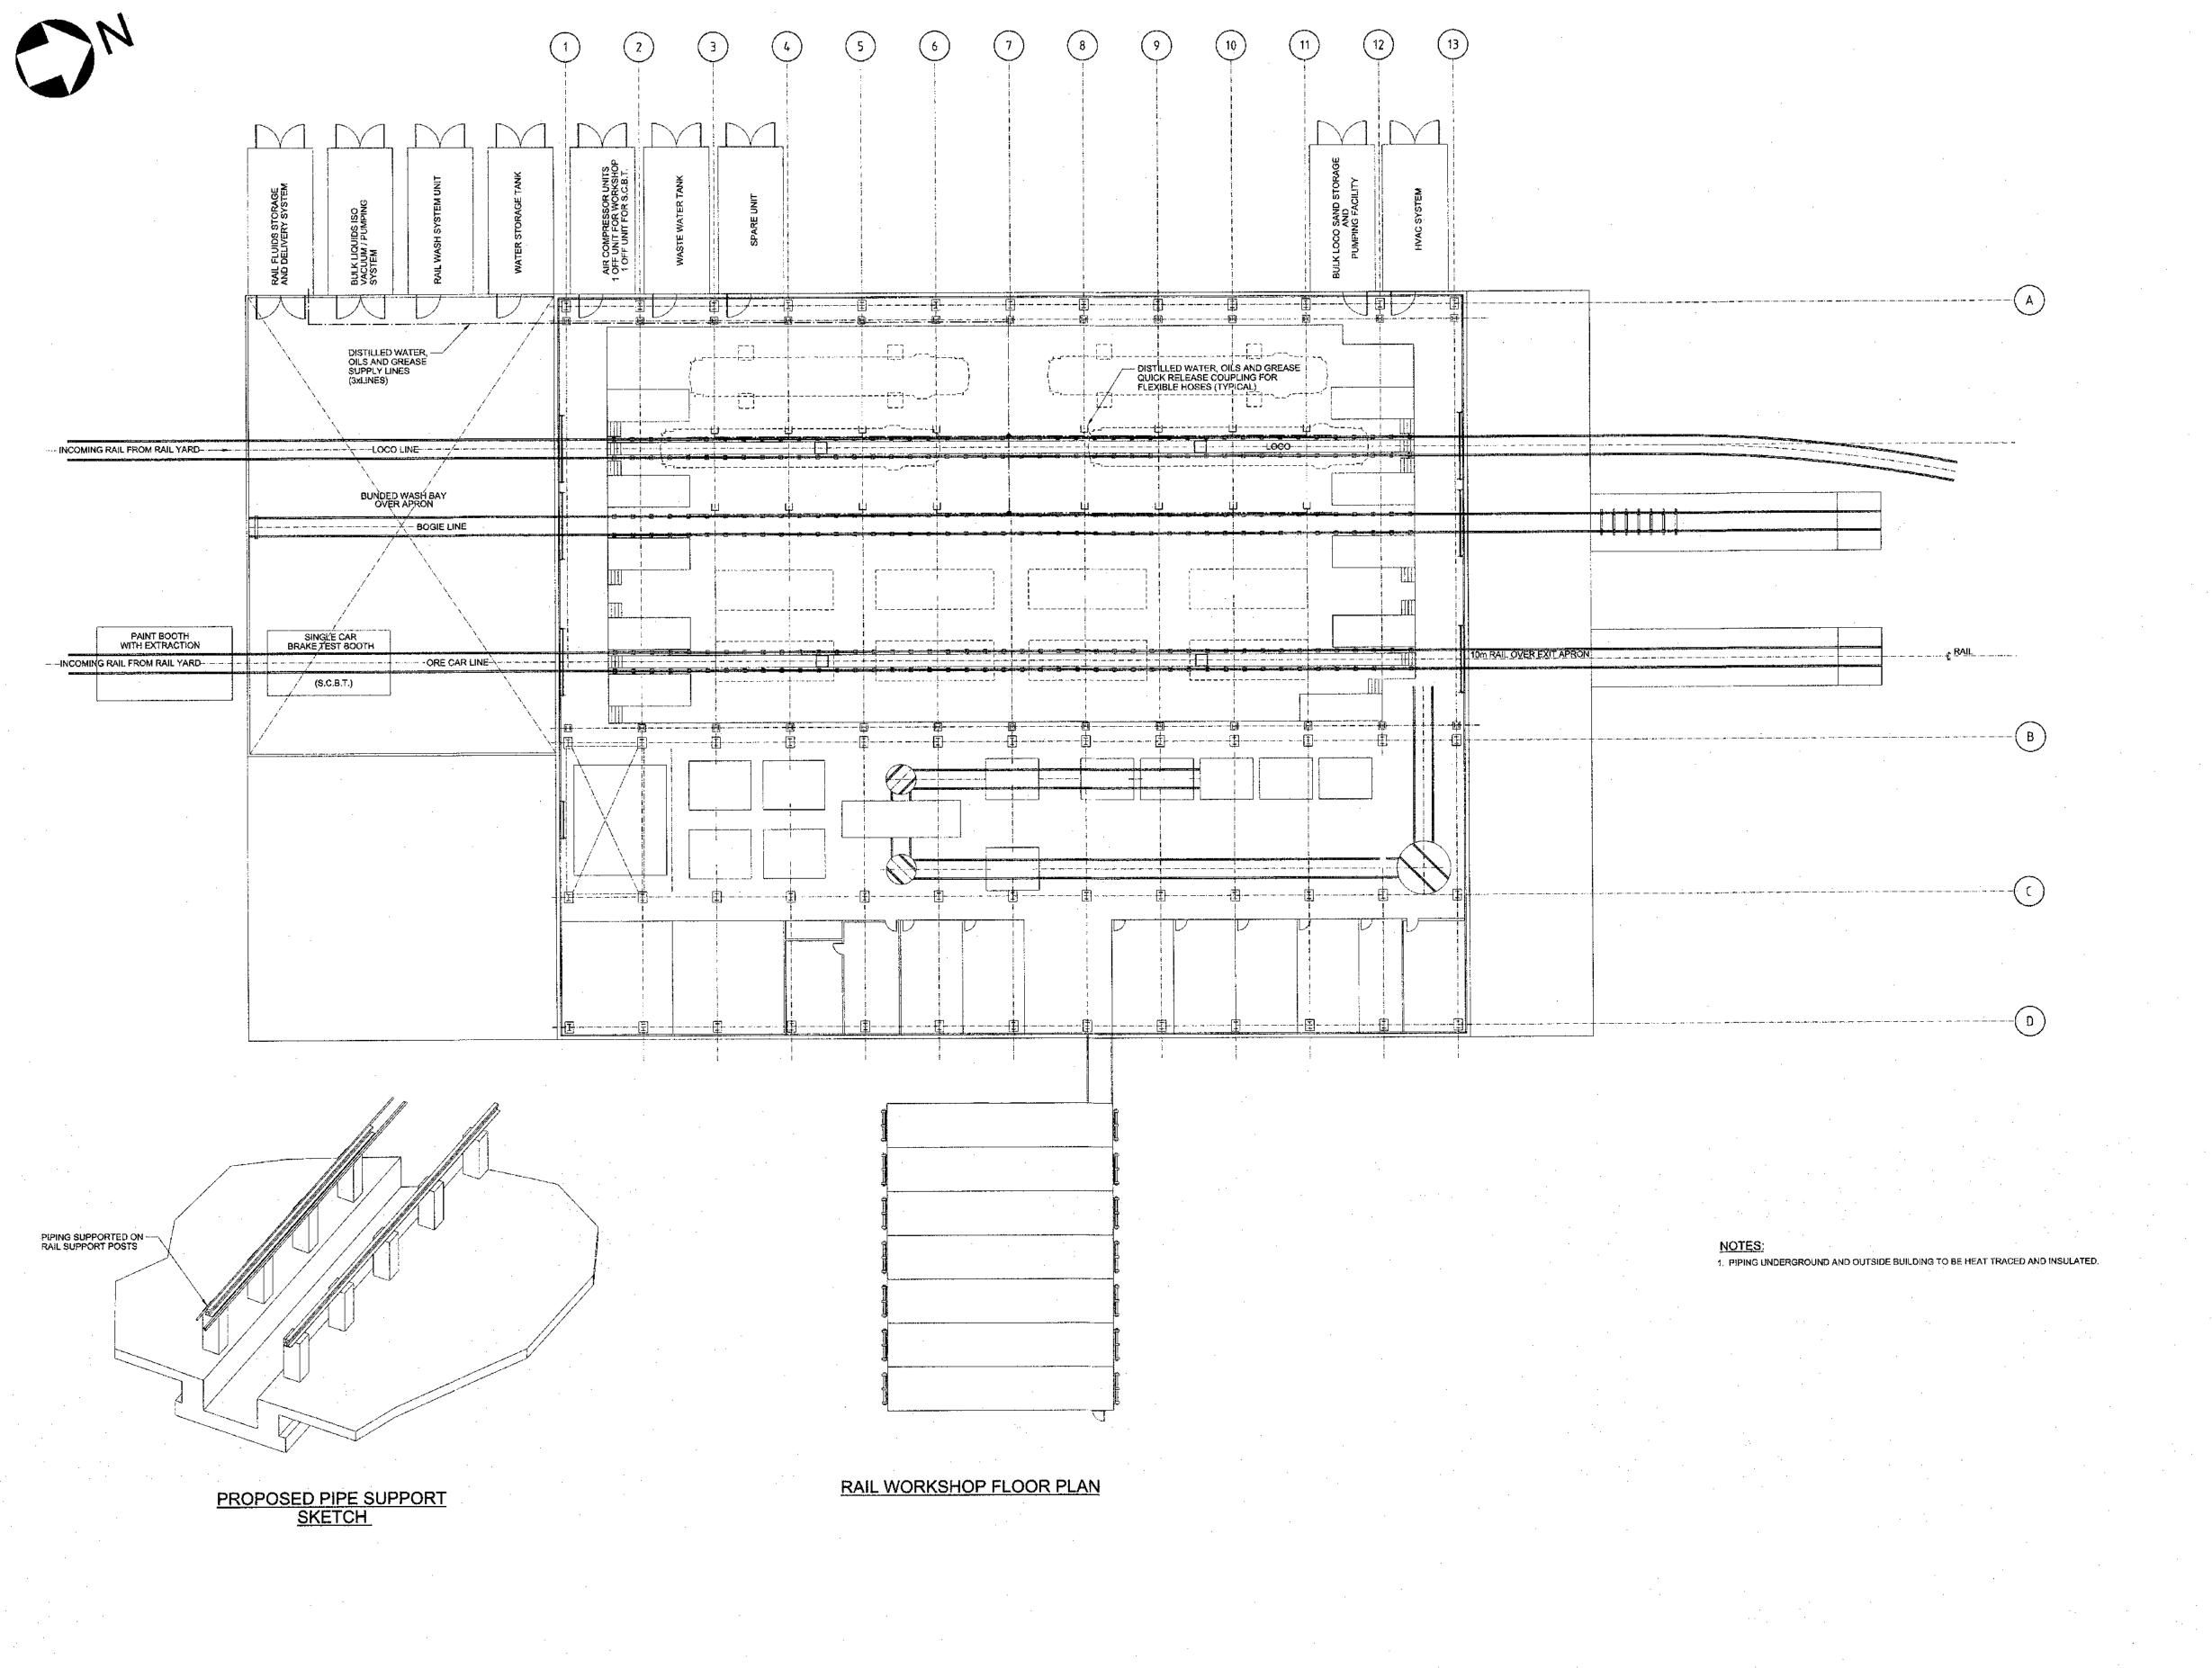
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