



Baffinland Iron Mines LP Mary River Expansion Project

Construction Summary Report: 386p Camp

PERMIT TO PRACTICE

Signature_

Date APRIL 30, 2020 PERMIT NUMBER: P 512

The Association of Professional Engineers, Geologists and Geophysicists of NWT/NU



	Client					
Date	Rev.	Status	Prepared By	Checked By	Approved By	Approved By
2020-04-30	0	Approved for Use	G. Peace	N. Mason -	N. Mason	D. Henkelman
			Sheva	high More	hillows	Denton Digitally signed by Denton Henkelman Date: 2020.04.30 13:45:33 -04'00'





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Map to Show Construction in Relation to Lease Boundaries and Water Bodies





1. Facility Description

1.1 Purpose and Design Basis

Baffinland Iron Mines Corporation (Baffinland) has added a 386 person (386p) accommodation camp at Milne Port. Raw water is trucked to feed the Potable Water Treatment Plant (PWTP) and fire water storage tanks. Potable water is stored in Potable Water storage tanks. Waste water is pumped to a Waste Water Treatment Plant (WWTP) which produces a cake for disposal and effluent that is trucked to the discharge point. The fire water tanks feed the fire water pumps which feed the fire water system.

The camp and associated works were designed and constructed to the following codes and standards.

- National Building Code of Canada (NBC) 2010.
- ANSI B31.3-2010.
- Nunavut Mine Health and Safety Act.
- Nunavut Mine Health and Safety Regulations.
- Nunavut Electrical Protection Act.
- Nunavut Electrical Protection Regulations.

1.2 Location and Base Elevations

The new 386p Camp is located on the west side of the Tote Road between northing N7974974 and N7975280, and easting E503241 and E503424 at elevation 13 meters above sea level (masl).

1.3 Geometry and Access

The 386p Camp is accessible from the Tote Road.

1.4 Earthworks Materials Details

The 386p Camp pad was constructed to meet the elevation requirements of the design. Details of the earthworks can be found in Appendix B.

2. Construction Activity Summary

Construction activities for the 386p camp commenced in April of 2017 with the camp pad. On February 3, 2019 work started on preparation of floor panels. Construction activities were completed on December 11, 2019.





The following summarizes construction activities:

2.1 Pad preparation

- Snow and ice was cleared.
- · High areas were cut to grade.
- Compaction of the existing ground was completed.
- Run of Quarry (ROQ) fill was placed.
- A variety of crushed materials were sourced from Baffinland and placed to level the subgrade.
- Surfacing material was placed to bring to final grade.

2.2 Foundations

Floor panels were placed.

2.3 Erection of camp structures

- Started camp installation with the erection of "A" wing.
- WWTP and PWTP were placed.
- Continued erection of remaining wings, arctic corridor and the core.
- Boot room, gym and training units were placed.

2.4 Building services

- Potable water supply was installed.
- Waste water system was installed.
- Fire alarm system was installed.
- Sprinkler system was installed.

2.5 Power

- Cabling was installed from main power supply.
- Transformers were installed and hooked up.

3. QA/QC

Quality Assurance (QA) was performed by the Hatch Construction Supervisor during daily audits with the Nuna/ADCO, Nuna and/or the Horizon North Supervisor during the construction. Quality Surveillance Inspection Acceptance and Sign-off Reports were prepared by the Nuna/ADCO Supervisor, Nuna Supervisor and/or Horizon North Supervisor and signed of by the Hatch Representative. Quality reports are included as part of the turnover packages in Appendix B and Appendix C.





4. Photographic Records



Photo 4-1: Camp Pad



Photo 4-2: Floor Panel Construction





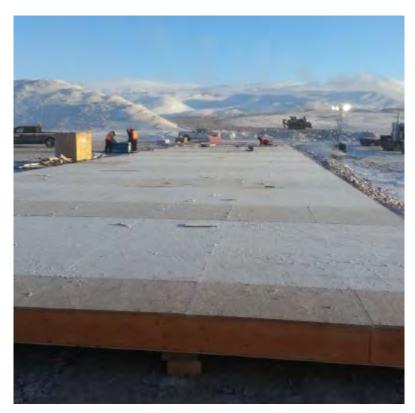


Photo 4-3: Floor Panel Placement



Photo 4-4: Prefab Shop







Photo 4-5: A Dorm Installed



Photo 4-6: Dorm Wall Installation







Photo 4-7: A Dorm Room



Photo 4-8: Arctic Corridor







Photo 4-9: Power Supply Cables



Photo 4-10: Stairs and Landing







Photo 4-11: Dining Room



Photo 4-12: Transformer Containment







Photo 4-13: Water Storage Tank

5. As-built Drawings

The as-built drawings incorporate contractor red line markups, field instructions, requests for information, field sketches and all other inputs provided by the Engineering, Procurement and Construction Management (EPCM) field team. As-built drawings are attached in Appendix A. These drawings are representative of the final as-built conditions.

Table 5-1: As-built Drawing List

Drawing Number	Title
AF-000-010	386p Camp Site Plan
SM 17064 MPCP Crush Surface	386p Camp Surface As-built
E-000-002	Electrical Distribution Schematic Sheet 1
E-000-001	Electrical Distribution Schematic Sheet 2
E2.2	Electrical 16 Unit (Skid) "Kitchen/Diner"
E2.1	Electrical Layout 36 Room Dorm
E2.0	Electrical Layout 50 Room Dorm
E3.0	Electrical Schedule
FAS150701B	Fire Alarm Plan
FAS150702A	Fire Alarm Riser Diagram
E150801B	Fire Suppression As-built Sheet 1
E150802B	Fire Suppression As-built Sheet 2
E150803B	Fire Suppression As-built Sheet 3
E150804B	Fire Suppression As-built Sheet 4





Drawing Number	Title
E150805B	Fire Suppression As-built Sheet 5
M2.0	Main Floor HVAC Layout 36 Person Complex
M2.1	Main Floor HVAC Layout 50 Person Complex
M1.0	Mechanical Cover Page
	Potable and Waste Water Infrastructure
	PWTP Electrical Legend
	PWTP P&ID Inlet
	PWTP P&ID Legend
	PWTP P&ID Outlet
	PWTP PLC Layout
	PWTP Single Line Diagram 120V
	PWTP Single Line Diagram 600V
	PWTP System Layout Sheet 1
	PWTP System Layout Sheet 2
	WWTP feed from Receiving Station (RS)
214.09.P07	WWTP P&IDs Chemical Addition and Membrane Backpulse Skid
214.09.P02	WWTP Piping and Instrumentation Diagrams (P&IDs) Legend
214.09.P04	WWTP P&IDs Membrane Filtration
214.09.P01	WWTP P&IDs Raw Sewage Equalization
214.09.P05	WWTP P&IDs Sludge Holding and Recycle
214.09.P06	WWTP P&IDs UV Disinfection and Final Effluent

6. Field Decisions

The following section describes field decisions made during construction:

- Type 8 material (150 mm minus) was not available during camp pad construction. Run of Quarry (ROQ) was substituted for the Type 8.
- The orientation of the boot room, gym and training room units was changed due to access considerations.
- Addition of a waste water receiving tank (RT) to regulate flow to the WWTP.

7. Performance Evaluation

There have been frequent spills at the WWTP. This was addressed by the installation of a receiving tank to help even out the flow to the WWTP.

8. Vibration Monitoring and Quarrying Activity

No vibration monitoring was conducted during the construction of this work as it was not deemed necessary based on the scope of activities required for construction.

9. Environmental Monitoring

Baffinland Environment was responsible for environmental monitoring at the site during this work and following-up with construction if there were any reported environmental incidents or non-conformances.





The Spill contingency Plan (BAF-PH1-830-P16-0036), in conjunction with the Emergency Response Plan (BAF-PH1-830-P16-0007), provides guidance and instructions for first responders and Baffinland Management in the event of a spill event or other emergency such as fire or accident.

The risks to the environment as a result of construction activity for this work would originate from spills from equipment or facilities and are described below:

- On July 18, 2019 biological foam overflowed at the WWTP resulting in a small amount contacting the ground. It was immediately cleaned up.
- On July 24, 2019 20 to 30 liters of effluent were spilled when a hose between the effluent truck and the WWTP was disconnected. It was immediately cleaned up.
- On August 12, 2019 there was a sewage overflow at a lift station. It was cleaned up immediately.
- On September 14, 2019 the holding tank at the WWTP overflowed resulting in a spill to the ground. It was cleaned up immediately.
- On September 27, 2019 approximately 1000 litres of foam and liquid over flowed onto the plant floor and the ground outside the WWTP. It was cleaned up immediately.

10. Earthworks Data

See Appendix B for information on the Camp Pad earthworks construction.

11. Unanticipated Observations

Not applicable.

12. Surface Monitoring

Non conducted.

13. Required Maintenance

Not applicable.

14. Adaptive Management

Construction changes were managed through issue of Engineering Change Notices (ECNs) for changes to the design and through Requests for Information (RFIs) for changes requested by the Contractor.

For discussion of adaptive management principles and practices applied and their overall effectiveness please refer to the Annual Report to the Nunavut Water Board and the Nunavut Impact Review Board.





15. Concordance with Type "A" Water Licence

Baffinland's Type A Water Licence, Schedule D, outlines the requirements for Construction Summary/Monitoring Reports. Table 15-1 provides a concordance of this report with the requirements of Schedule D.

Table 15-1: Concordance with Type "A" Water License

Schedule D Item No.	Schedule D Description	Corresponding Section in this Report
1a	Description of all infrastructure and facilities designed and constructed to contain, withhold, divert or retain Water and/or Waste;	1
1b	A summary of construction activities including photographic records before, during and after construction of the facilities and infrastructure designed to contain, withhold, divert or retain Water and/or Waste;	2, 3, 4
1c	As-built drawings and design for facilities and infrastructure, in Item 1(a) of this schedule, designed and constructed to contain, withhold, divert or retain Water and/or Waste;	5 Appendix A
1d	Documentation of field decisions that deviate from the original plans and any data used to support or developed facilities and infrastructure to withhold, divert or retain Water and/or Waste;	6
1e	A comparison of measured versus predicted performance of infrastructure and facilities;	7
1f	Any blast vibration monitoring and control for quarrying activity carried out in close proximity to fish bearing waters;	8
1g	Monitoring conducted for sediment and explosives residue release from construction areas;	9
1h	Monitoring undertaken in accordance with Part D of the Licence during the Construction Phase of the Project;	8, 9
1i	Details confirming that the requirements of the CCME guidance document entitled "Aboveground Storage Tank Systems for Petroleum and Allied Petroleum Products (2003)" have been met by the Licensee;	N/A
1j	Data collected from instrumentation used to monitor earthworks and the interpretation of that data;	12
1k	A discussion of any unanticipated observations including changes in risk and mitigation measures implemented to reduce risk during construction;	11
11	An overview of any method including frequency used to monitor deformations, seepage and geothermal responses;	12
1m	A summary of maintenance work undertaken as a result of settlement or deformation of dikes and dams;	13
1n	A summary of adaptive management principles and practices applied during the relevant phases of the Project and their overall effectiveness.	14





16. Concordance with Commercial Lease Requirements

Table 16-1 provides a concordance of this report with the requirements of the Commercial Lease for As-built reporting.


Table 16-1: Concordance for Commercial Lease As-built Requirements


Component	Minimum Information Requirements	Corresponding Section in this report
1	The name and contact information of the person and company responsible for completing the construction, construction monitoring and preparing the As-built Report	Appendix D
2	The name and contact information of the Baffinland representatives(s) that QIA can contact should it have any questions or comments regarding the As-built Report	Appendix D
3	An introduction to the infrastructure or facilities including but not limited to the construction background, concept and construction history	1,2
4	Construction records including As-built drawings signed and stamped by a professional engineer detailing surveys, planar and cross sections that illustrate all designed components. This should be provided in PDF format and if requested the native file (e.g. CAD, .dxf, etc.)	Appendix A Appendix B Appendix C
5	Detailed description of any deviations from the For Construction Design. Deviations that should be noted include, but are not limited to, changes in design and construction materials, construction methodology or monitoring	6
6	Observed performance of the construction including a comparison to predicted performance. Recommendations for performance monitoring based on observations during construction if applicable	NA
7	A description and list of instrumentation installed, if applicable, and results of construction monitoring including all environmental data. Recommendations for additional performance or environmental monitoring based on observations and monitoring results, if applicable.	NA
8	A summary of quality assurance testing results, if applicable, and comparison of these results to construction/design requirements to ensure performance of the infrastructure or facilities.	3 Appendix B Appendix C
9	A summary of adaptive management principles and practices related to environmental management and monitoring applied during the relevant phases of the Project and their overall effectiveness	NA
10	Photographic records before, during and after construction of the facilities or infrastructure.	4
11	Map(s) to illustrate the completed construction in relation to Lease boundaries and water bodies. The minimum distance from completed or modified facilities and infrastructure to the surveyed boundary of the Property, surveyed boundary of the Impact Area, and the original high water mark should be provided.	Appendix E








Appendix AAs-built Drawings

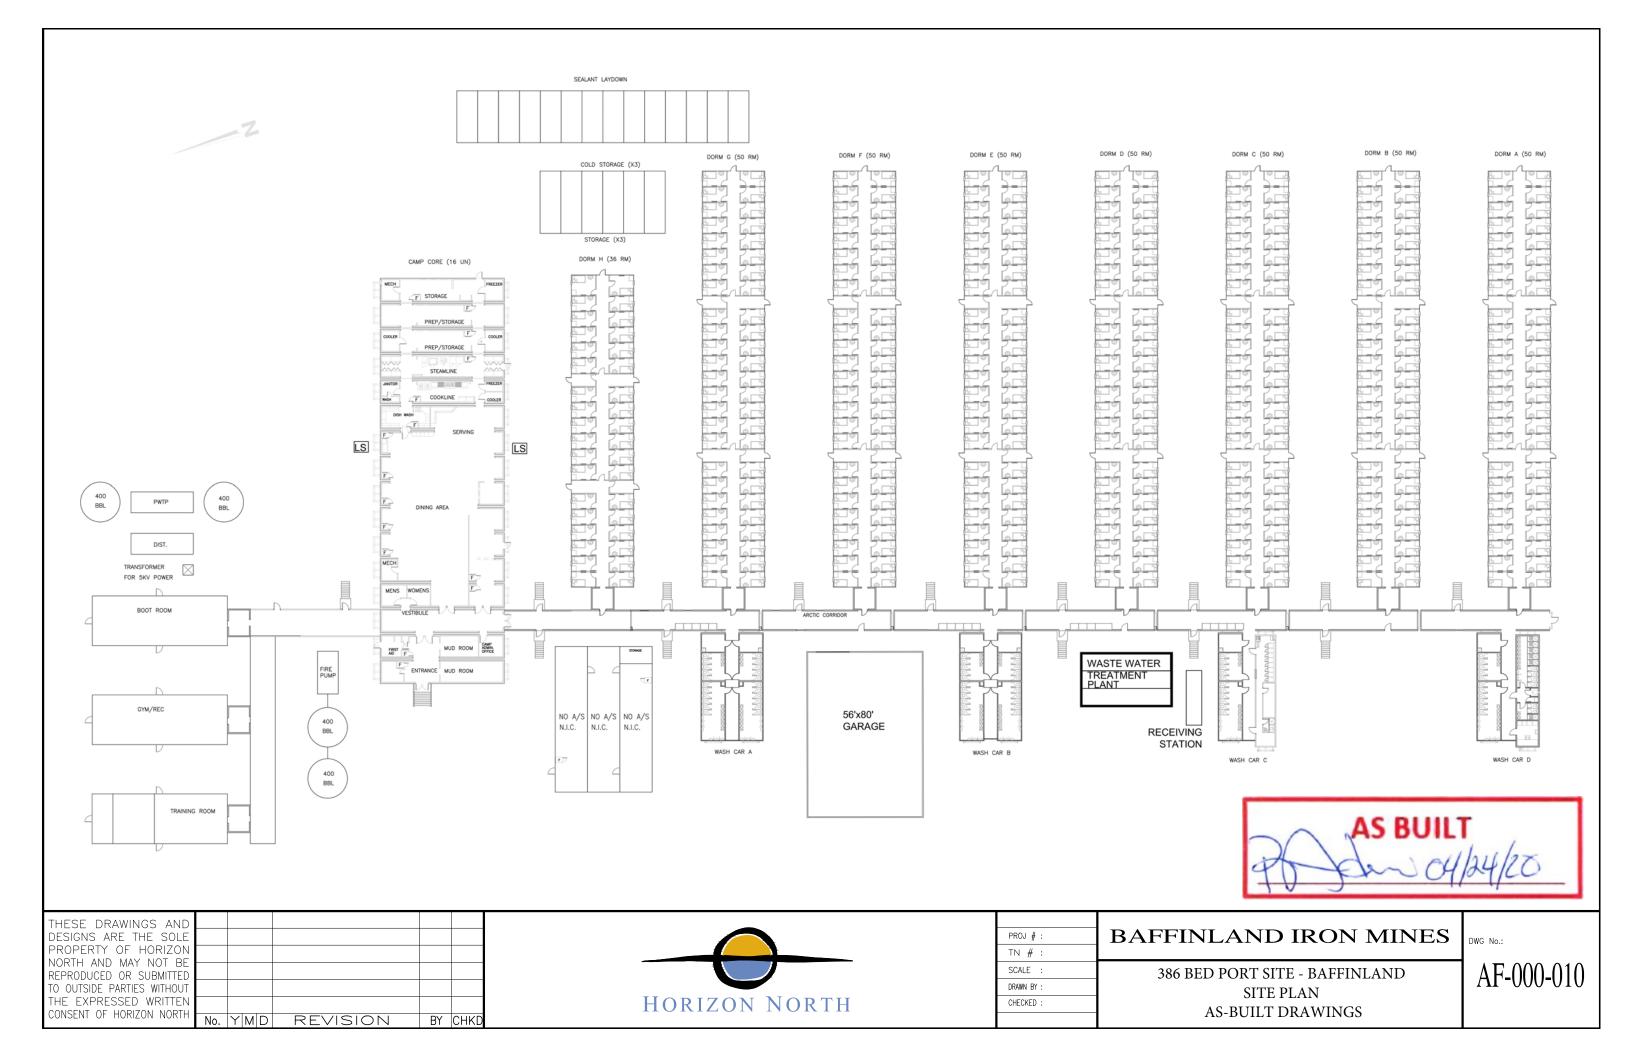

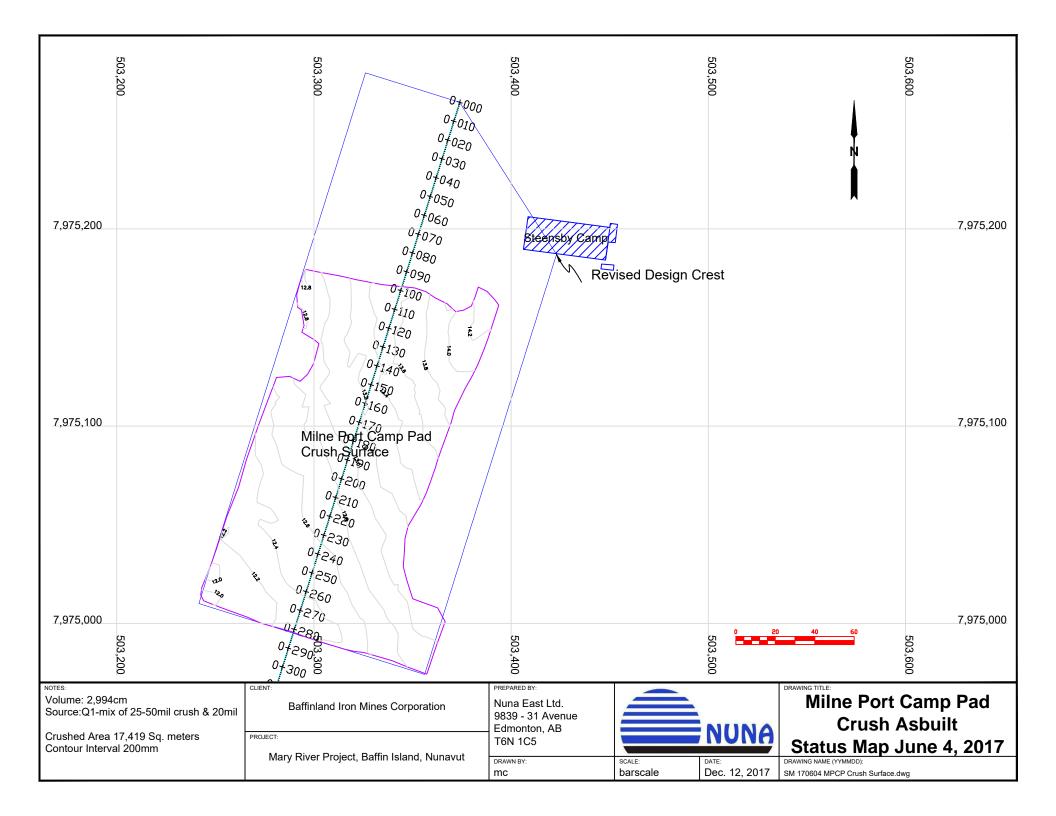

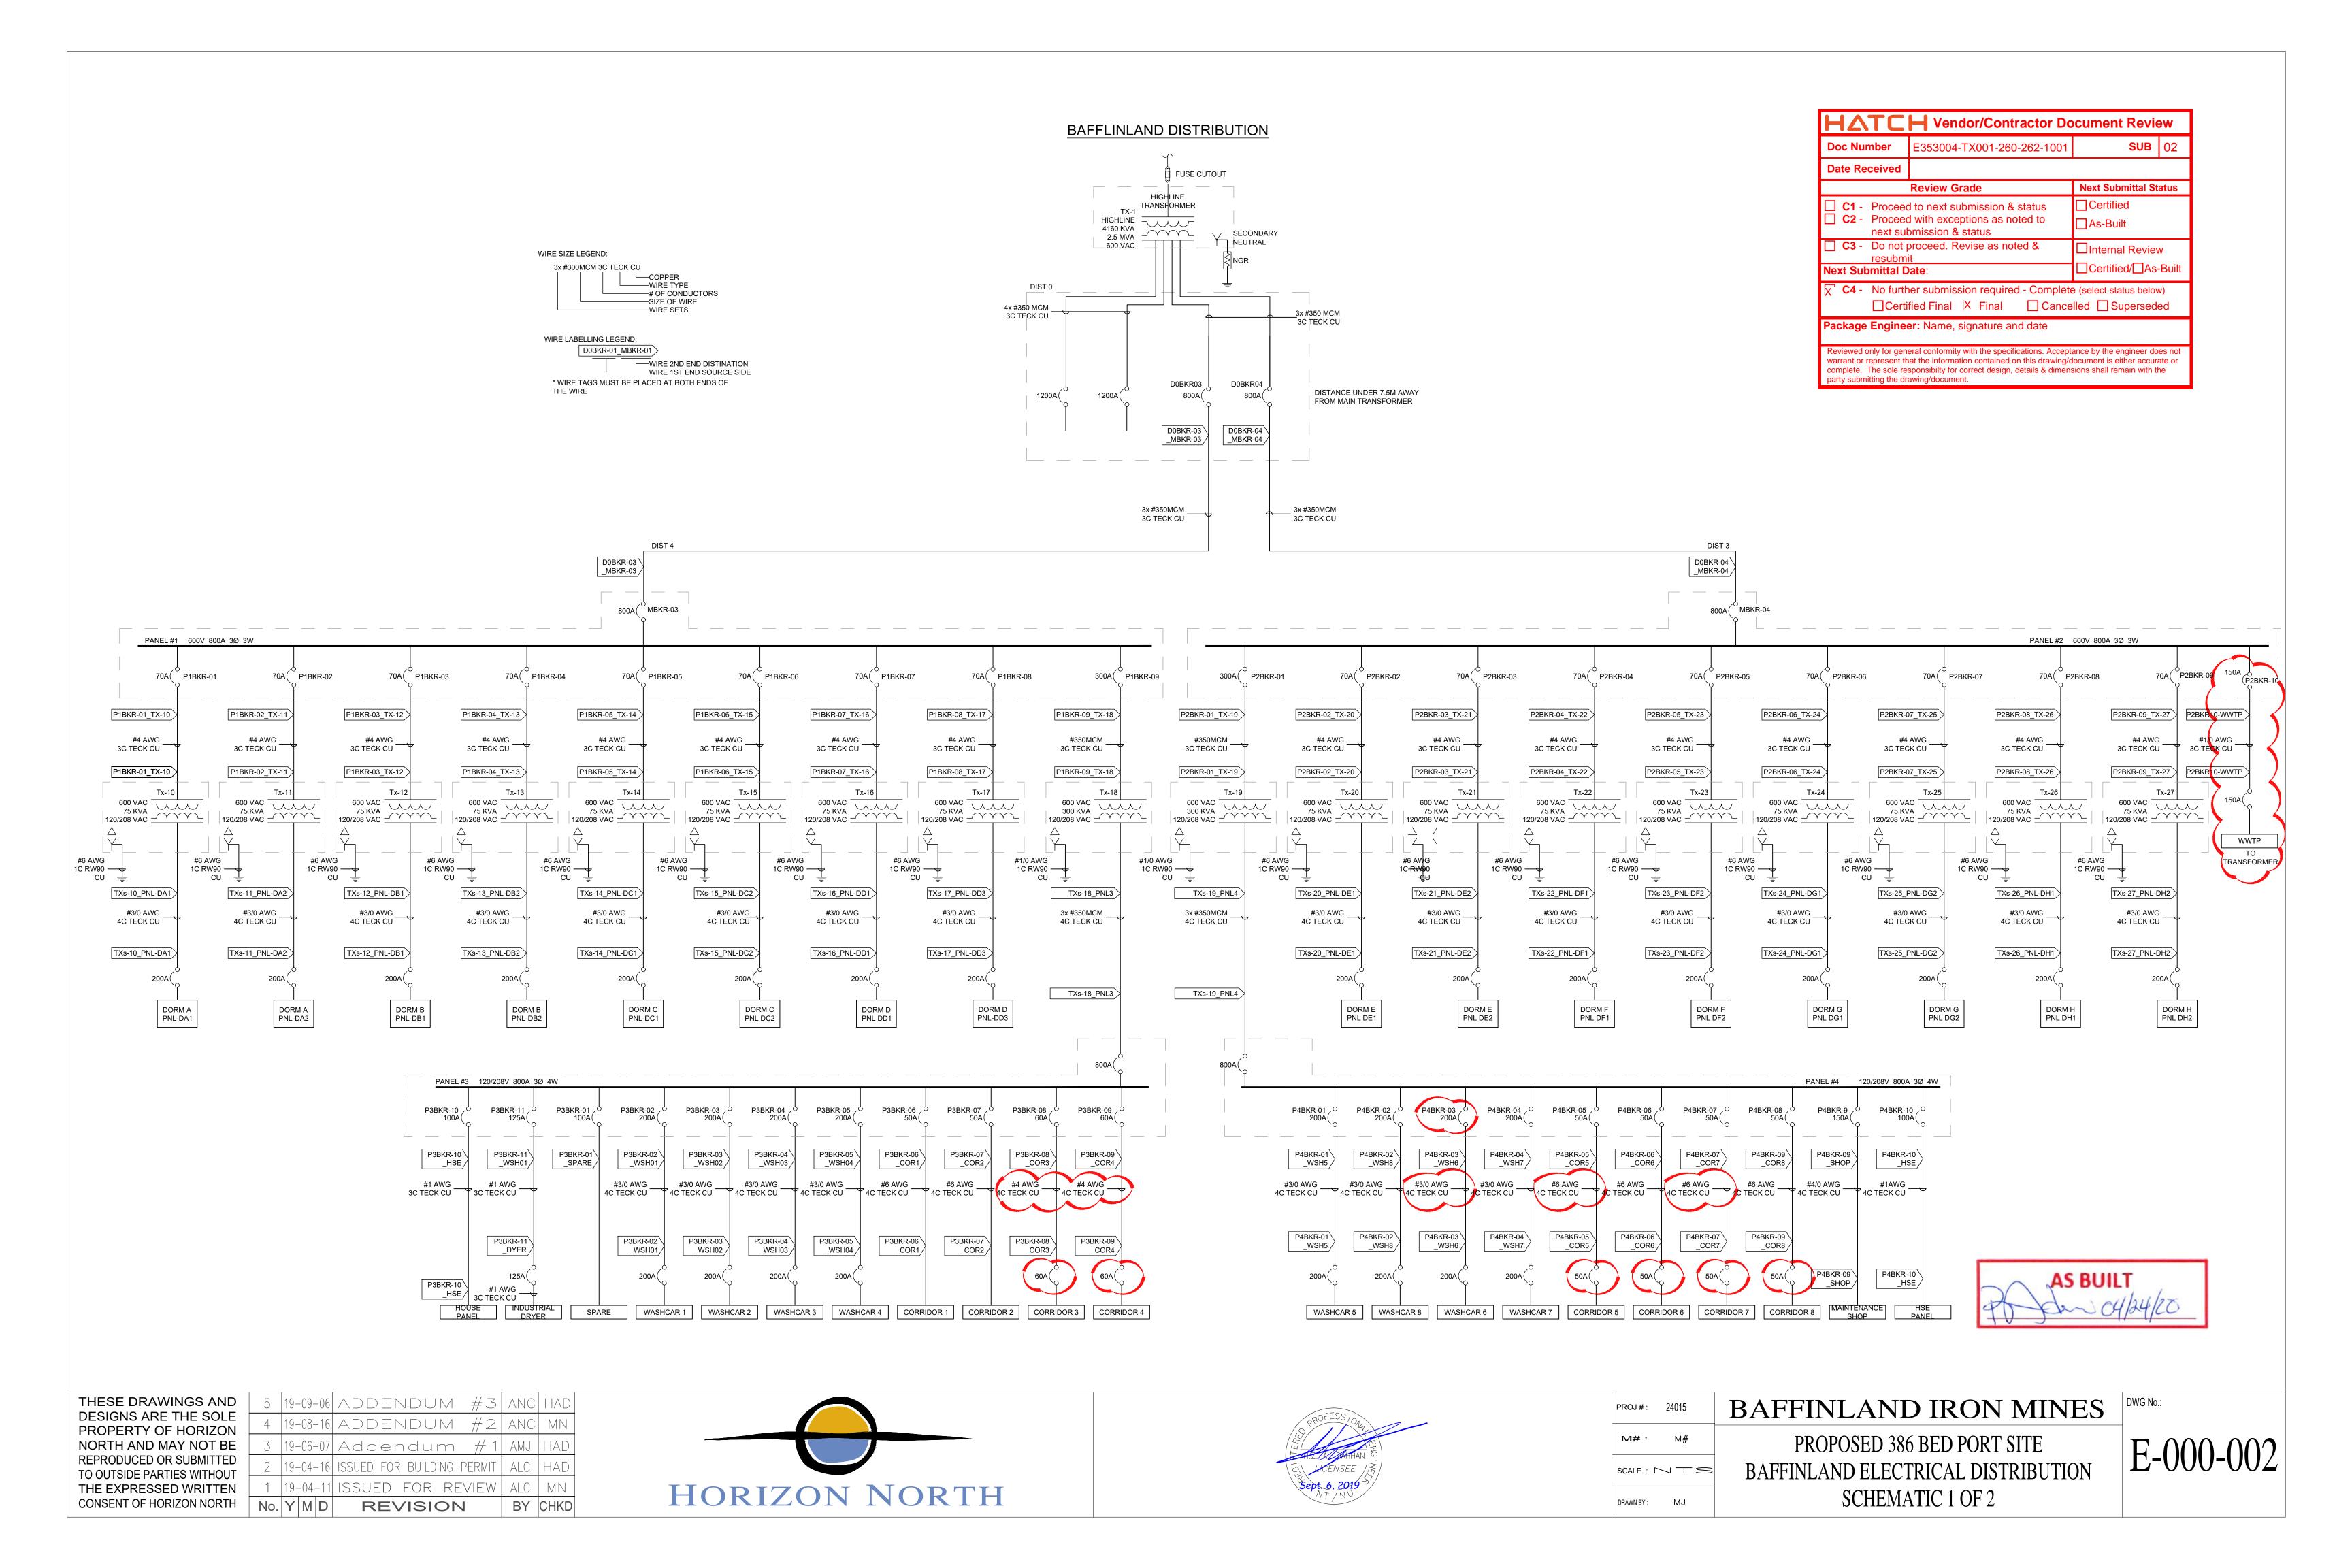

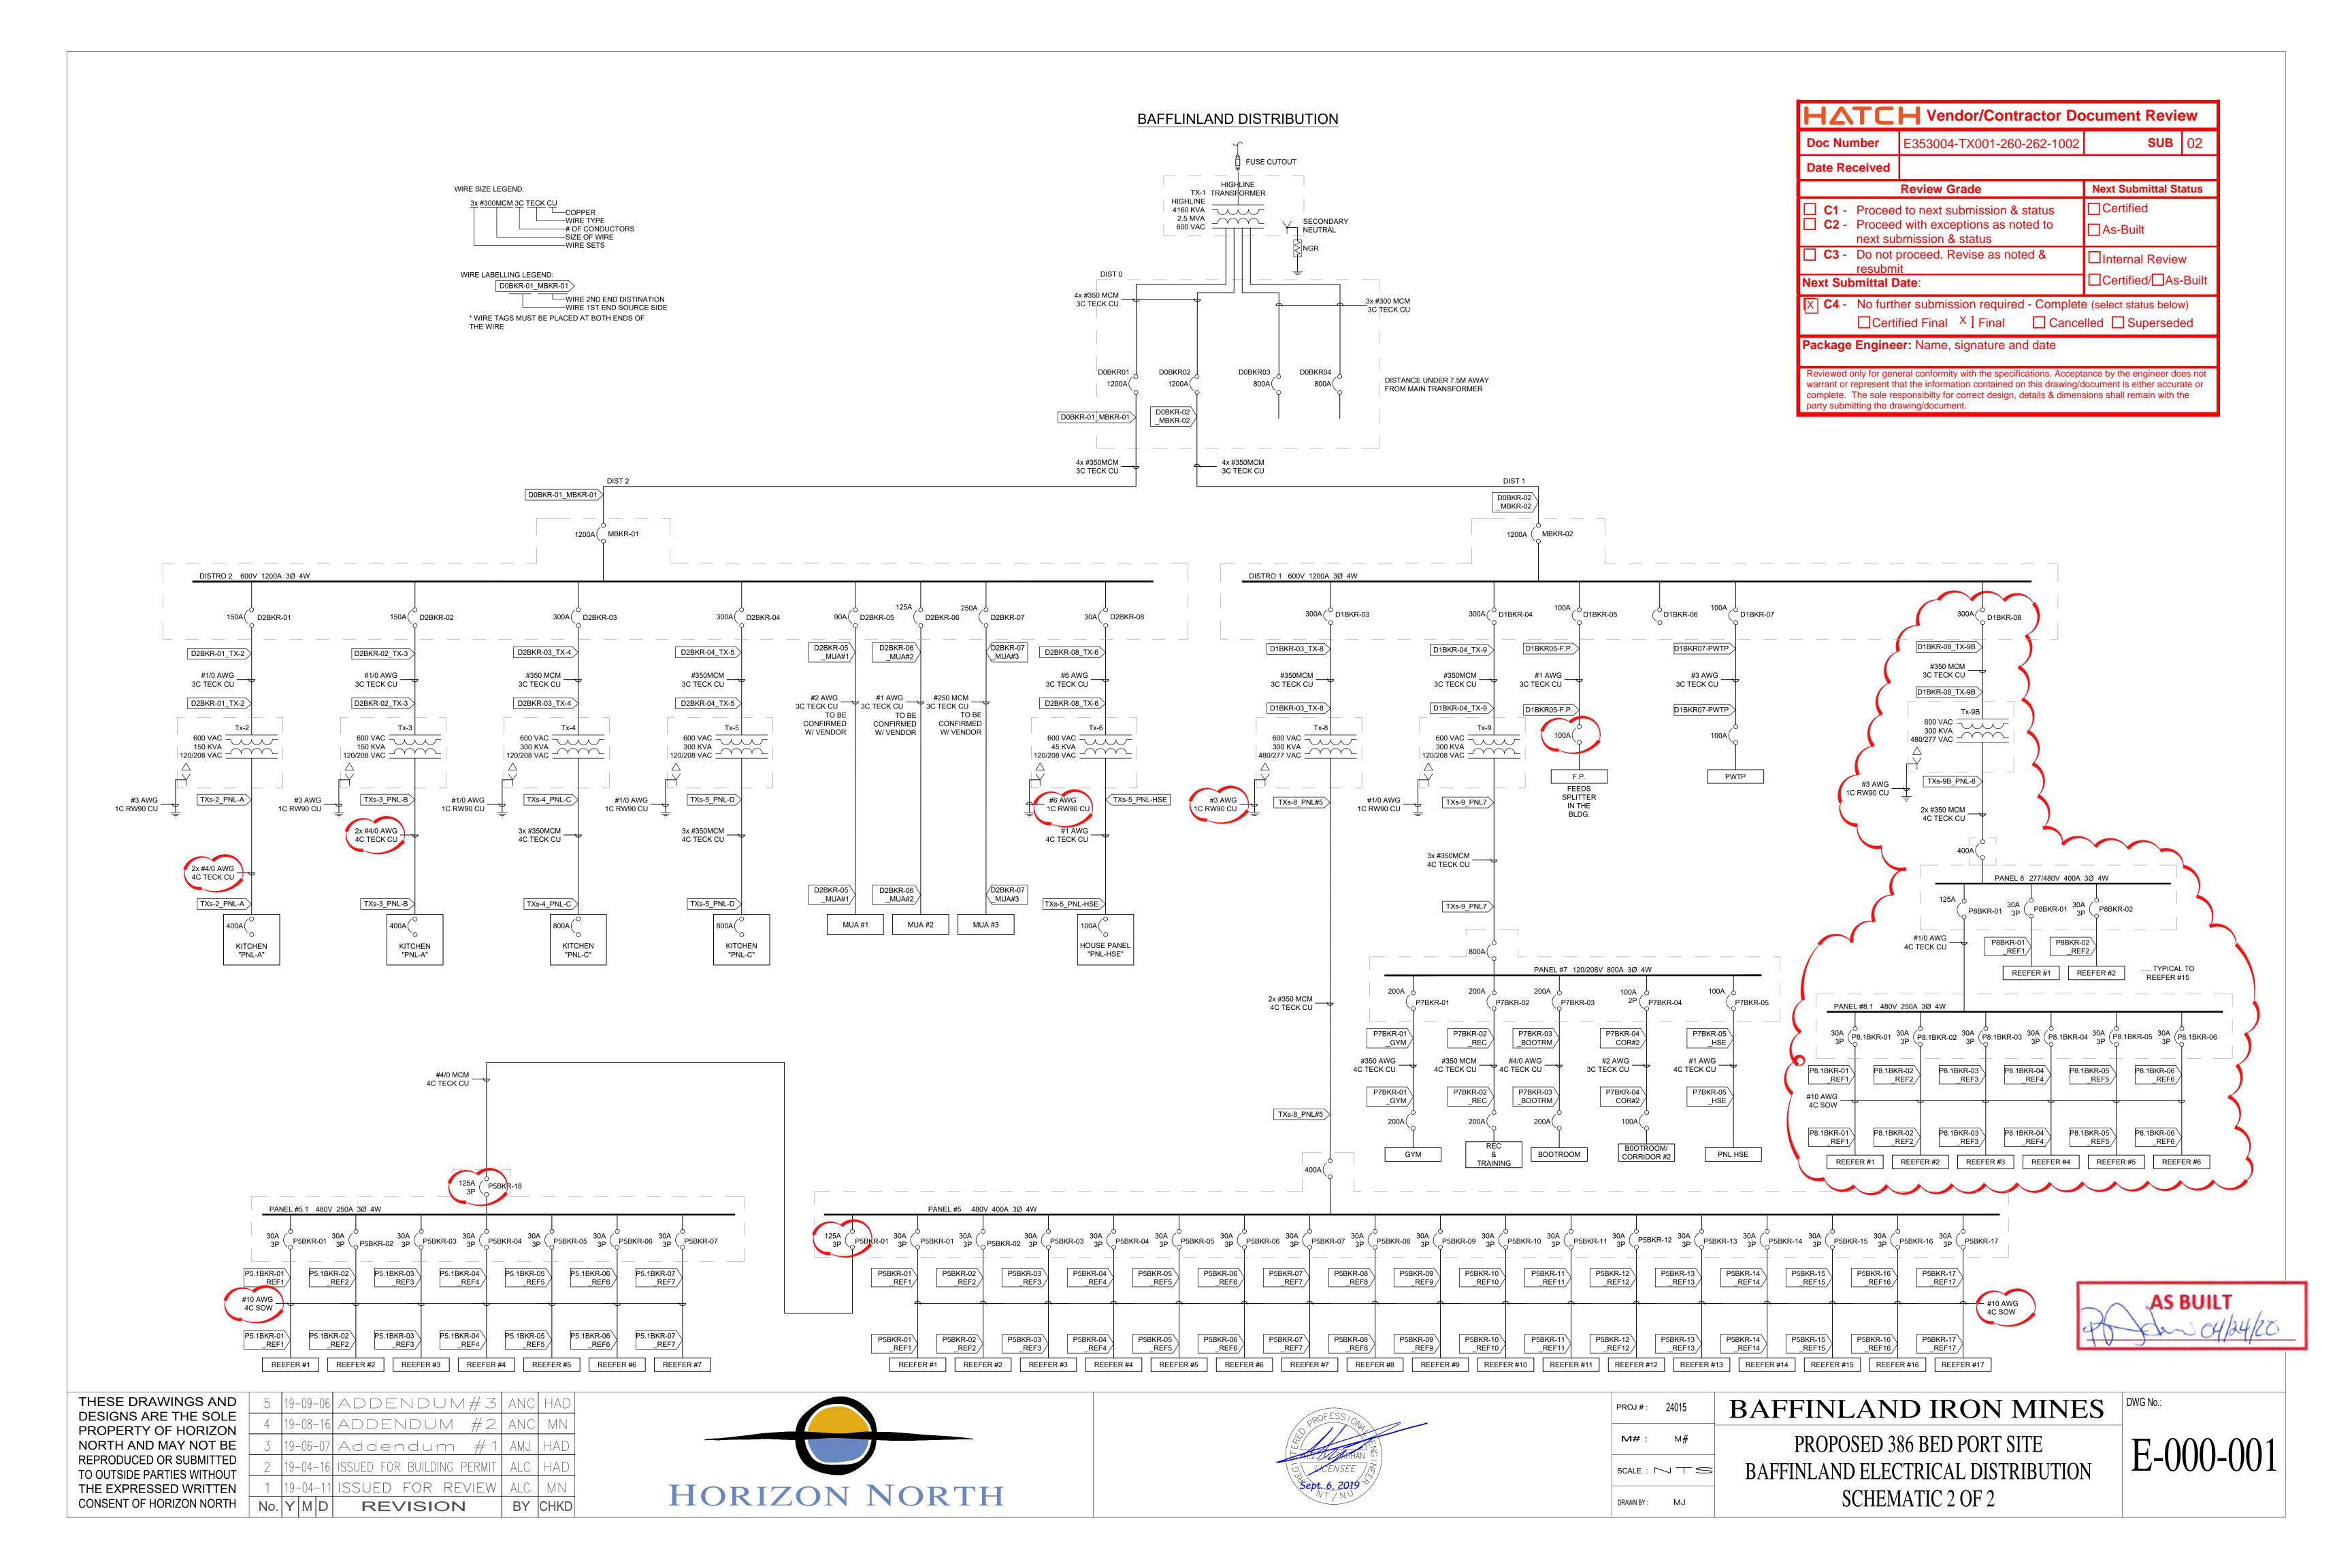

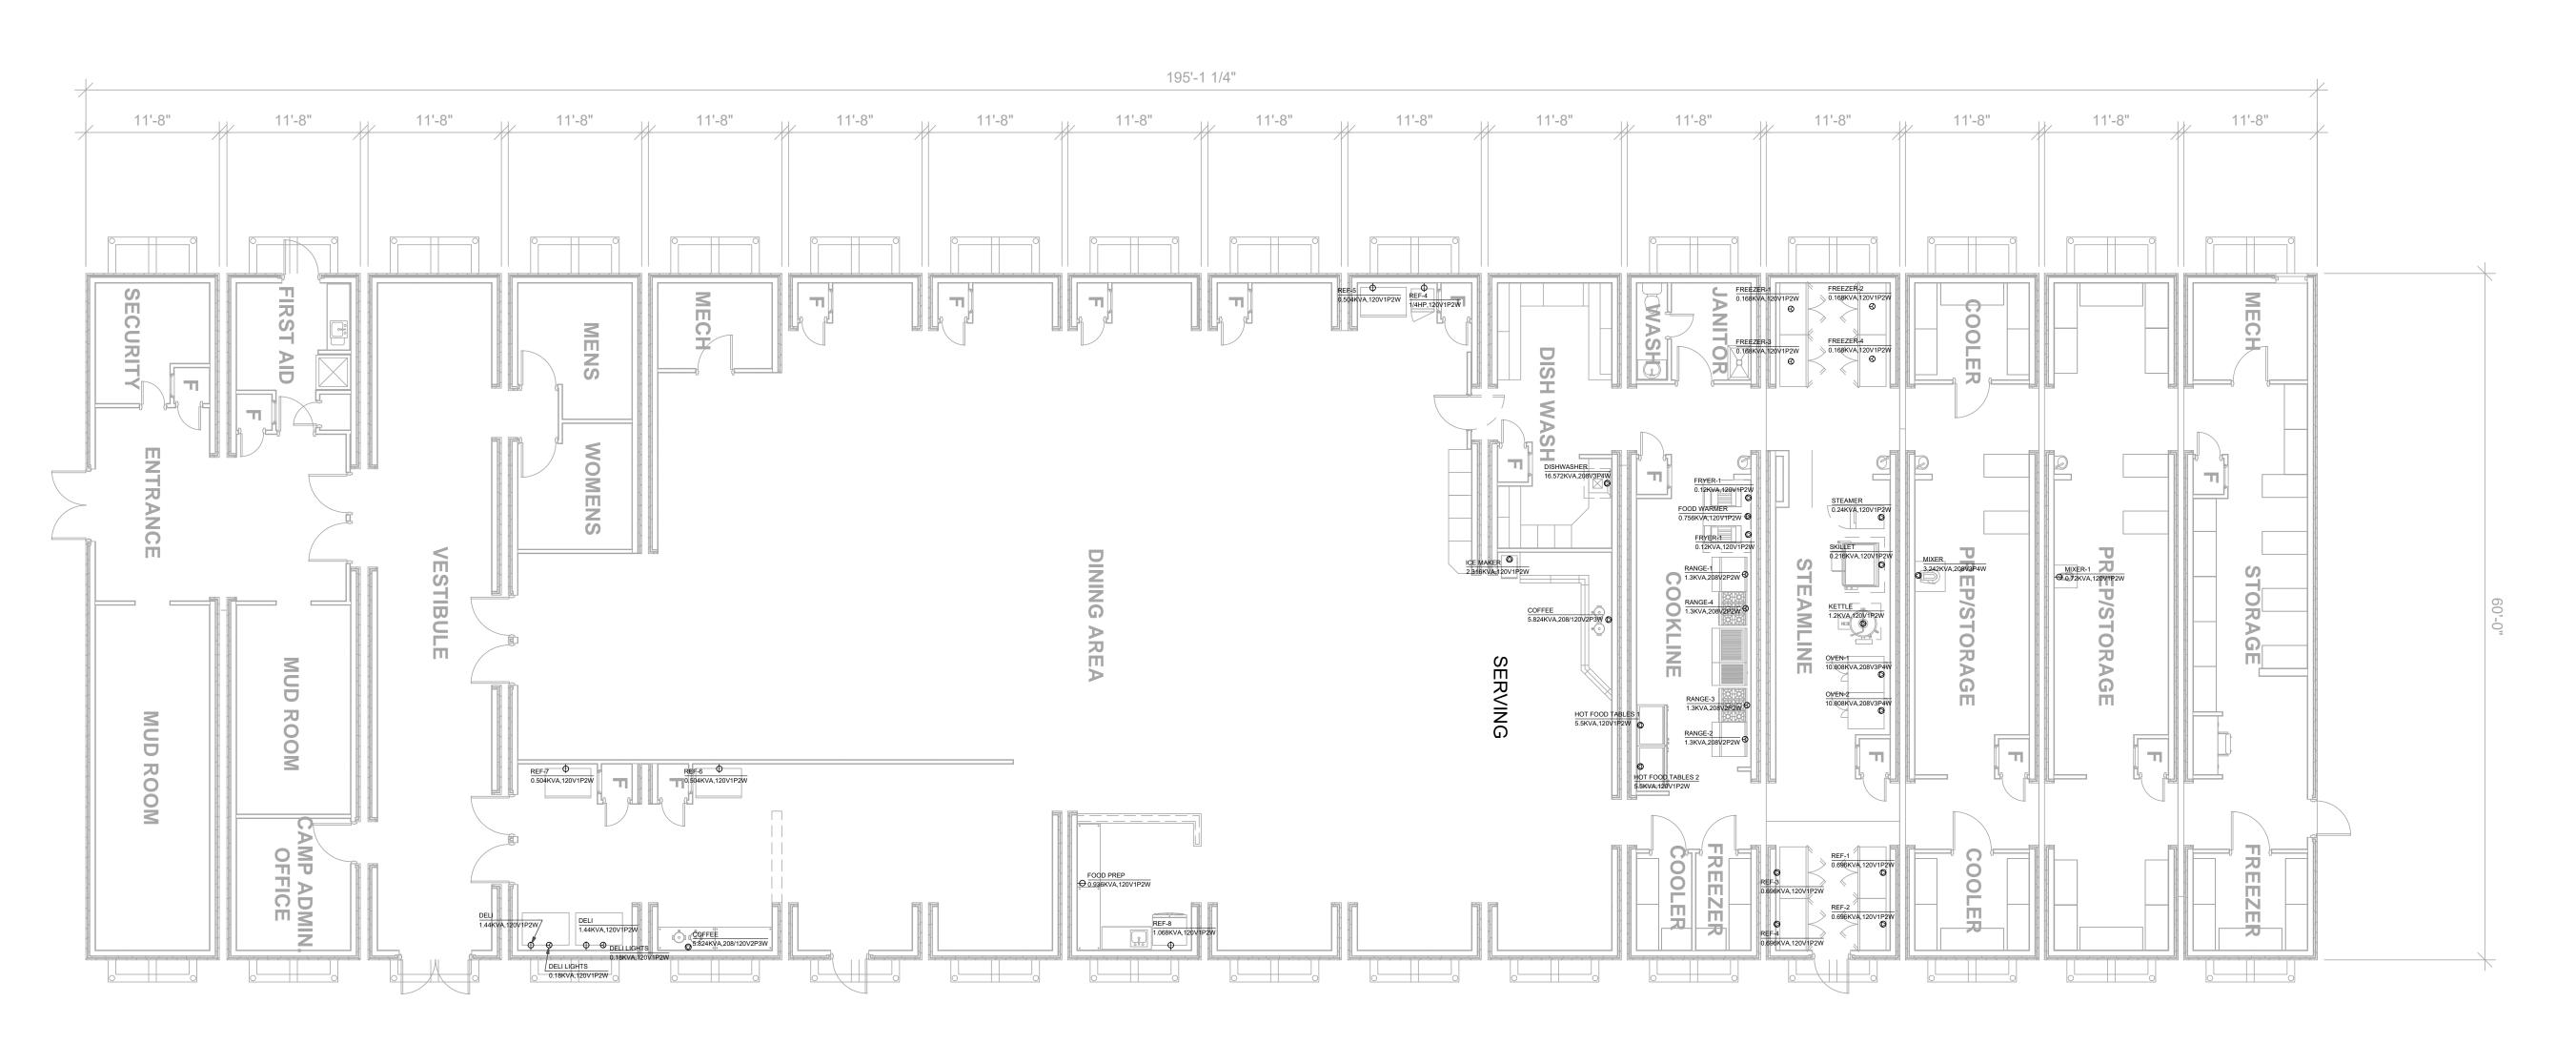

	NC	DRTH E2	16 Unit (\$.2) 1/8" = 1'-0"	SKID) "Ki	tchen/Di	nner" Po	wer Layo	<u>out</u>
SKID E	EQUIPM	ENT SC	HEDULE					
CALLOUT	SYMBOL	NEMA	VOLTS	AMPS	KVA	HP	CIRCUIT	
COFFEE	0		208/120V 2P 3W	28	5.82			GARLA

CALLOUT	SYMBOL	NEMA	VOLTS	AMPS	KVA	HP	CIRCUIT	NOTE 1
COFFEE	0		208/120V 2P 3W	28	5.82			GARLAND G36-G36R
COFFEE	0		208/120V 2P 3W	28	5.82			GARLAND G36-G36R
DELI	\ominus		120V 1P 2W	12	1.44			HOWAR-McCRAY SC 0035E 4 LS OTR
DELI	\ominus		120V 1P 2W	12	1.44			
DELI LIGHTS	\Diamond		120V 1P 2W	1.5	0.18			
DELI LIGHTS	\odot		120V 1P 2W	1.5	0.18			
FOOD PREP	\ominus		120V 1P 2W	7.8	0.94			TRUE TSSU 60 18M B
FREEZER-1	\Diamond		120V 1P 2W	1.4	0.17			TRUE T49F
FREEZER-2	\Diamond		120V 1P 2W	1.4	0.17			TRUE T-49F
FREEZER-3	\Diamond		120V 1P 2W	1.4	0.17			TRUE T-49F
FREEZER-4	\Diamond		120V 1P 2W	1.4	0.17			TRUE T-49F
ICE MAKER	0		120V 1P 2W	19.3	2.32			GARLAND G36-G36R
KETTLE	0		120V 1P 2W	10	1.2			GARLAND KGL 40 T
MIXER	0		208V 3P 4W	9	3.24			GLOBE SP60
MIXER-1	\ominus		120V 1P 2W	6	0.72			GLOBE SP20
OVEN-1	0		208V 3P 4W	30	10.81			GARLAND SUMG 200
OVEN-2	0		208V 3P 4W	30	10.81			GARLAND SUMG 200
REF-4	\ominus		120V 1P 2W	5.8	0.7	1/4 HP		GARLAND G36-G36R
REF-5	\ominus		120V 1P 2W	4.2	0.5			HABCO SE40E
REF-6	\ominus		120V 1P 2W	4.2	0.5			HABCO SE40E
REF-7	\ominus		120V 1P 2W	4.2	0.5			HABCO SE40E
REF-8	\rightarrow		120V 1P 2W	8.9	1.07			TRUE T-19
SKILLET	0		120V 1P 2W	1.8	0.22			CLEVELAND SPL 40 TR
STEAMER	0		120V 1P 2W	2	0.24			CLEVELAND 24 CGA 10





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No.	Description	Date		
1	ISSUED FOR REVIEW	2017-05-23		

CONTRACTOR

l s

С

- 1		
	DRAWN BY:	AL NEIL CABALLES
	CHECKED BY:	HAYDAR AL DAHHAN, P.ENG.
	ENGINEER:	HAYDAR AL DAHHAN, P.ENG.
	DATA FILE:	K:\\designserver\DW Management\projects \2017\170109 Horizon Baffinland Iron Mines \BUILDING DESIGN\ELECTRICAL\Electrical
	DATE:	MAY 2017
	SCALE:	1/8" = 1' - 0"

PROJECT

Baffinland Iron Mines


DESCRIPTION

16 Unit (SKID) "Kitchen/Dinner"


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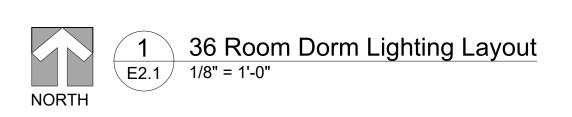
E2.2



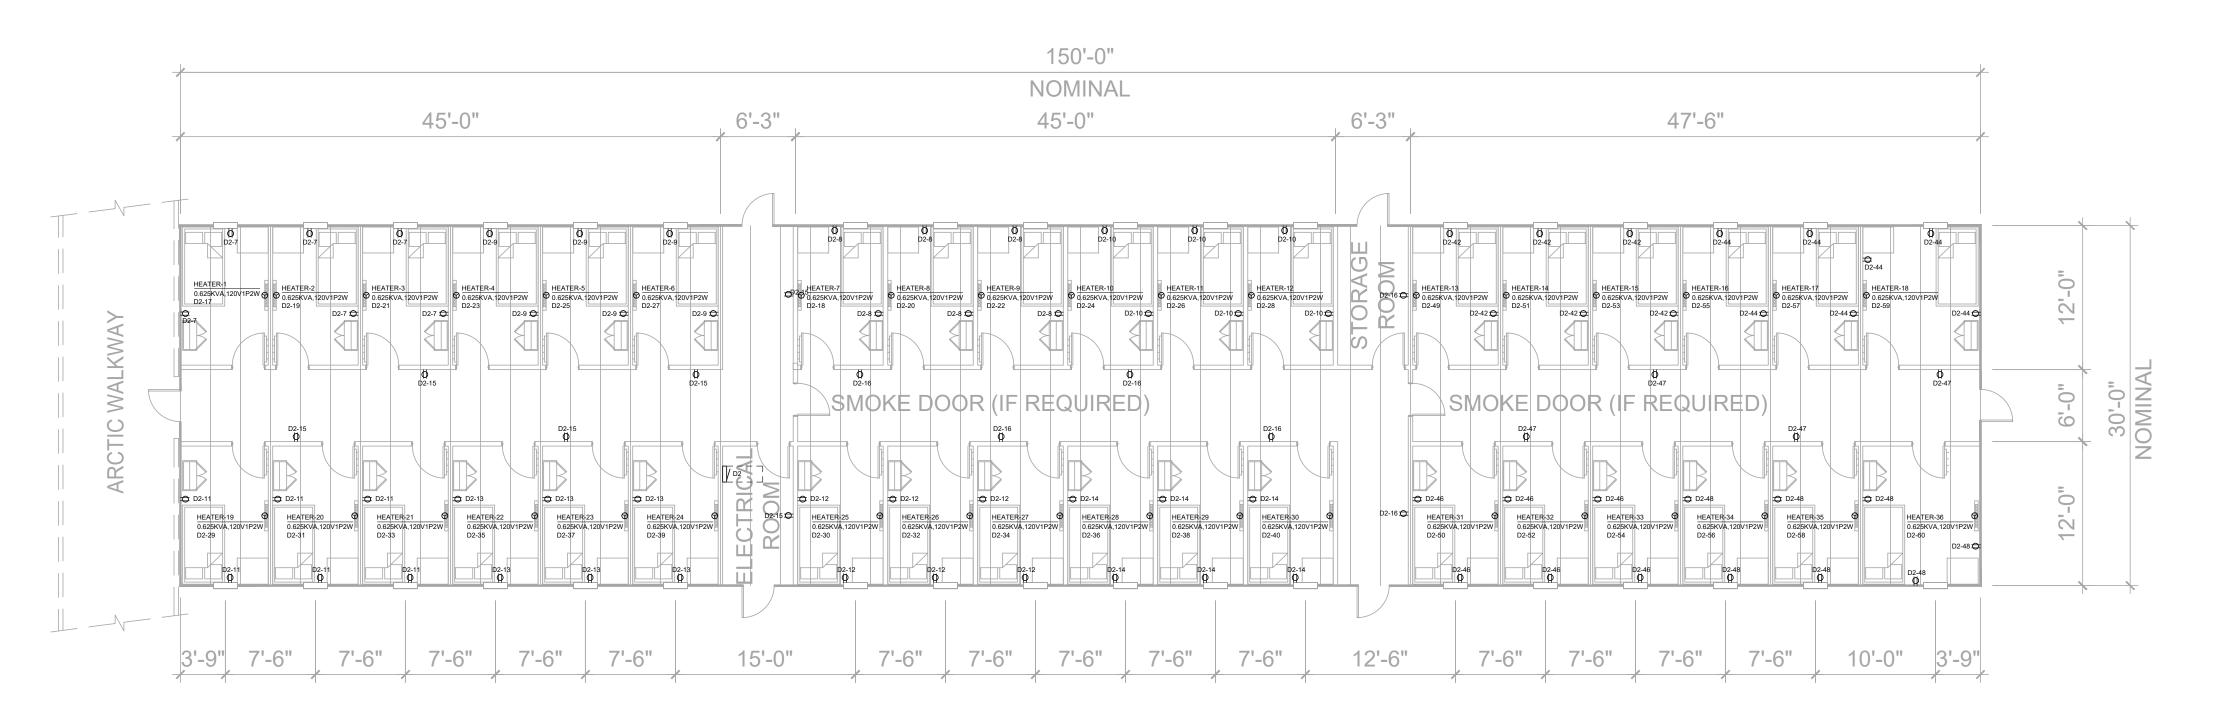

1 36 Room Dorm Power Layout
E2.0 1/8" = 1'-0"



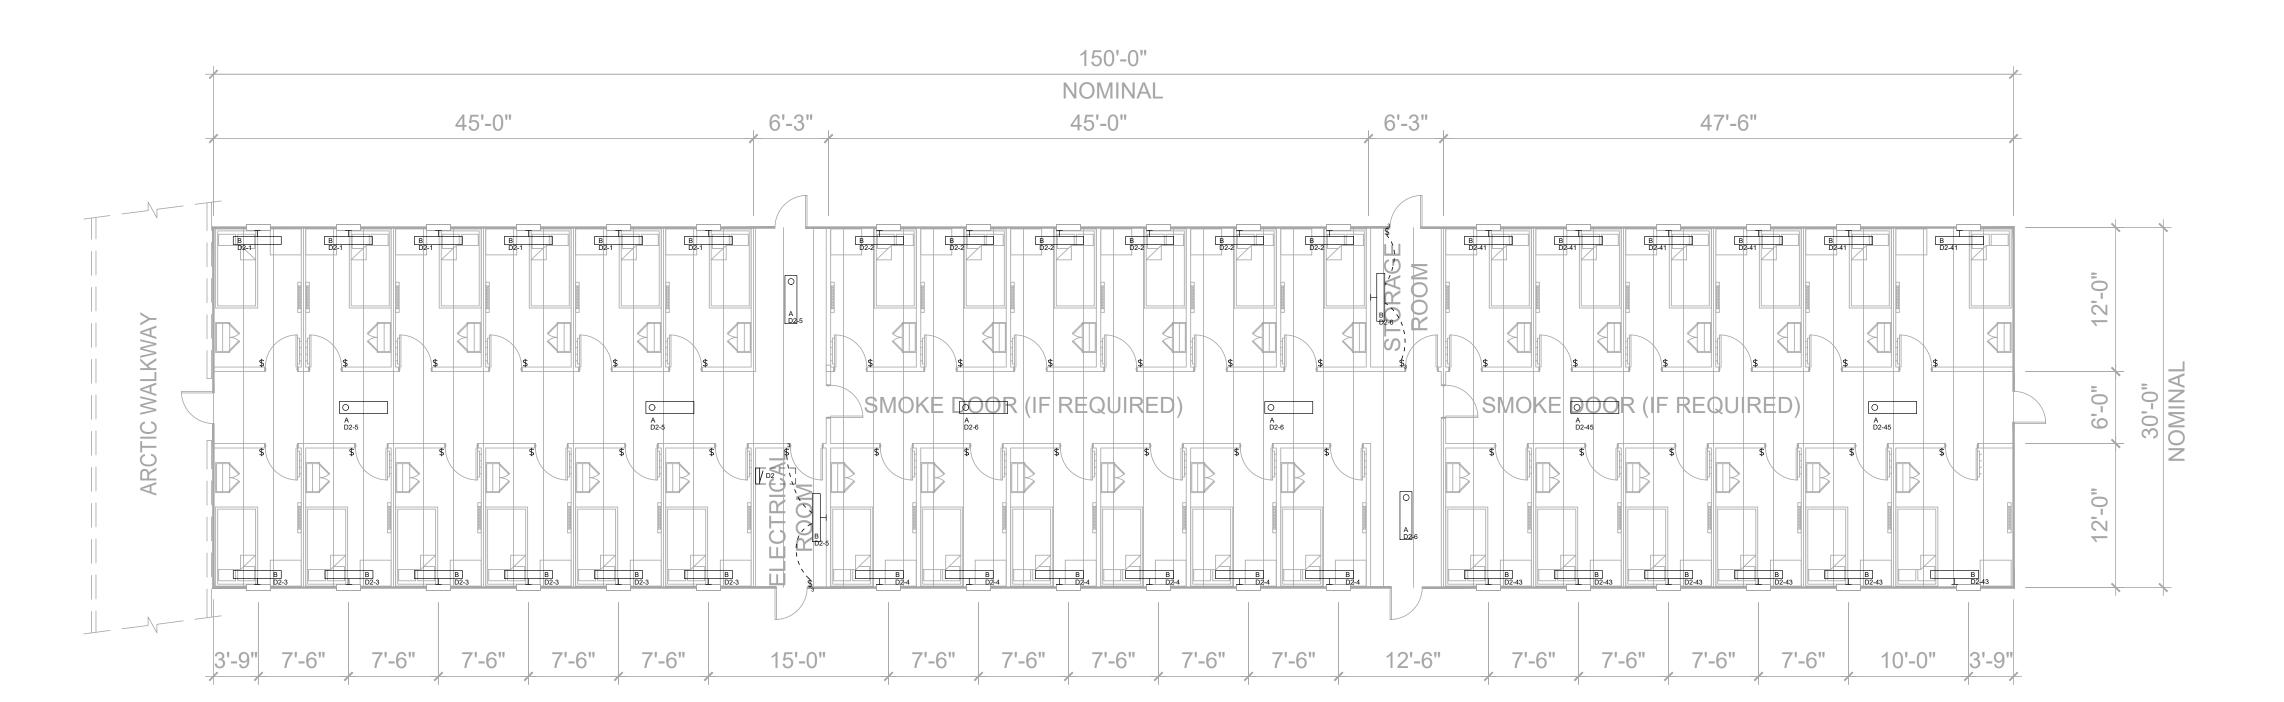





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ENGINEER:	HAYDAR AL DAHHAN, P.ENG.
DATA FILE:	K:\\designserver\DW Management\projects \2017\170109 Horizon Baffinland Iron Mines \BUILDING DESIGN\ELECTRICAL\Electrical
DATE:	MAY 2017
SCALE:	1/8" = 1' - 0"

PROJE

Baffinland Iron Mines


DESCRIPTION

36 Room Dorm Electrical Layout

DRAWING NO.


E2.1



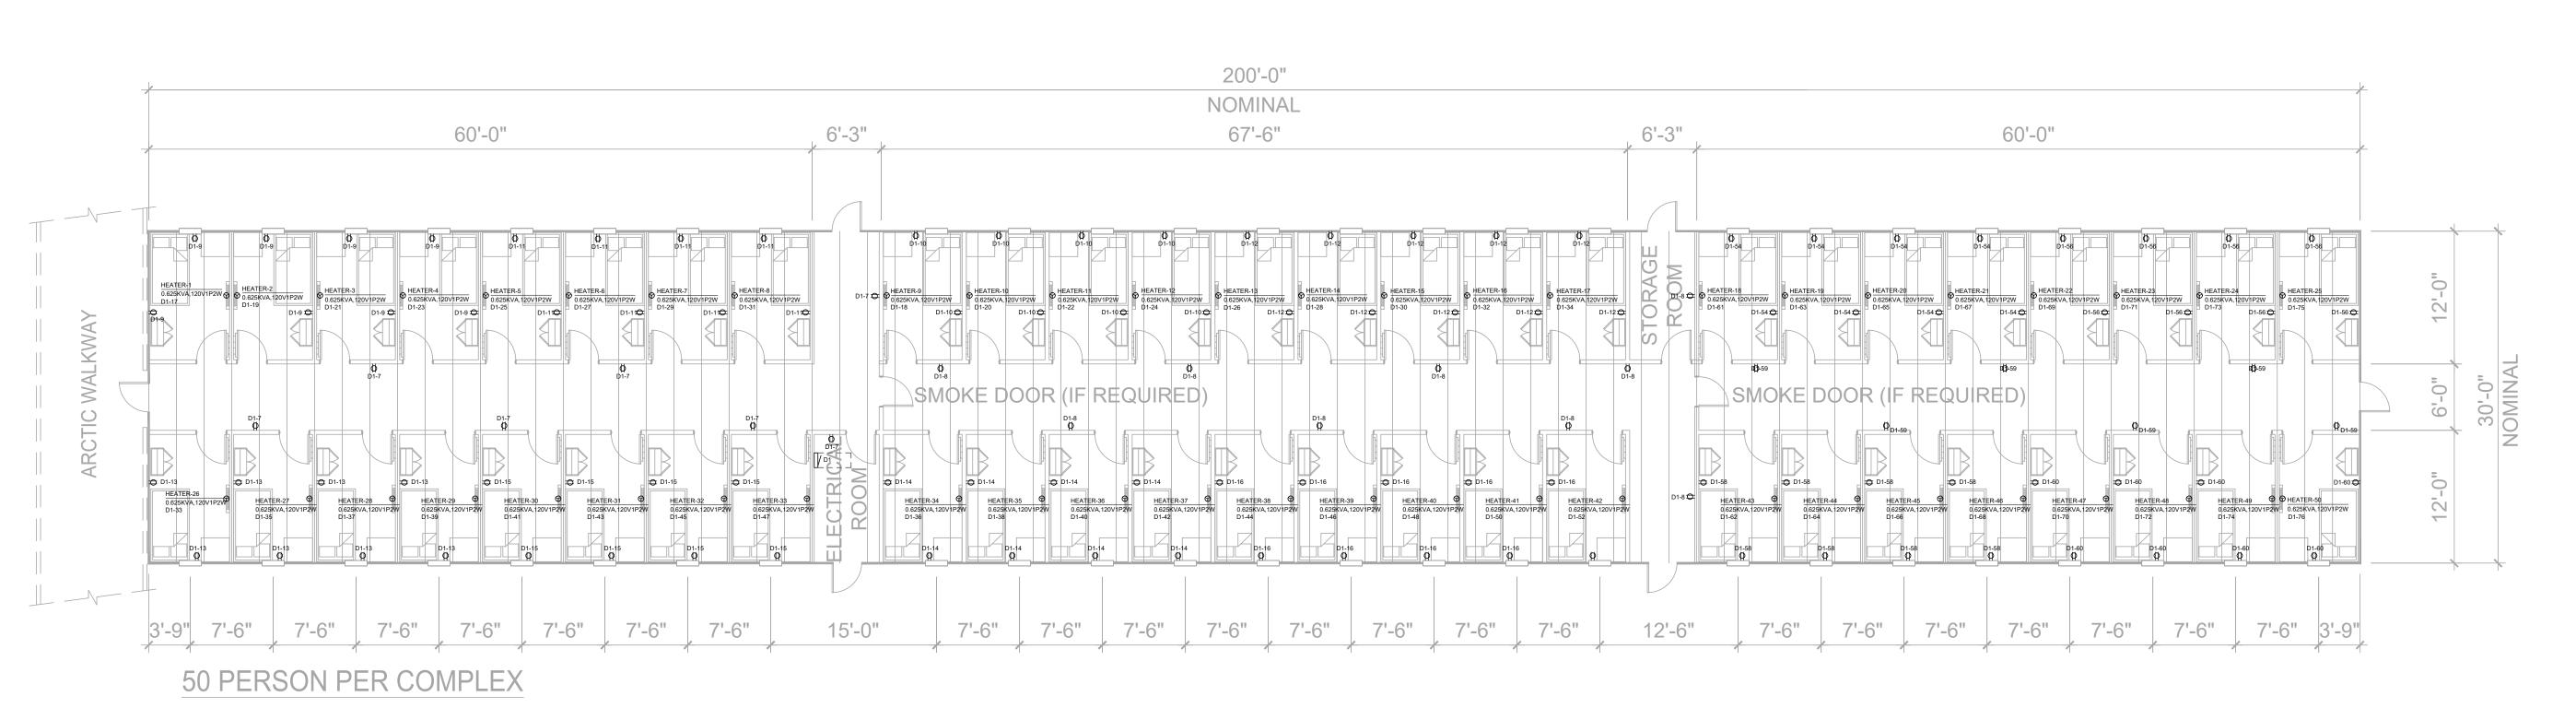

1 50 Room Dorm Power Layout

E2.0 1/8" = 1'-0"

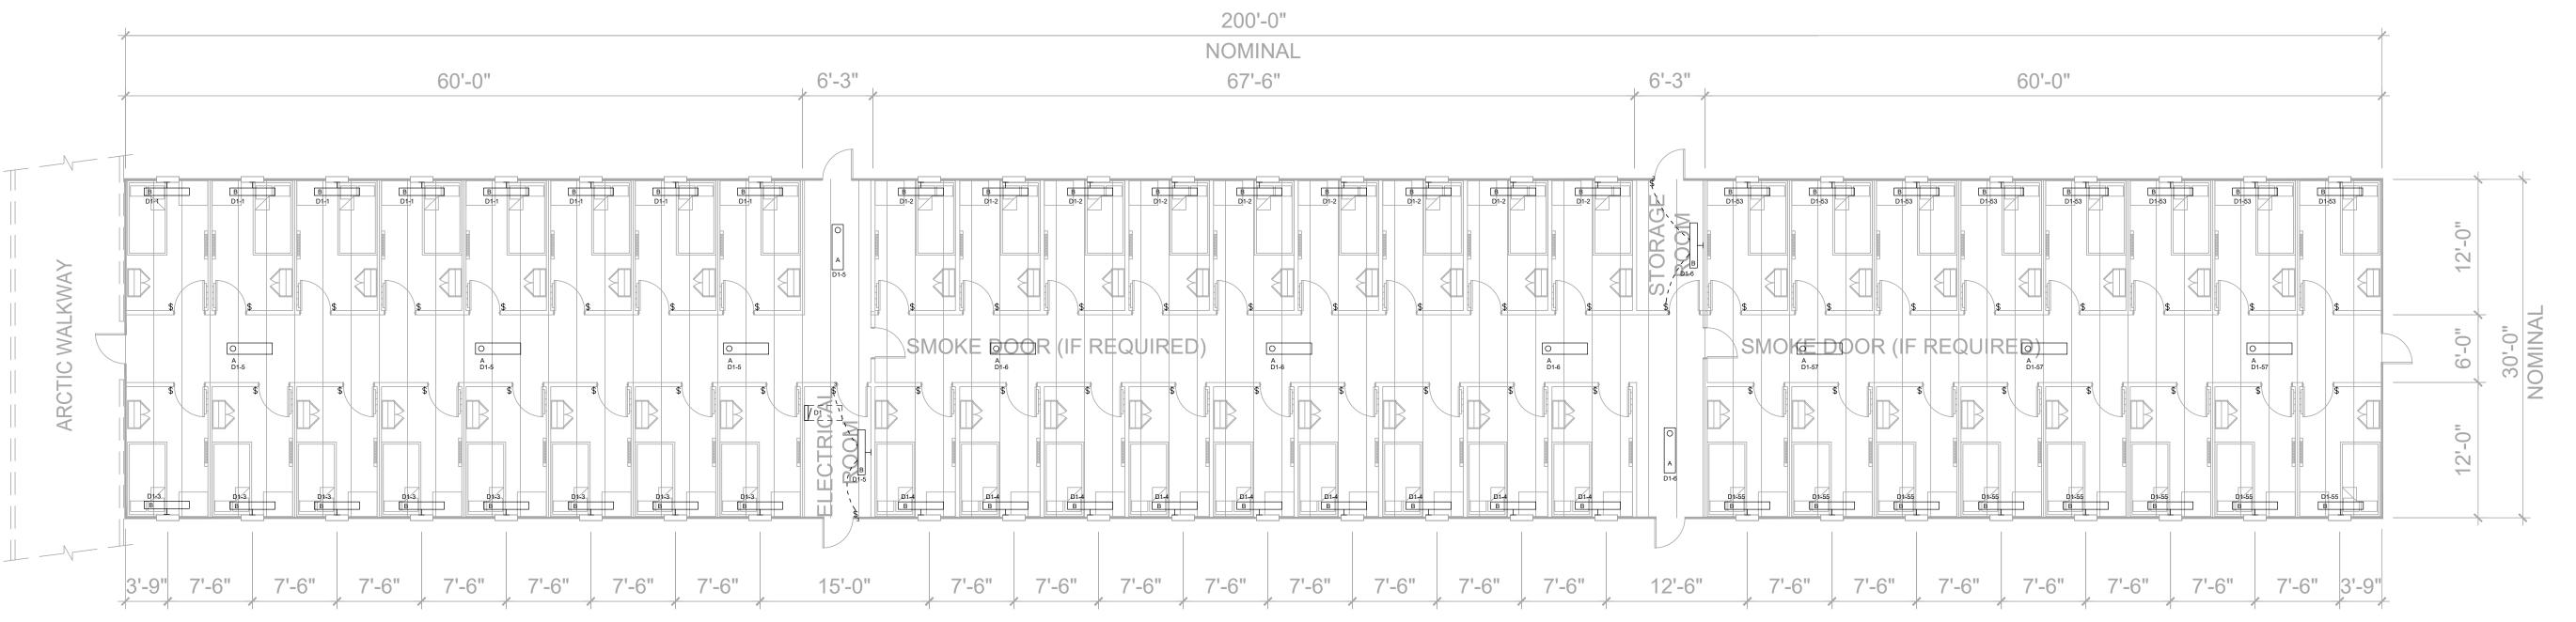

50 PERSON PER COMPLEX







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No.	Description	Date
1	ISSUED FOR REVIEW	2017-05-23

CONTRACTOR

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AL NEIL CABALLES

CHECKED BY:

HAYDAR AL DAHHAN, P.ENG.

ENGINEER:

HAYDAR AL DAHHAN, P.ENG.

K:\\designserver\DW Management\projects \2017\170109 Horizon Baffinland Iron Mines \BUILDING DESIGN\ELECTRICAL\Electrical

DATE:

MAY 2017

SCALE:

*\frac{\%}{8}" = 1' - 0"

PROJECT

Baffinland Iron Mines

DESCRIPTION

50 Room Dorm Electrical Layout

DRAWING NO.

E2.0

LUMIN	LUMINAIRE SCHEDULE 50 DORM										
CALLOUT	SYMBOL	LAMP	DESCRIPTION	BALLAST	MOUNTING	MODEL	INPUT WATTS	VOLTS	QUANTITY		
A	0	(1) 40.5W LED	HALLWAY LIGHTS	ELECTRONIC	CEILING	LITHONIA - LBL4 4800LM EZ1 LP840 40K MVLOT	45	120V 1P 2W	12		
В		(1) 28.2W LED	BEDROOM LIGHTS	ELECTRONIC	SURFACE	LITHONIA - WL4 30L EZ1 LP840	31	120V 1P 2W	52		


RECEI	PTACLE SC	HEDULE 50	DORM		
CALLOUT	SYMBOL	NEMA	VOLTS	FEATURES	QUANTITY
STANDARD DUPLEX	**	5-20R	120V 1P 2W	GND	124

SWITO SCHEI DORM	DULE 50)
CALLOUT	SYMBOL	QUANTITY
Generic Switch	\$	50
Threeway Switch	\$3	4

LUMIN	IAIRE SCHE	EDULE 36DORN	Л						
CALLOUT	SYMBOL	LAMP	DESCRIPTION	BALLAST	MOUNTING	MODEL	INPUT WATTS	VOLTS	QUANTITY
А	0	(1) 40.5W LED	HALLWAY LIGHTS	ELECTRONIC	CEILING	LITHONIA - LBL4 4800LM EZ1 LP840 40K MVLOT	45	120V 1P 2W	7
В		(1) 28.2W LED	BEDROOM LIGHTS	ELECTRONIC	CEILING	LITHONIA - WL4 30L EZ1 LP840	31	120V 1P 2W	38

RECE	PTACLE SC	HEDULE 36	DORM						
CALLOUT SYMBOL NEMA VOLTS FEATURES QUANTIT									
STANDARD DUPLEX									

SWITO SCHE DORM	DULE 36	6				
CALLOUT	SYMBOL	QUANTITY				
Generic \$ 36 Switch						
Threeway	\$3	4				

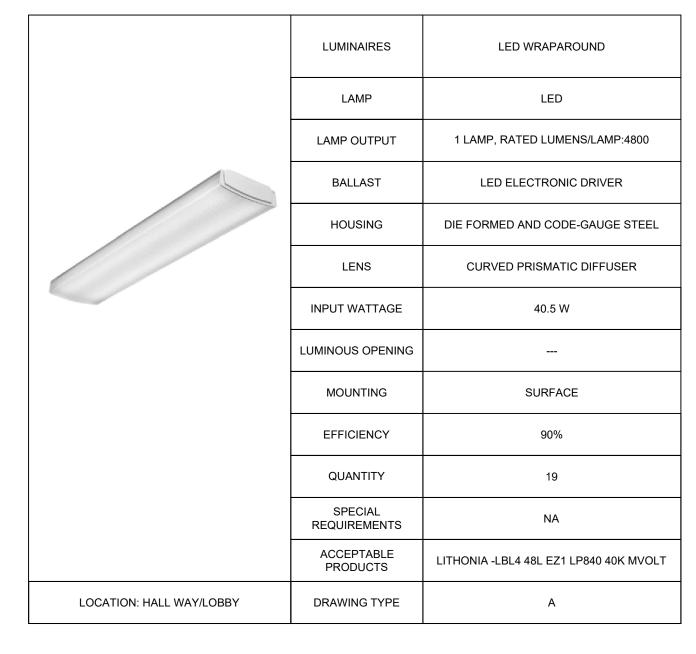

	LUMINAIRES	WALL BRACKET & SURFACE MOUNT LED		
	LAMP	LED		
	LAMP OUTPUT	1 LAMP, RATED LUMENS/LAMP:3000		
	BALLAST	LED ELECTRONIC DRIVER		
	HOUSING	ROLL FORMED FROM CODE-GAUGE STEE		
A second	LENS	IMPACT MODIFIED LINEAR FACETED REFRACTOR		
	INPUT WATTAGE	28.2 W		
	LUMINOUS OPENING			
	MOUNTING	SURFACE		
	EFFICIENCY	90%		
	QUANTITY	90		
	SPECIAL REQUIREMENTS	NA		
	ACCEPTABLE PRODUCTS	LITHONIA -WL4 30L EZ1 LP840		
LOCATION: BEDROOM	DRAWING TYPE	В		

MC	OOM 50 DO	SURFA	CE	BUS	AMPS	150	0	OV 3P 4W		AIC 2	BKR 1	50
	D FROM DTE	UTILITY		NEU	TRAL 10	00%	Ó			LUGS	STAND	ARD
	CKT	LOAD	1				СКТ	СКТ	LOAD			
#	BKR	KVA	CIRCUI	T DESCR	IPTION		#	BKR	KVA		JIT DESC	CRIPTIO
1	15/1	0.248	DORM1	LEFT LIG	HTING	а	2	15/1	0.279	DORM	2 LEFT L	IGHTING
3	15/1	0.248	DORM1	RIGHT LI	GHTING	b	4	15/1	0.279	DORM	2 RIGHT	LIGHTIN
5	15/1	0.211	1	AY DORM	1	С	6	15/1	0.211	HALLV	VAY DOR	:M2
7	20/1	1.26	1	AY DORM	1	а	8	20/1	1.62		VAY DOR	lM2
9	20/1	1.44	DORM1	LEFT		b	10	20/1	1.44	DORM	PTACLE 2 LEFT	
11	20/1	1.44	DORM1	LEFT		С	12	20/1	1.8	DORM	PTACLE 2 LEFT PTACLE	
13	20/1	1.44	DORM1 RECEP	RIGHT		а	14	20/1	1.44	DORM	2 RIGHT	
15	20/1	1.44	DORM1 RECEP			b	16	20/1	1.62	1 -	2 RIGHT PTACLE	
17	20/1	0.625	HEATER	R-1		С	18	20/1	0.625	HEATE	R-9	
19	20/1	0.625	HEATER	R-2		а	20	20/1	0.625	HEATE	R-10	
21	20/1	0.625	HEATER	R-3		b	22	20/1	0.625	HEATE	R-11	
23	20/1	0.625	HEATER	R-4		С	24	20/1	0.625	HEATE	R-12	
25	20/1	0.625	HEATER	R-5		а	26	20/1	0.625	HEATE	R-13	
27	20/1	0.625	HEATER	₹-6		b	28	20/1	0.625	HEATE	R-14	
29	20/1	0.625	HEATER	R-7		С	30	20/1	0.625	HEATE	R-15	
31	20/1	0.625	HEATER	R-8		а	32	20/1	0.625	HEATE	R-16	
33	20/1	0.625	HEATER	R-26		b	34	20/1	0.625	HEATE	R-17	
35	20/1	0.625	HEATER	R-27		С	36	20/1	0.625	HEATE	R-34	
37	20/1	0.625	HEATER	R-28		а	38	20/1	0.625	HEATE		
39	20/1	0.625	HEATER	R-29		b	40	20/1	0.625	HEATE		
11	20/1	0.625	HEATER	R-30		С	42	20/1	0.625	HEATE		
13	20/1	0.625	HEATER	R-31		а	44	20/1	0.625	HEATE		
15	20/1	0.625	HEATER			b	46	20/1	0.625	HEATE		
17	20/1	0.625	HEATER			c	48	20/1	0.625	HEATE		
19	20/1	0.023	SPACE	1-00		а	50	20/1	0.625	HEATE		
51	20/1	0	SPACE			b	52	20/1	0.625	HEATE		
53	15/1	0.248	-	B LEFT LIG	HTING	С	54	20/1	1.44	DORM	3 LEFT PTACLE	
55	15/1	0.248	DORM 3	RIGHT L	IGHTING	а	56	20/1	1.44	DORM	3 LEFT PTACLE	
57	15/1	0.135	HALLWA	AY DORM: NG	3	b	58	20/1	1.44	1 -	3 RIGHT PTACLE	•
59	20/1	1.08	RECEP		3	С		20/1	1.44		3 RIGHT PTACLE	•
31	20/1	0.625	HEATER			а	ł	20/1	0.625	HEATE		
33	20/1	0.625	HEATER			b	64	20/1	0.625	HEATE		
35	20/1	0.625	HEATER			С	66	20/1	0.625	HEATE		
57	20/1	0.625	HEATER			a	68	20/1	0.625	HEATE		
9	20/1	0.625	HEATER			b	ł	20/1	0.625	HEATE		
71	20/1	0.625	HEATER			С	72	20/1	0.625	HEATE		
73	20/1	0.625	HEATER			a	74	20/1	0.625	HEATE		
75	20/1	0.625	HEATER	K-25		b	76	20/1	0.625	HEATE		
77	20/1	0	SPACE			С	78	20/1	0	SPACE		
	<u> </u>	<u>I</u>	CONN KVA	CALC KVA				l	I.	CONN KVA	CALC KVA	
ΠG	HTING	-	2.11	2.63	(125%)		COM	NTINUOUS		0	0	- (125%
	RGEST MO	TOR	0		(12576) (N/A)			ATING		31.3	31.3	(100%
	HER MOTO		0		(100%)			OLING		0	0	(N/A)
	CEPTACLE		21.8		(100 <i>%)</i> (50%>10)			NCONTINU	OUS	0	0	(100%
	CHEN EQU		0		(S0 % 10) (N/A)			ERSE		0	0	(N/A)
1 '			-	•	·· • · · · · · · · · · · · · · · · · ·			TERED DEN	MAND	0	0	(125%
ᇚ	ASE BALAI	NCE DE	DCENT: F		101%	,	BAL	AL KVA ANCED 3-F SE B 102			49.8 138 SE C	97.2%

)2											
	OOM 36 D	ORM EL SURFA				08		0V 3P 4W		AIC 2	22,000 BKR 1	125
	ED FROM OTE	UTILITY	′	NEU	TRAL 10	0%	6			LUGS	STANE	DARD
CKT ŧ	CKT BKR	LOAD KVA	CIRCU	IT DESCF	RIPTION		CK ⁻	CKT BKR	LOAD KVA	CIRCL	JIT DES	CRIPTION
1	15/1	0.186	DORM1	LEFT LIG	HTING	а	2	15/1	0.186	DORM	2 LEFT L	IGHTING
3	15/1	0.186	DORM1	RIGHT LI	GHTING	b	4	15/1	0.186	DORM	2 RIGHT	LIGHTING
5	15/1	0.166	HALLW.	AY DORM NG	1	С	6	15/1	0.166	HALLV	/ay dof ng	RM2
7	20/1	1.08	DORM RECEP			а	8	20/1	1.08		2 LEFT PTACLE	
9	20/1	1.08	DORM RECEP			b	10	20/1	1.08		2 LEFT PTACLE	
1	20/1	1.08	DORM RECEP	1 RIGHT TACLE		С	12	20/1	1.08		2 RIGHT PTACLE	•
3	20/1	1.08	DORM1 RECEP			а	14	20/1	1.08	1	2 RIGHT PTACLE	•
5	20/1	1.08	HALLW.	AY DORM TACLE	1	b	16	20/1	1.08	1	AY DOF	RM2
7	20/1	0.625	HEATE	₹-1		С	18	20/1	0.625	HEATE		
9	20/1	0.625	HEATE	₹-2		а	20	20/1	0.625	HEATE	R-8	
1	20/1	0.625	HEATE	₹-3		b	22	20/1	0.625	HEATE	R-9	
3	20/1	0.625	HEATE	₹-4		С	24	20/1	0.625	HEATE	R-10	
5	20/1	0.625	HEATE	₹-5		а	26	20/1	0.625	HEATE	R-11	
7	20/1	0.625	HEATE	₹-6		b	28	20/1	0.625	HEATE	R-12	
9	20/1	0.625	HEATE	R-19		С	30	20/1	0.625	HEATE	R-25	
1	20/1	0.625	HEATE	₹-20		а	32	20/1	0.625	HEATE	R-26	
3	20/1	0.625	HEATE	R-21		b	34	20/1	0.625	HEATE	R-27	
5	20/1	0.625	HEATE	R-22		С	36	20/1	0.625	HEATE	R-28	
7	20/1	0.625	HEATE	R-23		а	38	20/1	0.625	HEATE	R-29	
9	20/1	0.625	HEATE	R-24		b	40	20/1	0.625	HEATE	R-30	
1	15/1	0.186	DORM3	LEFT LIG	HTING	С	42	20/1	1.08		3 LEFT PTACLE	
3	15/1	0.186	DORM3	RIGHT LI	GHTING	а	44	20/1	1.26	1	3 LEFT PTACLE	
5	15/1	0.09	HALLW.	AY DORM NG	3	b	46	20/1	1.08	DORM	3 RIGHT	•
7	20/1	0.72	ı	AY DORM	3	С	48	20/1	1.26	DORM	3 RIGHT PTACLE	
9	20/1	0.625	HEATE			а	50	20/1	0.625	HEATE		
1	20/1	0.625	HEATE	R-14		b	52	20/1	0.625	HEATE	R-32	
3	20/1	0.625	HEATE			С	54	20/1	0.625	HEATE		
5	20/1	0.625	HEATE	₹-16		а	56	20/1	0.625	HEATE	R-34	
7	20/1	0.625	HEATE	R-17		b	58	20/1	0.625	HEATE	R-35	
9	20/1	0.625	HEATE	₹-18		С	60	20/1	0.625	HEATE	R-36	
1	20/1	0	SPACE			а	62	20/1	О	SPACE	Ξ	
3	20/1	0	SPACE			b	64	20/1	0	SPACE	Ξ	
5	20/1	0	SPACE			С	66	20/1	0	SPACE	Ē	
			CONN	CALC			<u> </u>			CONN	CALC	
		-	KVA	KVA	-				-	KVA	KVA	_
LIG	HTING		1.54	1.92	(125%)		CO	NTINUOUS		0	0	(125%)
LAI	RGEST MO	TOR	0	0	(N/A)		HE	ATING		22.5	22.5	(100%)
ОТ	HER MOTO	RS	0		(100%)		CO	OLING		0	0	(N/A)
RE	CEPTACLE	S	16.2	13.1	(50%>10)		NO	NCONTINU	OUS	0	0	(100%)
KIT	CHEN EQU	JIP	0	0	(N/A)		DIV	ERSE		0	0	(N/A)
								TERED DEI	MAND .	0	0	(125%)
							BAI	TAL KVA _ANCED 3-I			37.5 104	
PH	IASE BALA	NCE PE	RCENT: F	PHASE A	102%	ı	PHA:	SE B 99.	6%	PHA	SE C	98.7%





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No.	Description	Date
1	ISSUED FOR REVIEW	2017-05-23

	SEA

DRAWN BY:	AL NEIL CABALLES
CHECKED BY:	HAYDAR AL DAHHAN, P.ENG.
ENGINEER:	HAYDAR AL DAHHAN, P.ENG.
DATA FILE:	K:\\designserver\DW Management\project: \2017\170109 Horizon Baffinland Iron Mino \BUILDING DESIGN\ELECTRICAL\Electri
DATE:	MAY 2017
SCALE:	1/8" = 1' - 0"


Baffinland Iron Mines


DESCRIPTION


Electrical Schedule

E3.0



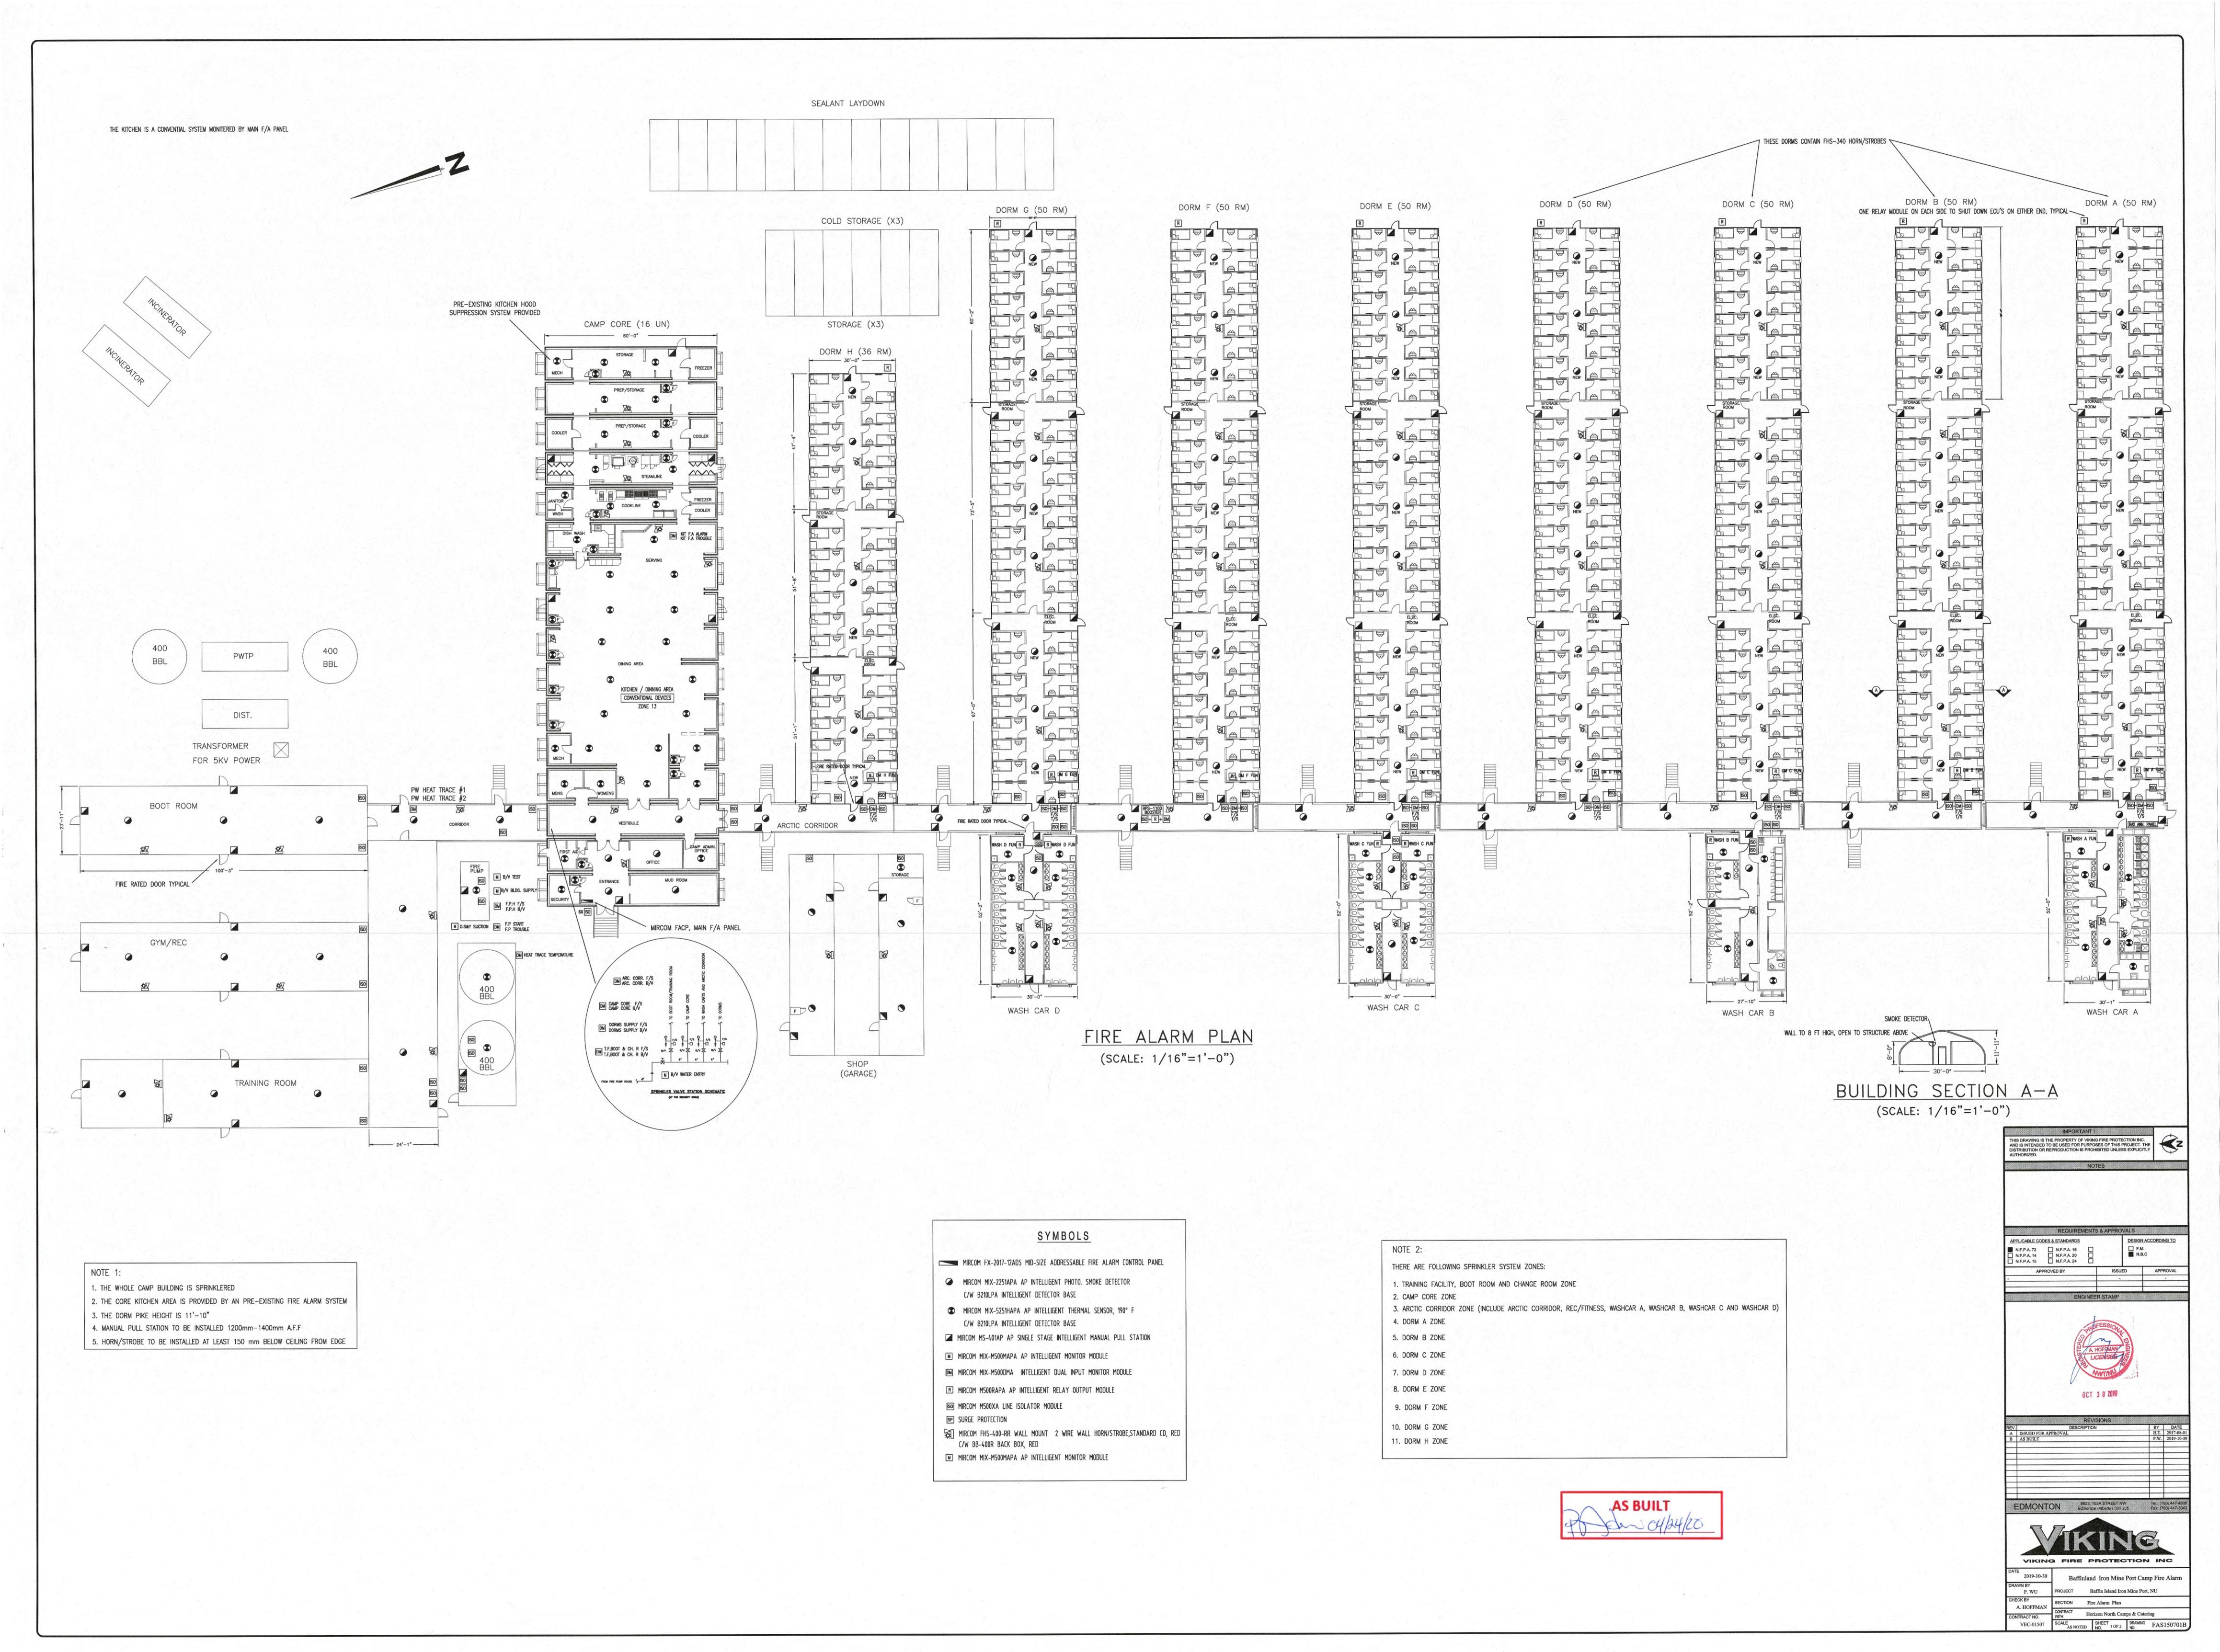

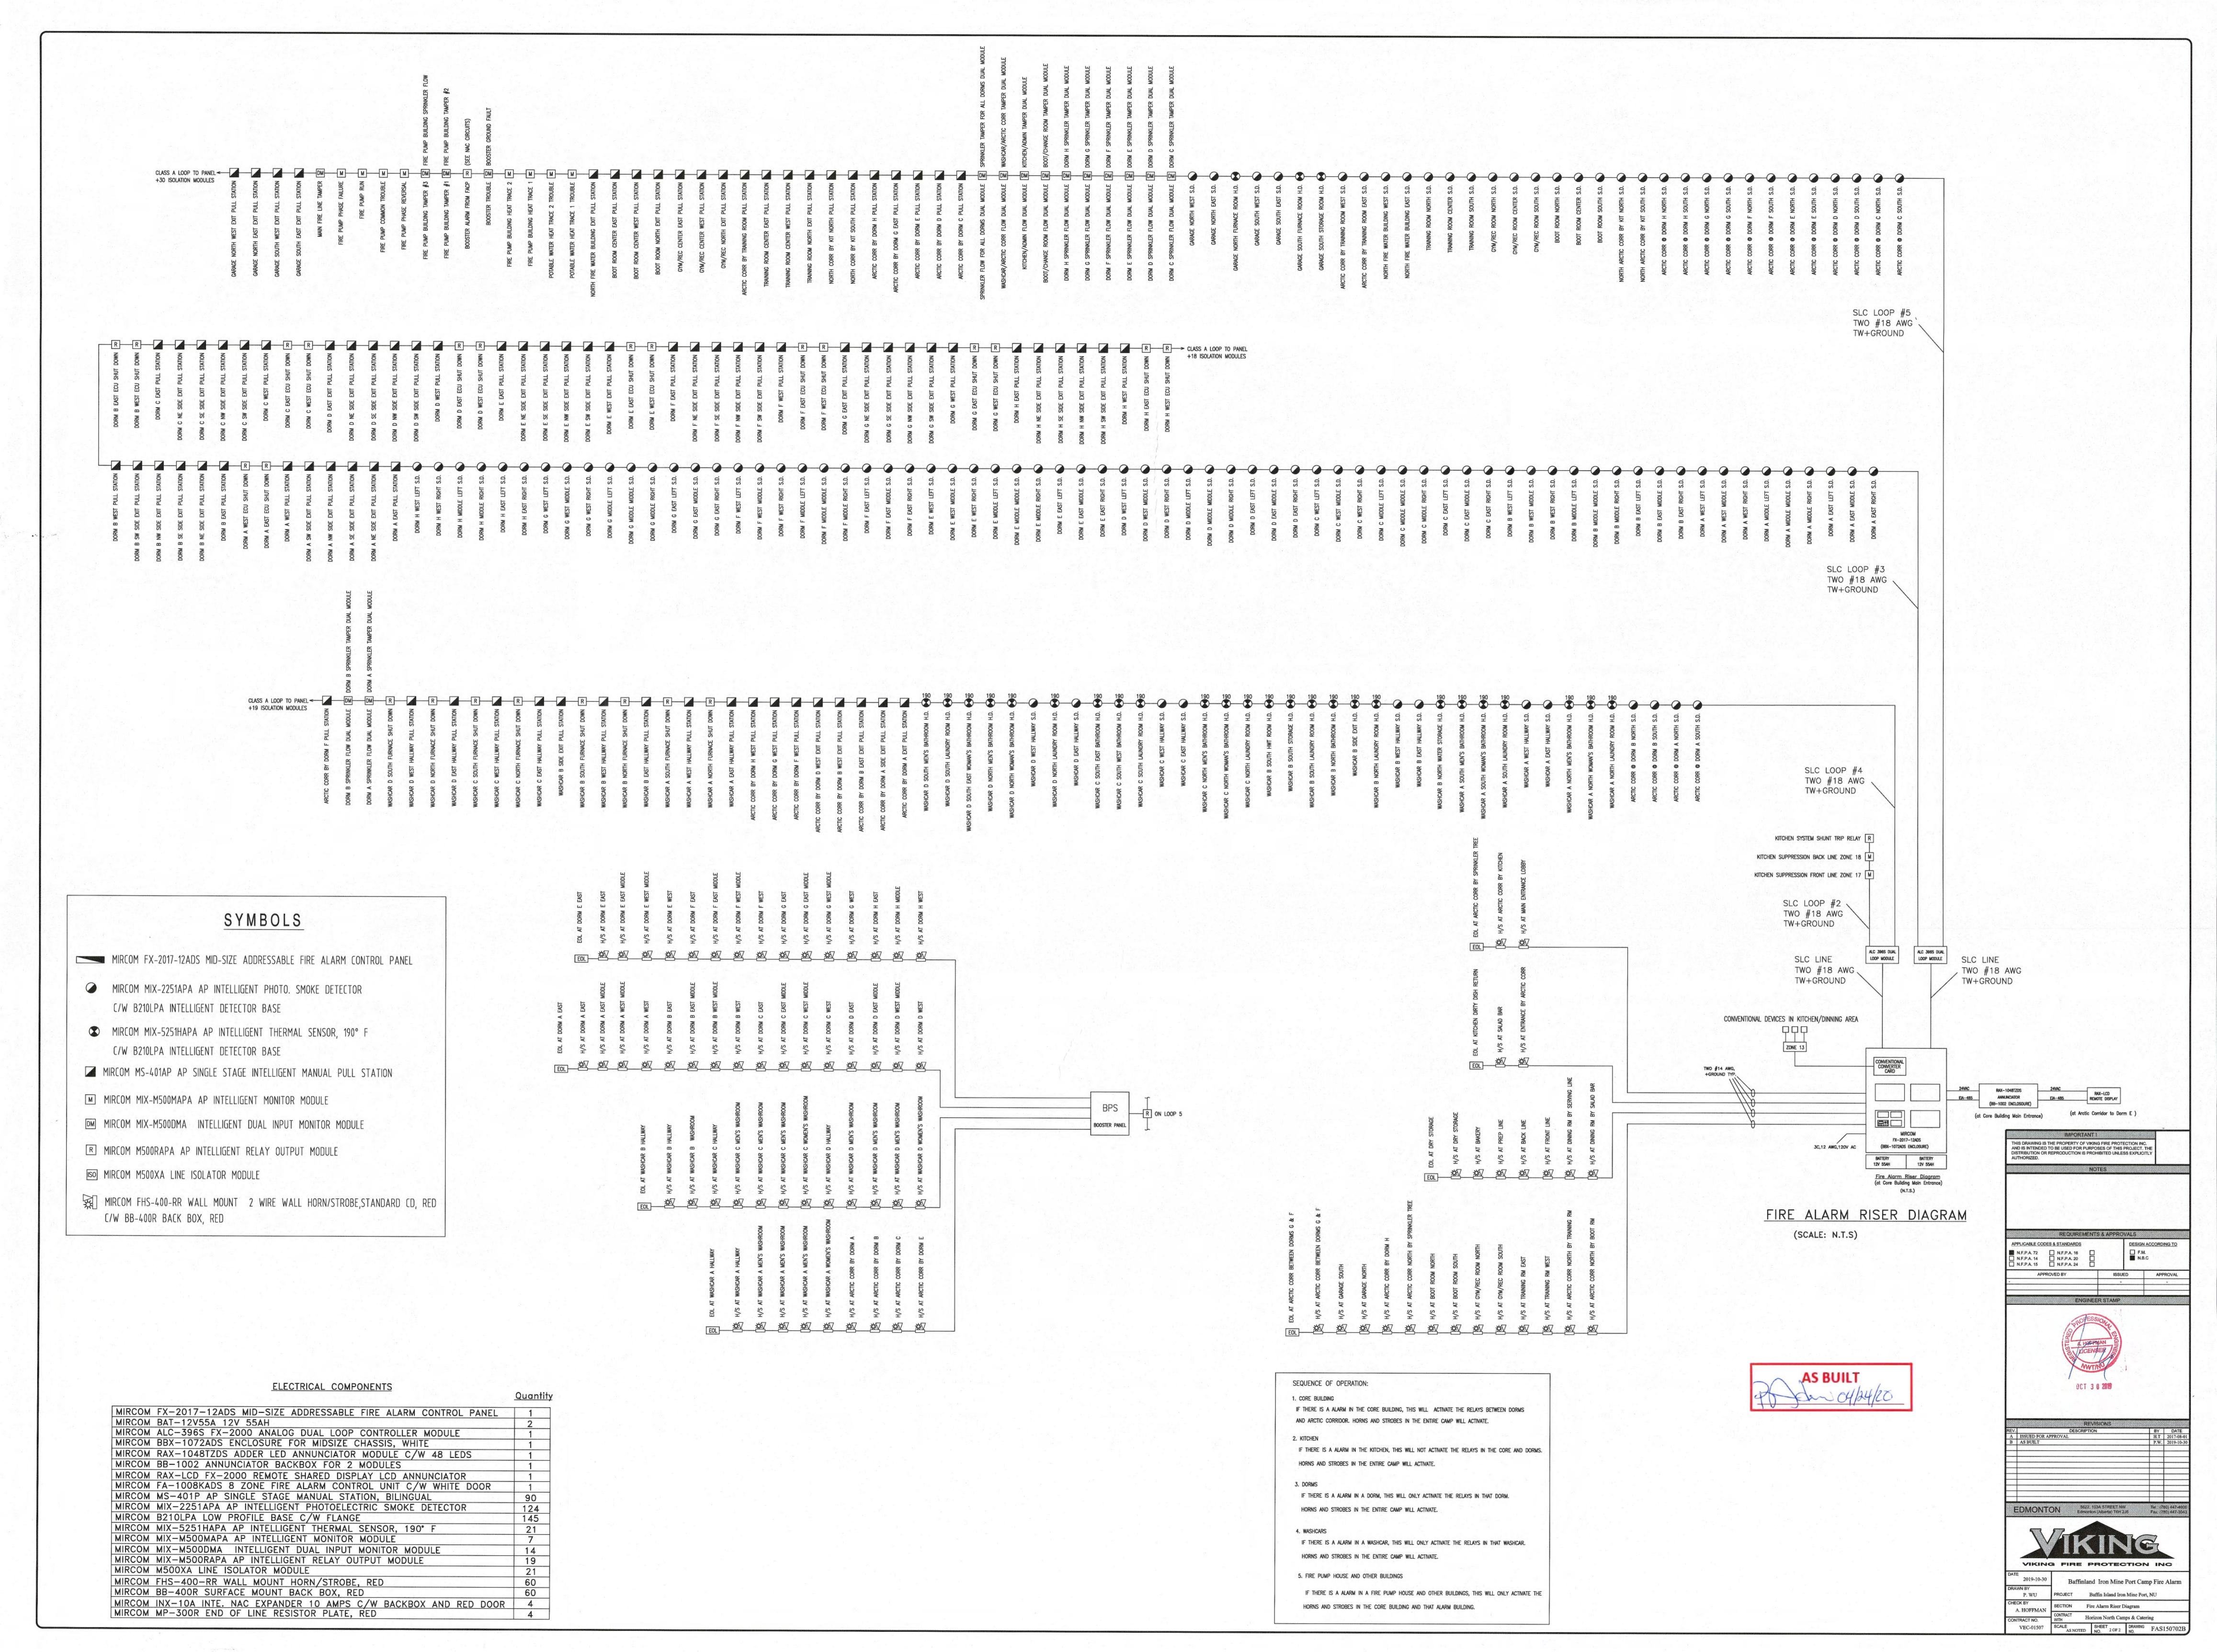

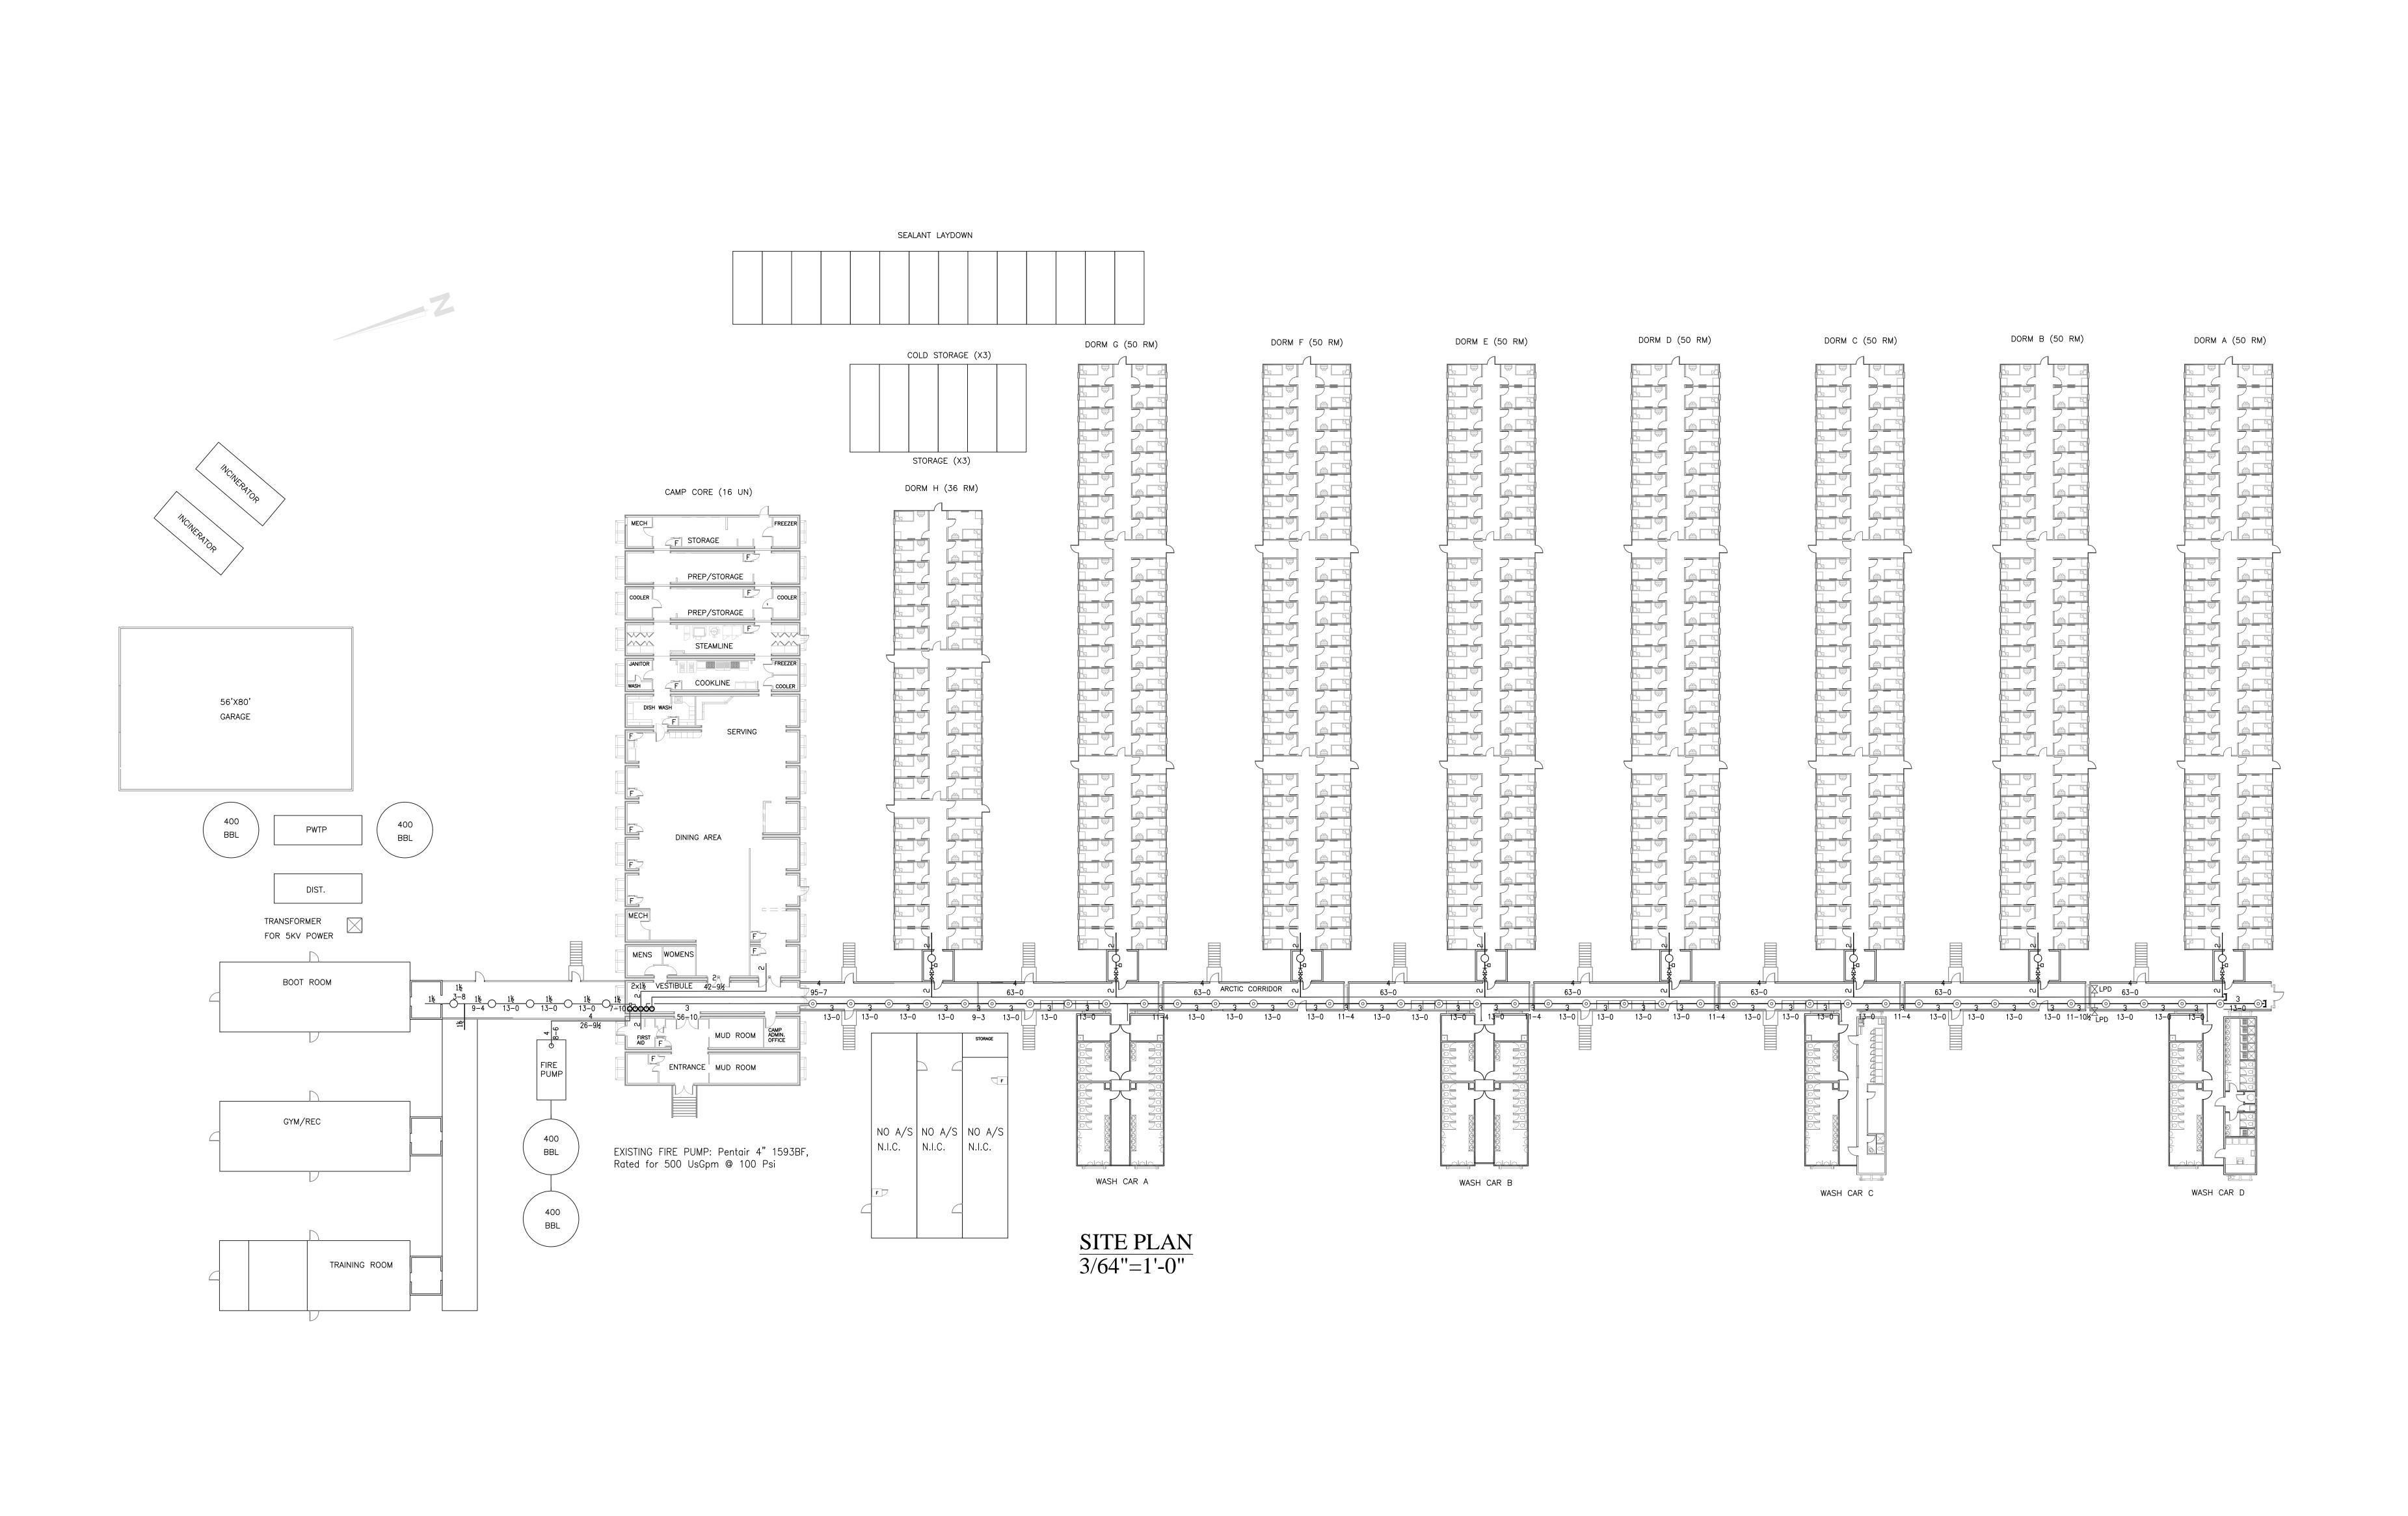

0N-Template-Large Sheet-Rev-B1





INDICATES THE DISTANCE IN INCHES
OR MILLIMETERS FROM THE CENTER
LINE OF THE PIPE TO THE UNDERSIDE
OF THE CEILING, CONCRETE SLAB OR ROOF DECK. 1-0 INDICATES THE DISTANCE IN FEET OR MILLIMETERS FROM THE CENTER LINE OF THE PIPE TO THE FLOOR. THIS DRAWING IS THE PROPERTY OF VIKING FIRE PROTECTION INC. AND IS INTENDED TO BE USED FOR PURPOSES OF THIS PROJECT. THE DISTRIBUTION OR REPRODUCTION IS PROHIBITED UNLESS EXPLICITLY AUTHORIZED. KEEP THIS COPY CLEAN AND RETURN IT TO THE OFFICE AT THE END OF THE PROJECT ALL MODIFICATIONS DONE O SITE MUST BE SHOWN FOREMAN SIGNATURE VERIFICATION CODE (ID) ● → DATE FOREMAN INITIALS THE FOLLOWING TO BE PROVIDED OR PERFORMED BY VIKING OTHER N/A TYTON JOINT
MECH. JOINT THREAD MALL.THREAD C.I. THREAD GALV.
GROOVED
COPPER ABOVEGROUND - MAINS ☐ THREAD MALL. THREAD GALV.

GROOVED 5 K5.6 1/2" VK302 225 S.F. CHROME PENDENT QR PREACTION EDMONTON 5622, 103A Street NW Tel.: (780) 447-46 Edmonton (Alberta) T6H 2J5 Fax: (780) 447-30 BAFFINLAND PORT CAMP ECT BAFFIN ISLAND, NUNAVUT TRACT HORIZON NORTH LOGISTICS INC. LE 3/64"=1'-0" SHEET 1 of 5 DRAWING E150801B


OWNERS MUST MAINTAIN SUFFICIENT HEAT (MINIMUM 5°C/41°F) THROUGHOUT THE AREAS WHERE "WET" SYSTEM ARE INSTALLED TO PREVENT FREEZING OF WATER UNLESS AN ANTI-FREEZE OR A DRY

AS BUILT DRAWINGS

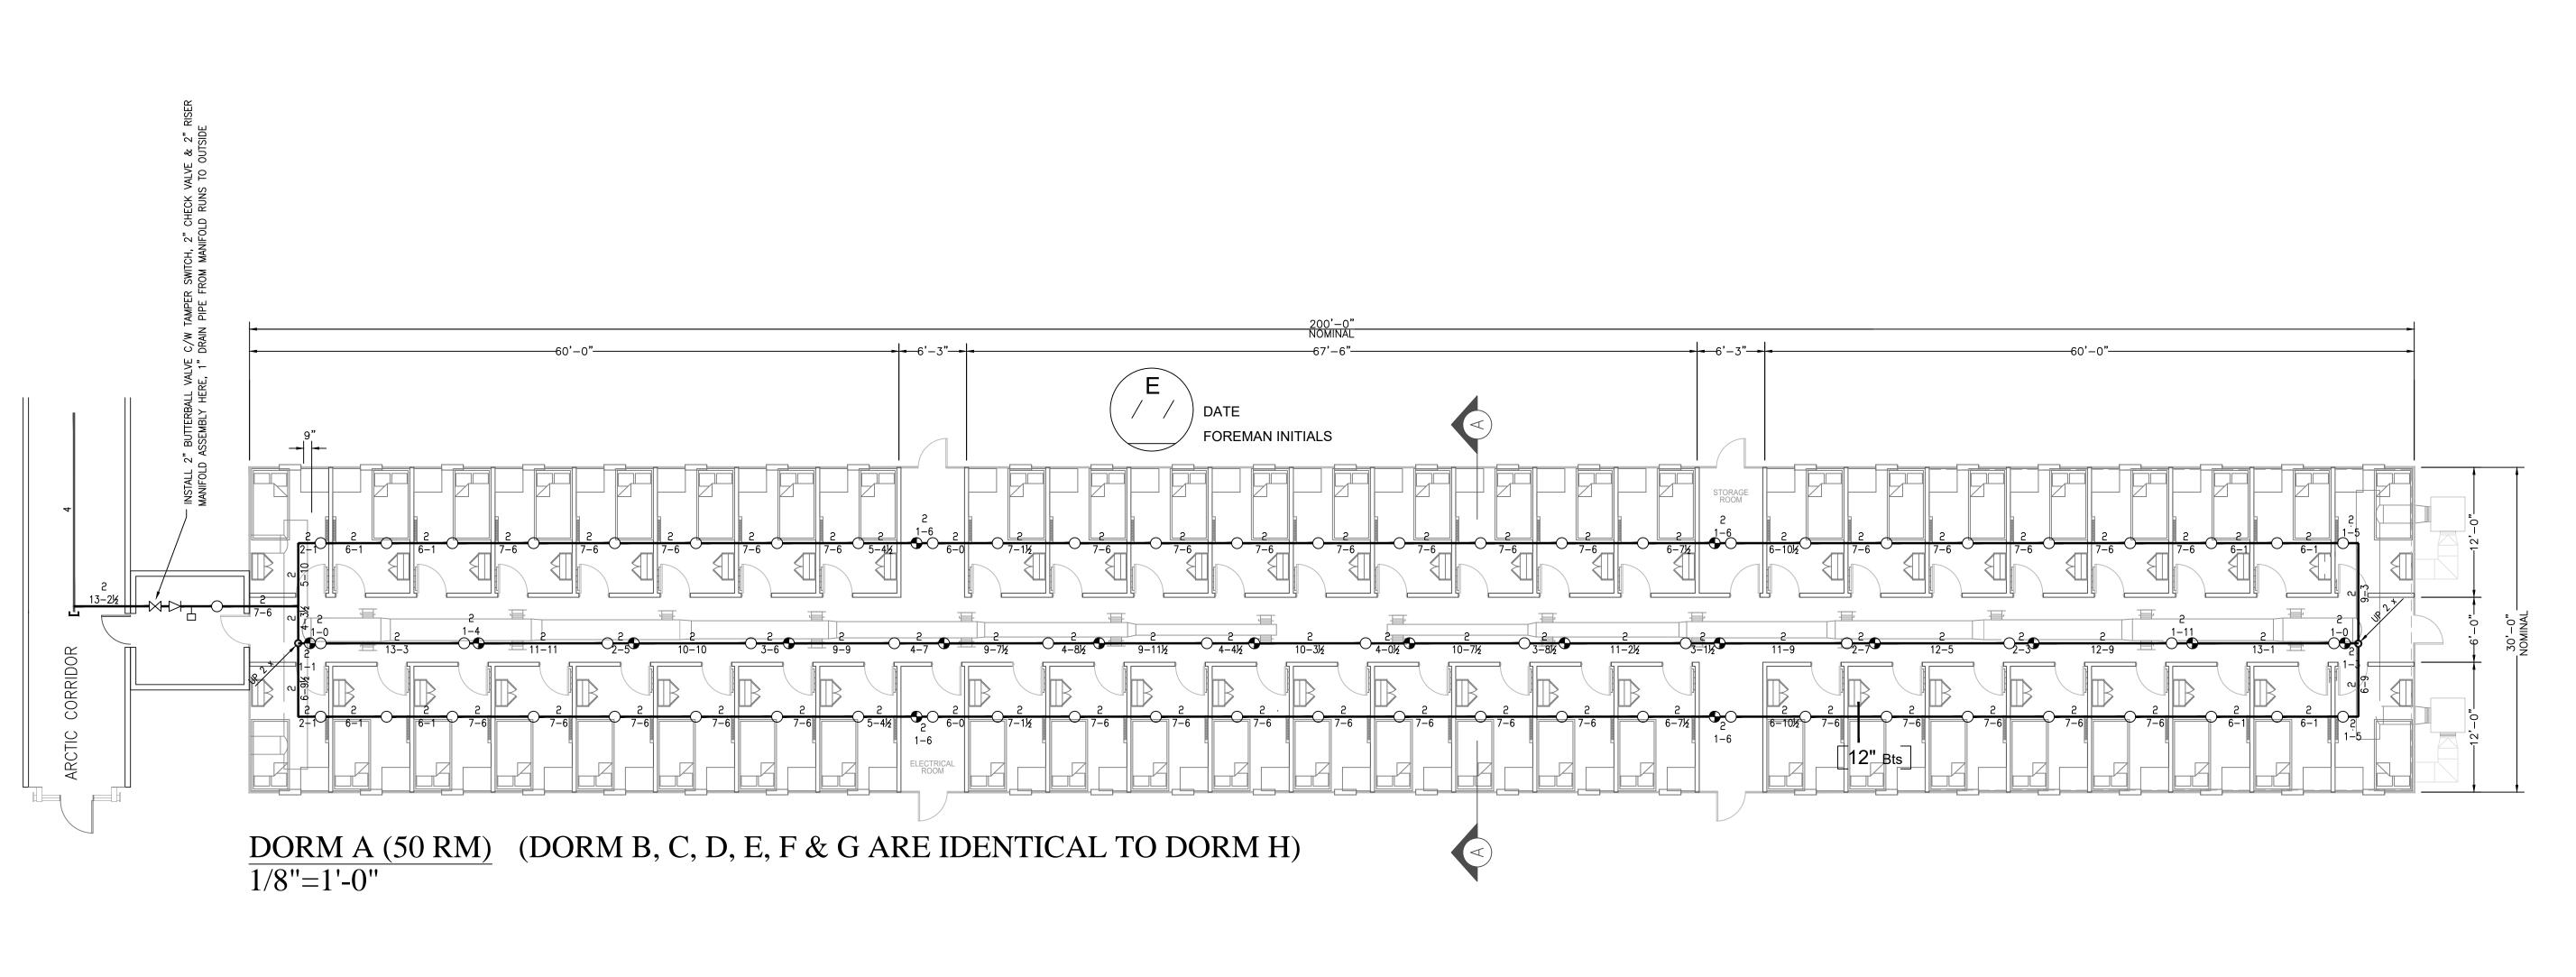


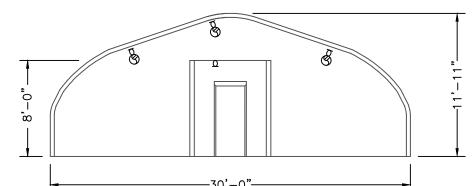

BUILDING SECTION A-A
1/8"=1'-0"

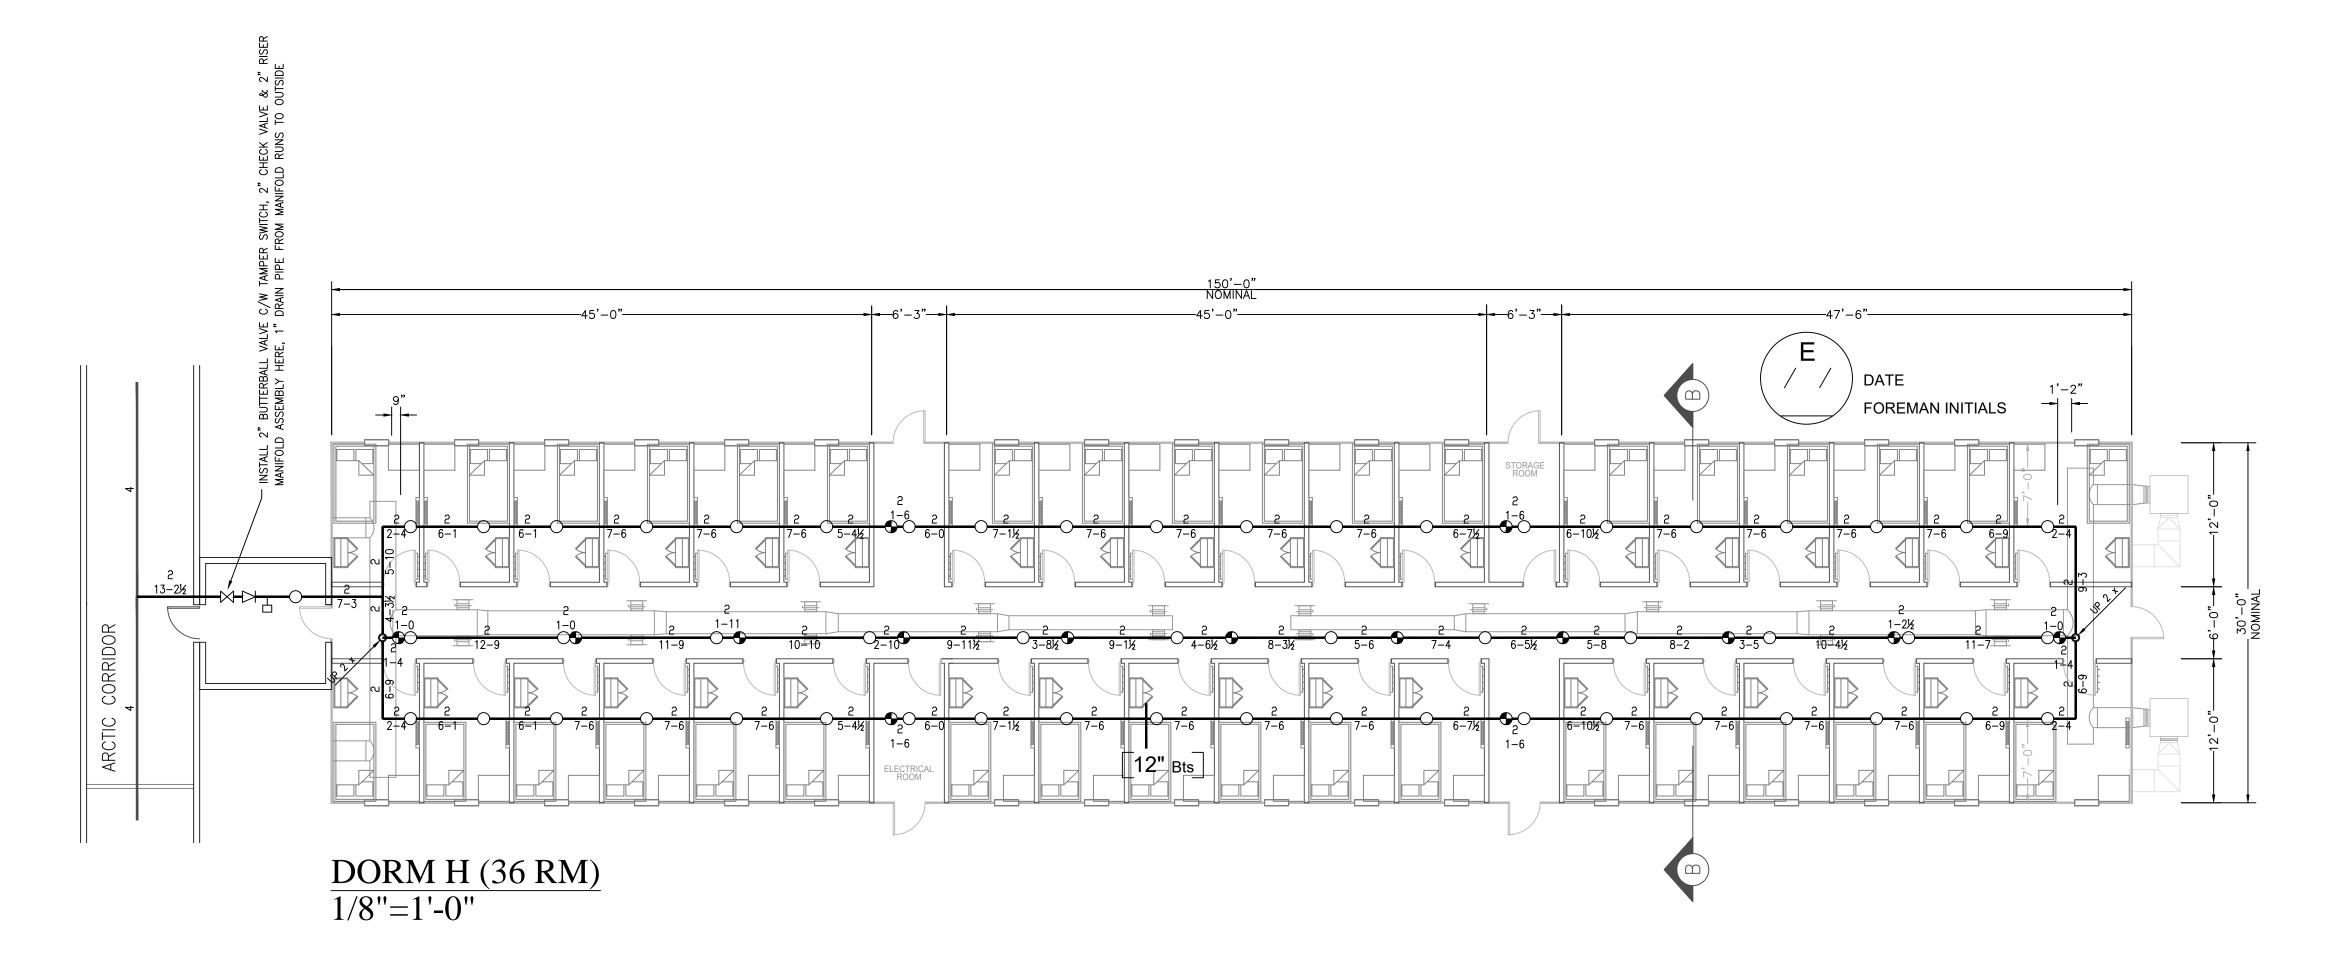

0N-Template-Large Sheet-Rev-B1

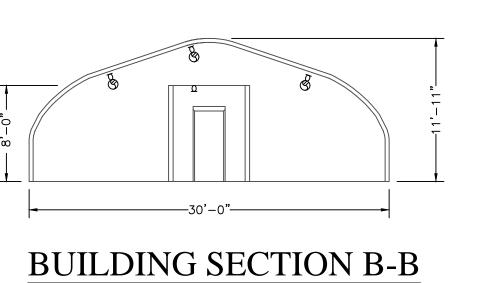


1/8"=1'-0"


NOTES:

PIPES TO BE 2" SCH 10 BLACK PIPES (GROOVED ENDS) C/W WELDED OUTLETS FOR SPRINKLER HEADS, JOINED WITH GROOVED FITTINGS




OWNERS MUST MAINTAIN SUFFICIENT HEAT (MINIMUM 5°C/41°F) THROUGHOUT THE AREAS WHERE "WET" SYSTEM ARE INSTALLED TO PREVENT FREEZING OF WATER UNLESS AN ANTI-FREEZE OR A DRY SYSTEM IS PROVIDED. INDICATES THE DISTANCE IN INCHES OR MILLIMETERS FROM THE CENTER LINE OF THE PIPE TO THE UNDERSIDE OF THE CEILING, CONCRETE SLAB OR ROOF DECK. 1-0 INDICATES THE DISTANCE IN FEET OR MILLIMETERS FROM THE CENTER LINE OF THE PIPE TO THE FLOOR. THIS DRAWING IS THE PROPERTY OF VIKING FIRE PROTECTION INC. AND IS INTENDED TO BE USED FOR PURPOSES OF THIS PROJECT. THE DISTRIBUTION OR REPRODUCTION IS PROHIBITED UNLESS EXPLICITLY AUTHORIZED. KEEP THIS COPY CLEAN AND RETURN IT TO THE OFFICE AT THE END OF THE PROJECT FOREMAN SIGNATURE VERIFICATION CODE (ID) ● DATE FOREMAN INITIALS THE FOLLOWING TO BE PROVIDED OR PERFORMED BY EDMONTON 5622, 103A Street NW Tel.: (780) 447-46
Edmonton (Alberta) T6H 2J5 Fax: (780) 447-30 BAFFINLAND PORT CAMP NLE 1/8"=1'-0" SHEET 2 OF 5 DRAWING E150802B

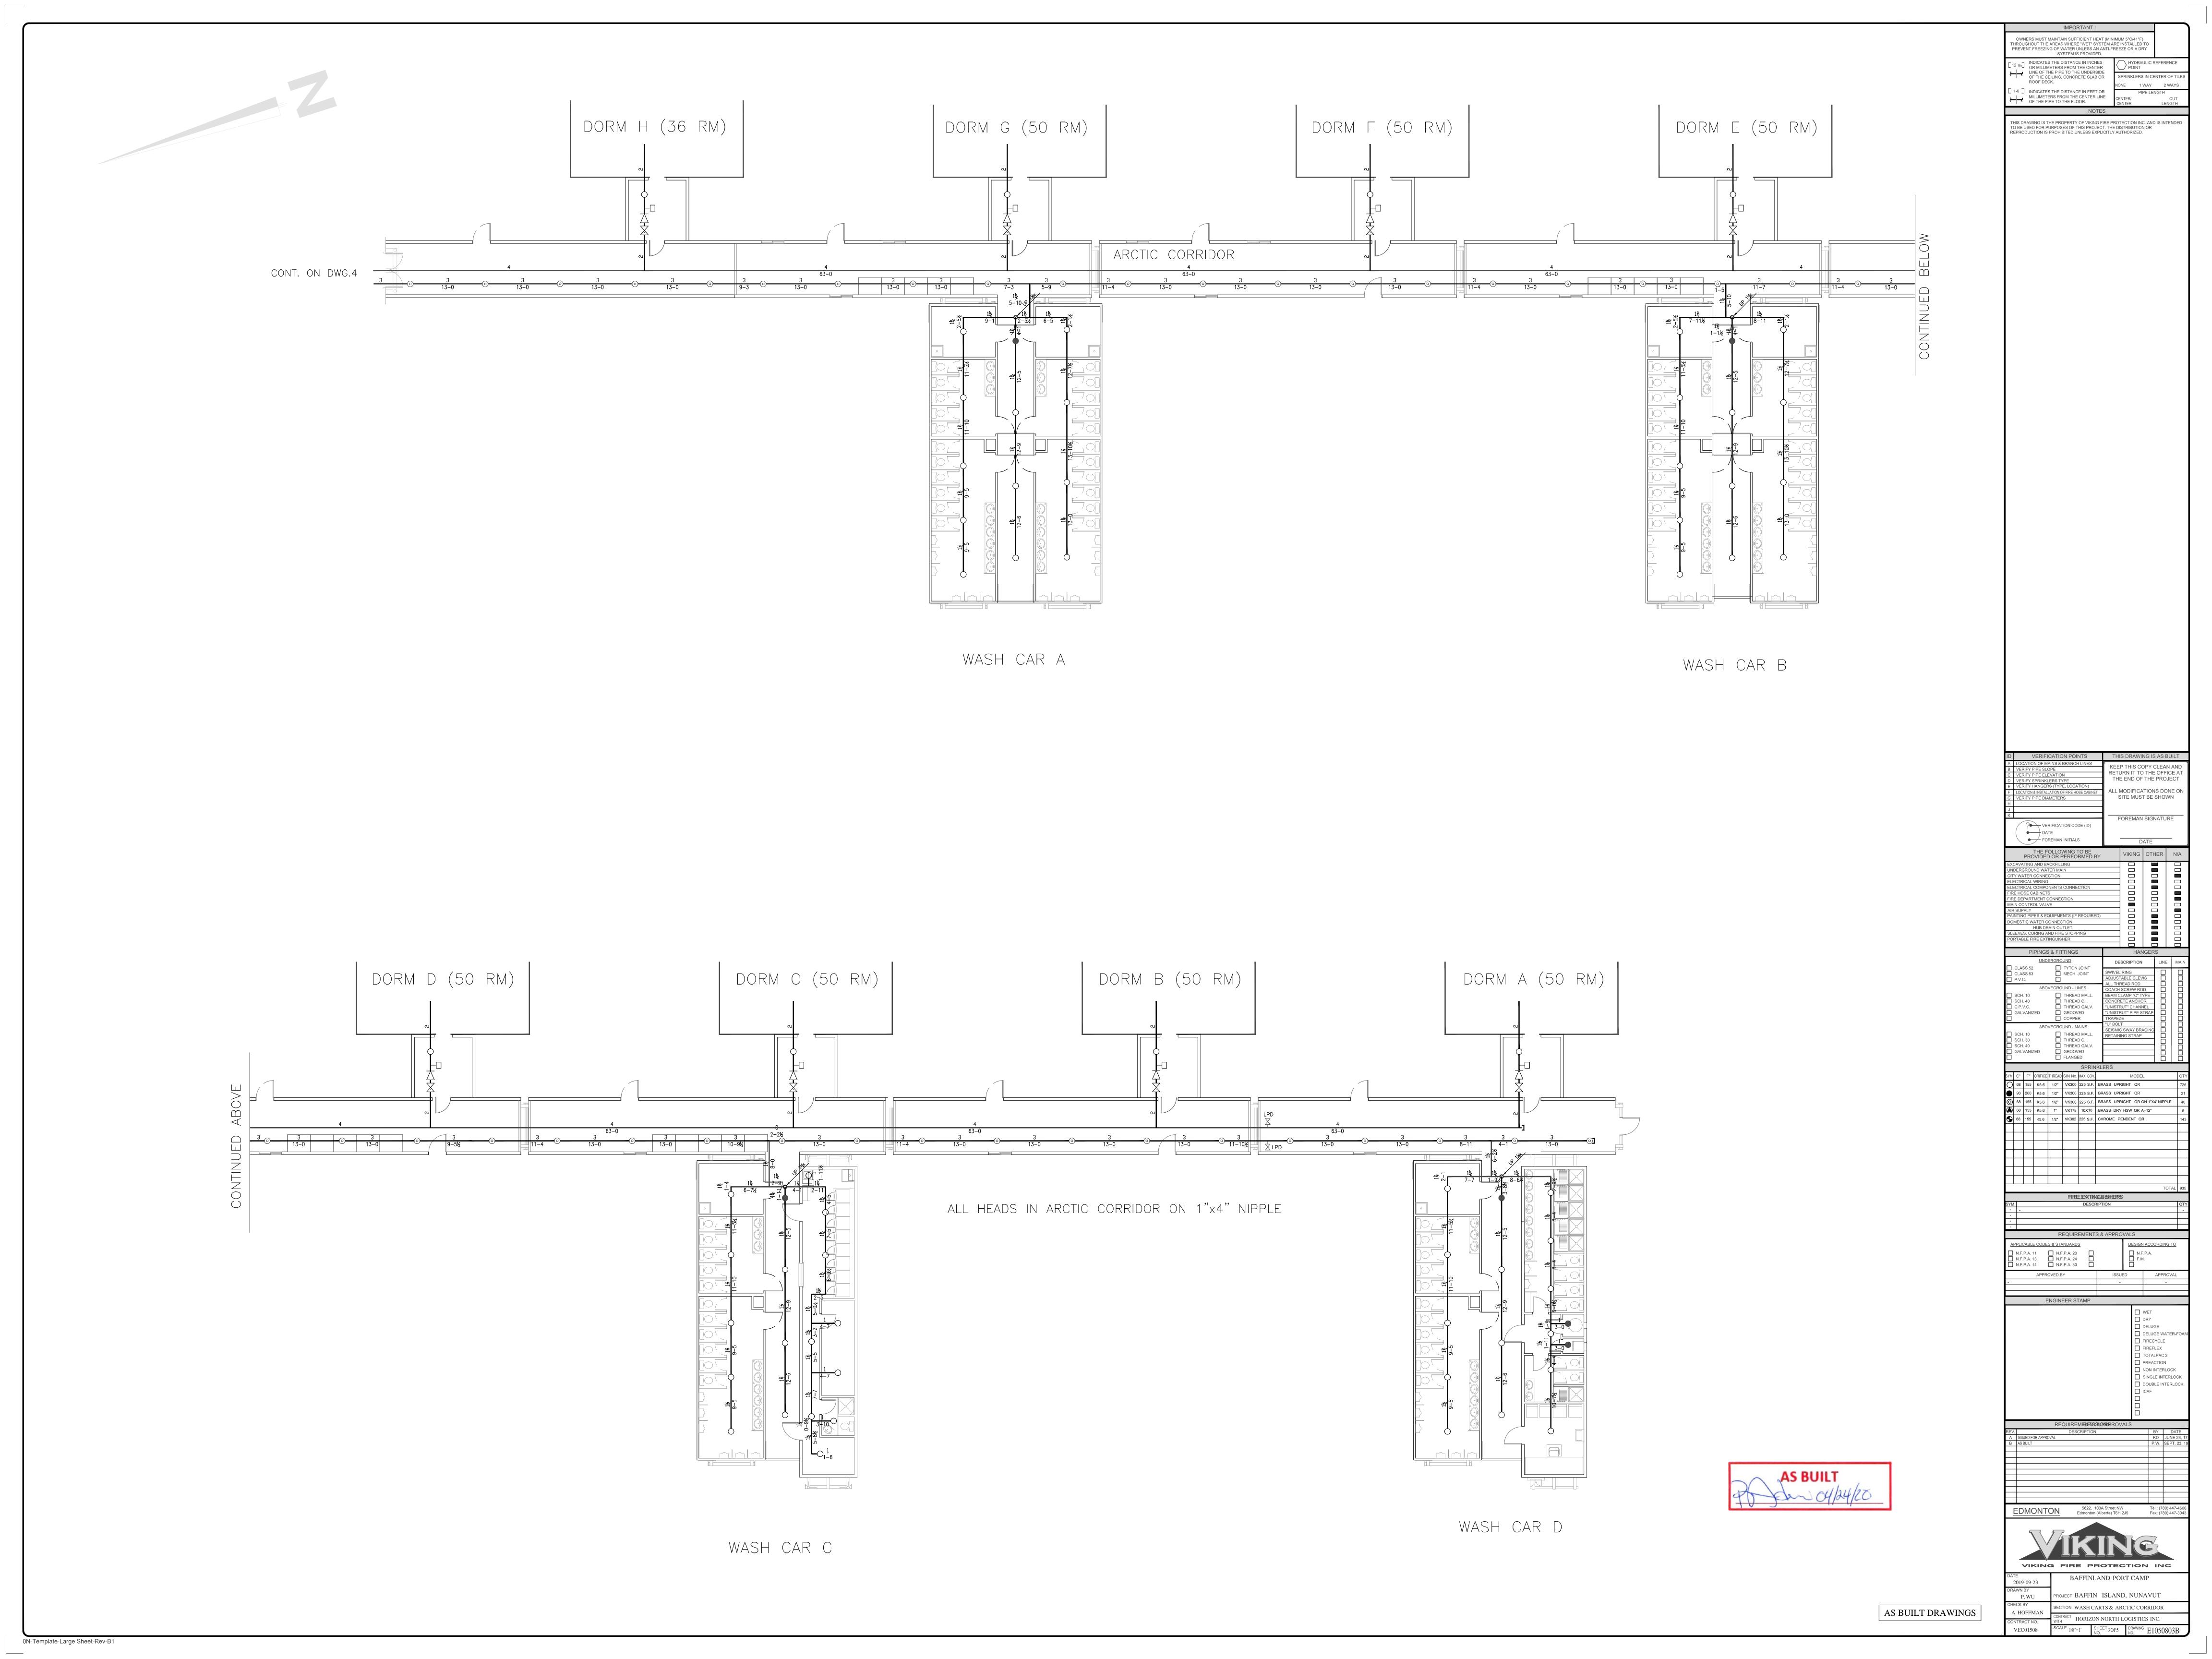

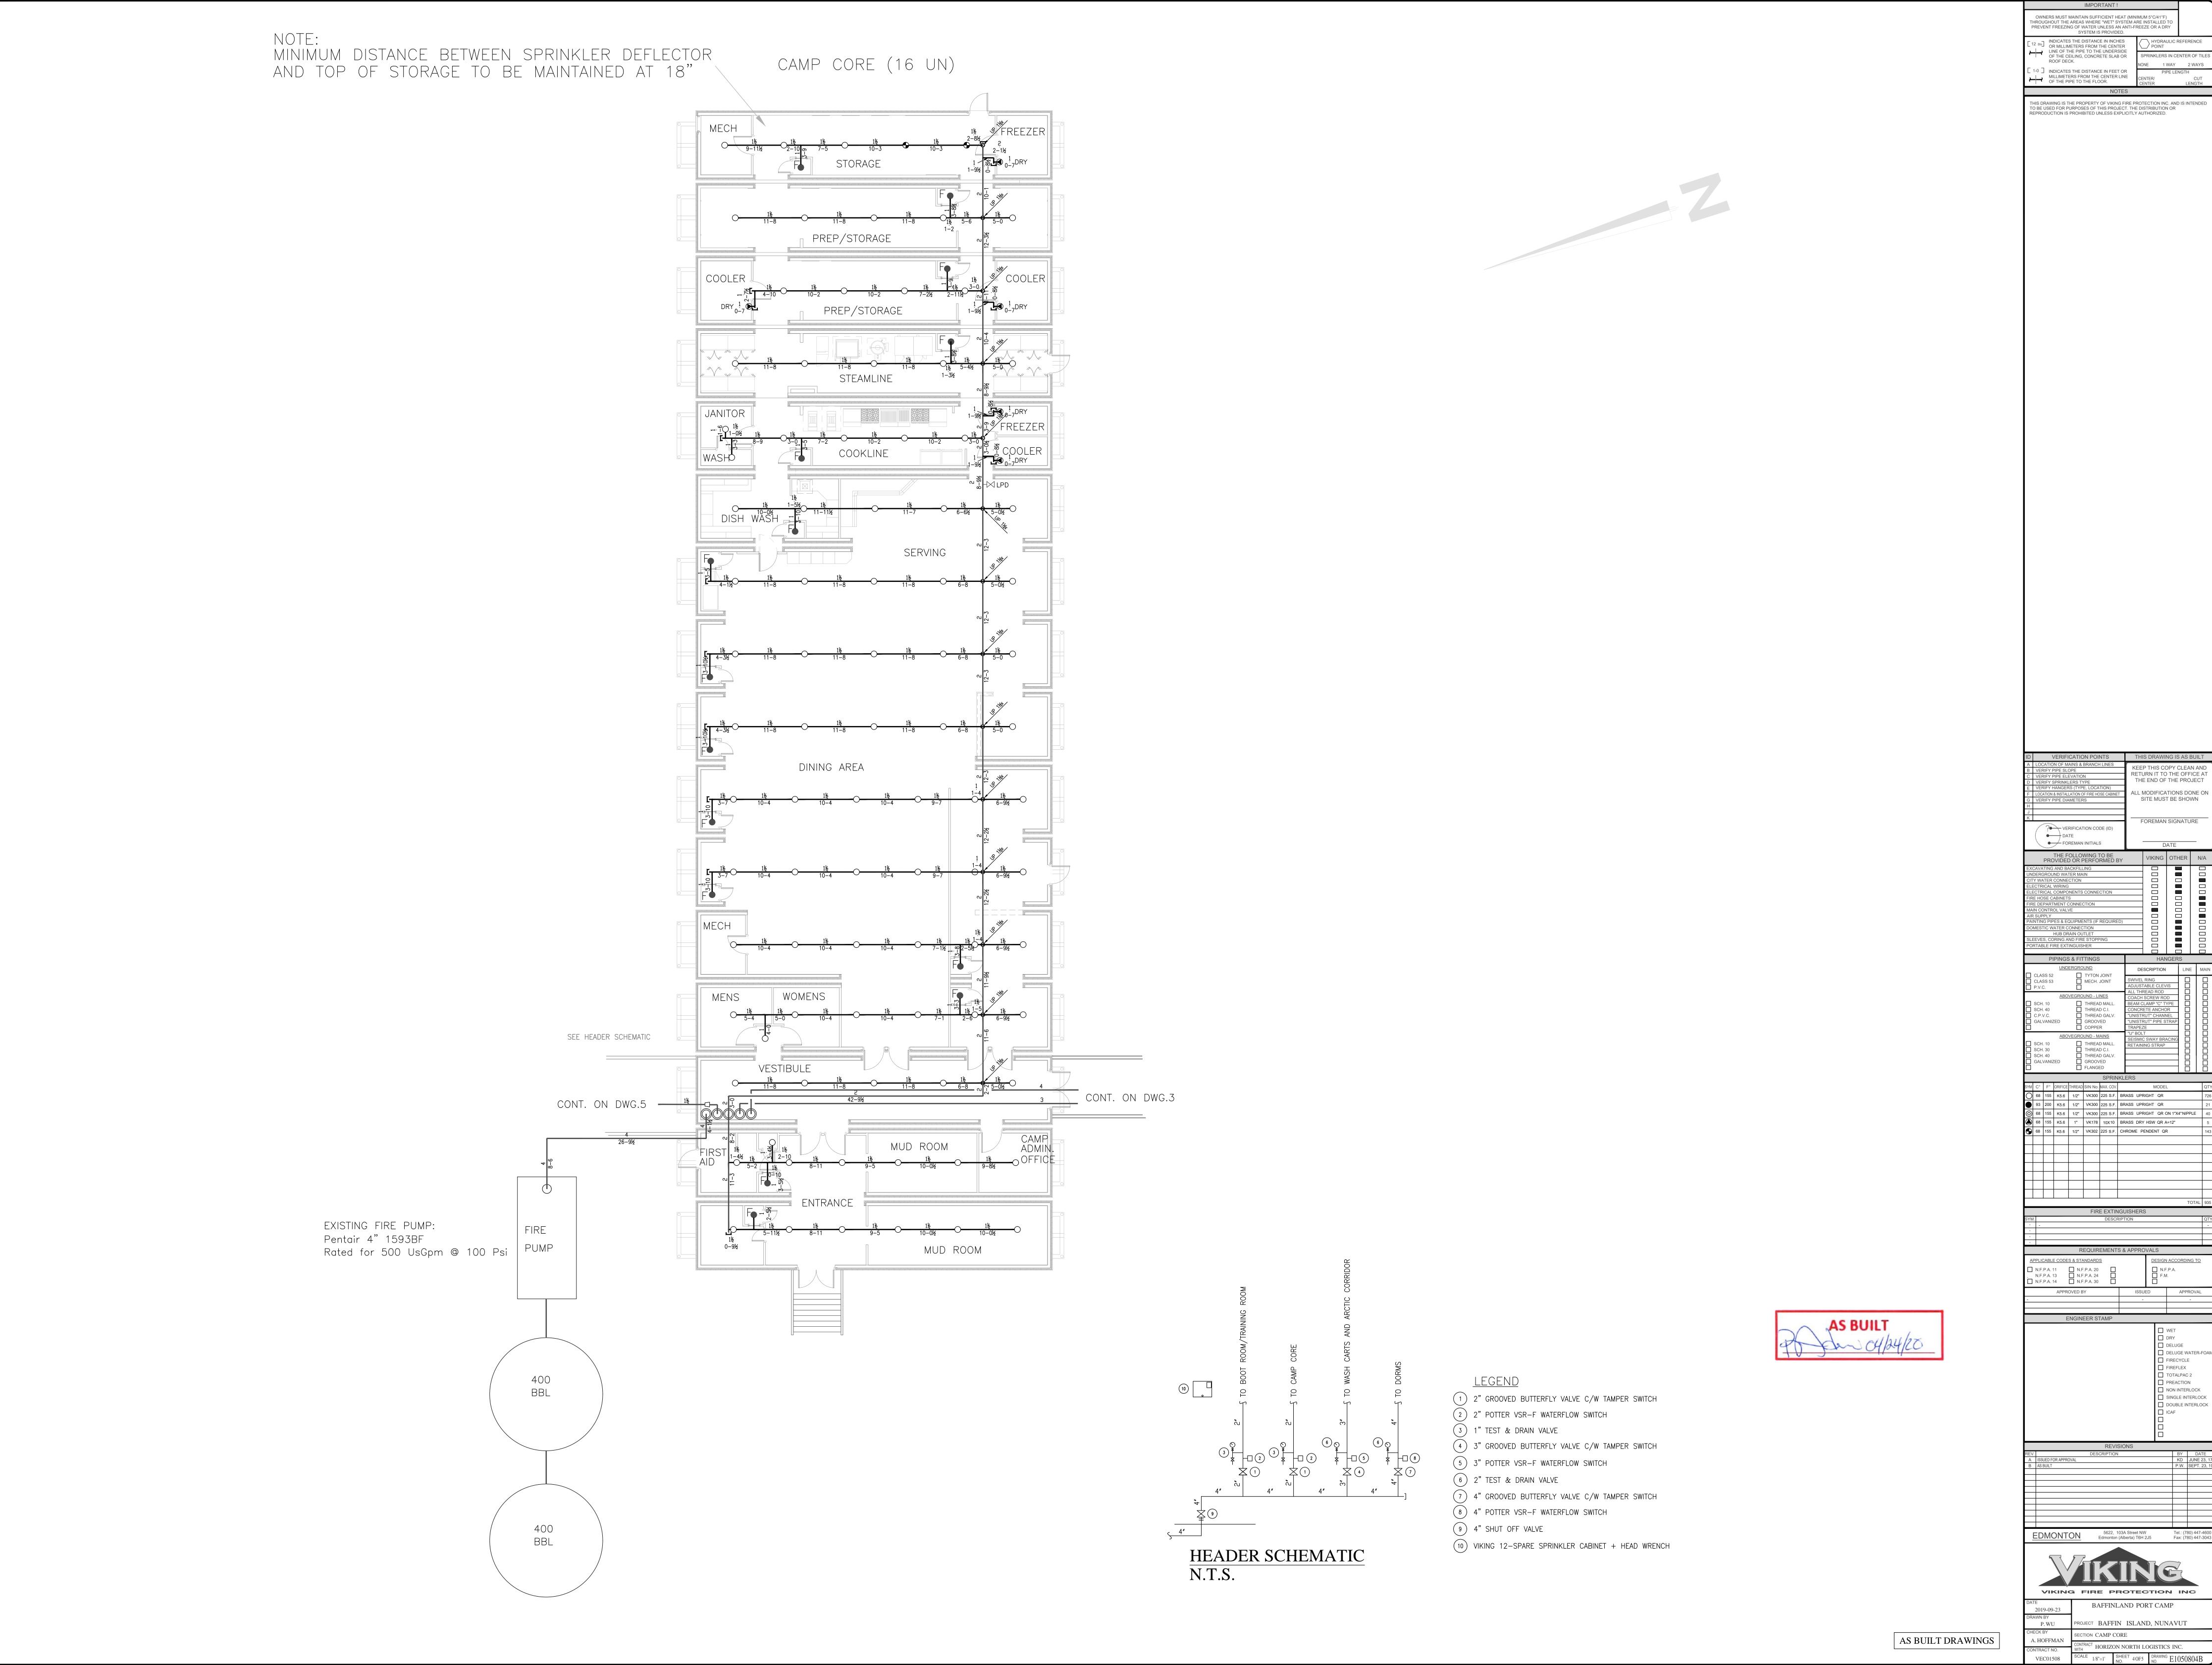

0N-Template-Large Sheet-Rev-B1

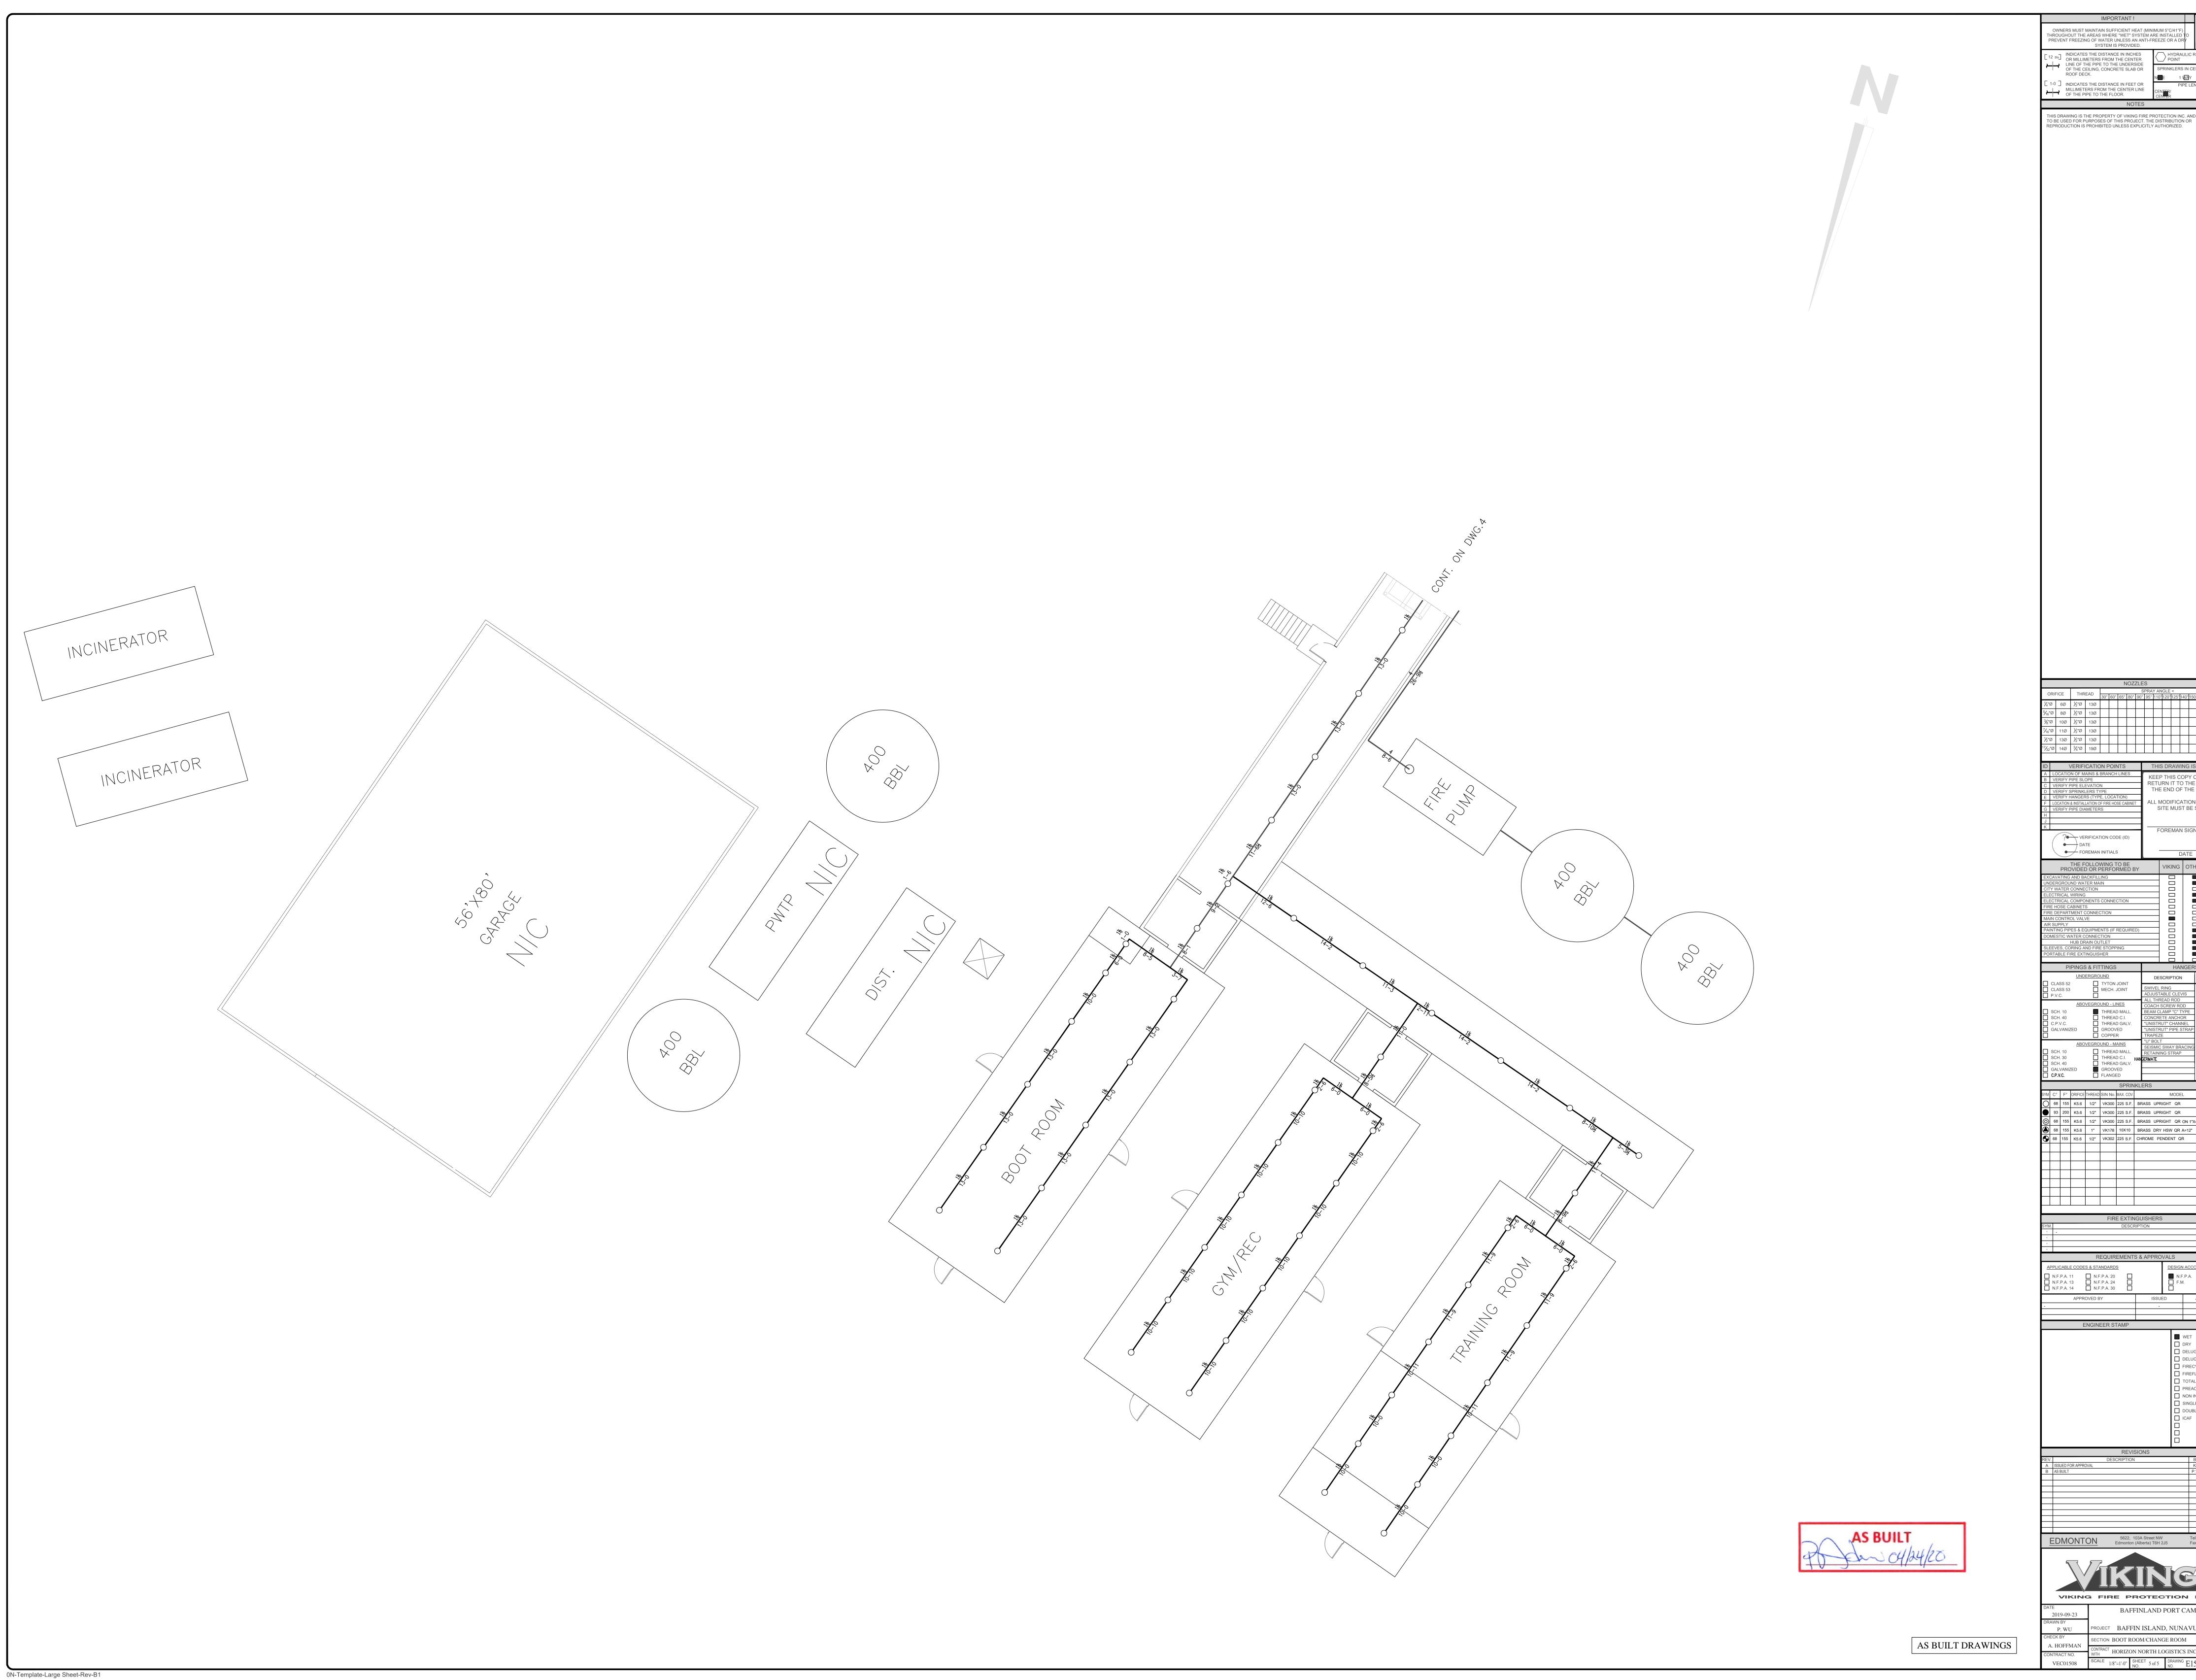


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DATE
FOREMAN INITIALS THE FOLLOWING TO BE PROVIDED OR PERFORMED BY

CAVATING AND BACKFILLING

DERGROUND WATER MAIN

TY WATER CONNECTION TOTALPAC 2 PREACTION ■ NON INTERLOCK SINGLE INTERLOCK ■ DOUBLE INTERLOCK EDMONTON 5622, 103A Street NW Tel.: (780) 447-460 Fax: (780) 447-304 BAFFINLAND PORT CAMP JECT BAFFIN ISLAND, NUNAVUT

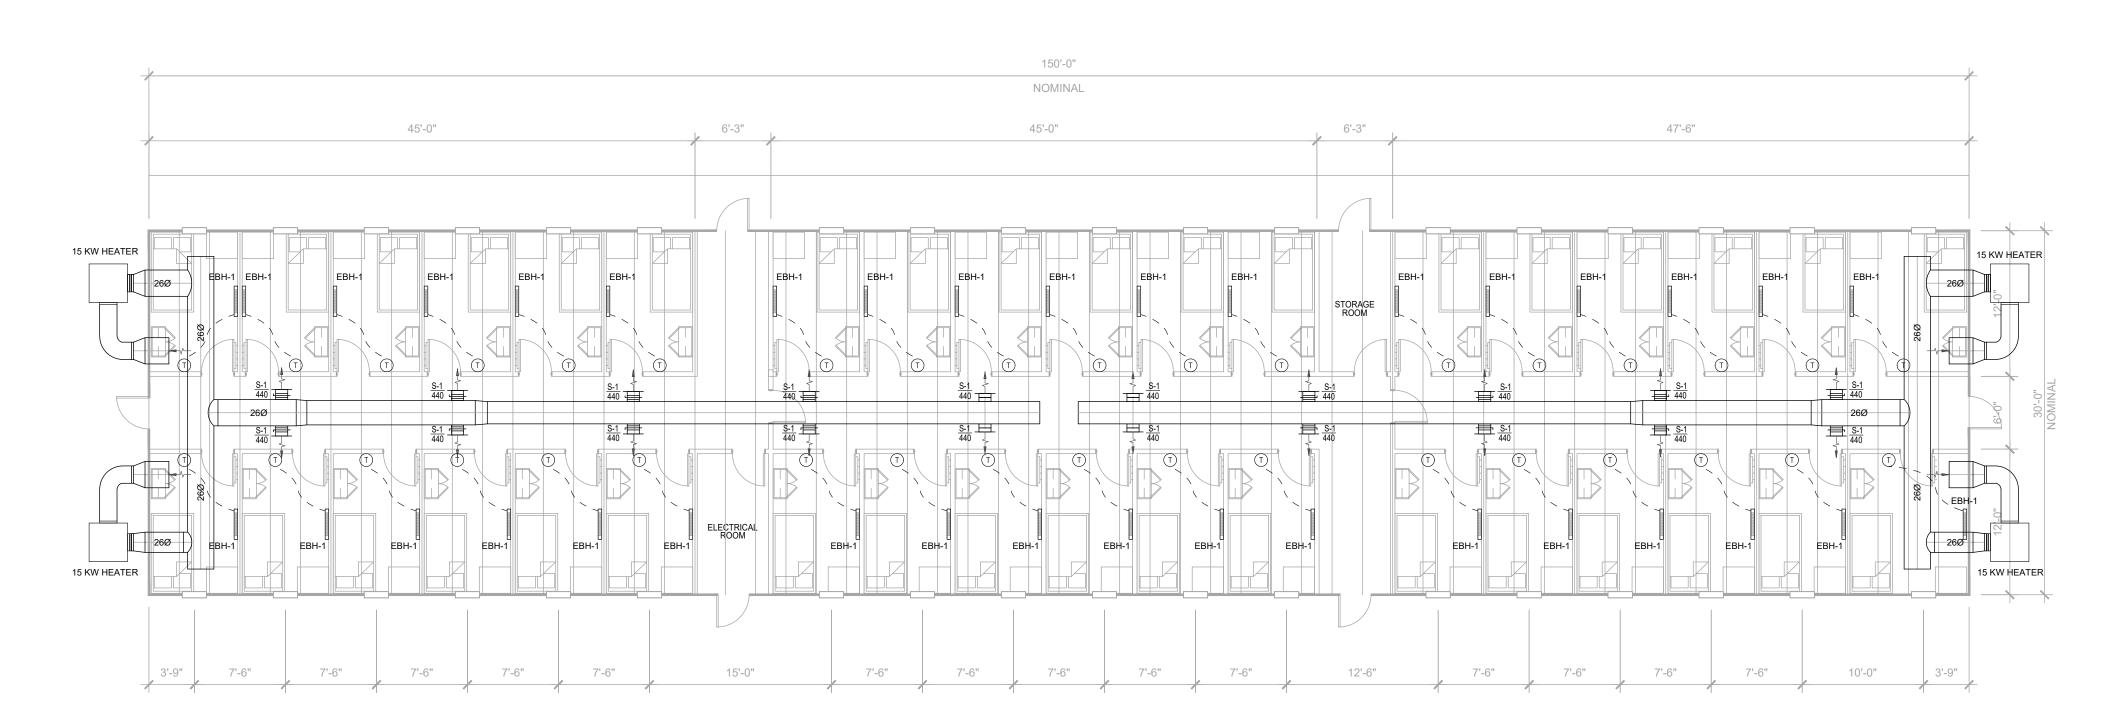





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- ALL WORK AND MATERIALS SHALL COMPLY WITH THE MANUFACTURER'S PRINTED INSTALLATION INSTRUCTIONS.
- ALL PIPING, TUBING, DUCTS, WIRING, CONDUITS, ETC. PASSING THROUGH FIRE RATED SEPARATIONS SHALL BE SMOKE AND FIRE PROOFED WITH ULC APPROVED MATERIALS IN ACCORDANCE WITH CAN4-S115 AND ASTM EB814 STANDARDS AND WHICH MEET THE REQUIREMENTS OF THE PROVINCIAL BUILDING CODE.
- CONFIRM ALL REQUIREMENTS, LOCATIONS, CONDITIONS, AND DIMENSIONS PRIOR TO COMMENCING WORK. COORDINATE ALL
 MECHANICAL INSTALLATIONS WITH ARCHITECTURAL, STRUCTURAL AND ELECTRICAL LAYOUTS, CONFIRM EXACT LOCATIONS AND
 METHODS FOR PIPING, DUCTWORK AND EQUIPMENT SUPPORTS ON THE SITE PRIOR TO INSTALLATIONS.
- CEILING SPACE UTILIZED AS RETURN AIR PLENUM. PLENUM RATED SYSTEMS SHALL BE IN COMPLIANCE WITH CSA B181.2 AND CAN/ULC S102.2, HAVE A FLAME SPREAD RATING OF NOT MORE THAN 25 AND SMOKE DEVELOPMENT CLASSIFICATION OF NOT MORE THAN 50 IN ACCORDANCE WITH CAN/ULC S 102, NFPA 255 AND ASTM E84.
- ALL DUCT SIZES ARE INSIDE CLEAR DIMENSIONS, UNLESS OTHERWISE INDICATED. FOR ACOUSTICALLY LINES OR INTERNALLY INSULATED DUCTS MAINTAIN SIZES INSIDE DUCTS.



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No.	Description	Date
1	ISSUED FOR REVIEW	YYYY-MM-DD

CONTRACTOR

SEA

DRAWN BY:	EFREN DALIDA / IAN ESPARES
CHECKED BY:	DALEN SCHADECK, E.I.T.
ENGINEER:	HAYDAR AL DAHHAN, P.ENG.
DATA FILE:	K:\Management Team Folder\Projects\201 \170109 Baffinland Iron Mines \BUILDING DESIGN\MECHANICAL
DATE:	MAY 2017
SCALE:	1/8" = 1' - 0"

PROJECT


Baffinland Iron Mines

DESCRIPT

Main Floor
HVAC Layout
(36 Person Complex)

M2.0

SHEET 2

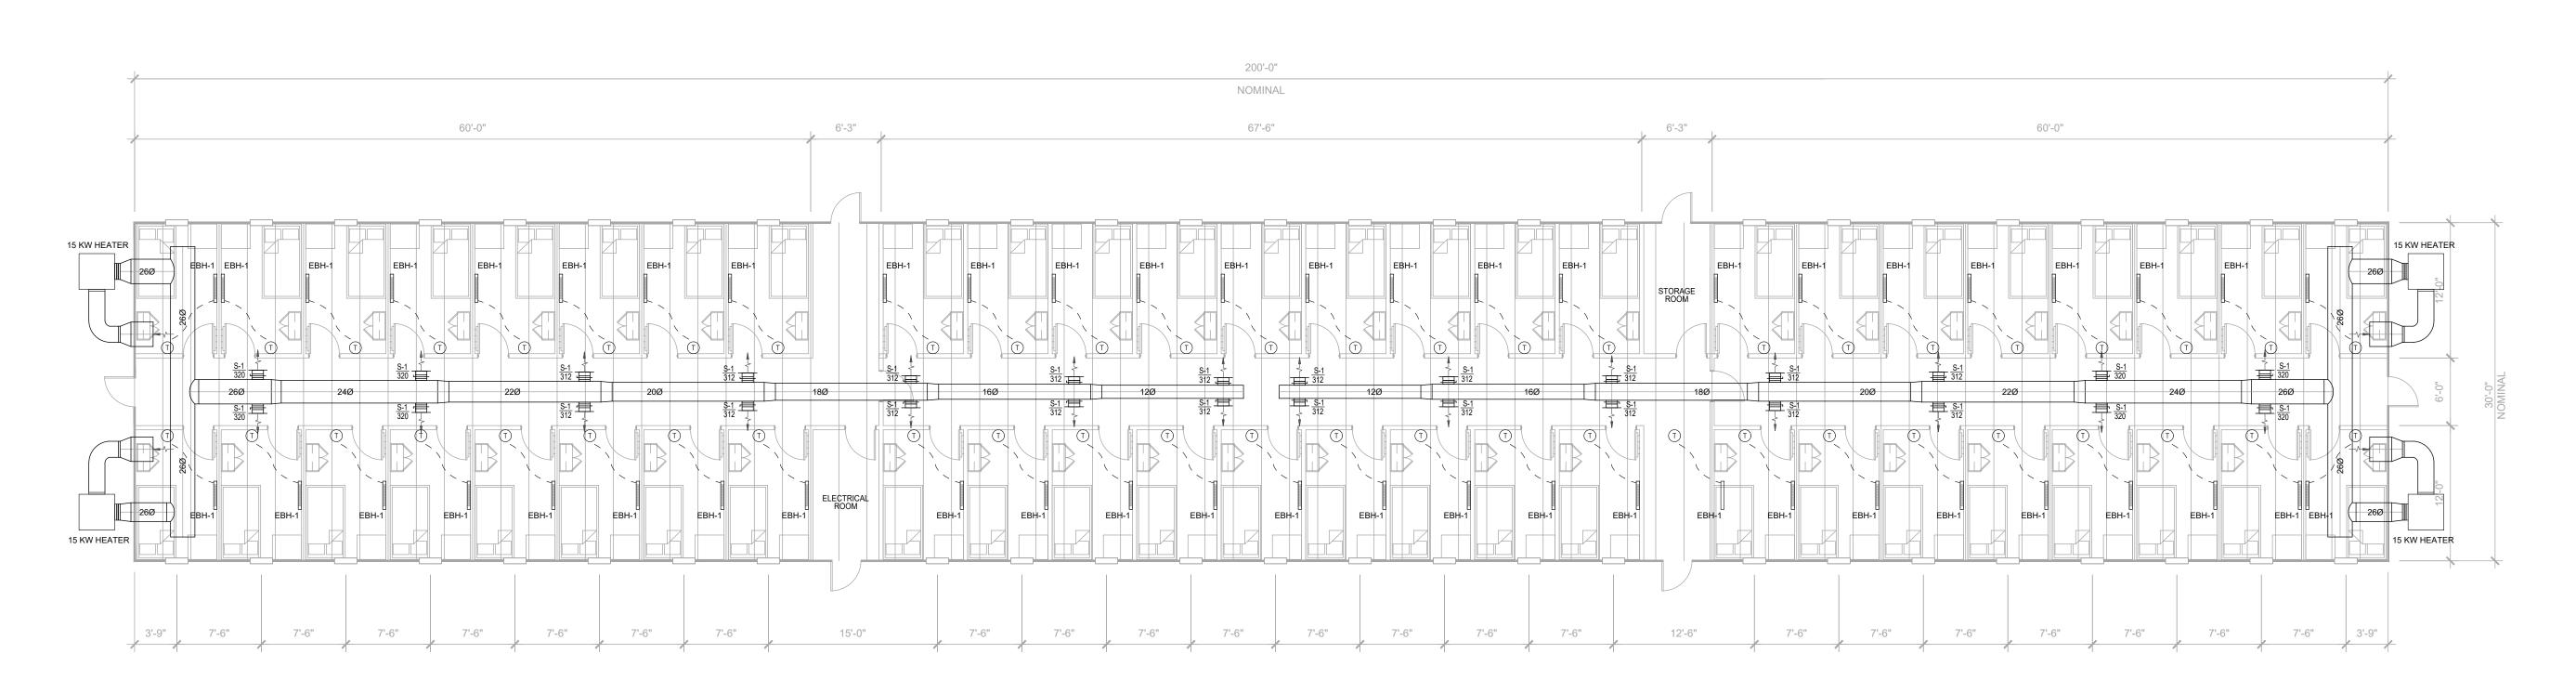





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- CONFIRM ALL REQUIREMENTS, LOCATIONS, CONDITIONS, AND DIMENSIONS PRIOR TO COMMENCING WORK. COORDINATE ALL
 MECHANICAL INSTALLATIONS WITH ARCHITECTURAL, STRUCTURAL AND ELECTRICAL LAYOUTS, CONFIRM EXACT LOCATIONS AND
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OF THE APPLICABLE BUILDING CODE, AND ANY OTHER
GOVERNING AUTHORITY.

No.	Description ISSUED FOR REVIEW	YYYY-MM-
I		
SEAL		

DRAWN BY:	EFREN DALIDA / IAN ESPARES
CHECKED BY:	DALEN SCHADECK, E.I.T.
ENGINEER:	HAYDAR AL DAHHAN, P.ENG.
DATA FILE:	K:\Management Team Folder\Projects\2017 \170109 Baffinland Iron Mines \BUILDING DESIGN\MECHANICAL
DATE:	MAY 2017
SCALE:	1/8" = 1' - 0"
•	

PROJECT

Baffinland Iron Mines

DESCRIPT

Main Floor
HVAC Layout
(50 Person Complex)

M2.1

SHEET 4



DesignWorks Engineering + Inspections Ltd.

Baffinland Iron Mines Mechanical Drawing List

DESCRIPTION	DRAWING NO.	SHEET NO.
Mechanical Cover Page	M1.0	1
Main Floor HVAC Layout (36 person complex)	M2.0	2
Main Floor HVAC Layout (50 person complex)	M2.1	3
Mechanical Specifications and Schedules	M3.0	4



Engineering + Inspections Ltd.

P: 780 814 5533 **F**: 780-800-2112 9905 97 Avenue, Grande Prairie, AB, T8V 0N2 info@designworkseng.com www.designworkseng.com

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ALL WORK MUST COMPLY WITH THE MOST RECENT EDITION OF THE APPLICABLE BUILDING CODE, AND ANY OTHER

ISSUED FOR REVIEW	YYYY-MM-DD
	+

CONTRACTOR


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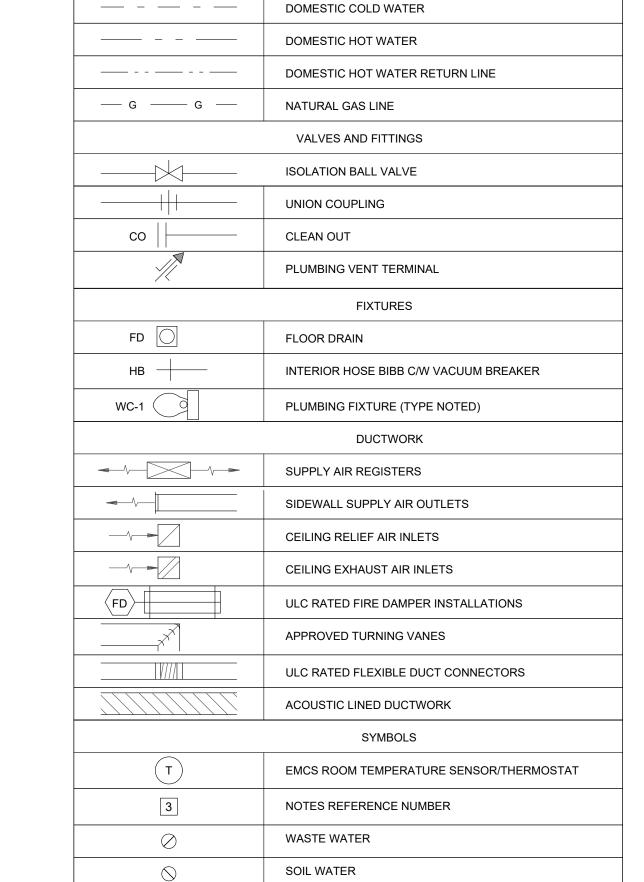
DRAWN BY:	EFREN DALIDA / IAN ESPARES
CHECKED BY:	DALEN SCHADECK, E.I.T.
ENGINEER:	HAYDAR AL DAHHAN, P.ENG.
DATA FILE:	K:\Management Team Folder\Projects\2017 \170109 Baffinland Iron Mines \BUILDING DESIGN\MECHANICAL
DATE:	MAY 2017
SCALE:	Not To Scale

Baffinland Iron Mines

Mechanical Cover Page

M1.0



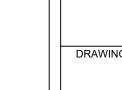

RAIN WATER

TOTAL GAS LOAD FOR G/M-1

DESCRIPTION

ROOF TOP UNIT

2 PSIG BASED ON A PRESSURE DROP OF 1 PSIG

INPUT (MBH)

150

1,000

1,150

EQUIPMENT

FOR FUTURE

MECHANICAL SYMBOL SCHEDULE


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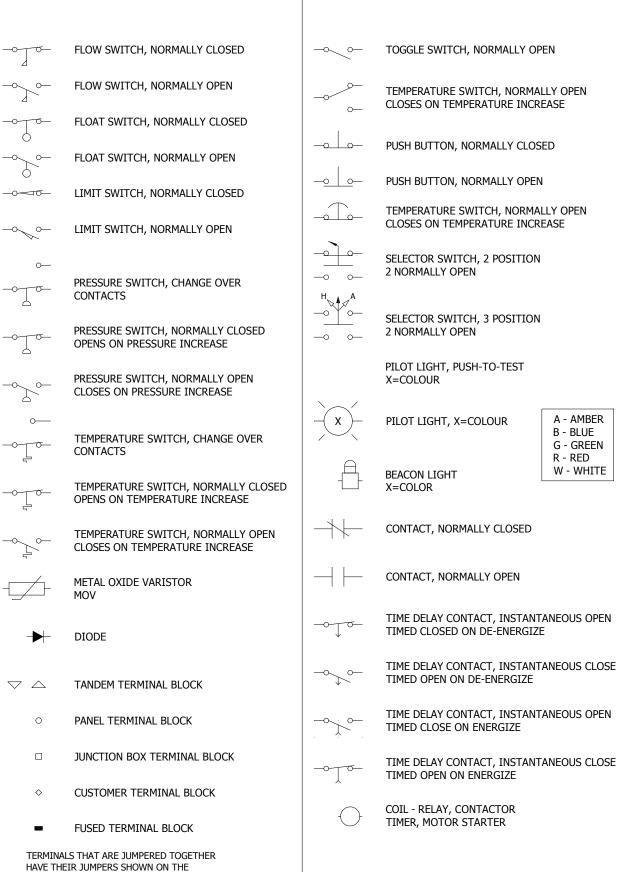
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BURIED SANITARY SEWER

BURIED WATER


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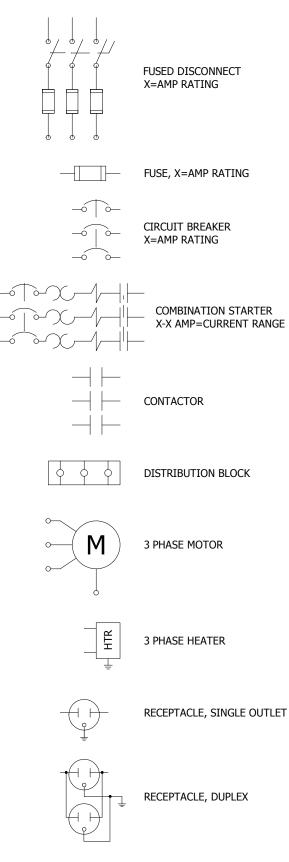





TERMINAL STRIP LAYOUTS

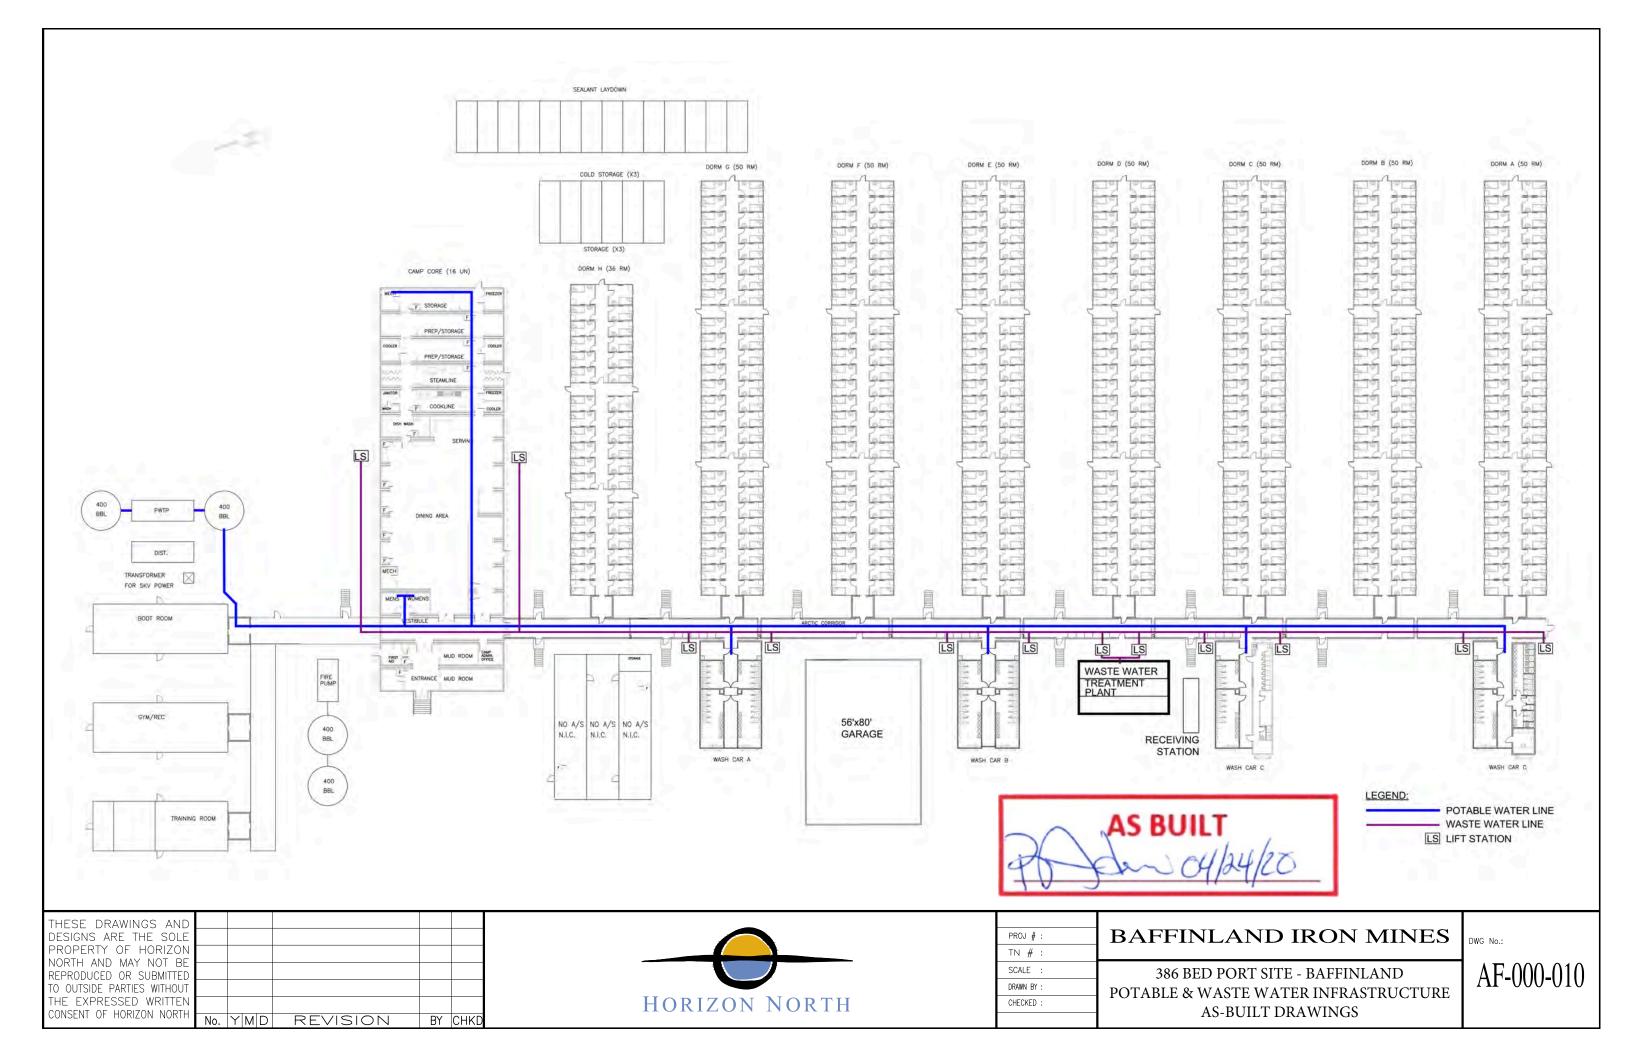NOTES:



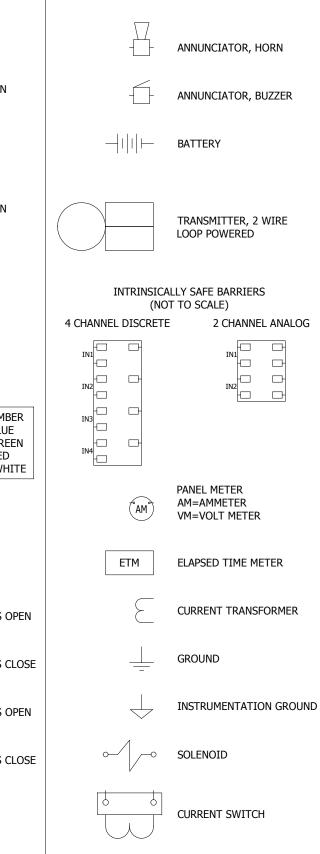

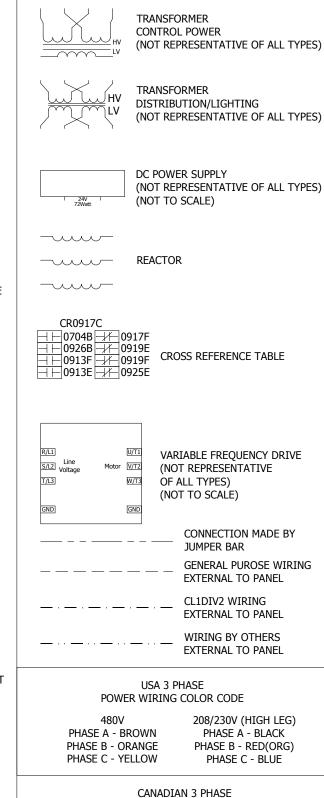





1291 CALIFORNIA AVE. BROCKVILLE ONTARIO CANADA K6V 5Y6

PROJ. NO: TITLE AND LOCATION UPDATED VFD 24/05/2017 ccliffe A2 24/05/2017 ADDED H-0501 A1 FOR APPROVAL 24/05/2017 ccliffe LEVEL REVISION DATE


PHASE B - BLACK PHASE C - BLUE


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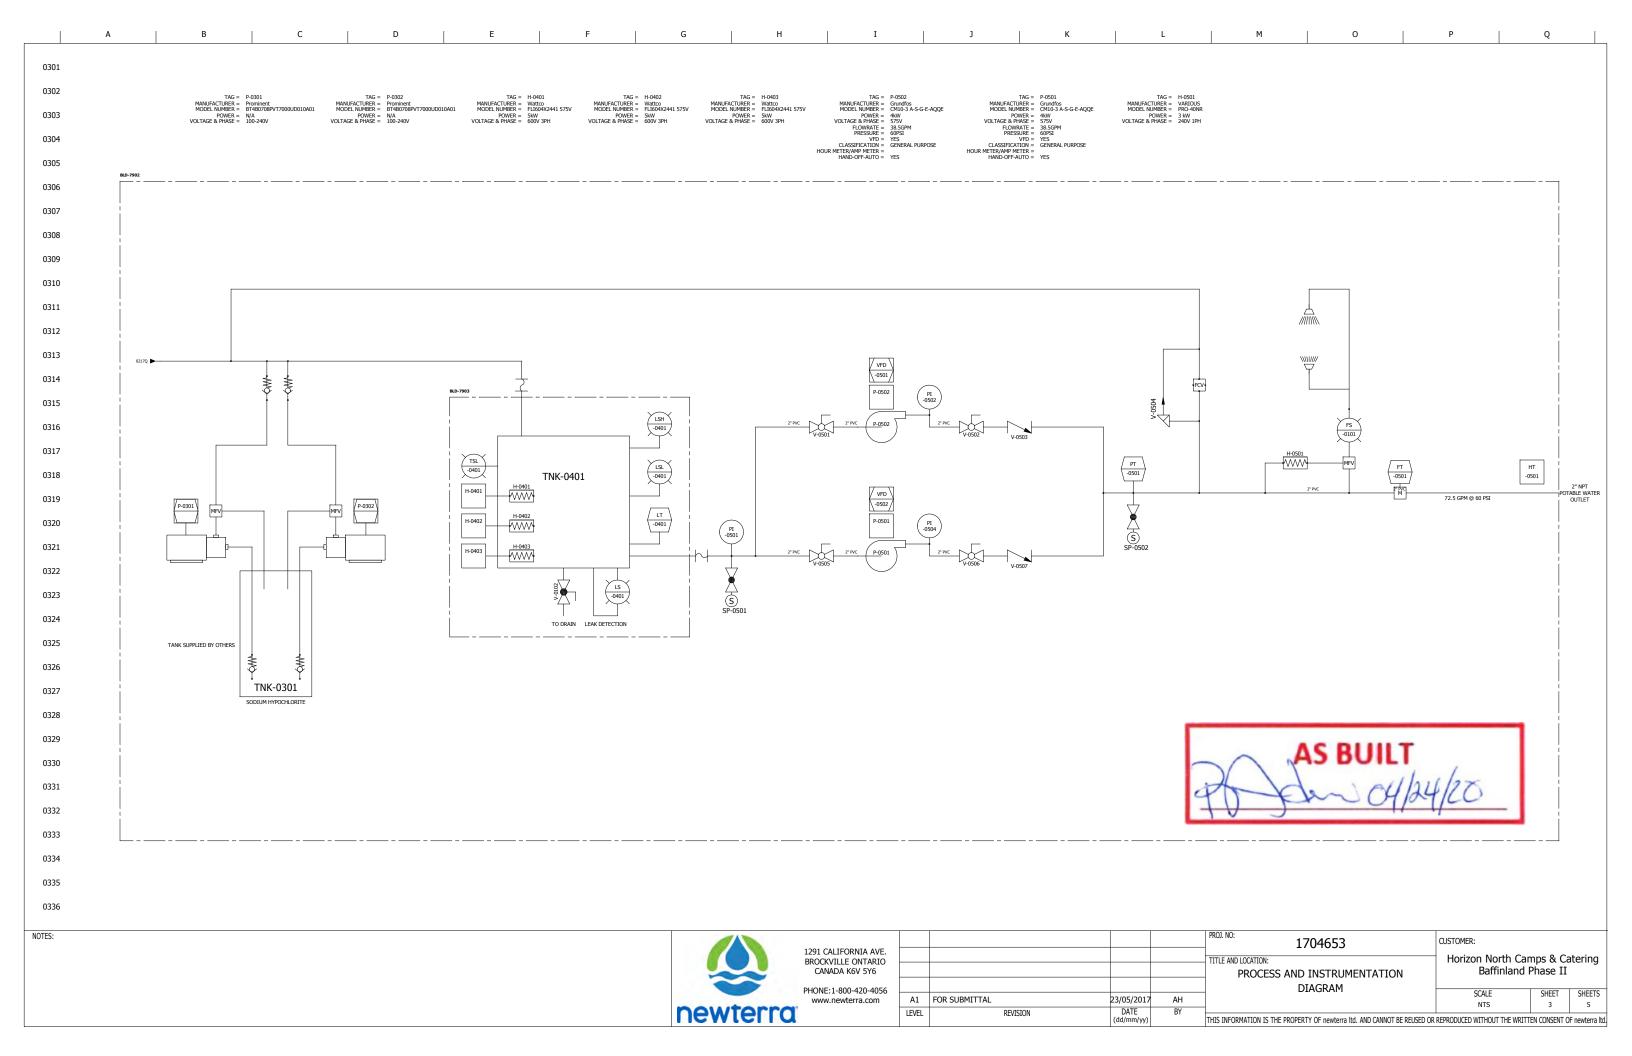
POWER WIRING COLOUR CODE PHASE A - RED


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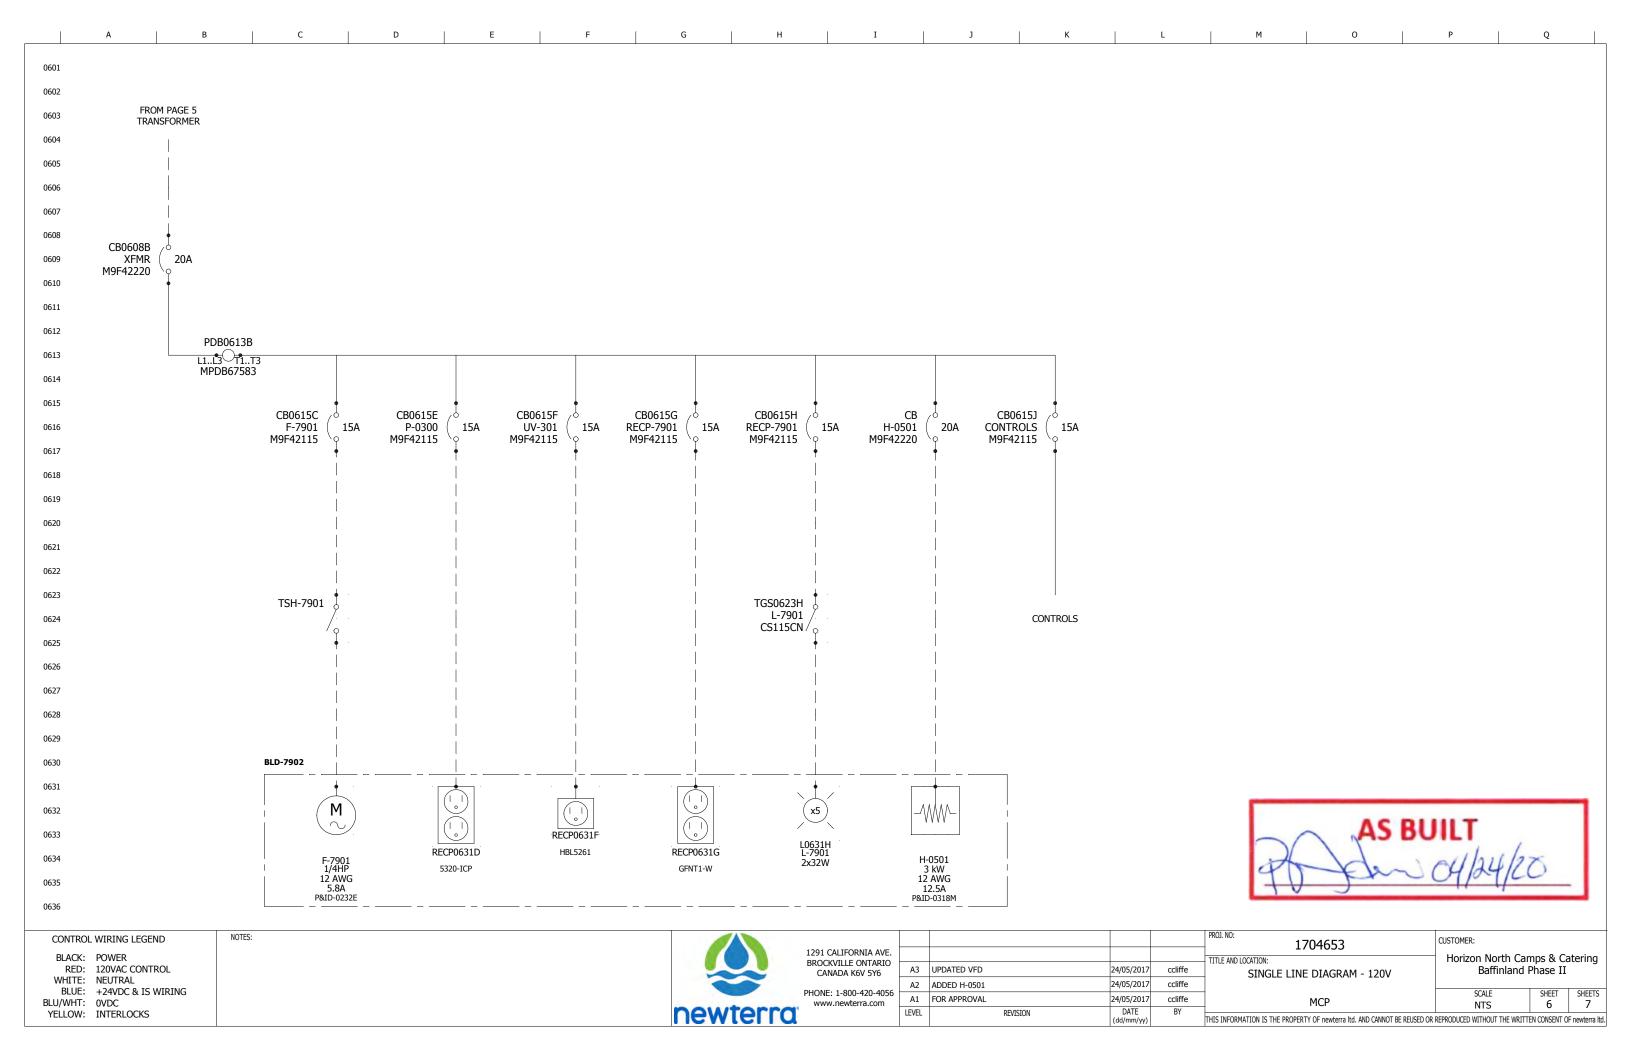
PHONE: 1-800-420-4056 www.newterra.com







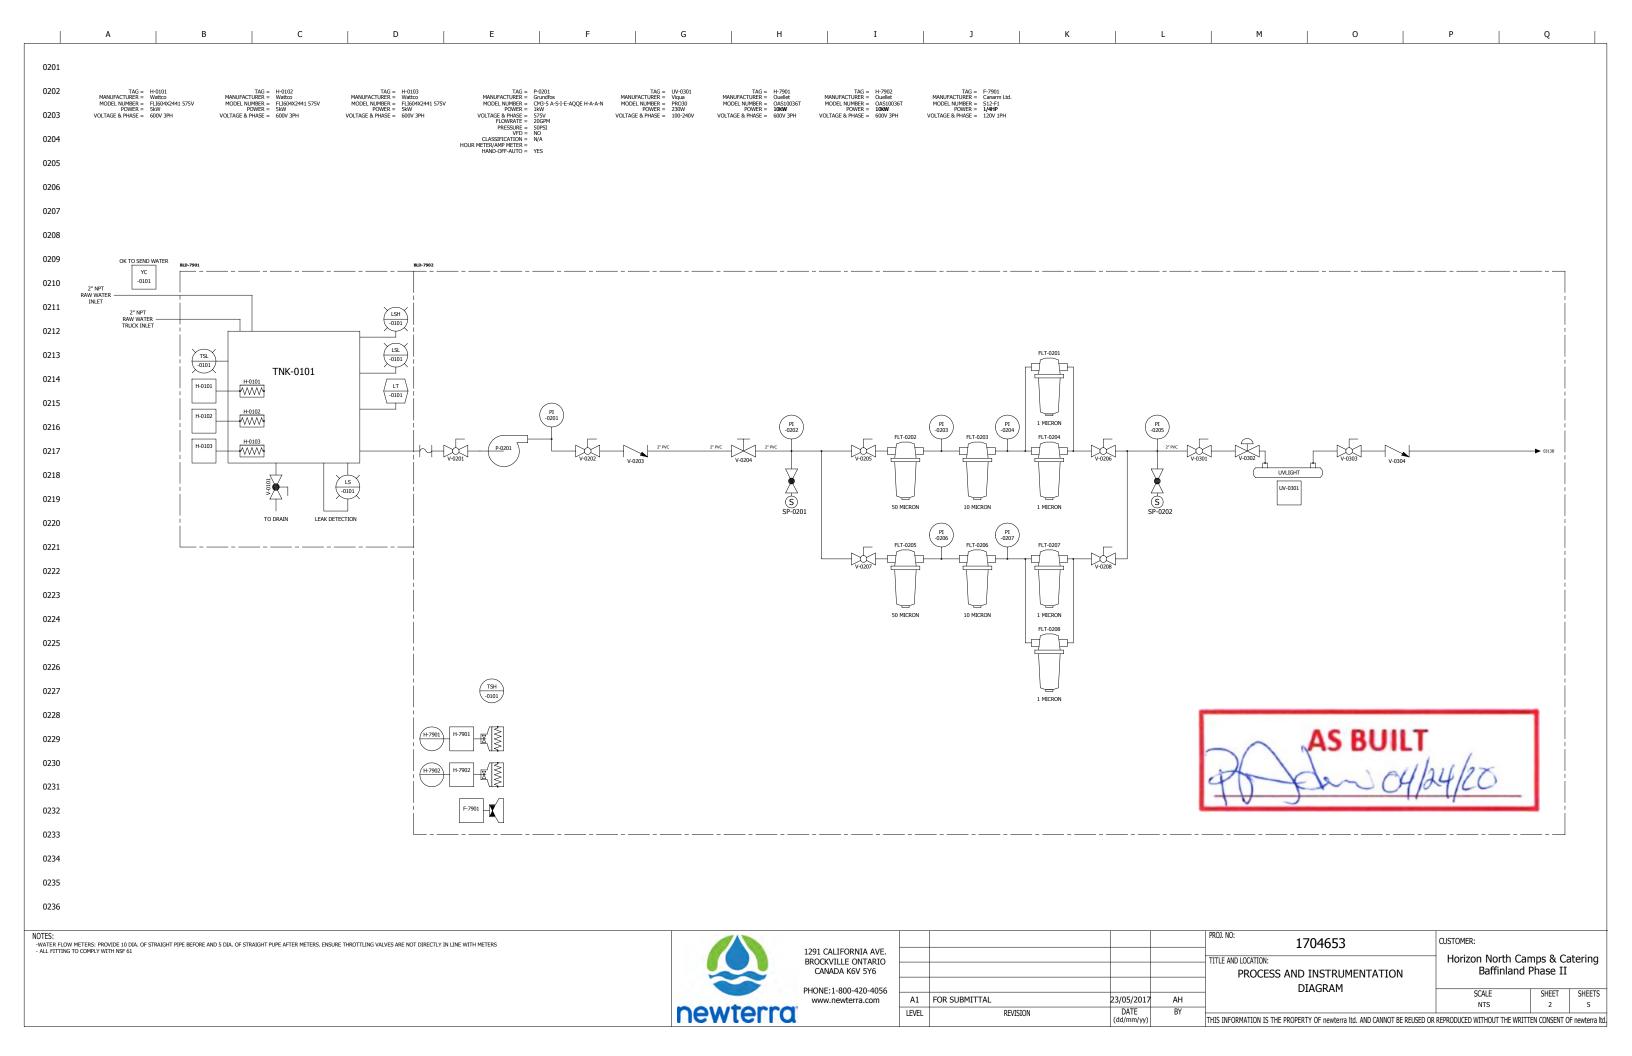


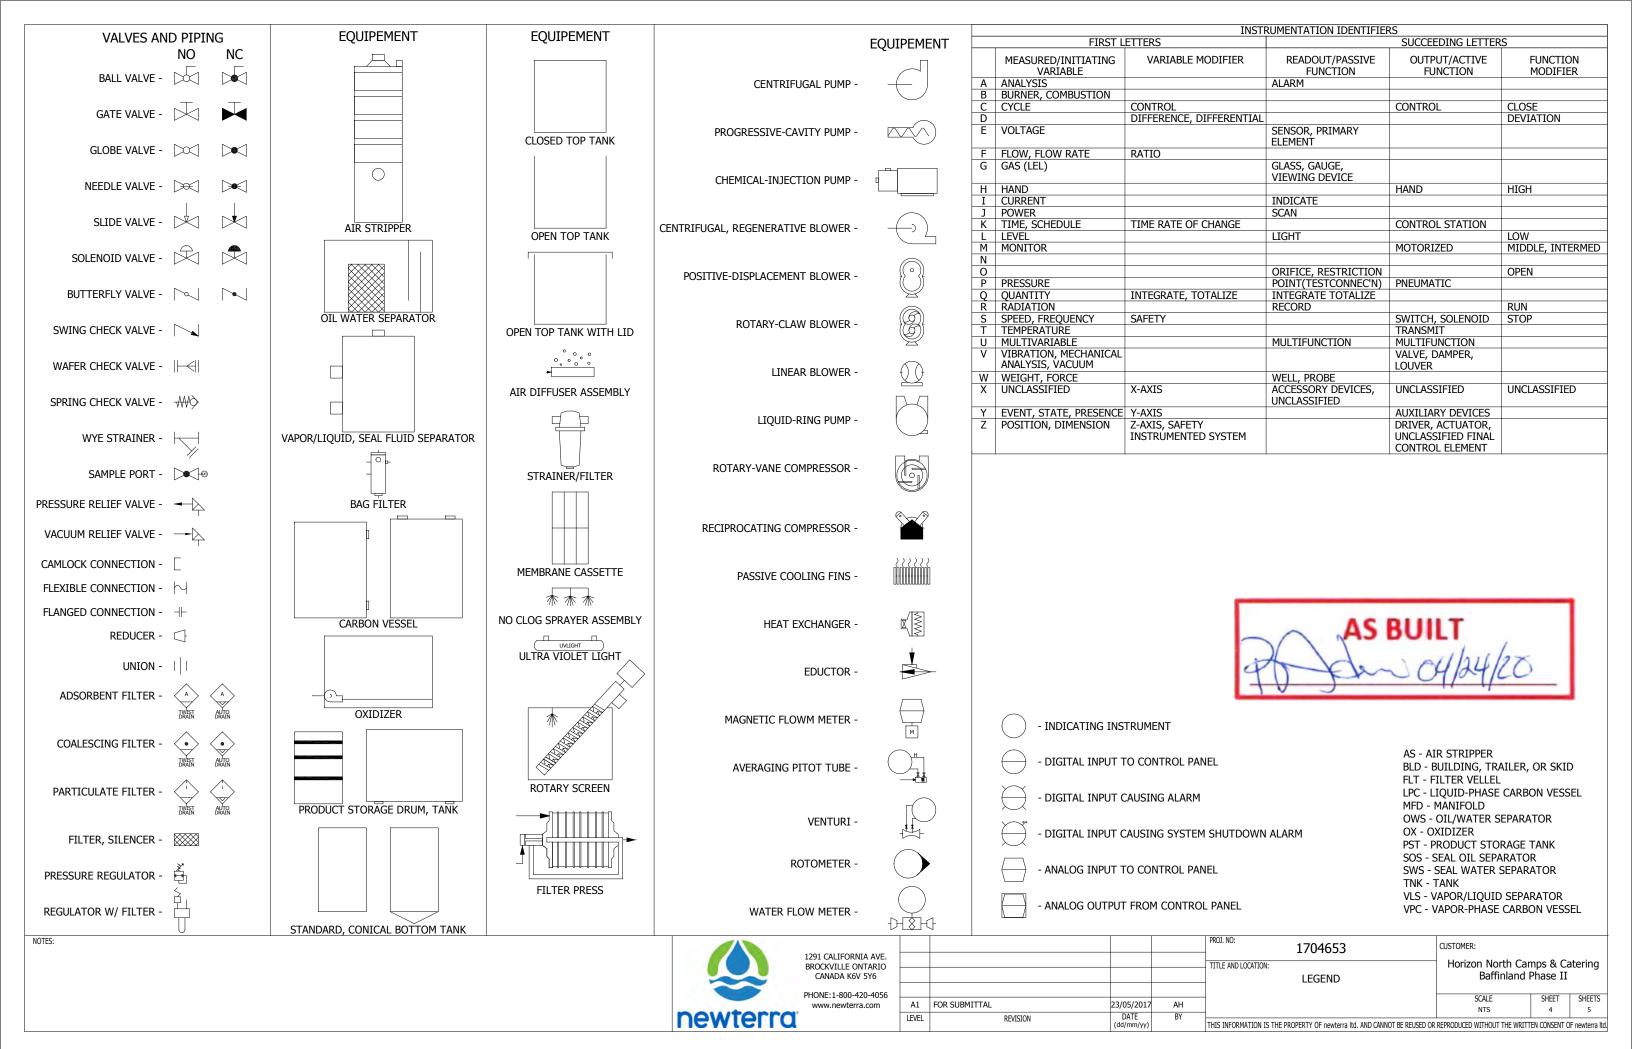

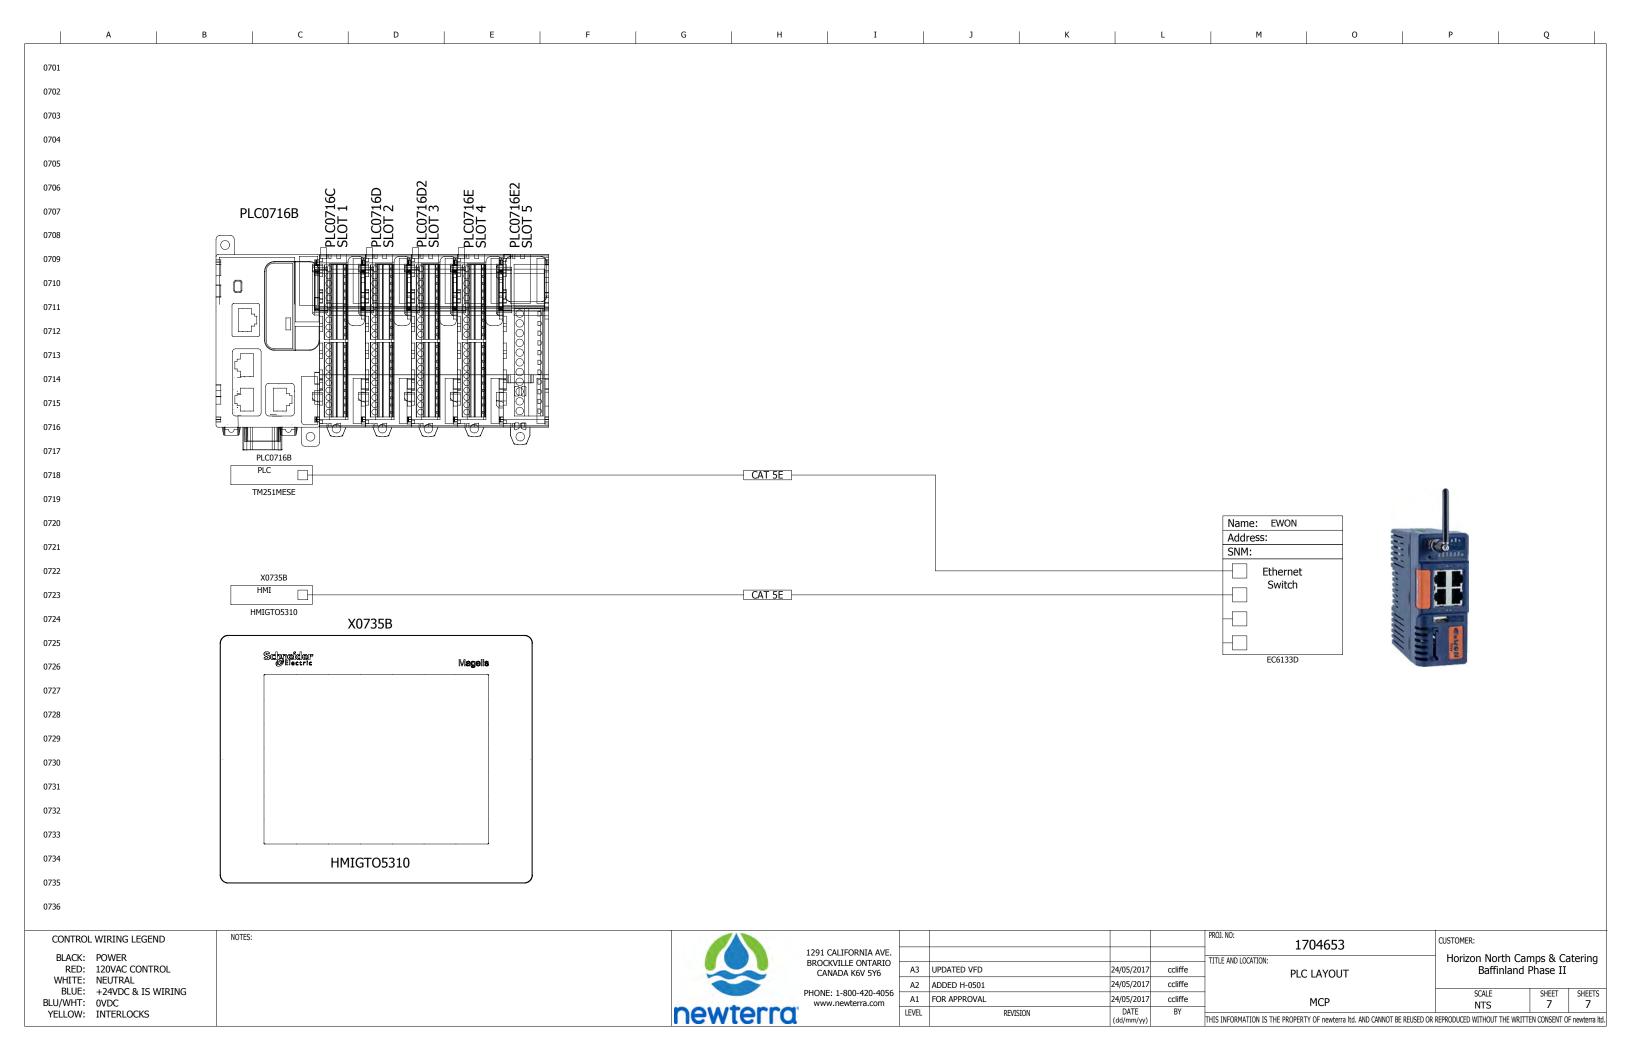


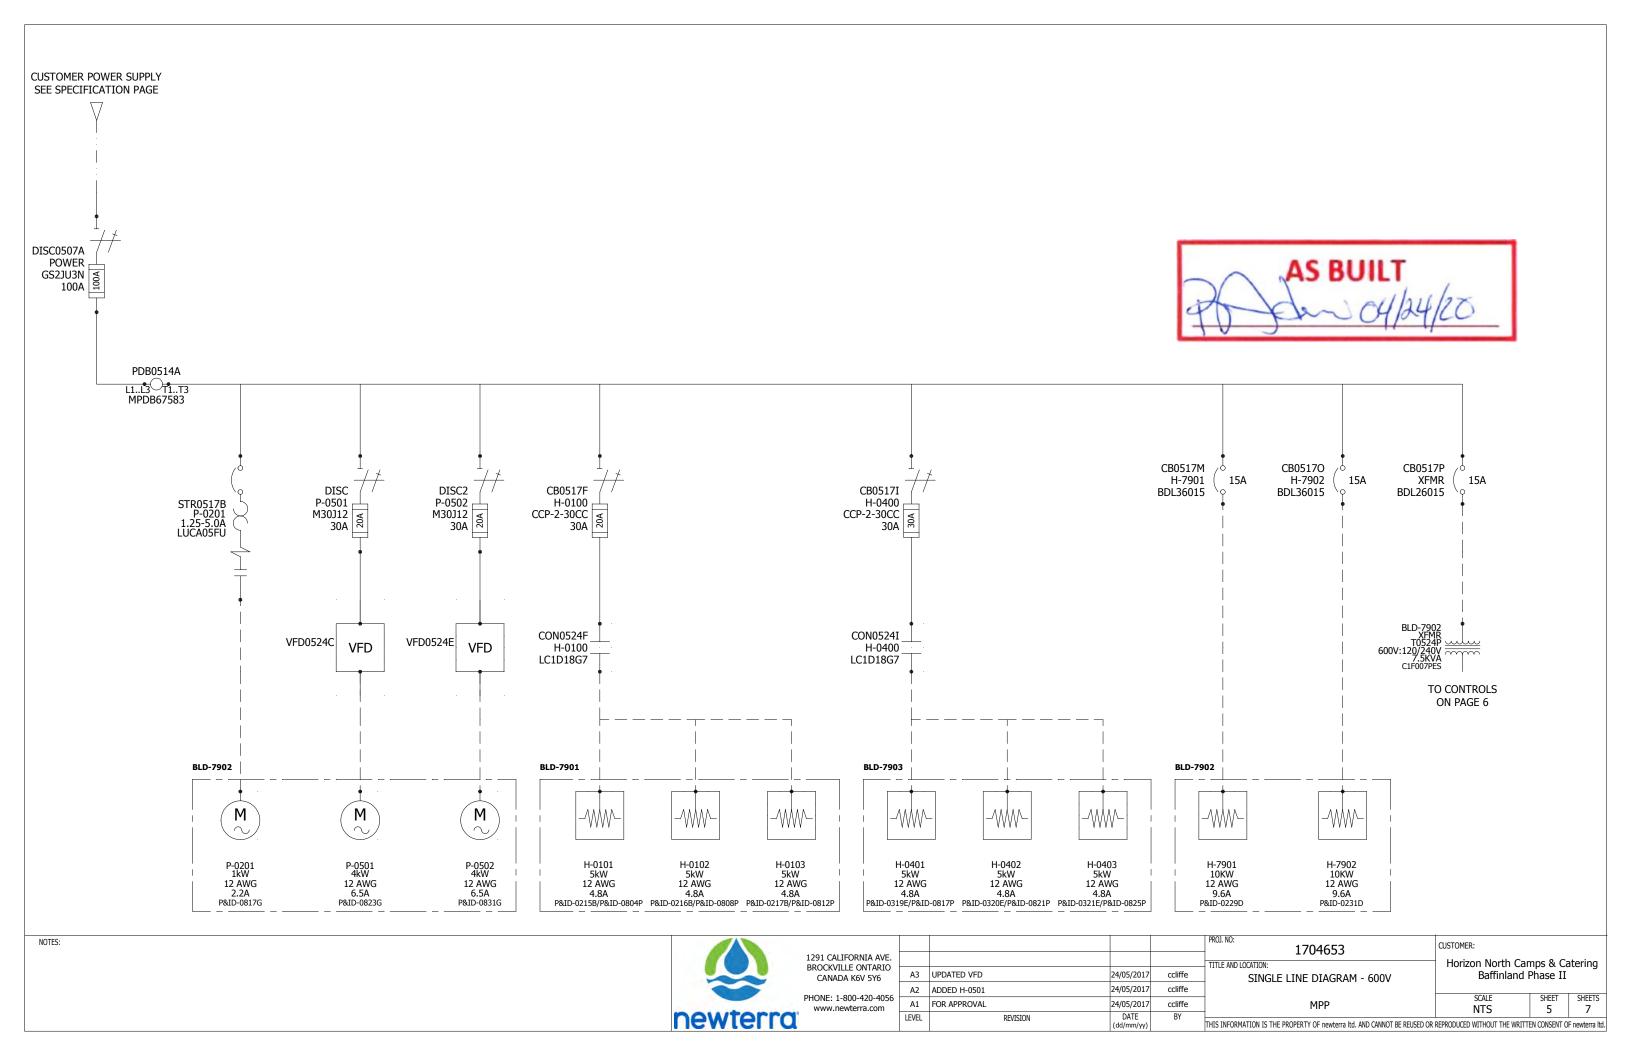

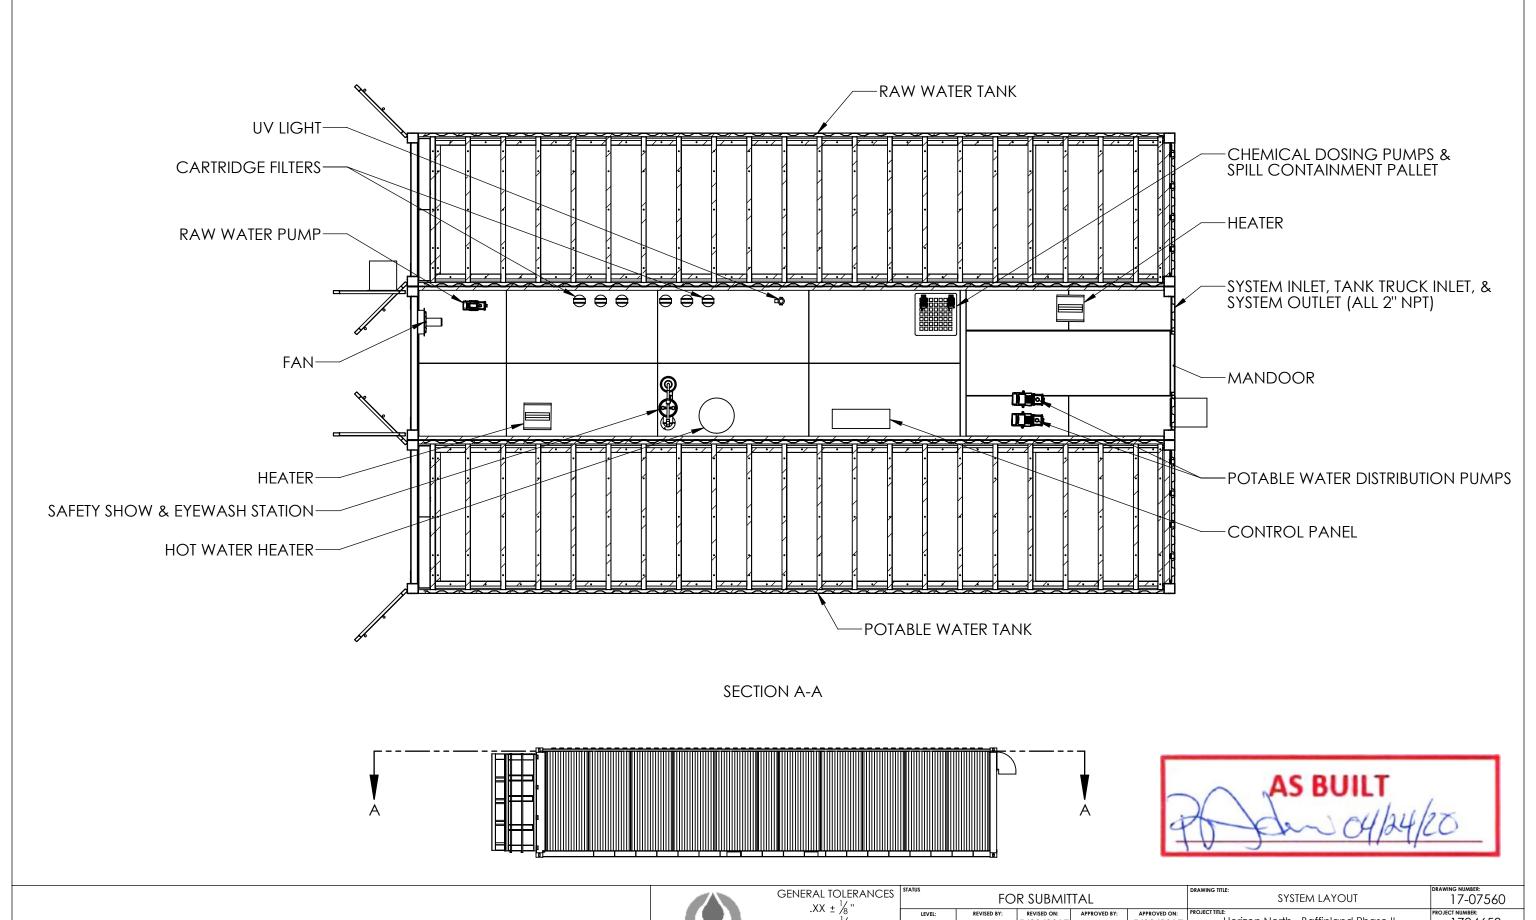

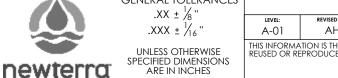

'		FO	r submii	IAL		SYSIEM LAYOUI	17-07560
	LEVEL: A-01	REVISED BY: AH	revised on: 5/23/2017	APPROVED BY: PDMA	APPROVED ON: 5/23/2017	Horizon North - Baffinland Phase II	1704653
		TION IS THE PRO			INOT BE	CUSTOMER: Horizon North	DRAWN BY:
						Honzon North	5/23/2017
							SHEET 1 OF 2

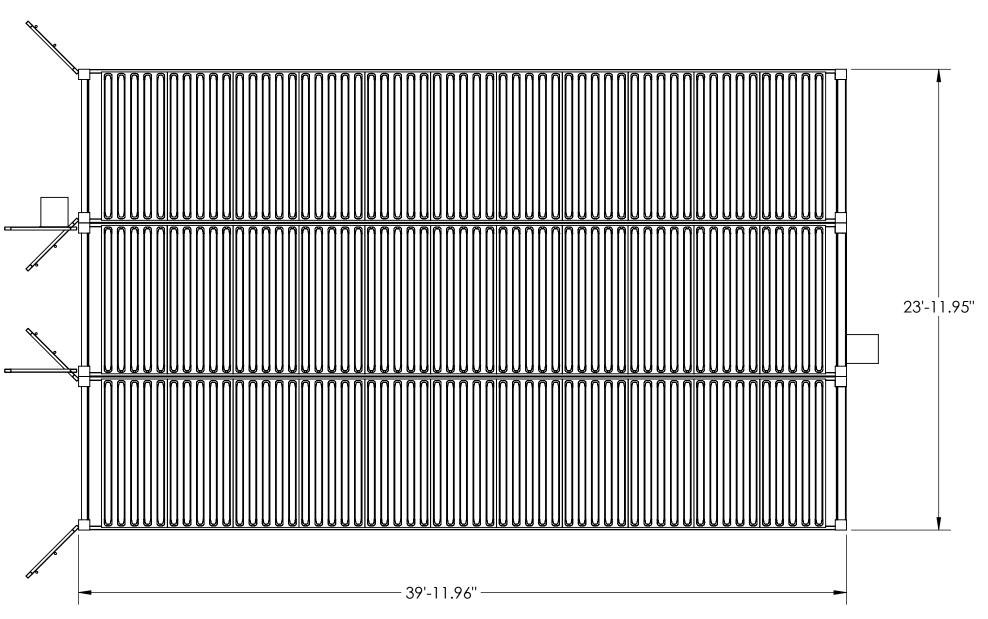







GENERAL TOLERANCES $.XX \pm \frac{1}{8}"$ $.XXX \pm \frac{1}{16}"$

UNLESS OTHERWISE SPECIFIED DIMENSIONS ARE IN INCHES

ES	STATUS	FO	r submit	TAL		DRAWING TITLE: SYSTEM LAYOUT	17-07560
	LEVEL: A-01	REVISED BY:	revised on: 5/23/2017	APPROVED BY: PDMA	APPROVED ON: 5/23/2017	PROJECT TITLE: Horizon North - Baffinland Phase II	1704653
		ATION IS THE PRO EPRODUCED WIT			NOT BE	customer: Horizon North	DRAWN BY:
						HOHZOH NOHH	DATE: 5/23/2017

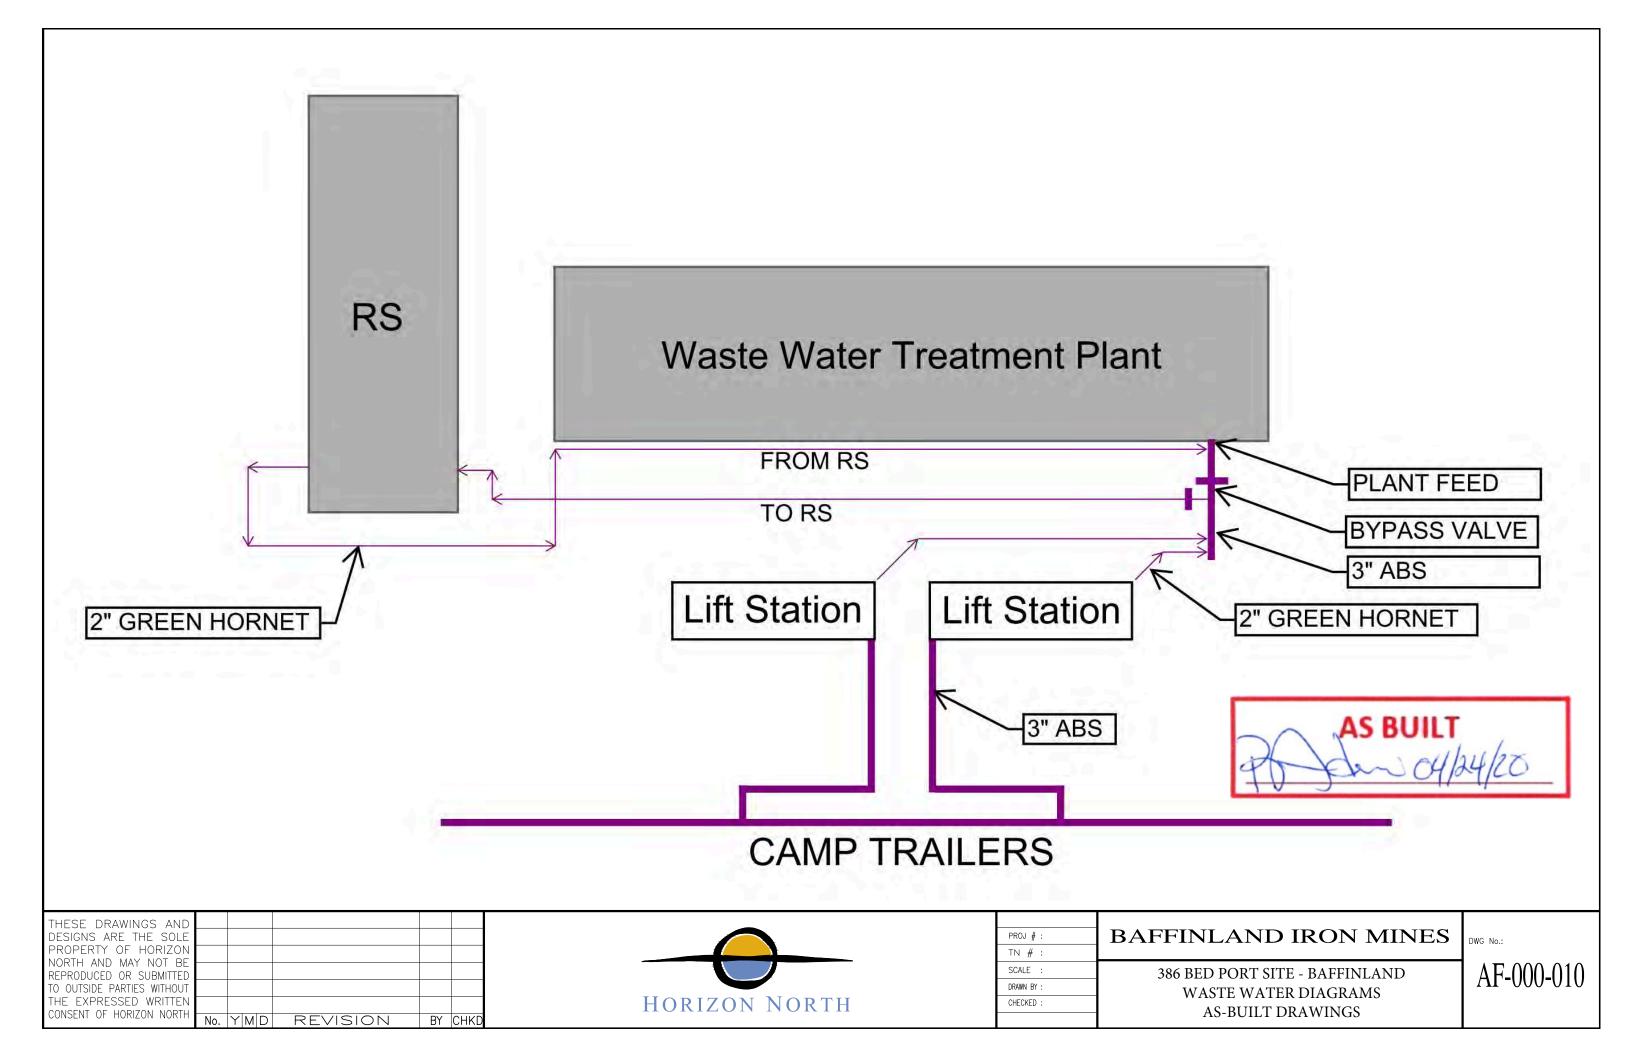

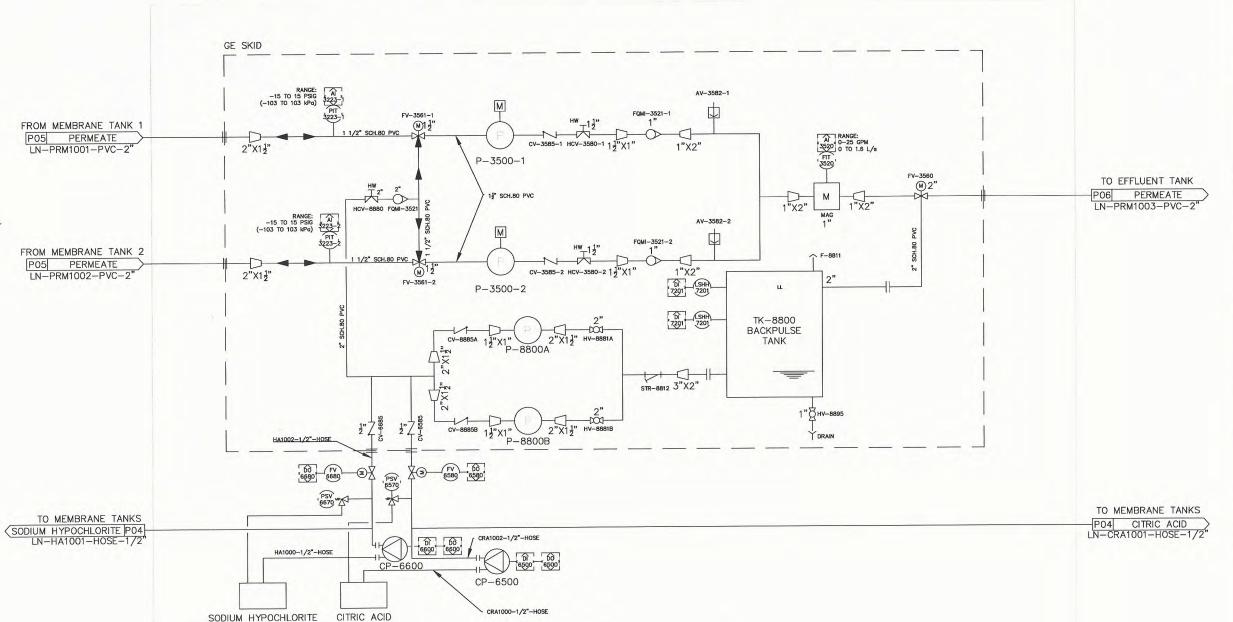

P-3500-1/2 PERMEATE PUMP #1 AND #2 AVG. FLOW: 24 USGPM @ 40 FT HEAD MAX. FLOW: 34 GPM @ 40 FT HEAD 1.9 L/s @ 15.4m TDH 0.5HP @ 3450 RPM 480V/3PH/60Hz

P-8800A/B BACKPULSE PUMP A AND B DUTY/STANDBY 56 GPM @ 25 FT TDH 0.9 L/s @ 7.6m TDH 1HP @ 3450 RPM 480V/3PH/60Hz

CP-6600 SODIUM HYPOCHLORITE METERING PUMP BLUE-WHITE FLEX-PRO A3 PERISTALIC PUMP

CP-6500 CITRIC ACID METERING PUMP BLUE-WHITE FLEX-PRO A3 PERISTALIC PUMP

TK-8800 BACKPULSE TANK LLD POLYETHEYLENE 37"ø X 40.5"H 204 USGAL



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REVISIONS DATE (YY.MM.DD) DRAWN BY APPROVED BY REV 19.02.07 J.P.M.

CLIENT:



HORIZON NORTH

PROJECT:

HORIZON NORTH CAMPS AND CATERING: BAFFIN WWTP
PIPING AND INSTRUMENTATION
DIAGRAMS

DRAWING NAME:

CHEMICAL ADDITION AND MEMBRANE BACKPULSE SKID

DRAWN BY: M.Z. SCALE: NTS

PAGE: DRAWING: NAPEG PERMIT: P 940 P07 OF P07 214.09.P07





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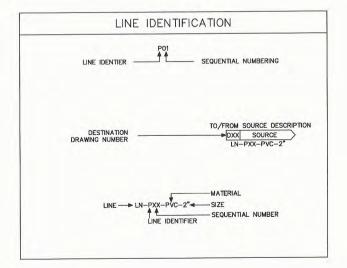
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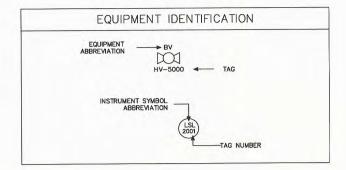
3. SCALE IS NOT VALID FOR ELECTRONICALLY TRANSMITTED AND

REPRINTED DOCUMENTS (.PDF)

5. P&ID, AND PIPE DIMENSIONS TO BE FIELD VERIFIED BY CONTRACTOR.

	LINE IDENTIFIER		
SYSTEM	DESCRIPTION		
MBF	MEMBRANE		
PRM	PERMEATE		
НА	SODIUM HYPOCHLORITE		
CRA	CITRIC ACID		
PRA	PRESSURERIZED AIR		
TRW	TREATED WATER		
SPW	SCREEN PROCESS WATER		
ML	MIXED LIQUOR		
RAS	RECYCLED ACTIVATED SLUDGE		
WAS	WASTE ACTIVATED SLUDGE		
SN	SLUDGE		
O/F	OVERFLOW		
EQ	EQUALIZATION		
LN	LINE		





VALVE SYMBOLS LEGEND						
SYMBOL	ABBREVIATION	DESCRIPTION				
D\$(1	ARV	AIR RELEASE VALVE				
	AV	AIR VALVE				
M	BV	BALL VALVE				
M	CV	CHECK VALVE				
\bowtie	DV	DIAPHRAGM VALVE				
Z	FCV/HCV	FLOW/HAND CONTROL VALVE				
\bowtie	GV	GATE VALVE				
Ne/	GLV	GLOBE VALVE				
-\ <u>\</u>	PRV/PSV	PRESSURE RELIEF VALVE PRESSURE SUSTAINING VALVE				
	FV	MOTORIZED 3-WAY CONTROL VALVE				
S	SV	SOLENOID VALVE				
Į.	TV	THROTTLE VALVE				

FLUID-MOVER SYMBOLS LEGEND					
SYMBOL	ABBREVIATION	DESCRIPTION			
-(1)-	. Р	PUMP			
	В	BLOWER			
	С	PERISTALIC PUMP			



ABBREVIATIONS FLOW FAL FC FE FIC FIT FQMI FLOW ALARM LOW FLOW CONTROLLER FLOW ELEMENT FLOW INDICATING CONTROLLER FLOW INDICATING TRANSMITTER FLOW INDICATING TOTALIZING AND METERING FLOW RECORDER FR O/F FLOW OVERFLOW LEVEL LEVEL TRANSMITTER LEVEL CONTROL LEVEL ELEMENT LEVEL INDICATING CONTROLLER LEVEL INDICATING TRANSMITTER HIGH WATER LEVEL LOW WATER LEVEL NORMAL WATER LEVEL LOSS OF ECHO LEVEL SWITCH LT LC LE LIC LT LHW LL LNW LOE LS LSH LSHH LSL LSLL LOSS OF ECHO LEVEL SWITCH LEVEL SWITCH HIGH LEVEL SWITCH HIGH HIGH LEVEL SWITCH LOW LEVEL SWITCH LOW LOW PRESSURE PI PIT PRV PSV PRESSURE INDICATOR PRESSURE INDICATOR TRANSMITTER PRESSURE RELIEF VALVE PRESSURE SUSTAINING VALVE QUALITY DISSOLVED OXYGEN INDICATOR DO DI EQUIPMENT SAMPLE / SOLENOID FILTER SCREEN SCR TK SSF UV SSF TANK DECANT FLOAT ULTRA VIOLET TREATMENT UNIT DECANT FLOW

PIPING CO	NNECTIONS LEGEND
SYMBOL	DESCRIPTION
	CAPPED END
	CONCENTRIC REDUCER
Y	DRAIN OUTLET
	ECCENTRIC REDUCER
-	FLANGED CONNECTION
4	COUPLER CONNECTION
<u>—</u> [/	CAMLOCK CONNECTION

MISC.	EQUIPMENT SYM	BOLS LEGEND
SYMBOL	ABBREVIATION	DESCRIPTION
\bigcirc	FQMI	ROTAMETER
\$	S	SAMPLE PORT
	YS	Y STRAINER
M	М	METER



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19.02.07	M.Z.	J.P.M.	IFA

CLIENT:



PROJECT:

HORIZON NORTH CAMPS AND CATERING: BAFFIN WWTP PIPING AND INSTRUMENTATION DIAGRAMS


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LEGEND

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REV	APPROVED BY	DRAWN BY	DATE (YY.MM.DD)
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CLIENT:



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PROJECT:

HORIZON NORTH CAMPS AND CATERING: BAFFIN WWTP PIPING AND INSTRUMENTATION DIAGRAMS

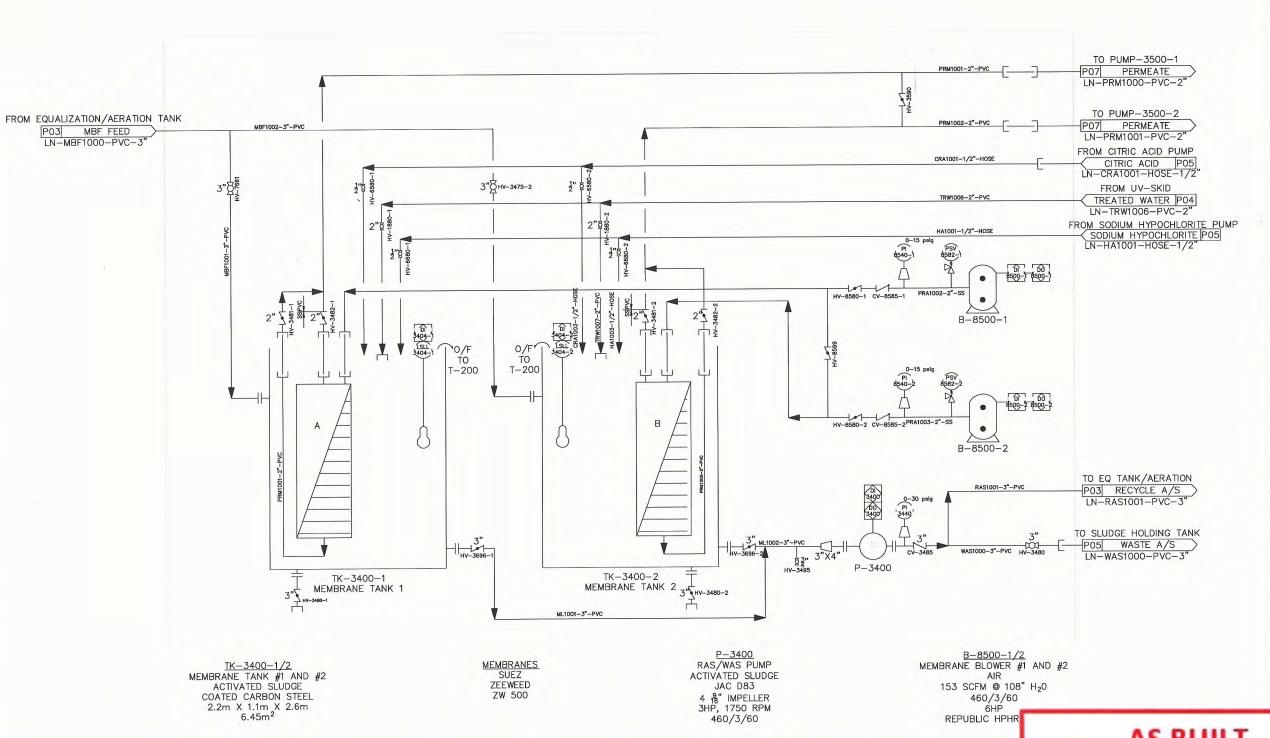DRAWING NAME:

MEMBRANE FILTRATION

DRAWN BY: M.Z. SCALE: NTS

PAGE: DRAWING: NAPEG PERMIT: P 940 P04 OF P04 214.09.P04




AS BUILT

D-200 FINE DIFFUSERS AIR EDI FLEXAIR MINI PANEL DIFFUSERS 28X10 SCFM P-3600

MEMBRANE FEED PUMP
ACTIVATED SLUDGE
JAC D83

4% IMPELLER
3HP, 1750 RPM
460/3/60

B-8700 BLOWER AIR 460/4/60 280 SCFM @ 67" H20 6HP REPUBLIC KPHRB1102

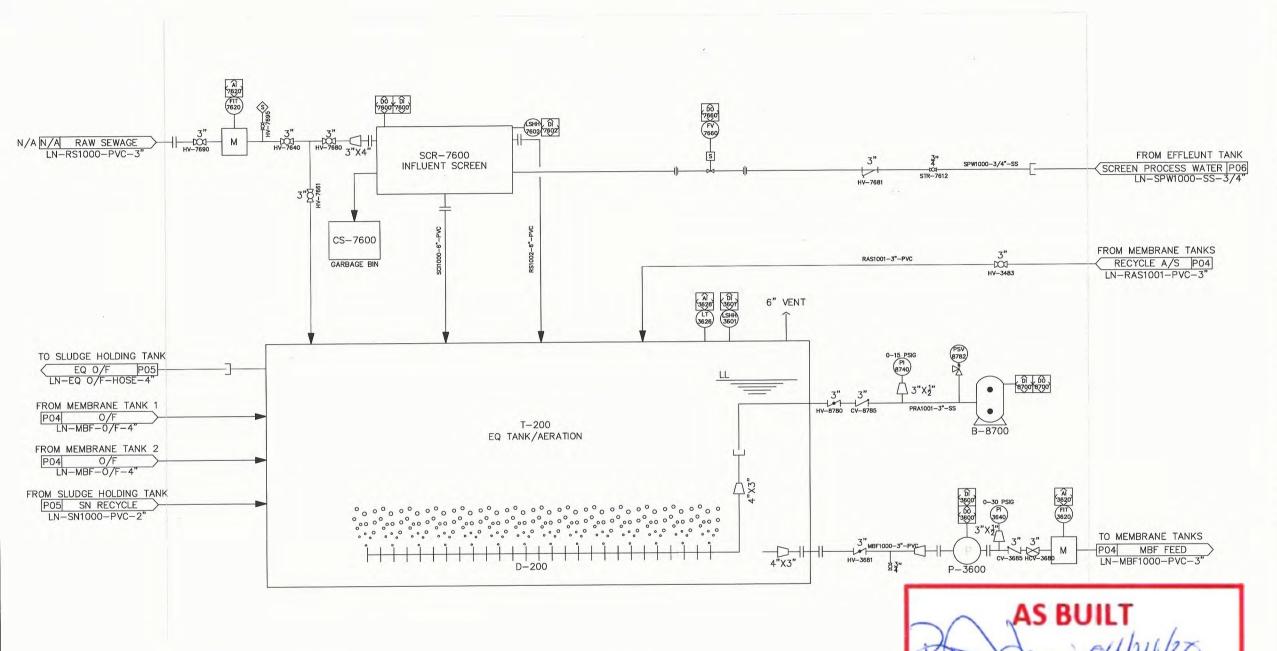

CS-7600 GARBAGE BIN T-200
AERATION/EQ TANK
ACTIVATED SLUDGE
COATED CARBON STEEL
12.0m x 2.3m x 2.7m
81 m3

SCREEN INFLUENT IPEC-RSS2512 304SS SCREEN MOTOR 0.33 HP 460/3/60



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-						

CLIENT:



HORIZON NORTH

PROJECT:

HORIZON NORTH CAMPS AND CATERING: BAFFIN WWTP PIPING AND INSTRUMENTATION DIAGRAMS


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RAW SEWAGE EQUALIZATION

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PROJECT:

HORIZON NORTH CAMPS AND CATERING: BAFFIN WWTP PIPING AND INSTRUMENTATION DIAGRAMS

DRAWING NAME:

SLUDGE HOLDING AND RECYCLE

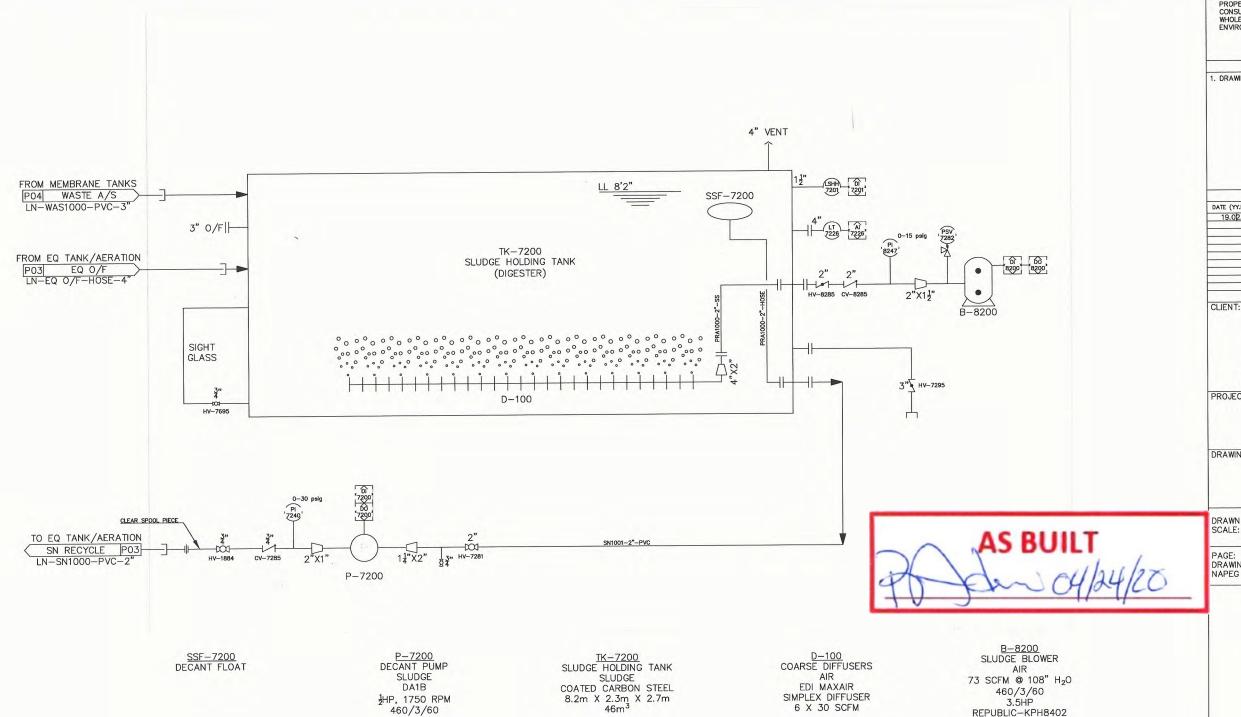
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P05 OF P05 214.09.P05



3.5HP REPUBLIC-KPH8402



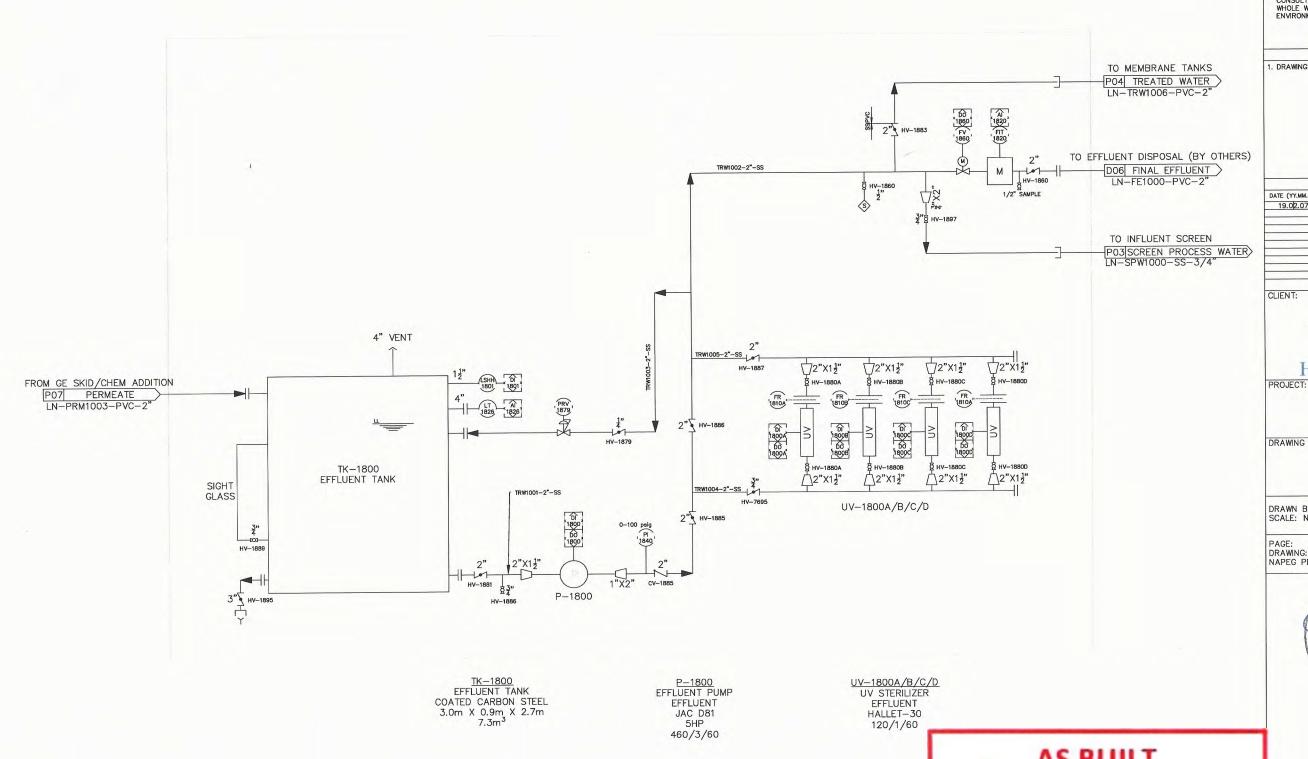

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DRAWING NAME:

UV DISINFECTION AND FINAL EFFLUENT

DRAWN BY: M.Z. SCALE: NTS

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Baffinland Iron Mines LP - Mary River Expansion Project Construction Summary Report: 386p Camp - April 30, 2020

Appendix B Earthworks Data




Project:	Mary River Expansion Stage 3 Early Earthworks Project
Description of Item/Area inspected:	Surface/Sub-grade Preparation Approval - Refer to attached ascument.
Date of inspection:	April 15th, 2017
Parties Present at Inspection	Leonel Dabor,

Comments:

A visual inspection of the Milne Port Camp Pad surface/sub-grade refer for attached was conducted prior to placement of fill Material.

Sub-grade: The snow and ice in the area was cleared as described and according to the employer satisfaction.

Permission to Pr	oceed:		September 1985 Control of the Control	The second state of the second
The area and instr	uction described above	is acceptable, the	contactor is released to p	proceed with construction.
			1 01	
<u>NEL</u>	Leonel Jak)OV	1.0/1/	2017-04-15
Representative:	Name		Signature	Date
<u>HATCH</u>	Jan FARA	254	$\mathcal{L}(\mathcal{L}(\mathcal{L}))$	2017/04/17
Representative:	Name		Signature	Date

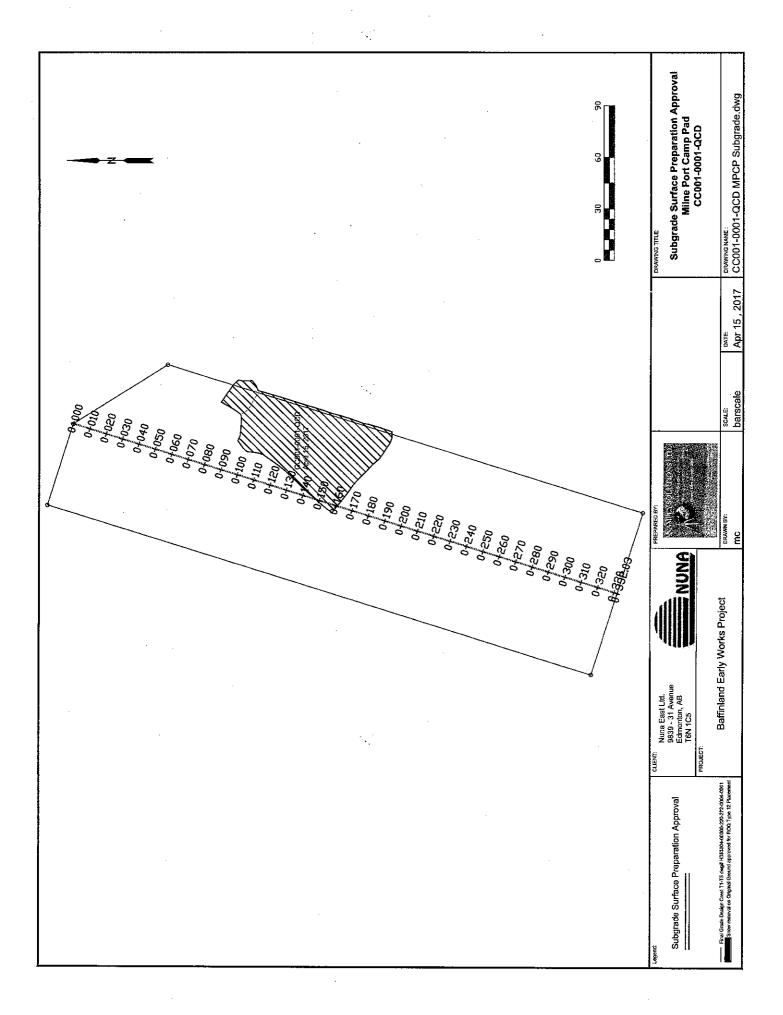




Project:	Mary River Expansion Stage 3 Early Earthworks Project
Description of Item/Area inspected:	Surface/Sub-grade Preparation Approval - refer (a) attached discurrent for Section
Date of Inspection:	April 16, 2017
Parties Present at Inspection	Leonel Jahor

Camman	
	, La . 7

A visual inspection of the Milne Port Camp Pad surface/sub-grade Yeller to attached allument was conducted prior to placement of fill Material.

Sub-grade: The snow and ice in the area was cleared as described and according to the employer satisfaction.

Permission/to/Pr	oceed:		- Luib construction
The area and instr	uction described above is acce	eptable, the contactor is released t	o proceed with construction.
	Lagral Daha	0.11	2017-04-16
<u>NEL</u> <u>Representative</u> :	Name	Signature	Date
HATCH Representative:	Name FARRELL	Signature	<u> </u>

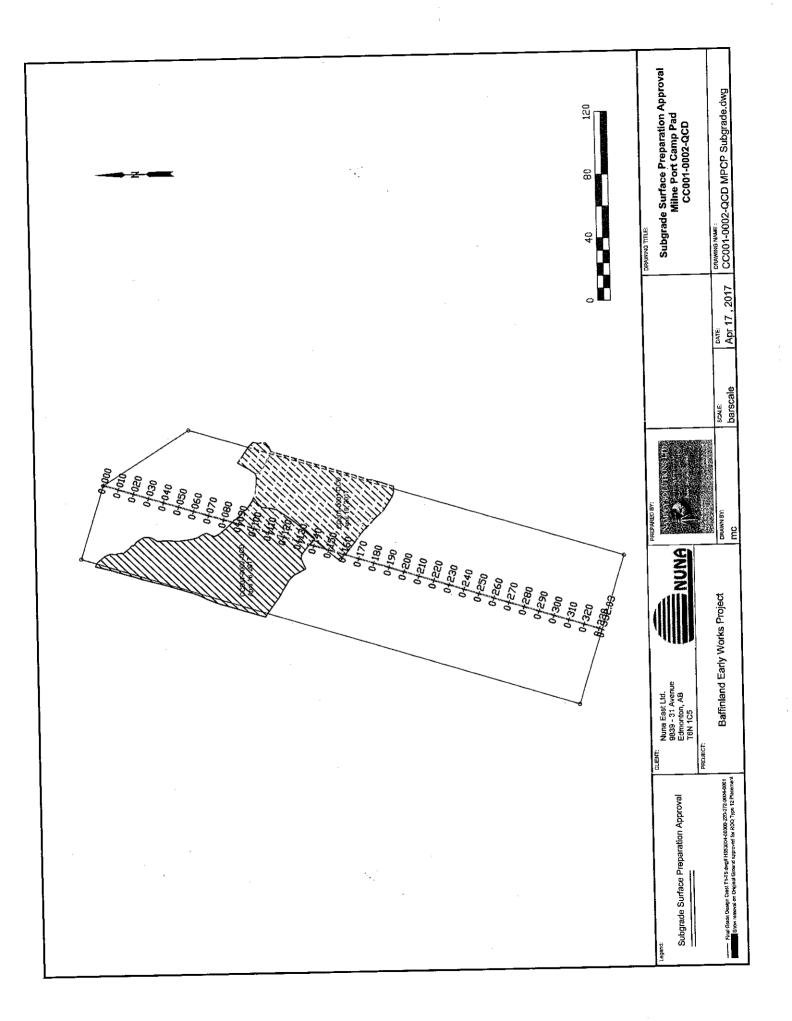




Project:	Mary River Expansion Stage 3 Early Earthworks Project	
	Surface/Sub-grade Preparation Approval - YCRer to attached document for Selfin	
Description of		
Item/Area Inspected:		
Date of inspection:	April 18th, 2017	
Parties Present at Inspection	Leonel Jabor, Paul Farrell	

Comments:
A visual inspection of the Milne Port Camp Pad surface/sub-grade Yeler to Machie dicumentwas conducted prior to placement of fill Material.
Sub-grade: The snow and ice in the area was cleared as described and according to the employer satisfaction.
The outlined area is appraved for placement of material.

Permission to Pro	SEAS TO SEE A SEE A SEE A SECURITION OF SECURITION OF SECURITION OF THE SECURITION OF		
The area and instru	iction described above is acceptable	e, the contactor is released to	proceed with construction.
	· · · · · · · · · · · · · · · · · · ·	1 00/	
NEL	Leonel Dabor		20 1 7-04-17 Date
Representative: HATCH	Name	Signature	Date
Representative:	Name Manlow Coatiley	Valenature Cuy	Date 2 0/ 9-04-77

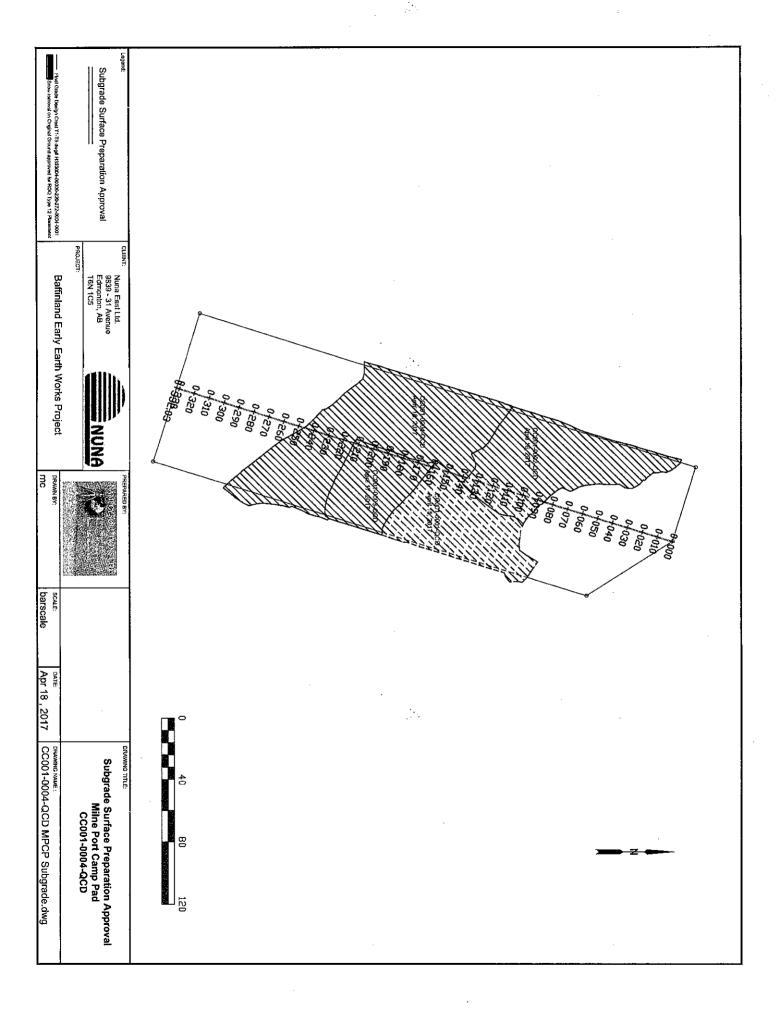




Project:	Mary River Expansion Stage 3 Early Earthworks Project
Description of Item/Area Inspected:	Surface/Sub-grade Preparation Approval - Yeler to attached document for Section
Date of Inspection:	April 17th, 2017
Parties Present at Inspection	Leonel Dabor, Paul farrell

Comments:

A visual inspection of the Milne Port Camp Pad surface/sub-grade Yeller to Whathed accument was conducted prior to placement of fill Material.

Sub-grade: The snow and ice in the area was cleared as described and according to the employer satisfaction.

Permission to Pr	oceed:	Section is a second contract of the second co	to mentage tilling som en et i skrivet som
The area and instr	uction described above is accepta	ble, the contactor is released to pr	oceed with construction.
		100	
<u>NEL</u>	Leonel Jasor	1.6//	2017-04-17
Representative:	Name	Signature	Date
<u>HATCH</u>			
Representative:	Namellanlon Cootiles	Mignature C	Date 20/7-04-2/
	· · · · · · · · · · · · · · · · · · ·		

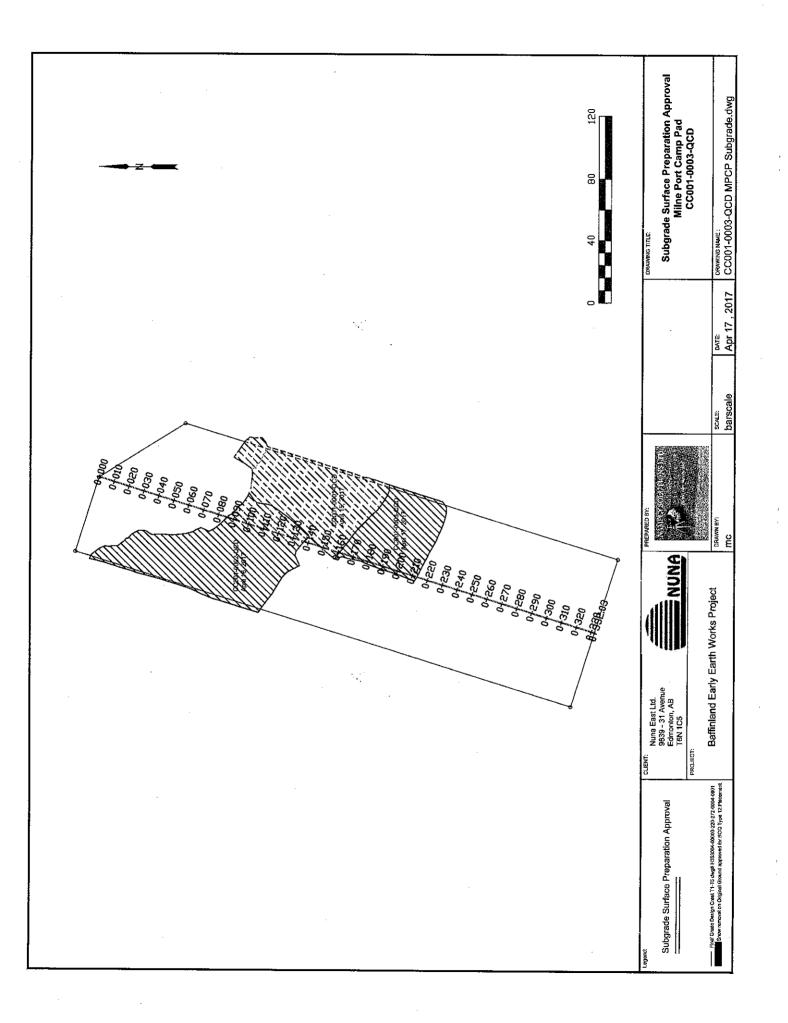




Projecti	Mary River Expansion Stage 3 Early Earthworks Project	
Description of Item/Area Inspected:	Surface/Sub-grade Preparation Approval - felt (COOI-0005-OCD MPCP Subgrade dwg	
Date of Inspection:	APRIL 24,2017	
Parties Present at Inspection	JEFF DEPAPE, NUNA MARION COAKLEY, HATCH	

Comments:
A visual inspection of the Milne Port Comp Pad surface/sub-grode <u>for obtachment</u> was conducted prior to placement of fill Material.
Sub-grade: The snow and ice in the area was cleared os described and according to the employer satisfaction.
The outlined area is approved for plocement of material.

The area and instruction described above is acceptable, the contactor is released to proceed with co NEL Representative: Name Name Name Name Name	
NEL Name Date	istruction.
NEL Name Date	
Mamb Fugilataic A	-24
Representative.	1
HATCH Marlow Cookey Wary Up 2017-64	- LE
Representative: Name Signature Date	

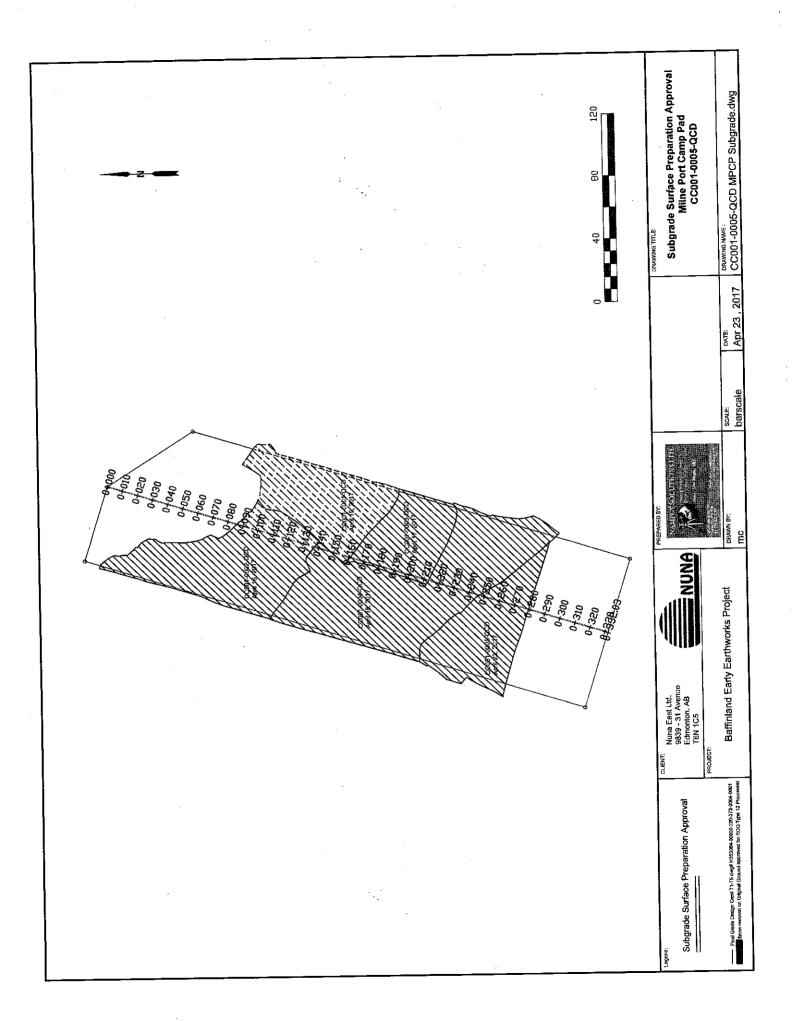






Project:	Mary River Expansion Stage 3 Early Earthworks Project
Description of Item/Area Inspected:	Milne Port Camp Pad per attached drawing CC001-0006-QCD MPCP Subgrade.pdf
Date of Inspection:	April 28, 2017
Parties Present at Inspection	Hatch - Marlon Coakley Nuna — Jeff DePape

Comments:

A visual inspection of the Milne Port Camp Pad surface/sub-grade per the attached drawing was conducted prior to placement of fill Material.

Sub-grade: The snow and ice in the area was cleared as described and according to the Project specifications..

Permission to P	roceed:			
The area and instru	ction described abo	ve is acceptáble, the c	ontactor is released to proc	eed with construction.
<u>NEL</u>	Jeff DePape			April 28, 2017
Representative:	Name		Signature	Date
<u>HATCH</u>	Marlon Coakley	Mala les	w) '	April 28, 2017
Representative:	Name		Signature	Date
	•		\ 	·

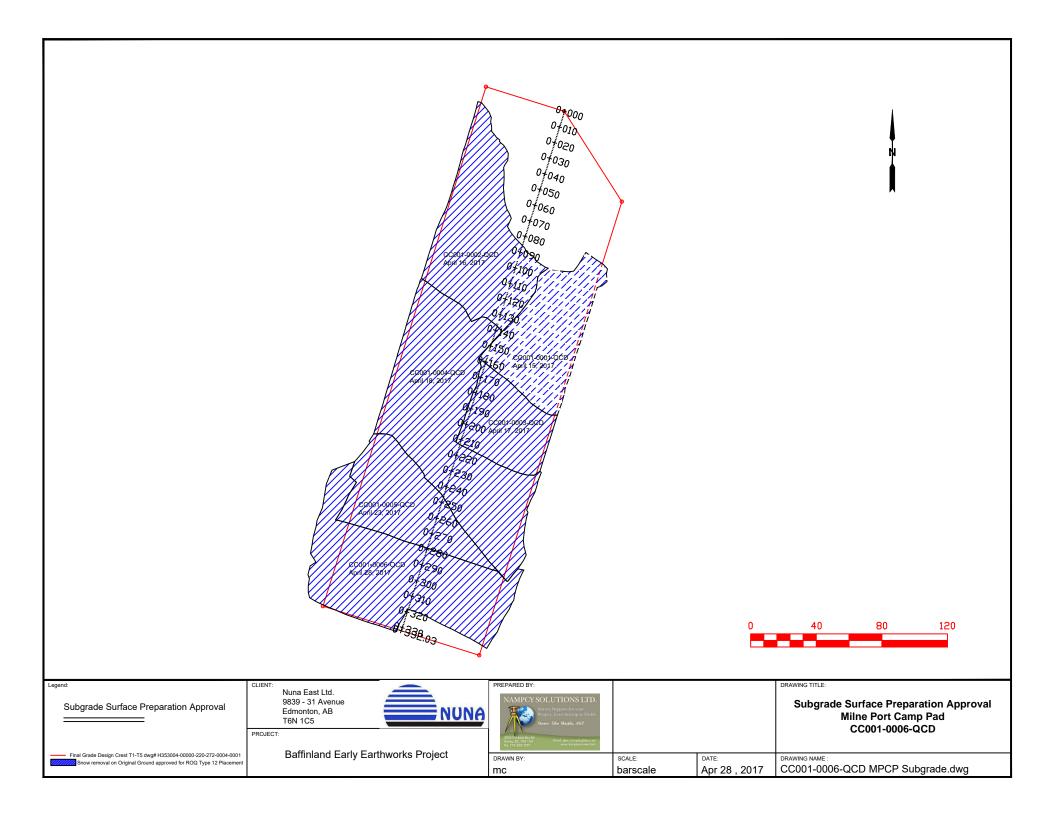




Project:	Mary River Expansion Stage 3 Early Earthworks Project
Description of Item/Area Inspected:	Milne Port Camp Pad per attached drawing CC001-0008-QCD MPCP Subgrade.pdf
Date of Inspection:	May 07, 2017
Parties Present at Inspection	Hatch – Paul Farrell Nuna – Leonel Dabor

Comments:

A visual inspection of the Milne Port Camp Pad surface/sub-grade per the attached drawing was conducted prior to placement of fill Material.

Sub-grade: The snow and ice in the area was cleared as described and according to the Project specifications..

he area and instru	action described above is a	acceptable, the contactor is released to proceed	with construction.
<u>NEL</u>	Leonel Dabor	J-0-1/11/	May 07, 2017
<u>Representative</u> :	Name	Signature	Date
HATCH	Paul Farrell		May 07, 2017
Representative:	Name	Signature	Date

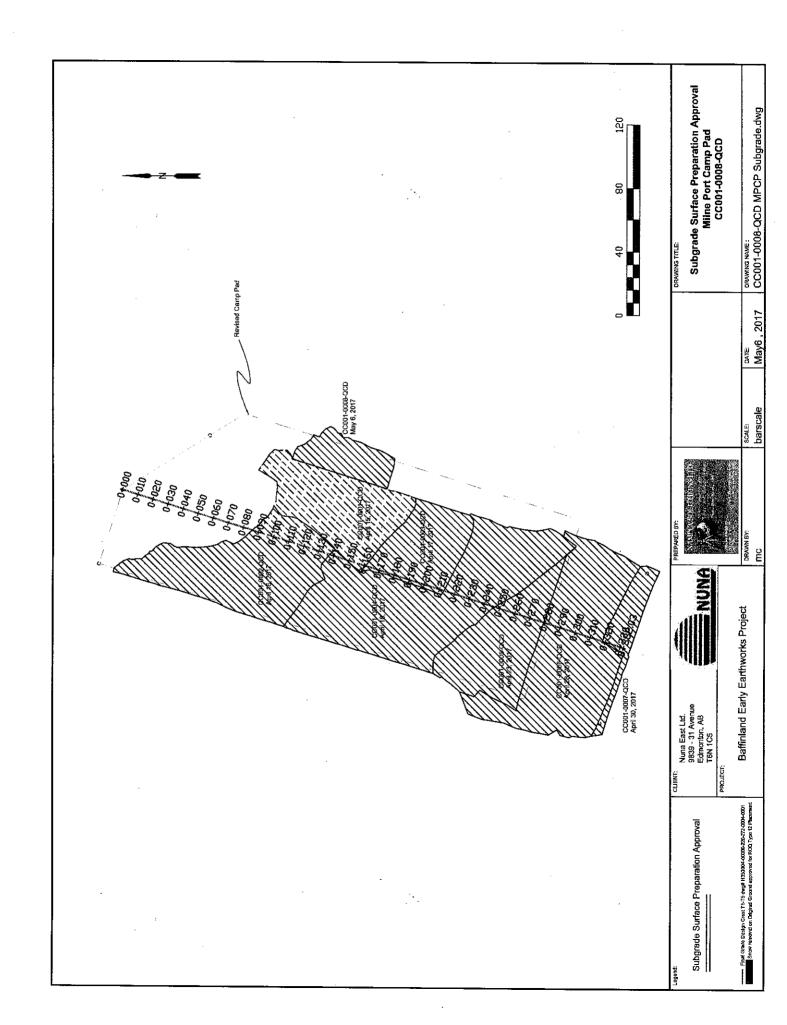






Project:	Mary River Expansion Stage 3 Early Earthworks Project
Description of Item/Area Inspected:	Milne Port Camp Pad per attached drawing CC001-0009-QCD MPCP Subgrade.pdf
Date of Inspection:	May 08, 2017
Parties Present at Inspection	Hatch – Paul Farrell Nuna – Leonel Dabor

Comments

A visual inspection of the Milne Port Camp Pad surface/sub-grade per the attached drawing was conducted prior to placement of fill Material.

Sub-grade: The snow and ice in the area was cleared as described and according to the Project specifications...

ne area and instru	ction described above is acc	eptable, the contactor is released to proceed w	ith construction.
<u>NEL</u>	Leonel Dabor	J. 6.////	May 08, 2017
epresentative:	Name	Signature	Date
ATCH	Paul Farrell		May 08, 2017
lepresentative:	Name	Signature	Date

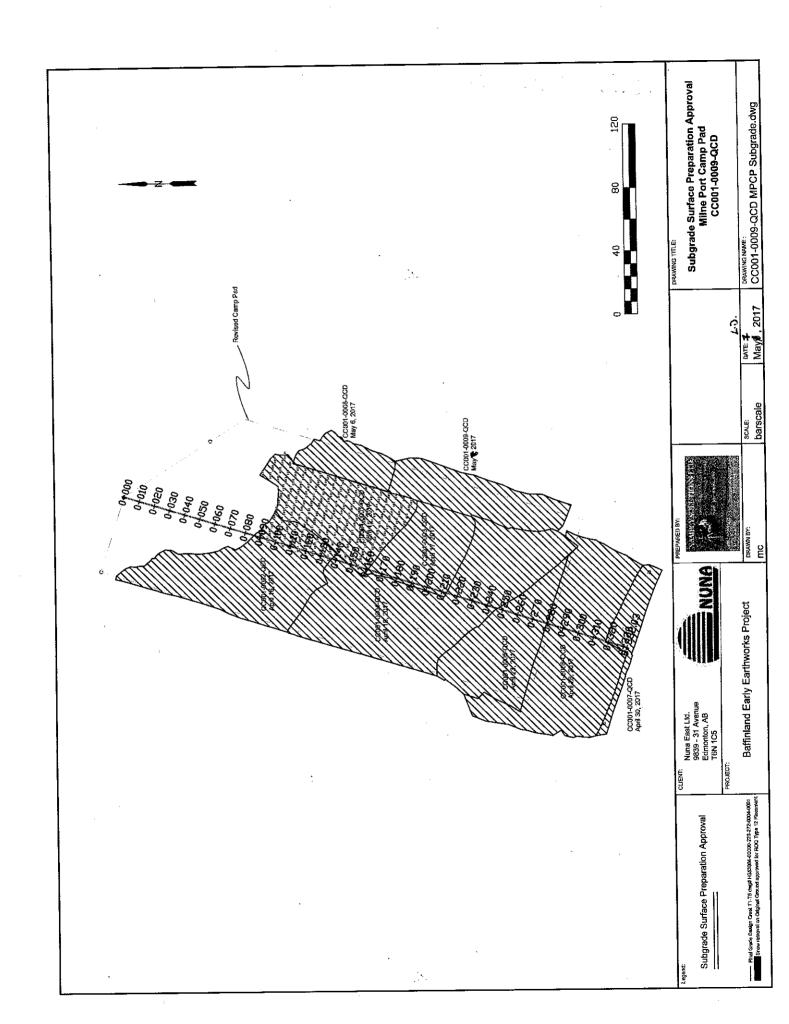






Project:	Mary River Expansion Stage 3 Early Earthworks Project
Description of Item/Area Inspected:	Milne Port Camp Pad per attached drawing CC001-0010-QCD MPCP Subgrade.pdf
Date of Inspection:	May 13, 2017
Parties Present at Inspection	Hatch — Paul Farrell Nuna — Leonel Dabor

Comments:

A visual inspection of the Milne Port Camp Pad surface/sub-grade per the attached drawing was conducted prior to placement of fill Material.

Sub-grade: The snow and ice in the area was cleared as described and according to the Project specifications.

Permission to P	roceed:		and the second second
The area and instru	action described above is	acceptable, the contactor is released to proceed	with construction.
NEL Representative:	Leonel Dabor	10/10	May 13, 2017
HATCH	Name Paul Farreli	Signature	Date
Representative:	Name	Signature	May 13, 2017 Date

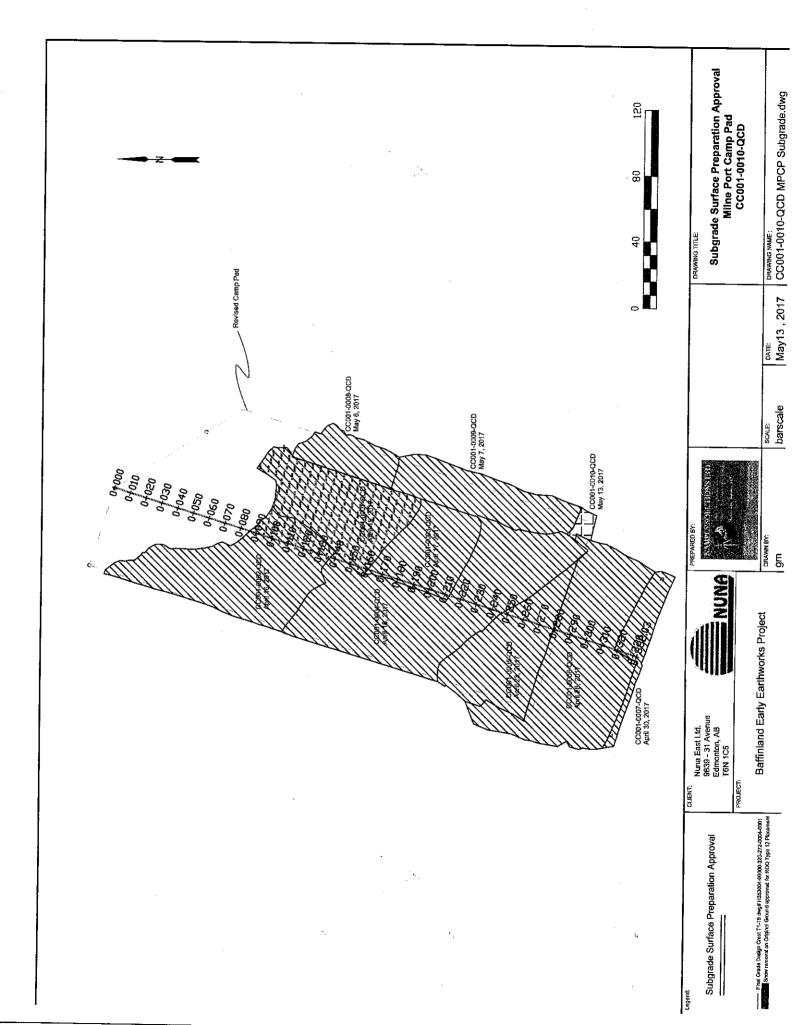



Project:	Mary River Expansion Stage 3 Early Earthworks
Description of Item/Area Inspected:	Construction Material Approval per attached correspondence
Date of Inspection:	May 15 th , 2017
Parties Present at Inspection	Hatch – Paul Farrell

Comments:

A visual inspection of the stackpile of 25-50mm blend of crush Material was conducted to confirm Material conforms to the surfacing material specifications.

Canstruction Material: The 25-50mm blend of crushed material conforms to specifications and is approved for placement on the Milne Port Camp pad.

Leonel Dabor

From:

Farrell, Paul <paul.farrell@hatch.com>

Sent:

Tuesday, May 16, 2017 6:00 AM

To:

Doug Haverland

Cc:

Coakley, Marion; Leonel Dabor; Jeff DePape

Subject:

1" to 2" blend for top lift at accommodation pad

Doug,

Utilize the available 25mm-50mm blend material offered by road maintenance for final grade at the accommodations pad.

Regards,

Paul Farrell

Project Delivery Group Mary River Project Site Office 416-364-8820 Ext 4126 Mobile: (204) 430-8903 2800 Speakman Drive, Mississauga Ontario Canada L5K 2R7 Email:paul.farrell@hatch.com

Thank you for your continued support.

HATCH

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NUNA East Limited Quality Department Quality Surveillance Inspection Acceptance and Sign-off Report

Project:	Mary River Expansion Stage 3 Early Earthworks Project
Description of Item/Area Inspected:	Milne Port Camp Pad per attached drawing CC001-0011-QCD MPCP ROQ Approval.pdf
Date of Inspection:	May 16, 2017
Parties Present at Inspection	Hatch — Paul Farrell Nuna — Leonel Dabor


Comments:

A visual inspection of the Milne Port Camp Pad ROQ placement per attached drawing was canducted prior to placement of Surfacing Materia (Surface Course).

ROQ Placement: The grade, elevation and compaction were found to be acceptable.

The outlined area is approved for placement of Type 5 (32mm) Surfacing Material or as approved.

Permission to Pr	Set Seguestic Section Control of the	ove is acceptable, the contactor is relea	esed to proceed with construction
THE GIEW GIRG HISTI	action described abo	A A	ased to proceed with construction.
<u>NEL</u>	Leonel Dabor	p. 2/7/	May 16, 2017
Representative:	Name	Signature	Date
<u>HATCH</u> <u>Representative</u> :	Paul Farrell Name	Signature	May 16, 2017 Date

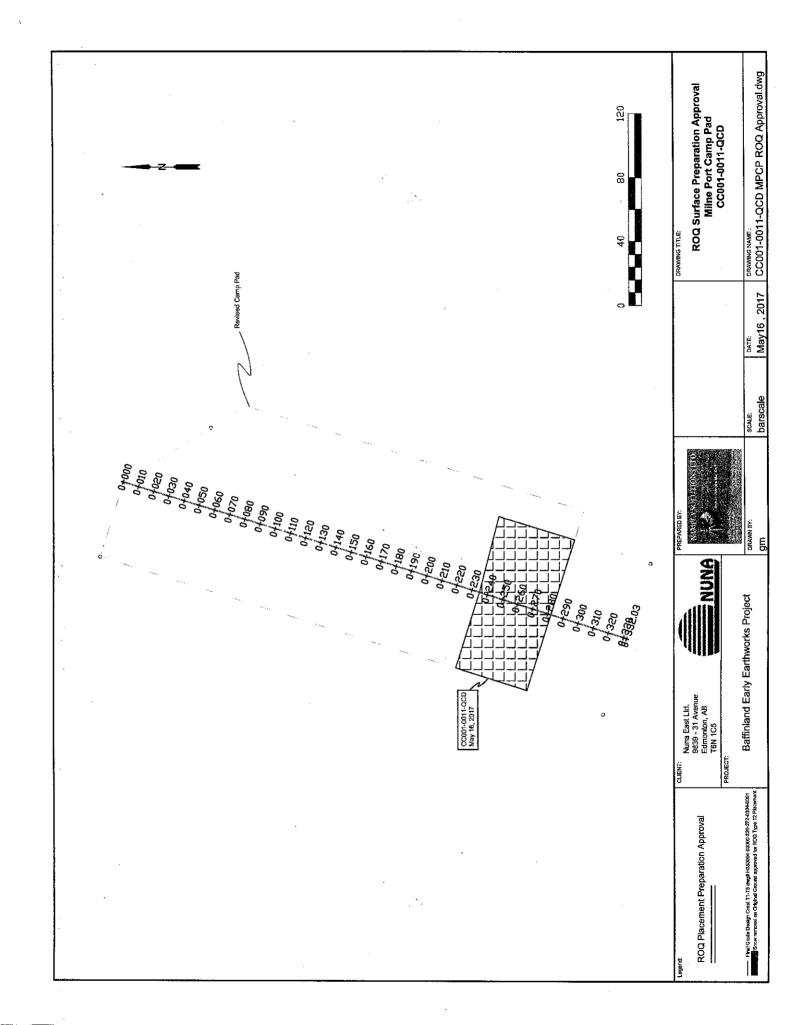



NUNA East Limited Quality Department Quality Surveillance Inspection Acceptance and Sign-off Report

Project:	Mary River Expansion Stage 3 Early Earthworks Project
Description of Item/Area Inspected:	Milne Port Camp Pad per attached drawing CC001-0012-QCD MPCP ROQ Approval.pdf
Date of Inspection:	May 17, 2017
Parties Present at Inspection	Hatch – Paul Farrell Nuna – Leonel Dabor


Comments:

A visual inspection of the Milne Port Camp Pad ROQ placement per attached drawing was conducted prior to placement of Surfacing Moteria (Surface Course).

ROQ Placement: The grade, elevation and compaction were found to be acceptable.

The outlined area is approved for placement of Type 5 (32mm) Surfacing Material or as approved.

Permission to Pr	oceed:				
The area and instr	uction described abov	e is acceptable,	the contactor is released	I to proceed with construction.	
;		187			
ALT!	Leonel Dabor		1971	May 17, 2017	
<u>NEL</u> <u>Representative</u> :	Name	0	Signature	Date	
<u>HATCH</u>	Paul Farrell		<u> </u>	May 17, 2017	
Representative:	Name	7	Signature	Date	

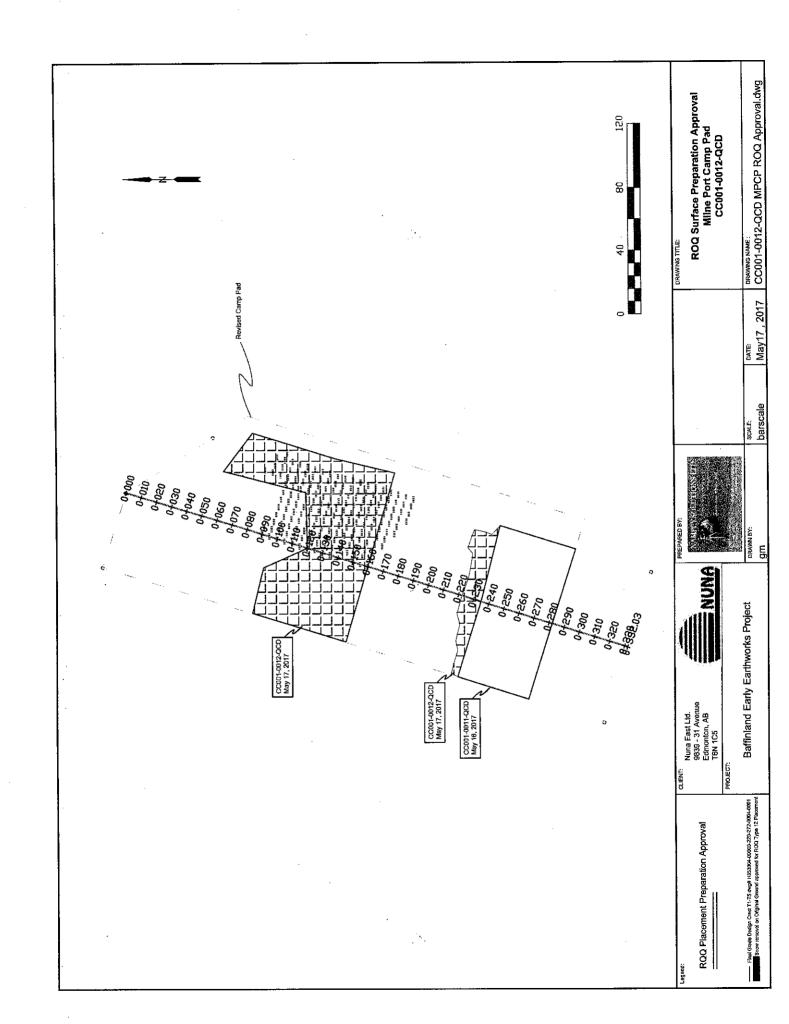





Nuna East Limited Quality Department Quality Surveillance Inspection Acceptance and Sign-off Report

Project:	Mary River Expansion Stage 3 Early Earthworks Project
Description of Item/Area Inspected:	Milne Port Camp Pad per attached drawing CC001-0013-QCD MPCP ROQ APPROVAL.pdf
Date of Inspection:	May 22, 2017
Parties Present at Inspection	Hatch - Marlon Coakley Nuna – Jeff DePape

Comments:

A visual inspection of the Milne Port Camp Pad ROQ subgrade placement per the attached drawing was conducted prior to placement of cap (surfacing) material.

ROQ Placement: The grade, elevation and compaction were found to be acceptable.

The outlined area is approved for placement of cap (surfacing) material.

Permission to Proceed:


The area and instruction described above is acceptable, the contactor is released to proceed with construction.


NEL Jeff DePape / W May 22, 2017


Representative: Name Signature Date


<u>HATCH</u> Marlon Coakley May 22, 2017

Representative: Name Signature Date

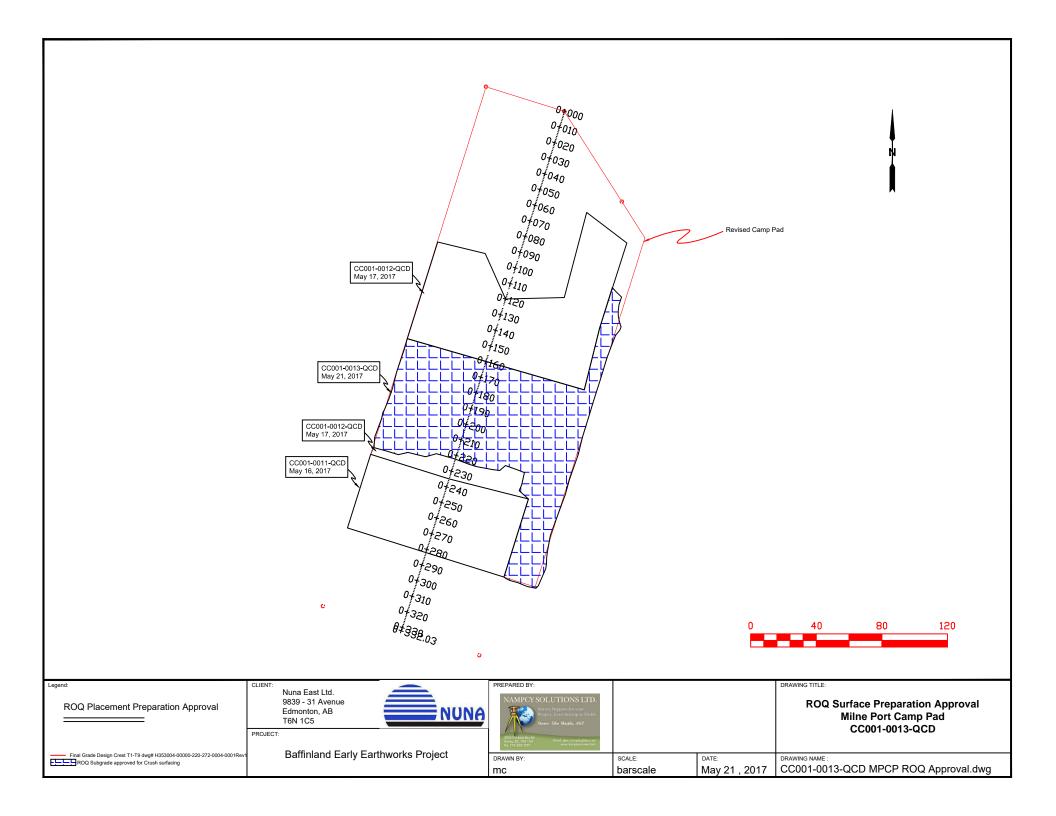

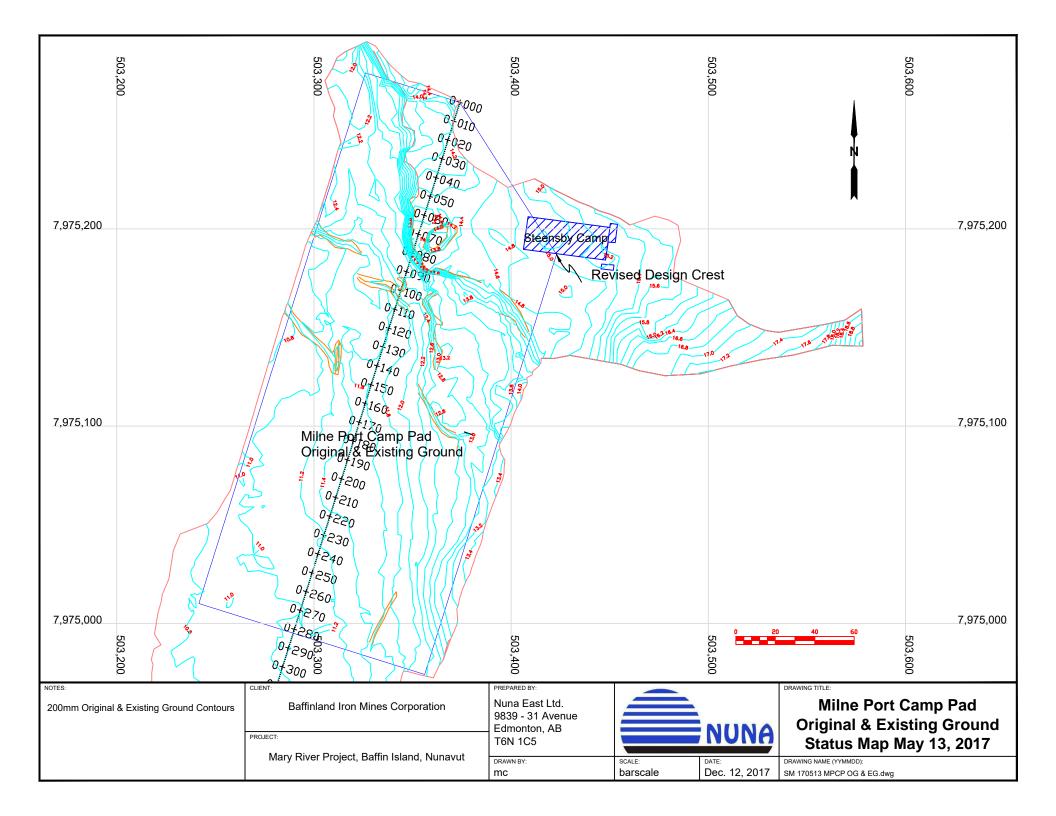

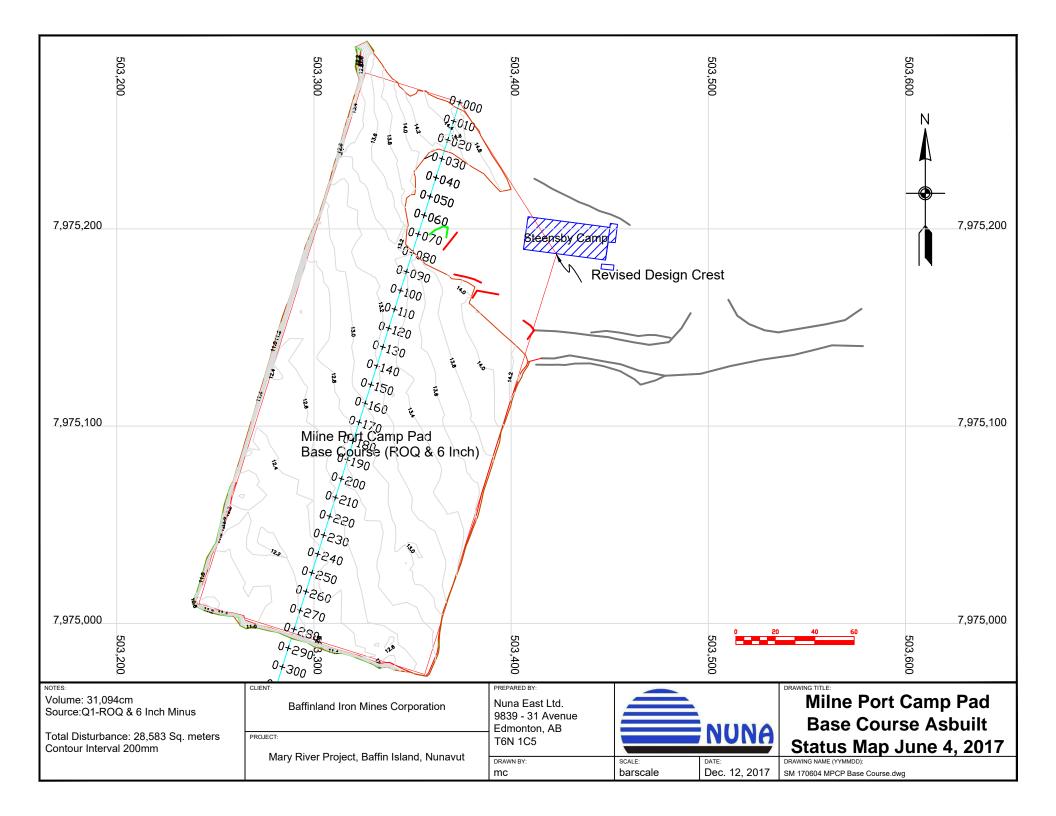

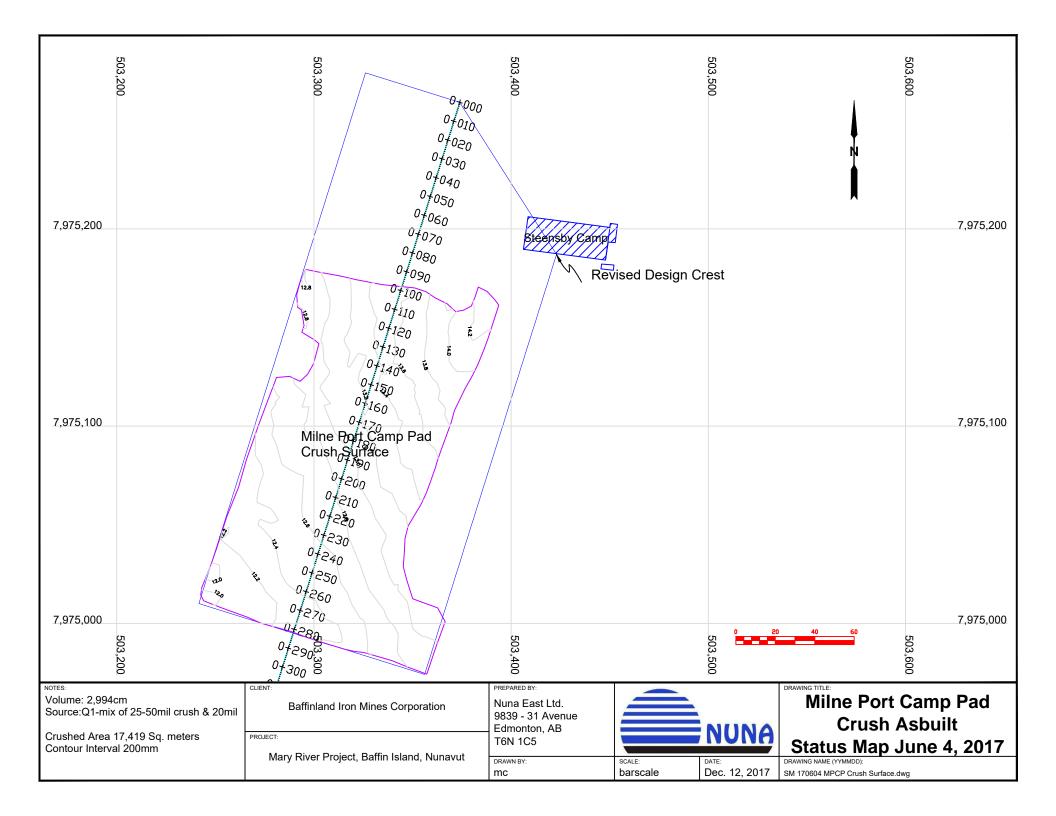





Baffinland Iron Mines LP - Mary River Expansion Project Construction Summary Report: 386p Camp - April 30, 2020

Appendix C Turnover Documents



		~~ ~~ ~~ ~~	7 10
Dorm: A	Dorm Type: 50 Person	Date: May 29	10010
DOITH. /			

D. III. 1992	Dorm H		
Hallways	Accepta	Acceptable	
	Yes	No	
Floors – Clean, Swept			
Walls – Clean, Spot free			
Exterior Doorway – Condition			
Ceilings – Clean			
	The Per		
Notes: (:948 (equical alound elec Cages needed alound lights	tical Panels.		

n. decemb	Dorm H	
Bedrooms	Acceptable	
	Yes	No
Floors – Clean	P	
Walls – Clean, Spot free		
Doorway – Clean, Complete	Ø	
Ceilings – Clean		
Lighting – Clean, complete		
Closet – Clean, Complete	₫	
Windows – Clean, Complete		
Thermostat - Clean, Complete		
Drawers – Clean, Complete	Z	
Mattress - Clean	区	
Bunk Light - Clean, Complete	d	
Furniture - Clean, Complete	Z,	
Smoke Detector - Clean, Complete	ď	
Notes:		



	Dorm H Acceptable		
Bathrooms			
	Yes	No	
Floors – Clean, Swept	7		
Walls – Clean, Spot Free	D		
Doorway – Clean, Complete			
Ceilings – Clean			
Lighting – Clean, complete	♂		
Shower & Door - Clean	团		
Toilet – Clean, complete			
Sink - Clean	C		
Faucets – Clean, Complete			
Floor Drains - Clean			
Mirrors – Clean, Crack Free			
Exhaust Fan – Clean, Complete			
Floor Drains - Clean			
Garbage Cans - Clean			
Notes:			

Yes	table
Voc	
103	No
B	
1	
7	



	Dorm H	
Electrical	Accep	table
	Yes	No
Sub Panel - Complete		3
Distribution Panel - Complete	B	
Baseboard Heater – Clean, Complete		
F/A Panel - complete		
Notes: Signs required for Panels. Signs required for Fire Alarm.		

	Dorm H	ASCERIOR OF STATE	
Safety	Accep	Acceptable	
	Yes	No	
Fire Extinguisher – correct type, current date, required number			
Emergency Evacuation Drawing – posted in adequate numbers			1
Baseboard Heater – signage in mud room			
walkways – Lighting			
Base Radio	1		
AED-installed, functional			
/ March 2 (1) 1 1 2 1 1 2 1 2 2 2 2 2 2 2 2 2 2 2 2	3		
Clear path for Fire Response First Aid and Eyewash in place, clean and ready			
Fire watch identified, schedule in place			
			N.
Water Coolers (3)	1		٦.
Emergency Exit Signage			N
Notes: Cases needed			



Name	Company	Date	Signature
Stephone	Hatch	29/05/19	
Ryan R	Hotek	29/05/19	Coffee
Christopher Olsen.	Horizon North	29/05/19.	Chill
PNACE Grack	Holicon Nocth	29/08/19	4



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Dorm: B Dorm Type: 50 Person Date: 2019-04-09

Hallways	Dorm H	
Hallways	Acceptable	
	Yes	No
Floors – Clean, Swept		
Walls – Clean, Spot free	TA .	
Exterior Doorway - Condition Weather Stripping		×
Ceilings – Clean		
Lighting – Clean, complete		
Vight Covers for all FIFE L. in DORM A-B HALL WAYS. " LABLE MAKER FOR Panels + Lab DJIST Weather Stripping on En	screenmesh of ole all Bre Nevgy Exit Dorm H	atters IN ALL Deors so
Bedrooms	Acceptable	
	Yes	No
Floors – Clean		
	m/	
Walls – Clean, Spot free		
Doorway – Clean, Complete		
Doorway – Clean, Complete Ceilings – Clean Lighting – Clean, complete		
Doorway – Clean, Complete Ceilings – Clean Lighting – Clean, complete		
Doorway – Clean, Complete Ceilings – Clean Lighting – Clean, complete Closet – Clean, Complete – Coat tangers (2)		
Doorway – Clean, Complete Ceilings – Clean		
Lighting – Clean, complete Closet – Clean, Complete – Coat tangers (2) Windows – Clean, Complete		
Doorway – Clean, Complete Ceilings – Clean Lighting – Clean, complete Closet – Clean, Complete Windows – Clean, Complete Thermostat - Clean, Complete		
Doorway – Clean, Complete Ceilings – Clean Lighting – Clean, complete Closet – Clean, Complete + Coat trangers (2) Windows – Clean, Complete Thermostat - Clean, Complete Drawers – Clean, Complete		

Smoke Detector - Clean, Complete

Notes: No Hangers - IN Room closets

CLOSETS "secured" to walls in Rooms

Furniture - Clean, Complete



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Bathrooms	Dorm H	
Battilooms	Acceptable	
	Yes	No
Floors – Clean, Swept		
Walls – Clean, Spot Free		
Doorway – Clean, Complete	Ď/	
Ceilings – Clean	Φ/	
Lighting – Clean, complete	D'	
Shower & Door - Clean	☑ /	
Toilet – Clean, complete		
Sink - Clean		
Faucets – Clean, Complete	\square	
Floor Drains - Clean	₫ /	
Mirrors – Clean, Crack Free		
Exhaust Fan – Clean, Complete		
Floor Drains - Clean	ă/	
Garbage Cans - Clean		
Notes:		

Laundry Room	Dorm H	Dorm H		
Lauriury Noorii	Accept	table		
	Yes	No		
Floors – Clean, Swept				
Walls – Clean, Spot Free				
Doorway – Clean, Complete				
Ceilings – Clean				
Lighting – Clean, complete				
Washing Machines – Clean, Complete				
Dryers – Clean, Lint traps clean, complete				
Mop Sink - Clean				
Storage Lockers - Clean	NA 0			
Floor Drains - Clean				
Garbage Cans - Clean				
Notes: Smake or fire detection?				

Nothing in front Electrical Panel
No Map Bucket in Laundry Room
Ponatrations Fire Caul & B" ASAP" AU Penatrations
Block off Philos in Laundry Boom that are NONE
EXIT LIGHT ABOUE, DOOR GFCI

GFCI on Phys Near water



Electrical		Dorm H	
		Acceptable	
		Yes	No
Sub Panel - Complete			
Distribution Panel - Complete			
Baseboard Heater – Clean, Complete		9/	
F/A Panel - complete		· 4D/	
Notes: Need Lables	on all Bi	rakers	

Safety	Dorm H	Dorm H		
Suicty	Accep	table		
	Yes	No		
Fire Extinguisher – correct type, current date, required number	D)			
Emergency Evacuation Drawing – posted in adequate numbers				
Baseboard Heater – signage in mud room Checkon				
walkways – Lighting				
Base Radio				
AED-installed, functional checked by HSE HNCC				
Clear path for Fire Response	12/			
First Aid and Eyewash in place, clean and ready				
Fire watch identified, schedule in place	U			
Water Coolers (3)	9			
Emergency Exit Signage				
Refrigerator Need in ARCHIC WALKWAY		/		
Notes: TRAP SIGNAGE		·		
Gye Wish IN LAUNDY ROOMS	15 Comple			
Put water in Water Bottle	S AND ST	CANIDS		
At Halfway Point of each	n dorm.			



Name	Company	Date	Signature
Dave Bury	Hoth	Apralpa	D211
Michael Marea	HNCC	APRIL 9 2019	HO
Davin Gurdinse		Apr. 19, 2019	du S
Jonathan Walts	HNCC	April 9,2019	Junk to



Dorm: C	Dorm Type: 50 Person	Date: APC.	23	2019

Hallways	Dorm H		
	Accep	Acceptable	
	Yes	No	
Floors – Clean, Swept	D D		
Walls – Clean, Spot free			
Exterior Doorway – Condition		P	
Ceilings – Clean	G		
Lighting – Clean, complete	7		
Notes: Side exit needs adjustme Fire extinguishers need annual	nt. Camplefed inspections, comple	ted	

Bedrooms	Dorm H	
	Acceptable	
	Yes	No
Floors – Clean		
Walls – Clean, Spot free		
Doorway – Clean, Complete	B	
Ceilings – Clean	B	
Lighting – Clean, complete	9	
Closet – Clean, Complete		7
Windows – Clean, Complete	4	
Thermostat - Clean, Complete		
Drawers – Clean, Complete		
Mattress - Clean	8	
Bunk Light - Clean, Complete		
Furniture - Clean, Complete		F
Smoke Detector - Clean, Complete		
Notes: Finish Laid 0665 - complete		



Dorm:	Dorm Type: 50 Person	Date:	

Hallways	Dorm H		
	Acceptable		
	Yes	No	
Floors – Clean, Swept			
Walls - Clean, Spot free			
Exterior Doorway – Condition	ď		
Ceilings – Clean			
Lighting – Clean, complete		П	
Notes:			

Bedrooms	Dorm H Acceptable		
	Yes	No	
Floors – Clean			
Walls – Clean, Spot free	Ó		
Doorway – Clean, Complete			
Ceilings – Clean	Ø		
Lighting – Clean, complete	<u>d</u>		
Closet – Clean, Complete			
Windows – Clean, Complete			
Thermostat - Clean, Complete			
Drawers – Clean, Complete			
Mattress - Clean			
Bunk Light - Clean, Complete			
Furniture - Clean, Complete			
Smoke Detector - Clean, Complete	3	П	
Notes:			



Bathrooms	Dorm H	
	Acce	otable
FI. OL O	Yes	No
Floors – Clean, Swept		aft com
Walls – Clean, Spot Free		
Doorway – Clean, Complete	7	
Ceilings – Clean	T T	
Lighting – Clean, complete	A	
Shower & Door - Clean	[7	
Toilet – Clean, complete		
Sink - Clean		
Faucets – Clean, Complete	7	
Floor Drains - Clean	X	
Mirrors – Clean, Crack Free	Ø	
Exhaust Fan – Clean, Complete		
Floor Drains - Clean	d	
Garbage Cans - Clean		est con
Notes:		E / CO/

Laundry Room	Dorm H	
	Accep	otable
	Yes	No
Floors – Clean, Swept	8	get con
Walls – Clean, Spot Free	8	П
Doorway – Clean, Complete	8	
Ceilings – Clean		
Lighting – Clean, complete		
Washing Machines – Clean, Complete	T/	
Dryers – Clean, Lint traps clean, complete	2	
Mop Sink - Clean		
Storage Lockers - Clean		
Floor Drains - Clean		
Garbage Cans - Clean	1	
Notes: Smoke or fire detection?	_	



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Electrical	Dorm H		
	Accep	Acceptable	
	Yes	No	
Sub Panel - Complete		П	
Distribution Panel - Complete			
Baseboard Heater – Clean, Complete			
F/A Panel - complete			

Safety	Dorm H		
	Acce	ptable	
	Yes	No	
Fire Extinguisher – correct type, current date, required number	B		
Emergency Evacuation Drawing – posted in adequate numbers	Ø		
Baseboard Heater – signage in mud room			
walkways – Lighting	Ø		
Base Radio			
AED-installed, functional	1		
Clear path for Fire Response	d	П	
First Aid and Eyewash in place, clean and ready	D/		
Fire watch identified, schedule in place	d		
Water Coolers (3)	R		
Emergency Exit Signage	K		
Refrigerator	П	F	
Notes:			

N/A N/A



Name	Company	Date	Signature
Stephane	Hatch	25/04/19	
RYAN SMITH	Hatch	25/04/19	a com
Parky Gactz	HNCC	2 3/04/	19 5
Samp Fi	nky BIM	26/04	1/19
Rya Smith	BHA Hade.	1 26/04/1	9 1/2



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Dorm: D	Dorm Type: 50 Person	Date: 2019-05-11	
20111112	Dorni Type. 30 Terson	Date. 2019-03-11	

Hallways	Dorm D	Dorm D		
	Acce	Acceptable		
	Yes	No		
Floors – Clean, Swept				
Walls - Clean, Spot free				
Exterior Doorway – Condition				
Ceilings – Clean				
Lighting – Clean, complete				

dorm by emergency exit at end of dorm. (Wall piece to be replaced)

Bedrooms	Dorm D	Dorm D		
	Acceptable			
	Yes	No		
Floors – Clean				
Walls – Clean, Spot free				
Doorway – Clean, Complete				
Ceilings – Clean				
Lighting – Clean, complete				
Closet – Clean, Complete				
Windows – Clean, Complete		\boxtimes		
Thermostat - Clean, Complete		\boxtimes		
Drawers – Clean, Complete	\boxtimes			
Mattress - Clean				
Bunk Light - Clean, Complete	\boxtimes			
Furniture - Clean, Complete	\boxtimes			
Smoke Detector - Clean, Complete				

Notes: Room 42 – Wall Damage by closet. (wall section to be replaced) Electric baseboard heater thermostat need to be turned down. Electricians have them turned up on high to verify.



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Bathrooms	Dorm H Acceptable	
	Yes	No
Floors – Clean, Swept		
Walls – Clean, Spot Free		
Doorway – Clean, Complete		
Ceilings – Clean		
Lighting – Clean, complete		
Shower & Door - Clean		
Toilet – Clean, complete		
Sink - Clean		
Faucets – Clean, Complete		
Floor Drains - Clean		
Mirrors – Clean, Crack Free		
Exhaust Fan – Clean, Complete		
Floor Drains - Clean		
Garbage Cans - Clean		

Laundry Room	Dorm H	Dorm H		
	Acceptable			
	Yes	No		
Floors – Clean, Swept				
Walls – Clean, Spot Free	\boxtimes			
Doorway – Clean, Complete	\boxtimes			
Ceilings – Clean	\boxtimes			
Lighting – Clean, complete	\boxtimes			
Washing Machines – Clean, Complete	\boxtimes			
Dryers – Clean, Lint traps clean, complete	\boxtimes			
Mop Sink - Clean				
Storage Lockers - Clean		\boxtimes		
Floor Drains - Clean	\boxtimes			
Garbage Cans - Clean	\boxtimes			

Notes: Laundry rooms are setup. Eyewash is installed as is Sharps containers both are checked for monthly inspection. Dryer lint trays were checked, and all were cleaned out as was the garbage cans were freshly changed



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Electrical	Dorm H		
	Acceptable		
	Yes	No	
Sub Panel - Complete	\boxtimes		
Distribution Panel - Complete	\boxtimes		
Baseboard Heater – Clean, Complete	\boxtimes		
F/A Panel - complete		\boxtimes	

Notes: Main Feed Cables (2") straps need to be secured at base. Also, some of the bedrooms in the last few rooms also need to have the 3rd bx cable strap applied to the lose bx cable. Electricians are aware of this as the new cable straps have been ordered and we are awaiting delivery. The 3rd bx strap was used to add to the last few rooms. Panels still require final Labels from Label Makers on Doors and will be completed for final commissioning.

Safety	Dorm H Acceptable		
	Yes	No	
Fire Extinguisher – correct type, current date, required number	\boxtimes		
Emergency Evacuation Drawing – posted in adequate numbers	\boxtimes		
Baseboard Heater – signage in room	\boxtimes		
walkways – Lighting	\boxtimes		
Base Radio	\boxtimes		
AED-installed, functional	\boxtimes		
Clear path for Fire Response			
First Aid and Eyewash in place, clean and ready	\boxtimes		
Fire watch identified, schedule in place			
Water Coolers (3)	\boxtimes		
Emergency Exit Signage	\boxtimes		
Refrigerator		\boxtimes	
	THE RESERVE THE PARTY OF THE PA		


Notes: Exterior Emergency Access route around the 380 Person Camp is now established and completed as of 2019-05-13. New parking area is also being established and temporary signage is being made onsite.



Name	Company	Date	Signature
Michael Michael	HORIZON HATCH	2019-05-11	Wall -
· company	11	"	Kal
Darry Ca din	- Hotel	05/11/19	flu IJ
Payre Les !	w Bim	.,	at the
De Bury	Hotel	05/11/19	5
Josepher Worth	Horizon	05/11/19	Jen



Doc#: F-002.2 Rev#: Nov 2016

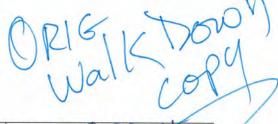

Dorm: D

Dorm Type: 50 Person

Date: 2019-05-1

Hallways	Dorm H	Dorm H Acceptable		
	Accep			
	Yes	No		
Floors – Clean, Swept				
Walls – Clean, Spot free				
Exterior Doorway – Condition	V.			
Ceilings - Clean BLACK CLOTH	<u> </u>			
Lighting – Clean, complete	V			
Notes: Wall Damage to Exterior Emergi Gait, Wall piece	wall at Dor	ed.		

Bedrooms	Dorm H Acceptable	
	Yes	No
Floors – Clean	D'	
Walls – Clean, Spot free		
Doorway – Clean, Complete		
Ceilings – Clean		
Lighting – Clean, complete		
Closet – Clean, Complete		
Windows – Clean, Complete		
Thermostat - Clean, Complete base board hearer	U,	
Drawers – Clean, Complete		
Mattress - Clean		
Bunk Light - Clean, Complete		
Furniture - Clean, Complete		
Smoke Detector - Clean, Complete		
Room 42 - Wall Damage Turn Down Base board	by Close	et.



Walls – Clean, Spot Free Doorway – Clean, Complete Ceilings – Clean Lighting – Clean, complete Shower & Door - Clean Toilet – Clean, complete Sink - Clean Faucets – Clean, Complete Floor Drains - Clean	Accep Yes	table
Walls – Clean, Spot Free Doorway – Clean, Complete Ceilings – Clean Lighting – Clean, complete Shower & Door - Clean Toilet – Clean, complete Sink - Clean Faucets – Clean, Complete Floor Drains - Clean	Yes	
Shower & Door - Clean Toilet – Clean, complete Sink - Clean Faucets – Clean, Complete Floor Drains - Clean		No
Doorway – Clean, Complete Ceilings – Clean Lighting – Clean, complete Shower & Door - Clean Toilet – Clean, complete Sink - Clean Faucets – Clean, Complete Floor Drains - Clean	Q.	
Ceilings – Clean Lighting – Clean, complete Shower & Door - Clean Toilet – Clean, complete Sink - Clean Faucets – Clean, Complete Floor Drains - Clean	1	
Lighting – Clean, complete Shower & Door - Clean Toilet – Clean, complete Sink - Clean Faucets – Clean, Complete Floor Drains - Clean	4	
Lighting – Clean, complete Shower & Door - Clean Toilet – Clean, complete Sink - Clean Faucets – Clean, Complete Floor Drains - Clean Mirrors – Clean, Crack Free	2	
Toilet – Clean, complete Sink - Clean Faucets – Clean, Complete Floor Drains - Clean	Ø	
Sink - Clean Faucets – Clean, Complete Floor Drains - Clean	4	
Faucets – Clean, Complete Floor Drains - Clean		
Floor Drains - Clean	I	
	Ø	
Mirrors – Clean, Crack Free	Z	
	ď	
Exhaust Fan – Clean, Complete		
Floor Drains - Clean		
Garbage Cans - Clean		
Notes:		

Laundry Room	Dorm H	Dorm H	
Ladinary mooni	Acceptable		
	Yes	No	
Floors – Clean, Swept	P		
Walls – Clean, Spot Free	ď		
Doorway – Clean, Complete	Z		
Ceilings – Clean	4		
Lighting – Clean, complete	2		
Washing Machines – Clean, Complete			
Dryers – Clean, Lint traps clean, complete	Ø		
Mop Sink - Clean			
Storage Lockers - Clean	ď		
Floor Drains - Clean			
Garbage Cans - Clean	Ø		



Electrical	Dorm H Acceptable	
	Yes	No
Sub Panel - Complete	4	
Distribution Panel - Complete		
Baseboard Heater – Clean, Complete		
F/A Panel - complete		
Notes: Pin + Secure Main Feed Cable Check all Rooms for 1000 Cable Electrican	e to Pare	els, S

Safety	Dorm H	
	Acce	ptable
	Yes	No
Fire Extinguisher – correct type, current date, required number		
Emergency Evacuation Drawing – posted in adequate numbers		
Baseboard Heater – signage in mud room	U	
walkways – Lighting		
Base Radio		
AED-installed, functional		
Clear path for Fire Response		
First Aid and Eyewash in place, clean and ready	4	
Fire watch identified, schedule in place		
Water Coolers (3)		
Emergency Exit Signage		
Refrigerator		0
Notes: Exterior, Route for En	nerg Acc	ess
complete 2019-05-4	13	
	nerg Acc	ess



Dorm	E	Dorm Type: 50 Person	Date: May 29	2019
			,	

Yes Acces	otable No
Yes	No
	140
Ø	

Bedrooms	Dorm H	Dorm H Acceptable	
	Acce		
	Yes	No	
Floors - Clean	P		
Walls – Clean, Spot free			
Doorway – Clean, Complete			
Ceilings – Clean			
Lighting – Clean, complete	D		
Closet – Clean, Complete	7		
Windows – Clean, Complete			
Thermostat - Clean, Complete			
Drawers – Clean, Complete			
Mattress - Clean			
Bunk Light - Clean, Complete	D		
Furniture - Clean, Complete			
Smoke Detector - Clean, Complete	Ø		
Notes: M:ssing signs next to heaters.			



Bathrooms	Dorm H	
	Acceptable	
	Yes	No
Floors – Clean, Swept		
Walls – Clean, Spot Free		
Doorway – Clean, Complete	Ø	
Ceilings – Clean		
Lighting – Clean, complete		
Shower & Door - Clean		
Toilet – Clean, complete		
Sink - Clean	3	
Faucets – Clean, Complete		
Floor Drains - Clean		
Mirrors – Clean, Crack Free		
Exhaust Fan – Clean, Complete		
Floor Drains - Clean		
Garbage Cans - Clean		
Notes:		

Laundry Room	Dorm H Acceptable		
	Yes	No	
Floors – Clean, Swept			
Walls – Clean, Spot Free	7		
Doorway – Clean, Complete	Image: second control of the control		
Ceilings – Clean	☑		
Lighting – Clean, complete			
Washing Machines – Clean, Complete	☑		
Dryers – Clean, Lint traps clean, complete			
Mop Sink - Clean	7		
Storage Lockers - Clean	☑		
Floor Drains - Clean	D'		
Garbage Cans - Clean	ď		
Notes: Smoke or fire detection?			



Electrical	Dorm H		
	Acceptable		
	Yes	No	
Sub Panel - Complete	7		
Distribution Panel - Complete			
Baseboard Heater – Clean, Complete			
F/A Panel - complete			
Motes: Missing Signs for electrical Panel, Fire Alarm +	- sprinklers.		

Safety	Dorm H		
	Acceptable		
	Yes	No	
Fire Extinguisher – correct type, current date, required number	d		
Emergency Evacuation Drawing – posted in adequate numbers			
Baseboard Heater – signage in mud room	7		
walkways – Lighting	2		
Base Radio			
AED-installed, functional	ď		
Clear path for Fire Response	ð		
First Aid and Eyewash in place, clean and ready	7		
Fire watch identified, schedule in place	Ø		
Water Coolers (3)			
Emergency Exit Signage	2		
Refrigerator			
Notes:			



Name	Company	Date	Signature /
Stephane Siont	Halch	29/05/19	
Smitz.	Hotel	29/05-/19	The
Christopher Olsen.	Horizon North.	29/05/19.	Chill
Parker Gaetz	Helizon North		le



				-		000
Dorm	F	Dorm Type: 50 Person	Date:	ارد	411	2019
		•			0	

Hallways	Dorm H	Dorm H		
	Acceptable			
	Yes	No		
Floors – Clean, Swept	P			
Walls – Clean, Spot free	D			
Exterior Doorway – Condition				
Ceilings – Clean	₽			
Lighting – Clean, complete	D			
Notes:				

Bedrooms	Dorm H Acceptable		
beardons			
	Yes	No	
Floors – Clean	2		
Walls – Clean, Spot free			
Doorway – Clean, Complete	Image: section of the content of the		
Ceilings – Clean			
Lighting – Clean, complete			
Closet – Clean, Complete			
Windows – Clean, Complete			
Thermostat - Clean, Complete	Ø		
Drawers – Clean, Complete	团		
Mattress - Clean	Ø		
Bunk Light - Clean, Complete			
Furniture - Clean, Complete			
Smoke Detector - Clean, Complete			
Notes:		7	
		1	



Incoming Dorm Inspection Pre-Occupancy Checklist

Doc#: F-002.2 Rev#: Nov 2016

Bathrooms	Dorm H Acceptable		
Floors – Clean, Swept	D-		
Walls – Clean, Spot Free			
Doorway – Clean, Complete			
Ceilings – Clean	[]		
Lighting – Clean, complete	Id		
Shower & Door - Clean			
Toilet – Clean, complete			
Sink - Clean			
Faucets – Clean, Complete	□ □		
Floor Drains - Clean	2		
Mirrors – Clean, Crack Free	3		
Exhaust Fan – Clean, Complete	D D		
Floor Drains - Clean			
Garbage Cans - Clean			
Notes:			

Laundry Room	Dorm H		
	Acceptable		
	Yes	No	
Floors – Clean, Swept			
Walls – Clean, Spot Free			
Doorway – Clean, Complete			
Ceilings – Clean	2		
Lighting – Clean, complete	Z		
Washing Machines – Clean, Complete	2		
Dryers – Clean, Lint traps clean, complete	2		
Mop Sink - Clean	2		
Storage Lockers - Clean	Q		
Floor Drains - Clean	[2]		
Garbage Cans - Clean	己		
Notes: Smoke or fire detection?			



Rev#: Nov 2016

Planting	Dorm H Acceptable		
Electrical			
	Yes	No	
Sub Panel - Complete			
Distribution Panel - Complete			
Baseboard Heater – Clean, Complete	B		
F/A Panel - complete		0	

ECU's need to be hooked up Protecting grounding Rods

C-S-t-	Dorm H	
Safety	Acceptable	
	Yes	No
Fire Extinguisher – correct type, current date, required number		
Emergency Evacuation Drawing – posted in adequate numbers		
Baseboard Heater – signage in mud room	B	
walkways – Lighting		
Base Radio		
AED-installed, functional		
Clear path for Fire Response		
First Aid and Eyewash in place, clean and ready		
Fire watch identified, schedule in place		
Water Coolers (3)		
Emergency Exit Signage		
Refrigerator		
Notes:		



Name	Company	Date	Signature
Rejay Smite	Hatch	July 11, 2019	M
Wayne Guigon	Hatcy	July 11/19	WS5
Christeder Olden	HNCC	July 11, 2019	Out
Mayen Hamad	Hata	July 11, 2019	1
Palkel Gractz	Horizon	Ja17/1/2019	3



Incoming Dorm Inspection
Pre-Occupancy Checklist

Doc#: F-002.2 Rev#: Nov 2016

Dorm: G Dorm Type: 50 Person Date: Jy 1, 2019.

Hallways	Dorm H	
	Acceptable	
	Yes N	
Floors – Clean, Swept		
Walls – Clean, Spot free	· ·	
Exterior Doorway – Condition		
Ceilings – Clean		
Lighting – Clean, complete		
Notes: Little bit of construction debris left 120/208V sign on panels. Fix closer on dormexit. North side (1 feeted; mg Ground rods	V	

Bedrooms	Dorm H Acceptable	
Beardons		
	Yes	No
Floors – Clean		
Walls – Clean, Spot free	Ø	
Doorway – Clean, Complete	Ø	
Ceilings – Clean	Z'	
Lighting – Clean, complete	I	
Closet – Clean, Complete	7	
Windows – Clean, Complete	2	
Thermostat - Clean, Complete	2	
Drawers – Clean, Complete	☑	
Mattress - Clean	ď	
Bunk Light - Clean, Complete		
Furniture - Clean, Complete		
Smoke Detector - Clean, Complete	2	
Notes:		



Bathrooms	Dorm H Acceptable		
Datin Coms			
	Yes	No	
Floors – Clean, Swept			
Walls – Clean, Spot Free			
Doorway – Clean, Complete	ſ		
Ceilings – Clean			
Lighting – Clean, complete			
Shower & Door - Clean			
Toilet – Clean, complete	3		
Sink - Clean			
Faucets – Clean, Complete	ď		
Floor Drains - Clean	I		
Mirrors – Clean, Crack Free	[2]		
Exhaust Fan – Clean, Complete	Z		
Floor Drains - Clean	I		
Garbage Cans - Clean			
Notes:			

Laundry Room	Dorm H		
Lauriary Room	Acceptable		
	Yes	No	
Floors – Clean, Swept			
Walls – Clean, Spot Free			
Doorway – Clean, Complete			
Ceilings – Clean	Ø		
Lighting – Clean, complete	3		
Washing Machines – Clean, Complete	ď		
Dryers – Clean, Lint traps clean, complete			
Mop Sink - Clean	Ø		
Storage Lockers - Clean	B		
Floor Drains - Clean			
Garbage Cans - Clean			
Notes: Smoke or fire detection?			



Incoming Dorm Inspection Pre-Occupancy Checklist

Doc#: F-002.2 Rev#: Nov 2016

Electrical	Dorm H Acceptable		
	Yes	No	
Sub Panel - Complete			
Distribution Panel - Complete	G-		
Baseboard Heater – Clean, Complete			
F/A Panel - complete			
Notes: 120/208V signs on panels. Emerginary lights Fire Alarm not hooked up. Wife needs to b	need to be insta x installed	. Med CExterior	

Safety	Dorm H		
	Acceptable		
用基础的工作。 	Yes	No	
Fire Extinguisher – correct type, current date, required number			
Emergency Evacuation Drawing – posted in adequate numbers			
Baseboard Heater – signage in mud room			
walkways – Lighting			
Base Radio	2		
AED-installed, functional	2		
Clear path for Fire Response			
First Aid and Eyewash in place, clean and ready	6		
Fire watch identified, schedule in place			
Water Coolers (3)			
Emergency Exit Signage	8		
Refrigerator			
Notes: Emergency lights need tags.			



Name	Company	Date	Signature
Kanfinde	Hotel	They 1/19	M
Kap. In Hamed	Hatch	July 11/19	
Nayne Guige	on Flatch.	Joly 11/19.	as
Palkel Graetz	en Flatch. Holizan	52/7/1/19	3



Hallways

Floors - Clean, Swept

Mattress - Clean

Bunk Light - Clean, Complete

Furniture - Clean, Complete

Smoke Detector - Clean, Complete

Incoming Dorm Inspection Pre-Occupancy Checklist

Doc#: F-002.2 Rev#: Nov 2016

	26 D	Date: 2019-06-26
Dorm: H	Dorm Type: 36 Person	Date: 2021

IN Progress

Dorm H

Yes

4

Acceptable

No

Walls – Clean, Spot free		1 Can
Exterior Doorway – Condition Door Needs closeur	N/A D	
Ceilings – Clean		
Lighting – Clean, complete		1 STEKCES
Notes: Panels in Emerg ExITS Need until my Real 208 V INSULATION ON HEATERS OUTSIDE EXIT DOOR @ DORM END - FIXED VIKING FIRE SUPRESSION WILL BE	26-06-19@ BACK JULY 11	3:20pm cw 2019 - NO
	Dorm H	- wantil
Bedrooms	Acce	ptable
	Yes	No
	_/	
Floors - Clean IN Progress of cleaning		
1100100		
Walls – Clean, Spot free		
Walls – Clean, Spot free Doorway – Clean, Complete		
Walls – Clean, Spot free Doorway – Clean, Complete Ceilings – Clean	N/A D	
Walls – Clean, Spot free Doorway – Clean, Complete Ceilings – Clean Lighting – Clean, complete	N/A D	
Walls – Clean, Spot free Doorway – Clean, Complete Ceilings – Clean Lighting – Clean, complete Closet – Clean, Complete	N/A D	

Room 7 Closef Not Secure Room 5 11 11 11

NORTH EAST EXIT EMERG Light is ShowING Green and Does NOT TEST Correct. - CONNECTED WIRE TO BATTERY CHARGING @ 5: ZOFIN CW 26-06-19

ROUBANCE ROUBE 26-JUNE-2019



Electrical	Dorm H			
	Acce	eptable		
	Yes	No		
Sub Panel - Complete				
Distribution Panel - Complete				
Baseboard Heater – Clean, Complete				
F/A Panel - complete				
Notes: We still Need 208 V STICKER	RS FOR AL	-L PANELS		
HACC SIGNS INSTALLED ABOVE BACEBO	ARD HEATER	es w/screws		

Safety	Dorm H				
	Accep	table			
	Yes	No			
Fire Extinguisher – correct type, current date, required number					
Emergency Evacuation Drawing – posted in adequate numbers	Ė				
Baseboard Heater – signage in mud room					
walkways – Lighting					
Base Radio	0/				
AED-installed, functional					
Clear path for Fire Response					
First Aid and Eyewash in place, clean and ready					
Fire watch identified, schedule in place					
Water Coolers (3)	V.				
Emergency Exit Signage					
Refrigerator	N/A				
Notes:					



Name	Company	Date	Signature
Michael M Erea	HORIZON	2019-86-26	Water State of the
Davru Gardinen	Hatelt	2019-06-26	Unn IL
Roybasen	HATCH	2013-06-16	A
Chacwesen	Hn ce	2019-06-26	-00



Baffinland Iron Mines Corporation Mary River Expansion Project H353004

Quality Form Site Construction Close Out ITP Section

Final Walk Down Attendance Sheet

Project: Mary River Expansion Project	Contractor: Horizon North	Contract No.: 4	353004-TX601		
Location: Milne Port	Elevation:	CWP: N/A	35 5004- (X00)		
Area: 386 man camp	Area Description: Five Alarm	10/17			
Inspection Test Plan No.:	Rev:	Issue Date	Alm / 12.0		
	Final Walk Down Description		· Nov 6/2019		
System/Sub System No.:	System/Sub System Description				
Tag No.:	T D				
Walk Down Date: Nov 6 /2019 Sta	art Time: 9:30 AM	The Filliam system			
	Attendees	786	mon cump office		
Name (Print)	Name (Sign)	Company	T		
1 Vake Anderson	An (orgin)		Department		
2 Daniel Mush	400	HNCC	Elei		
3 Wayne Haynes	The state of the s	Huce	Elec		
4 BODY NOYA	March Heyn	Leitt Sufety	Fire Alain		
5 Da Fitzgerald	A	Intothe Couse	an Close		
6 Ronal Frach		Hatch.	ET		
7	A Comment of the Comm	Hatch	QA		
8					
9					
10					
11					
12					
14					
16					
17					
18					
Contractor QC Manager/Designate	i 1				
Title	Vak Andrison 1	190	Nov 7/19 Date		
	Name (Print/Sign)	7			
Title	Ronny Frank 1 Name (Print/Sign)	N. Contraction of the contractio	1007-2019		
	(Filitosign)		Date		



Baffinland Iron Mines Corporation Mary River Expansion Project H353004

Quality Form Site Construction Close Out ITP Section

Construction QC Punchlist

			construction &c Functions	L				
Proj	ect: Ma	ary River Expansion Project	ITP No.:	CWP: N//	A			
Con	tractor	Horizon No-th	Contract No.: H 353004 - TX00	Sub-Syst	em: N	/A		
Loca	ation: N	Milne Port	Area: 386 man como	Area Des			_	
Tag	No.:		Tax Danadation (Test Pack	rage No :			
	_	Discipline Index: M - N	lechanical P - Piping C - Civil S - Structural			I - Instrumenta	ation	
	0					e Initiated		mpleted
Item	Discipline	Pt	unchlist Item Description	Punch	Initial	Date	Initial	Date
n	m	check fire rating	of doors		JH	Nov 6/19		
2	m	check down five vo	4+147		JA	Nou 6 119		
3	E	Corridor Intercor	ments sow cuble. Hard wired,		TH	Nov6/19		
						17		
0,00	otance	is issued.	Pre-OP. Testing 2 – Completed Prior to Hand Over from Pre- pleted by the end of the trial operation and hand over to ope	erations 5-	Complete	g 3 – Complete	Prior to the al performa	Completion
	ITE	EM LISTED ABOVE ARE AGREED	UPON AND SHALL BE TRANSFERRED TO THE MAS	STER PUN	CHLIST:	☐ Yes ☐	No 🗆	N/A
Cont	Vak	r QC Designate - Print/Sign	E	ler per	ail		Nov	
0		T 6		Title			Date	, '
Hate	h OA	Designate - Print/Sign	Ma	Joh WA			11006	- 2017
· rate	II GOA	besignate - Fillipolyii	<u></u>	Title			Date	



Baffinland Iron Mines Corporation Mary River Expansion Project H353004

Quality Form Site Construction Close Out ITP Section

Final Walk Down Attendance Sheet

Project: Mary River Expansion Project	Contrac	tor: Horizon North	Contract No.:	1353004-TX001
Location: Milne Port	Elevatio		CWP: N/A	
Area: 386 Man Camp	Area De	escription:		
Inspection Test Plan No.:		Re	v: Issue Date	: Nov 1/2019
	Final V	Valk Down Description		,
System/Sub System No.: N/A		System/Sub System Descrip	tion: Water Treatm	neat Plant
Tag No.:		Tag Description:		1 / 40/1
Walk Down Date: Nov 1/2019	Start Time:	9:00 Am	Meeting Place: 386	man camp office
		Attendees	,	man camp orasca
Name (Print)		Name (Sign)	Company	Department
1 Vake Anderson	_	11	HNCC	Elic
		7	HatcH.	E T
2 Don Fitzgerald 3 Josh Halleran	M	h Bully	ANG	Elec
4	1	1 100000	737.00	1180
5				
6				
7				
8				
9				
10				
11				
12				
14				
16				
17				
18				
Contractor QC Manager/Designate	cla	ke Anderson 1	da	Nov 1/13
Title	Va	Name (Print/S	Sign)	Date
Hatch QA Manager/Designate	Ronny	Frank 15	4	Nous-2019
Title		Name (Print/S	Sign)	Date



Baffinland Iron Mines Corporation Mary River Expansion Project H353004

Quality Form Site Construction Close Out ITP Section

	Construction QC Punchlis	t				
Project: Mary River Expansion Project	ITP No.:	CWP: N/A	A			
Contractor: Horizon North	Contract No.: #353004 - TX001	Sub-System:				
Location: Milne Port	Area: 386 man camp	Area Des	cription:		_	
Tag No.:	Tag Description: Water Treatment Plant	Test Pack	age No.:			
Discipline Index: M – M	echanical P - Piping C - Civil S - Structural	E - Elec	trical	I - Instrumenta	tion	
			Dat	e Initiated	Co	mpleted
Discipline nd	nchlist Item Description	Punch	Initial	Date	Initial	Date
1 E Five caulting light as	t front door	2	TH	Nov 1/19	JA	Nos5/19
2 E Tidy wire on LL swin		2	JA	No. 1/19	JA	Nov 5/19
3 E Spare parts list		3	TH	Nov 1/19	Jn	Nous 119
PRIORITY: 1 – Completed Prior to Handover to Pr	e-OP. Testing 2 – Completed Prior to Hand Over from Pre-	Op to Comm	nissioning	3 - Complete F	Prior to the	Completion
acceptance is issued. ITEM LISTED ABOVE ARE AGREED Vake Pardyson Contractor QC Designate - Print/Sign	UPON AND SHALL BE TRANSFERRED TO THE MAS	STER PUN	Complete	d before the fina	al performa	N/A / / / / 9
Hatch QA Designate - Print/Sign	Hato	Title				-2019
		Title			Date	9



E353004-TX001-130-124-0009_Sub01

Baffinland Iron Mines Corporation Mary River Expansion Project H353004

Quality Form Site Construction Close Out ITP Section

Final Walk Down Attendance Sheet

Project: Mary River Expansion Project	Contractor: Horizon Wo	Contract No	:: H353004-TX001		
Location: Milne Port	Elevation:		/A		
Area: 386 Man Camp	Area Description:				
Inspection Test Plan No.:		Rev: Issue	e Date: Nov 4/2019		
	Final Walk Down Desci	ription			
System/Sub System No.:	System/Sub System D	escription:			
Tag No.:	Tag Description:	ise Water Sprink	cler System		
Walk Down Date: Nov 4/2019	Start Time: 1:00 PM				
	Attendees				
Name (Print)	Name (Sign)	Compar	ny Department		
1 Vake Anderson	4	HWCC	Elec		
2 Ronny Franken	7	Hatch	QA		
3. Dan Fitzgerald	7.	Hatch			
4					
5					
6					
7					
8					
9					
10					
11					
12					
14					
16					
17					
18					
Contractor QC Manager/Designate	Jake Anderson	1 1	Nov 4/19		
Title	Roung Franker	(Print/Sign)	Date		
Hatch QA Manager/Designate	Ronny tranker	M	Nov 4-2019		
Title	Name	(Print/Sign)	Date		



Baffinland Iron Mines Corporation Mary River Expansion Project H353004

Quality Form Site Construction Close Out ITP Section

Construction QC Punchlist

		Construction QO run	omist				
Project: Mary River E	xpansion Project	ITP No.:	CWP: N/A	CWP: N/A			
Contractor: Horiz	on North	Contract No.: #353004-TX001	Sub-Syste	Sub-System:			
Location: Milne Port		Contract No.: #353004-TX001 Area: 386 Man Camp		Area Description:			
Tag No.:	IA	Tag Description: Fire Water Sprinkler	Test Pack	age No.:	NIA		
Di	scipline Index: M - I	Mechanical P – Piping C – Civil S – Stro	uctural E - Elec	trical	l - Instrumen	tation	
				Date	Initiated	Cor	mpleted
Item Discipline	Р	unchlist Item Description	Punch	Initial	Date	Initial	Date
No po	unches						
of Commissioning and acceptance is issued.	Before Pre-Trial 4 – Com	Pre-OP. Testing 2 – Completed Prior to Hand Over fr pleted by the end of the trial operation and hand over D UPON AND SHALL BE TRANSFERRED TO T	er to operations 5 -	Complete	d before the fi	Prior to the nal performa	nce
Jake And Contractor QC Des	dwson I -		Horizon, E Title	lec Le	ead	Nov	4-2019
Ronny Franke	en 1	SI - Hu	tch QA		/	100 4 - A	2019
Hatch QA Designat		346	Title			Date	





Baffinland Iron Mines Corporation Mary River Expansion Project H353004 Quality Form Site Construction Close Out ITP Section

Final Walk Down Attendance Sheet

Project: Mary River Expansion Project	Contrac	tor: Horizon V	Vorth	Contract No.: H3	53004 - TX001
Location: Milne Port	Elevation			CWP: N/H	
Area: 386 Man Camp	Area De	escription: WW	TP	/	
nspection Test Plan No.:			Rev:	Issue Date:	Nov 5/2019
	Final V	Walk Down Des	cription		,
System/Sub System No.:		System/Sub System	Description:		
Tag No.:		Tag Description:	Waste 1	Natar Treatm	rent Plant
Walk Down Date: Nov 5/2019	Start Time:	10:00 Am		Meeting Place: 386 n	
		Attendees			
Name (Print)		Name (Sign)	i e	Company	Department
1 Vak Anduson		1		HNCC	Elec
2 Do Fitzgerald		12		Hatch	EAT
3 Ronny Frank	(1		Hatch	QA
4					
5					
6					
7					
8					
9					
10					
11 12					
14					
16					
17					
18					
Contractor QC Manager/Designat	e Ja	K Andyson Nam	1	17	Nov 5 // Date
Title	0	Nam	ne (Print/Sign)	7_	
Hatch QA Manager/Designate	Konn	1 Frank	ne (Print/Sign)	H	Nov 5-2019 Date



Baffinland Iron Mines Corporation Mary River Expansion Project H353004

Quality Form Site Construction Close Out ITP Section

		Construction QC P	unchlist					
Project: M	ect: Mary River Expansion Project ITP No.: CWP: N/A							
Contractor: Horizon North Contract No.		Contract No.: H353004-TX00	Sub-Syst	Sub-System:				
1		Area: 386 Man Camp		Area Description:				
Tag No.:			regiment Test Pac	kage No.:				
	Discipline Index: M - I		- Structural E - Ele	W. W. W.	I - Instrument	ation		
	Punchlist Item Description			Date Initiated		Completed		
Item Discipline			Punch	Initial	Date	Initial	Date	
1 E	Box missing cover			JA	Nov 4/19	TH	Nou 5/19	
2 E	Cable not terminated in box			JA	Nov 4/19	JA	Nov 5/19	
3 E	XFMR Grounding incorrect			3H	Nov 4/19	JA	Nos 5/19	
4 E	Panels not labelled missing schedule			JH	Nov 4/19	JA	No 5/19	
5 E	Air exchanger supports			54	No14/19	JA	Nov 5/19	
6 E	Tidy wire on ground			JU	Nov 4/19		Nov 5/19	
7 8	Tray bindus and loose material			JA	Wov 4/19	JH	Mov 5/19	
8 E	mesh cover on stacks			54	Nov 4/19		100-11/	
9 E	Receiving station chain on values			JA	Nov 4/19	JA	Nov 5/19	
10 E	Class 17 Div 2 C	larification		JA	Nov 4/19	TH	HOLL	
PRIORITY: 1 – Completed Prior to Handover to Pre-OP. Testing 2 – Completed Prior to Hand Over from Pre-Op to Commissioning 3 – Complete Prior to the Completion of Commissioning and Before Pre-Trial 4 – Completed by the end of the trial operation and hand over to operations 5 – Completed before the final performance acceptance is issued. ITEM LISTED ABOVE ARE AGREED UPON AND SHALL BE TRANSFERRED TO THE MASTER PUNCHLIST: Yes NO N/A								
Contractor QC Designate - Print/Sign Electrical Lead Title					/\Data	10v 5/19		
Ronns	Franker 15	Wall DA	ol a			- 20v0		
Hatch QA Designate - Print/Sign			Title	Title			100 5-2019 Date	





Baffinland Iron Mines LP - Mary River Expansion Project Construction Summary Report: 386p Camp - April 30, 2020

Appendix D

Contact Information as per Components 1 and 2 of the Commercial Lease Requirement





Baffinland Iron Mines LP - Mary River Expansion Project Construction Summary Report: 386p Camp - April 30, 2020

Company	Address	Contact Numbers
Hatch (Global Corporate Office)	Sheridan Science & Technology Park	Tel: 1-905-855-7600
(EPCM Contractor)	2800 Speakman Drive	Fax: 1-905-855-8270
,	Mississauga, ON L5K 2R7 Canada	
Nuna East Limited	9839 – 31 Avenue NW	Tel: 1-780-434-9114
	Edmonton, AB T6N 1C5 Canada	Fax: 1-780-434-7758
Horizon North	10351-144th Avenue NW	Tel :1-866-305-6565
	Grande Prairie, AB T8V 7J9 Canada	

Role	Name	Email
Preparer of Report	Glen Peace, P.Eng.	glen.peace@hatch.com
Responsible for Construction	Marlon Coakley	marlon.coakley@hatch.com
Baffinland Representative	Christopher Murray	Christopher.murray@baffinland.com





Baffinland Iron Mines LP - Mary River Expansion Project Construction Summary Report: 386p Camp - April 30, 2020

Appendix E

Map to Show Construction in Relation to Lease Boundaries and Water Bodies

