
Attachment 3
380-Person Camp Layout

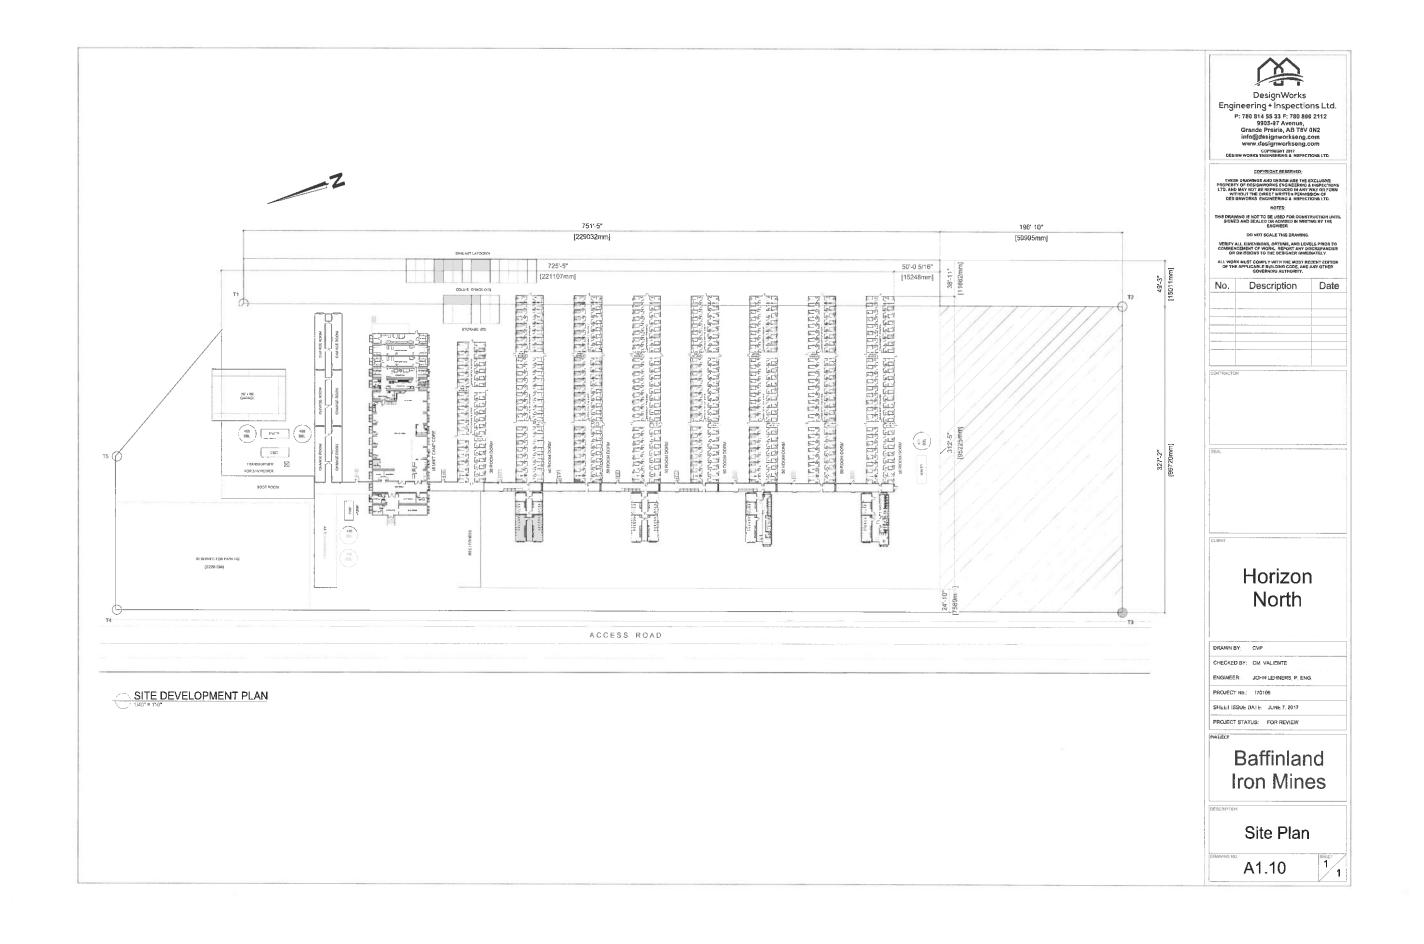

# Attachment 4 380-Person Camp Construction Methodology





Baffinland Iron Mines LP Mary River Project H353004

Project Management Plan Project Management Construction Methodology - Milne Port Accommodation Facility

#### Plan

## Construction Methodology - Milne Port Accommodation Facility

		,	Podenou	- po offillu	Juli	M Wane
2017-07-14	0	Approved for Use	L Langlois	TBruce	S Heiner	M Weaver
DATE	REV.	STATUS	PREPARED BY	CHECKED BY	APPROVED BY	APPROVED BY
						Employer



HATCH

Baffinland Iron Mines LP Mary River Project H353004 Project Management Plan Project Management Construction Methodology - Milne Port Accommodation Facility

#### 1. Overview

A new accommodation camp with a 380 single bed configuration is intended to be constructed at Milne Port. The associated infrastructure, including a dedicated sewage treatment plant and potable water treatment plant, are included within this scope.

The new accommodations camp and associated infrastructure will be situated on a new accommodation camp pad located south of the Milne Port Ore Stockpile Pad and west of the Tote Road (Km 1).

#### 2. Scope of Work

The scope of work starts with the sourcing of construction material which consists of drilling, blasting and crushing aggregate at the Milne Port Q1 Quarry. This produced rock fill material will be utilized to construct the pad for the new accommodations camp pad, a diversion ditch to direct surface water around the pad's southern perimeter and a utility berm to bench the required electrical cables for the new camp. This infrastructure is required to support the assembly and installation of the new 380 person camp and its associated facilities at Milne Port.

#### 3. Methodology

#### 3.1 Earthworks

#### 3.1.1 Material Sourcing

Material, both bulk fill and crusher produced aggregates, required for the new accommodations camp pad and associated works will be sourced from the Milne Inlet Q1 Quarry.

Quarry operations at the Q1 Quarry will be in accordance with the current Baffinland Q1 Quarry Management Plan (BAF-PH1-830-P16-0017).

A coordination meeting will be held between Baffinland Operations and Projects departments and the relevant contractors to determine the total aggregate requirements and develop a schedule for the planned quarry development at the Q1 Quarry.

#### Reference documents:

Q1 Quarry Management Plan (BAF-PH1-830-P16-0017)



Baffinland Iron Mines LP Mary River Project H353004



Project Management Plan Project Management Construction Methodology - Milne Port Accommodation Facility

#### 3.1.2 Camp Pad Water Diversion System Construction

A diversion system is required to direct the flow of a small seasonal stream around the southern perimeter of the new accommodations camp pad at Milne Port. Construction of the diversion system will adhere to the Construction Methodology – Camp Pad Water Diversion System (H353004-40000-400-050-0001 – Rev. 1) and engineered drawings designed and provided by Hatch.

#### Reference Documents:

Hatch – Construction Methodology – Camp Pad Water Diversion System (H353004-40000-400-050-0001, Rev. 1)

Hatch – Milne Port Camp Pad Natural Stream Diversion – Hydrology & Hydraulic Calculations (H353004-2100-240-030-001, Rev. 0)

#### 3.1.3 Camp Pad and Foundation Construction

The sub-grade of the accommodations camp pad will be constructed using Type 12 (Run of Quarry <200mm) coarse material and capped with Type 5 (<32mm crushed) crushed granular surface material. Type 5 material will be utilized as a final pavement for walkways and parking areas.

Pad construction will begin by the placement of Type 12 (Run of Quarry <200mm) coarse material. Upon achieving the required lift thickness, the entire surface area will be proofed and compacted with the utilization of a 10-ton vibratory compactor. Upon achieving consolidation, placement of Type 5 (<32mm crushed) crushed surface material will follow and be completed to the design elevation, including proofing and compaction with a 10-ton vibratory compactor. In addition, the pad will be graded to be free draining in order to prevent water from ponding on the pad.

The foundations for the camp structures will be installed by the Camp Installation Contractor. The foundations will consist of wooden cribbing assembled on top of interlocking 6" thick wooden matting. Both the hard-wall common core structures as well as the soft-wall dormitories will be erected upon these wooden foundations.

The foundations for the potable water treatment plant and the sewage treatment plant will incorporate a high-density expanded polystyrene insulating layer to offset any potential thermal migration into the underlying pad.

The layout of the new accommodations camp is presented in the Horizon North document: Milne Port New Accommodations Camp - Site Plan (A1.10)

#### **Reference Documents:**

Milne Port New Accommodations Camp - Site Plan (A1.10)

H353004-40000-400-050-0003, Rev. 0,



HATCH

Baffinland Iron Mines LP Mary River Project H353004

Project Management Plan Project Management Construction Methodology - Milne Port Accommodation Facility

#### 3.1.4 Utility Berm Construction

The new camp will need to be temporarily energized following the assembly of the camp and associated infrastructure using an electrical feed (3-5 kV cable) tied into Milne Port's existing power generators. Prior to commissioning the new camp and associated infrastructure, the temporary electrical feed will be discontinued and switched over to a dedicated e-house connected to Milne Port's power generators. To tie-in the dedicated e-house for the new camp and associated infrastructure, the existing utility berm will need to be extended to route the electrical cables between the new camp and the dedicated e-house near the existing Milne Port's power generators. A route for the utility berm extension has been determined and is aligned in a northeast direction from the new camp pad.

In addition to extending the existing Milne Port utility berm, the existing Milne Port utility berm will be widened by 1.5 meters to accommodate the additional electrical cables required to service the new camp and associated infrastructure. The design and construction of the utility berm extension and widening will be consistent with existing utility berms at the Project.

#### 3.2 Camp Construction

The layout of the new camp and associated infrastructure is provided in Horizon North document: Milne Port New Camp – Site Plan (A1.10). Construction of the new camp and associated infrastructure will commence on the north end of the new camp pad with the erection of a 2,400 sq. ft. garage. The garage will be used by the Camp Installation Contractor as a warming shed and fabrication area during the assembly of the new camp and associated infrastructure (sewage treatment plant, potable water treatment plant, etc.). Following the construction of the new camp and associated infrastructure, the garage will continue to be used to support the operation of the new camp.

Following the construction of the garage, construction of the new camp will commence with placement of the hard-wall common core facilities on the wooden foundations. While these common core units of the new camp are being integrated and assembled, the installation of the potable water treatment plant, located adjacent to the garage, will begin. The installation of the transformer and dedicated e-house will also occur during this same period in the schedule.

In parallel to the installation of the potable water treatment plant, the installation of the sewage treatment plant will occur on the far southern portion of the new camp pad. This location has been selected to take advantage of the prevailing winds from the north. The installation and commissioning of the sewage treatment plant and potable water treatment plant will require specialized skills and will be directed by the expertise of the vendor. Commissioning of the sewage treatment plant and potable water treatment plant will include connecting the plants to the new camp using insulated HDPE piping.





Baffinland Iron Mines LP Mary River Project H353004 Project Management Plan Project Management Construction Methodology - Milne Port Accommodation Facility

The new camp, sewage treatment plant and potable water treatment plant include a fire suppression system (sprinkler system) that will be connected to the fire pumps and tanks by insulated HDPE piping. Assembly and commissioning of the fire suppression systems and associated pumps and tanks will occur during the construction of the new camp.

Following the assembly and integration of the hardwall common core units of the new camp, the Camp Installation Contractor will start the installation and integration of the soft walled accommodation modules, starting from the north and progressing to the south. During this time, and following the sewage treatment plant and potable water treatment plant becoming operational, Baffinland Operations will coordinate the opportunity to populate the beds as they become available.

#### 4. Reference Documents

Document Identification	Document Title	Author
Site Plan (A1.10)	Milne Port New Accommodations Camp – Site Plan	Horizon North
H353004-40000-400-050-0001, Rev. 1	Construction Methodology – Camp Pad Water Diversion System	Hatch
H353004-2100-240-030-001, Rev. 0	Hatch - Milne Port Camp Pad Natural Stream Diversion – Hydrology & Hydraulic Calculations	Hatch

# Attachment 5 380-Person Camp – Supporting IFCs (Part 1 of 2)

Building Code Analys	sis (N.B.C.	DESIGN OCCUPANT LOAD:						
MAJOR OCCUPANCY: OTHER OCCUPANCIES:	3.1.17.1 DINING,BEVERAGE SPACE	AND CAFETERIA						
DESCRIPTION:	ART	ICLE:			PROVIDED:		462.08m <sup>2</sup> @ 1.20/m <sup>2</sup>	= 385 PERSONS
NUMBER OF STOREY(S): BUILDING ACCESS: TOTAL BUILDING AREA: SPRINKLERED: OCCUPANT LOAD: FIRE ALARM SYSTEM:	G ACCESS: - 3.2.2.10  UILDING AREA: - TABLE 3.2.2.25 <1,600m²  ERED: - 3.2.1.7 < 2,000 m²  NT LOAD: - TABLE 3.1.17.1				- 1,087.43 m² [ - N/A; NON-SPI		3.1.17.1 KITCHEN 63.51m <sup>2</sup> @ 9.30/m <sup>2</sup> 3.1.17.1 STORAGE 236.71m <sup>2</sup> @ 46.00/m <sup>2</sup> 3.1.17.1 VESTIBULE/ENTRY 93.10 m <sup>2</sup> @ 3.70/m <sup>2</sup>	= 7 PERSONS  = 5 PERSONS  LOBBY = 25 PERSONS
FIRE SEPARATIONS: RATINGS:					PROVIDED:		3.1.17.1 OFFICE	
BUILDING CONSTRUCTION: FLOOR ASSEMBLIES: MEZZANINES ASSEMBLIES: ROOF ASSEMBLIES: LOAD BEARING WALLS: MECHANICAL ROOM: EXIT STAIR: STORAGE ROOMS: JANITOR ROOM: SPATIAL SEPARATION & I		- COMBUSTIBLE & N/C CONST 3.2.2.25(2a) - 45MIN. FIRE RATED ASSEMBLY - 3.2.2.25(2b) - 45MIN. FIRE RATED ASSEMBLY - 3.2.2.25(2c) - 45MIN. FIRE RATED ASSEMBLY - 3.2.2.25(2d) - 45MIN. FIRE RATED ASSEMBLY - 3.6.2.1 - NOT LESS THAN 1HR. FIRE RATING - 3.4.4.1 - NOT LESS THAN 3/4HR. FIRE RATING - 3.3.4.3(2)- 1HR FIRE RATING - 3.3.1.21- NOT LESS THAN 3/4HR FIRE RATING		BLY BLY LY NG TING	- COMBUSTIBL - 1 HR FIRE RA - N/A - 1HR FIRE RA - 1 HR FIRE RA - 1 HR FIRE RA - 1HR FIRE RA - 1HR FIRE RAT	TING TING TING TING TING	3.1.17.1 OFFICE 83.37m² @ 9.30/m² = 9 P  3.1.17.1 OTHER USES MECHANICAL & ELECTRICAL R 24.63m² @ 46m² / PERSON = 1 F  TOTAL DESIGN OCCUPANT LOAD = 4  3.7.2.2 WATER CLOSET REQ'D:  FOR OVER 400 PERSONS (TABLE 3.7 AT LEAST 7 MALE WC. REQ'D A	
TABLE 3.2.3.1 B TABLE 3.2.3.7							13 FEMALE WC REQ'D	
EXPOSING WALL PROJECT NORTH	% U/O PERMITTED	% U/O ACTUAL	TYPE OF CONSTRUCTION REQUIRED	CLA	PE OF ADDING QUIRED	MINIMUM F.R.R.	PROVIDED: - 7 MALE WC. AT - 13 FEMALE WC BLDG	C. AT WASHROOM
NORTH WALL 44.59 m <sup>2</sup> SETBACK = 24.18 m	100%	4.37%	COMBUSTIBLE OR NONCOMBUSTIBLE	COMBUSTIBLE OR NONCOMBUSTIBLE		N/A	NUMBER OF EXITS: 3.4.2.1 (1) DINING	
SOUTH WALL 44.59 m <sup>2</sup> SETBACK = 30.81 m	100%	8.75%	COMBUSTIBLE OR NONCOMBUSTIBLE	COMBUSTIBLE OR NONCOMBUSTIBLE		N/A	2 EXITS REQ'D; 5 EXITS PR LOCATION OF EXITS:	OVIDED
EAST WALL 144.99 m <sup>2</sup> SETBACK = 9.70/2=4.85 m	30.71%	5.38%	COMBUSTIBLE OR NONCOMBUSTIBLE	NONCOMBUSTIBLE		45MIN. F.R.R.	3.4.2.5(1f) MAX TRAVEL DISTANCE	
WEST WALL 144.99 m <sup>2</sup> SETBACK = 9.75/2=4.87 m	30.85%	1.34%	COMBUSTIBLE OR NONCOMBUSTIBLE	NONCO	MBUSTIBLE	45MIN. F.R.R.		

Building Code And	alysis (N	.B.C 2015	): 50 UNITS DORM				DESIGN OCCUPANT LOAD:
MAJOR OCCUPANCY: OTHER OCCUPANCIES:	GROUP C, F	3.1.17.1 DWELLING UNITS 1 BEDROOM UNIT = 50 UNITS @ 1 PERSON					
DESCRIPTION:	А	RTICLE:			PROVIDED:		PER SLEEPING ROOM = 50 PERSONS
						FACING 1 STREET ,115,25ft²)< 600m²	3.1.17.1 OTHER USES  MECHANICAL & ELECTRICAL ROOM  13.76m² @ 46m² / PERSON = 1 PERSON  TOTAL DESIGN OCCUPANT LOAD = 51 PERSONS
-SPRINKLERED	-1	ION-SPR <b>I</b> NKLE	RED		-NON-SPRINI	(LERED	
FIRE SEPARATIONS:	R	AT <b>I</b> NGS:			PROVIDED:		3.7.2.2 WATER CLOSET REQ'D:
BUILDING CONSTRUCTION: FLOOR ASSEMBLIES: ROOF ASSEMBLIES: LOAD BEARING WALLS:		9.10.8.1 - NON-l 9.10.8.3 - NOT <	I. FIRE RATED ASSEMBLY RATED : THAT REQ'D FOR THE SL	JPPORTED	- 1HR F.R.R. -	BLE & N/C CONST.	3.7.2.2 (10) DWELLING UNIT  AT LEAST 1 WC. REQ'D FOR EACH 10  PERSON OF EACH SEX.
MECHANICAL ROOM: -9 EXIT STAIR: -9 STORAGE ROOMS: -9		FLOOR OR ROOF ASSEMBLY - 9.10.9.14(1) - 45MIN. FIRE RATED ASSEMBLY - 9.10.10.4 - NOT LESS THAN 1HR. FIRE RATING - 9.9.4.2 - 45MIN. FIRE RATED ASSEMBLY - 9.10.10.6 - NOT LESS 1HR FIRE RATING - 9.10.13.1(1) - NOT LESS THAN 20 MIN. F.R.R.			-1HR F.R.R. - 1HR F.R.R. - 1HR F.R.R. -1HR F.R.R. -1HR F.R.R. 20MIN. F.R.R.		PROVIDED: - 51 WC. WITH 26 URINALS AT WASHROOM BLDG  NUMBER OF EXITS:  9.9.7.4(1) DWELLING UNITS
NOISE PROTECTION: RATINGS:					PROVIDED:		2 EXITS REQ'D; 3 EXITS PROVIDED
CORRIDOR: - 9.11.2.1 (1) - NOT LESS THAN STC 50 DEMISING WALL: - 9.11.2.1 (1) - NOT LESS THAN STC 50				- STC 50 -STC 50		LOCATION OF EXITS:	
SPATIAL SEPARATION							9.9.8.2(c) MAX. TRAVEL DISTANCE REQ'D = 30m
OF ATTAL OLI ARATI	_	9.10.14.4.A	TABLE 9.10.14.5.A				ACTUAL TRAVEL DISTANCE = 23.91m
EXPOSING WALL PROJECT NORTH	% U/O PERMITT	% U/O	TYPE OF CONSTRUCTION REQUIRED	CLA	PE OF ADDING QUIRED	MINIMUM F.R.R.	
NORTH WALL 22.29 m <sup>2</sup> SETBACK = 11.86 m	100%	4.37%	COMBUSTIBLE OR NONCOMBUSTIBLE	COMBL	JSTIBLE OR MBUSTIBLE	N/A	
SOUTH WALL 22.29 m <sup>2</sup> ATTACHED TO CORRIDOR	N/A	N/A	COMBUSTIBLE OR NONCOMBUSTIBLE		JSTIBLE OR MBUSTIBLE	1HR. F.R.R.	
EAST WALL 148.64 m <sup>2</sup> SETBACK = 9.90/2=4.95 m	15.329	% 15.12%	COMBUSTIBLE OR NONCOMBUSTIBLE	NONCO	MBUSTIBLE	1HR. F.R.R.	
WEST WALL 148.64 m <sup>2</sup> SETBACK = 9.90/2=4.95 m	15.329	% 15.12%	COMBUSTIBLE OR NONCOMBUSTIBLE	NONCO	MBUSTIBLE	1HR. F.R.R.	

Building Code Ana	DESIGN OCCUPANT LOAD:						
MAJOR OCCUPANCY: GOTHER OCCUPANCIES:	ROUP C, F	RESIDENTIAL	OCCUPANCIES,DIV. B, PAR	RT 9, ART <b>I</b> CL	E 9.10.2.1		3.1.17.1 DWELLING UNITS 1 BEDROOM UNIT = 36 UNITS @ 1 PERSON
DESCRIPTION:	Al	RTICLE:			PROVIDED:		PER SLEEPING ROOM = 36 PERSONS
						FACING 1 STREET ,590.25ft²)< 600m²	3.1.17.1 OTHER USES  MECHANICAL & ELECTRICAL ROOM  13.76m² @ 46m² / PERSON = 1 PERSON
							TOTAL DESIGN OCCUPANT LOAD = 37 PERSONS
-SPRINKLERED	-N	ION-SPR <b>I</b> NKL	ERED		-NON-SPRIN	KLERED	3.7.2.2 WATER CLOSET REQ'D:
FIRE SEPARATIONS:	R/	ATINGS:			PROVIDED:		3.7.2.2 (10) DWELLING UNIT
BUILDING CONSTRUCTION: FLOOR ASSEMBLIES: ROOF ASSEMBLIES: LOAD BEARING WALLS:		- COMBUSTIBLE & N/C CONST 9.10.8.1 - 45MIN. FIRE RATED ASSEMBLY - 9.10.8.1 - NON-RATED - 9.10.8.3 - NOT < THAT REQ'D FOR THE SUPPORTED				BLE & N/C CONST.	AT LEAST 1 WC. REQ'D FOR EACH 10 PERSON OF EACH SEX.  PROVIDED: - 22 WC. WITH 12 URINALS AT
DEMISING WALL: MECHANICAL ROOM: EXIT STAIR:		FLOOR OR ROOF ASSEMBLY - 9.10.9.14(1) - 45MIN. FIRE RATED ASSEMBLY - 9.10.10.4 - NOT LESS THAN 1HR. FIRE RATING - 9.9.4.2 - 45MIN. FIRE RATED ASSEMBLY			-1HR F.R.R. - 1HR F.R.R. - 1HR F.R.R. -1HR F.R.R.		NUMBER OF EXITS:
		- 9.10.10.6 - NOT LESS 1HR FIRE RATING - 9.10.13.1(1) - NOT LESS THAN 20 MIN. F.R.R.			-1HR F.R.R. 20MIN. F.R.R.		9.9.7.4(1) DWELLING UNITS  2 EXITS REQ'D; 3 EXITS PROVIDED
NOISE PROTECTION: RATINGS:					PROVIDED:		
CORRIDOR: - 9.11.2.1 (1) - NOT LESS THAN STC 50 DEMISING WALL: - 9.11.2.1 (1) - NOT LESS THAN STC 50				- STC 50 -STC 50		LOCATION OF EXITS:  9.9.8.2(c) MAX. TRAVEL DISTANCE REQ'D = 30m	
SPATIAL SEPARATION	ON & EXI	POSURE P	ROTECTION:				ACTUAL TRAVEL DISTANCE = 20.16m
	TABLE	9.10.14.4.A	TABLE 9.10.14.5.A				
EXPOSING WALL PROJECT NORTH	% U/O PERMITTI		TYPE OF CONSTRUCTION REQUIRED	CLA	PE OF ADDING QUIRED	MINIMUM F.R.R.	
NORTH WALL 22.29 m <sup>2</sup> SETBACK = 6.09/2=3.04 m	26.11%	% 8.75%	COMBUSTIBLE OR NONCOMBUSTIBLE	NONCO	MBUSTIBLE	45MIN. F.R.R.	
SOUTH WALL 22.29 m <sup>2</sup> ATTACHED TO CORRIDOR	N/A	N/A	COMBUSTIBLE OR NONCOMBUSTIBLE	1	STIBLE OR MBUSTIBLE	1HR. F.R.R.	
EAST WALL 111.11 m <sup>2</sup> SETBACK = 9.90/2=4.95 m	15.0%	15.0%	COMBUSTIBLE OR NONCOMBUSTIBLE	NONCO	MBUSTIBLE	1HR. F.R.R.	
WEST WALL			COMBUSTIBLE OR	None	MBUSTIBLE	1HR. F.R.R.	

Building Code Ana	DESIGN OCCUPANT LOAD:						
MAJOR OCCUPANCY: OTHER OCCUPANCIES:	3.1.17.1 DWELLING UNITS 1 W.C.'S UNIT = 22 UNITS @ 1 PERSON						
DESCRIPTION:	А	RTICLE:			PROVIDED:		PER W.C. = 22 PERSONS
						FACING 1 STREET ,528.04ft²)< 600m²	TOTAL DESIGN OCCUPANT LOAD = 22 PERSONS
-SPRINKLERED -NON-SPRINKLERED -						KLERED	NUMBER OF EXITS:
FIRE SEPARATIONS:	R	ATINGS:			PROVIDED:		9.9.7.4(1) DWELLING UNITS
BUILDING CONSTRUCTION:  FLOOR ASSEMBLIES:  ROOF ASSEMBLIES:  LOAD BEARING WALLS:  - COMBUSTIBLE & N/C CONST.  - 9.10.8.1 - 45MIN. FIRE RATED ASSEMBLY  - 9.10.8.1 - NON-RATED  - 9.10.8.3 - NOT < THAT REQ'D FOR THE SUPPORTED				JPPORTED	- COMBUSTIBLE & N/C CONST. - 1HR F.R.R.		2 EXITS REQ'D; 2 EXITS PROVIDED  LOCATION OF EXITS:
		FLO	OR OR ROOF ASSEMBLY		-1HR F.R.R. - 1HR F.R.R.		9.9.8.2(c) MAX. TRAVEL DISTANCE REQ'D = 30m
DEMISING WALL: MECHANICAL ROOM: EXIT STAIR: STORAGE ROOMS: TWENTY-MINUTE CLOSURES		- 9.10.9.14(1) - 45MIN. FIRE RATED ASSEMBLY - 9.10.10.4 - NOT LESS THAN 1HR. FIRE RATING - 9.9.4.2 - 45MIN. FIRE RATED ASSEMBLY - 9.10.10.6 - NOT LESS 1HR FIRE RATING - 9.10.13.1(1) - NOT LESS THAN 20 MIN. F.R.R.			- 1HR F.R.R. - 1HR F.R.R. -1HR F.R.R. -1HR F.R.R. 20MIN. F.R.R.		ACTUAL TRAVEL DISTANCE = 28.14m
NOISE PROTECTION:	R	ATINGS:			PROVIDED:		
CORRIDOR: - 9.11.2.1 (1) - NOT LESS THAN STC 50			- STC 50				
SPATIAL SEPARATION	ON & EX	POSURE P	ROTECTION:				
	TABLE	9.10.14.4.A	TABLE 9.10.14.5.A				
EXPOSING WALL PROJECT NORTH	% U/O PERMITT		TYPE OF CONSTRUCTION REQUIRED	CLA	PE OF DDING UIRED	MINIMUM F.R.R.	
NORTH WALL 22.05 m <sup>2</sup> ATTACHED TO CORRIDOR	N/A	N/A	COMBUSTIBLE OR NONCOMBUSTIBLE	1	STIBLE OR MBUSTIBLE	1HR. F.R.R.	
SOUTH WALL 22.05 m <sup>2</sup> SETBACK =22.53 m	100%	0%	COMBUSTIBLE OR NONCOMBUSTIBLE		STIBLE OR MBUSTIBLE	N/A	
EAST WALL 38.28 m <sup>2</sup> SETBACK = 28.78/2=14.39 m	100%	5 0%	COMBUSTIBLE OR NONCOMBUSTIBLE		STIBLE OR MBUSTIBLE	N/A	
WEST WALL 38.28 m <sup>2</sup>	66.60°	% 0%	COMBUSTIBLE OR	NONCO	MBUST <b>I</b> BLE	45MIN. F.R.R.	

Building Code Ana	aiysis (N.B.	DESIGN OCCUPANT LOAD:					
MAJOR OCCUPANCY: OTHER OCCUPANCIES:	GROUP C, RES	3.1.17.1 DWELLING UNITS 1 W.C.'S UNIT = 13 UNITS @ 1 PERSON					
DESCRIPTION:	ARTI	ARTICLE:					PER W.C. = 13 PERSONS
NUMBER OF STOREY(S): TOTAL BUILDING AREA:					FACING 1 STREET 1,430.49ft²)< 600m²	TOTAL DESIGN OCCUPANT LOAD = 13 PERSONS	
-SPRINKLERED -NON-SPRINKLERED					-NON-SPRIN	KLERED	NUMBER OF EXITS:
FIRE SEPARATIONS:	RATII	RATINGS:			PROVIDED:		9.9.7.4(1) DWELLING UNITS
	LOOR ASSEMBLIES: OOF ASSEMBLIES: OAD BEARING WALLS: EMISING WALL: ECHANICAL ROOM: XIT STAIR:  - 9.10.8.1 - 45MIN. FIRE RATED ASSEMBLY - 9.10.8.3 - NOT < THAT REQ'D FOR THE SUPPORTED FLOOR OR ROOF ASSEMBLY - 9.10.9.14(1) - 45MIN. FIRE RATED ASSEMBLY - 9.10.10.4 - NOT LESS THAN 1HR. FIRE RATING - 9.9.4.2 - 45MIN. FIRE RATED ASSEMBLY		- 1HR F.R.R. -1HR F.R.R. - 1HR F.R.R. - 1HR F.R.R. -1HR F.R.R. -1HR F.R.R. 20MIN. F.R.R	BLE & N/C CONST.	2 EXITS REQ'D; 2 EXITS PROVIDED  LOCATION OF EXITS:  9.9.8.2(c) MAX. TRAVEL DISTANCE REQ'D = 30m  ACTUAL TRAVEL DISTANCE = 24.36m		
NOISE PROTECTION:	RATII	NGS:			PROVIDED:		
CORRIDOR:	- 9.11.2.1 (1) - NOT LESS THAN STC 50			- STC 50		HATCH	
SPATIAL SEPARATION	ON & EXPO	SURE PR	OTECTION:				Doc Number E38
	TABLE 9.10.14.4.A TABLE 9.10.14.5.A						Date Received
EXPOSING WALL PROJECT NORTH	% U/O PERMITTED	% U/O ACTUAL	TYPE OF CONSTRUCTION REQUIRED	CLAI	PE OF DD <b>I</b> NG UIRED	MINIMUM F.R.R.	Rev  C1 - Proceed to r  C2 - Proceed with
NORTH WALL 20.38 m <sup>2</sup> ATTACHED TO CORRIDOR	N/A	N/A	COMBUSTIBLE OR NONCOMBUSTIBLE	COMBU	STIBLE OR MBUSTIBLE	1HR. F.R.R.	next submis  C3 - Do not proceresubmit  Next Submittal Date:

COMBUSTIBLE OR NONCOMBUSTIBLE

COMBUSTIBLE OR NONCOMBUSTIBLE

COMBUSTIBLE OR NONCOMBUSTIBLE

N/A

N/A

COMBUSTIBLE OR NONCOMBUSTIBLE

COMBUSTIBLE OR NONCOMBUSTIBLE

COMBUSTIBLE OR

NONCOMBUSTIBLE

20.38 m<sup>2</sup>

39.76 m<sup>2</sup> SETBACK = 29.44/2=14.72 m

WEST WALL

SETBACK = 28.78/2=14.39 m

38.27 m<sup>2</sup>

SETBACK =22.63 m EAST WALL 100%

100%

w Grade  xt submission & status exceptions as noted to pn & status d. Revise as noted &	Next Submittal Statu ☐ Certified ☐ As-Built					
xt submission & status exceptions as noted to on & status	Certified					
exceptions as noted to on & status						
on & status	☐ As-Built					
d Revise as noted &						
a. Novice de noted d	☐Internal Review					
	☐Certified/☐As-Bu					
No further submission required - Complete (select status below)     □ Certified Final □ Final □ Cancelled □ Superseded						
Package Engineer: Name, signature and date						
	nal 🗌 Final 🔲 Cance					

Sheet 1 of 4

Building Code Ana	DESIGN OCCUPANT LO							
OTHER OCCUPANCIES:	T							18 UNITS @ 1 PERSON PER W.C.
DESCRIPTION:	ART	ICLE:			PROVIDED:			= 18 PERSONS
NUMBER OF STOREY(S): TOTAL BUILDING AREA:		.3.3(1) - 3 STC .3.3(1) - 600m	DREY MAXIMUM <sup>2</sup> MAXIMUM			FACING 1 STREET 1,543.41t²)< 600m²	TOTAL DESIGN OCCU	PANT LOAD = 18 PERSONS
-SPRINKLERED -NON-SPRINKLERED -						KLERED	NUMBER OF EXITS:	
FIRE SEPARATIONS:	RAT	INGS:			PROVIDED:		9.9.7.4(1) DWELLING U	NITS
BUILDING CONSTRUCTION:	I		& N/C CONST.		l	BLE & N/C CONST.	2 EXITS REQ'D; 2 EXI	TS PROVIDED
ROOF ASSEMBLIES: - 9.10.8.1 - NON-RATED -				- 1HR F.R.R.   -		LOCATION OF EXITS:		
LOAD BEARING WALLS:		FLOOF	THAT REQ'D FOR THE SU R OR ROOF ASSEMBLY		-1HR F.R.R.		9.9.8.2(c) MAX. TRAVE	L DISTANCE REQ'D = 30m
MECHANICAL ROOM: - 9.10.10.4 - NOT LESS THAN 1HR. FIRE RATING EXIT STAIR: - 9.9.4.2 - 45MIN. FIRE RATED ASSEMBLY			- 1HR F.R.R. - 1HR F.R.R. -1HR F.R.R. -1HR F.R.R. 20MIN. F.R.R.		ACTUAL TRAVEL DIST.	ANCE = 20.89m		
NOISE PROTECTION: RATINGS:				PROVIDED:				
CORRIDOR: - 9.11.2.1 (1) - NOT LESS THAN STC 50			- STC 50					
SPATIAL SEPARATION	ON & EXP	SURE PR	OTECTION:					
	TABLE 9.	10.14.4.A	TABLE 9.10.14.5.A					
EXPOSING WALL PROJECT NORTH	% U/O PERMITTED	% U/O ACTUAL	TYPE OF CONSTRUCTION REQUIRED	CLA	PE OF ADDING QUIRED	MINIMUM F.R.R.		
NORTH WALL 22.05 m <sup>2</sup> ATTACHED TO CORRIDOR	N/A	N/A	COMBUSTIBLE OR NONCOMBUSTIBLE		JSTIBLE OR MBUSTIBLE	1HR. F.R.R.		
SOUTH WALL 22.05 m <sup>2</sup> SETBACK =22.68 m	100%	0%	COMBUSTIBLE OR NONCOMBUSTIBLE		JSTIBLE OR MBUSTIBLE	N/A		
EAST WALL 39.76 m <sup>2</sup> SETBACK = 76.96 m	100%	0.65%	COMBUSTIBLE OR NONCOMBUSTIBLE		JSTIBLE OR MBUSTIBLE	N/A		
WEST WALL 38.27 m <sup>2</sup> SETBACK = 29.44/2=14.72 m	100%	0%	COMBUSTIBLE OR NONCOMBUSTIBLE		JSTIBLE OR MBUSTIBLE	N/A		



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No.	Description	Date
1.	ISSUED FOR BUILDING PERMIT	2018-11-27
ONTRACT	OR	

SEAL



CLIENT

### Horizon North

DRAWN BY:	JC
CHECKED BY:	C.M. VALIENTE
ENGINEER:	JOHN LEHNERS, P. ENG.
PROJECT No.:	170109
SHEET ISSUE DATE:	NOVEMBER 27 2018
PROJECT STATUS:	FOR BUILDING PERMIT

PROJECT

### Baffinland Iron Mines


DESCRIPTION

### Code Compliance Summary

DRAWING NO.

A1.00



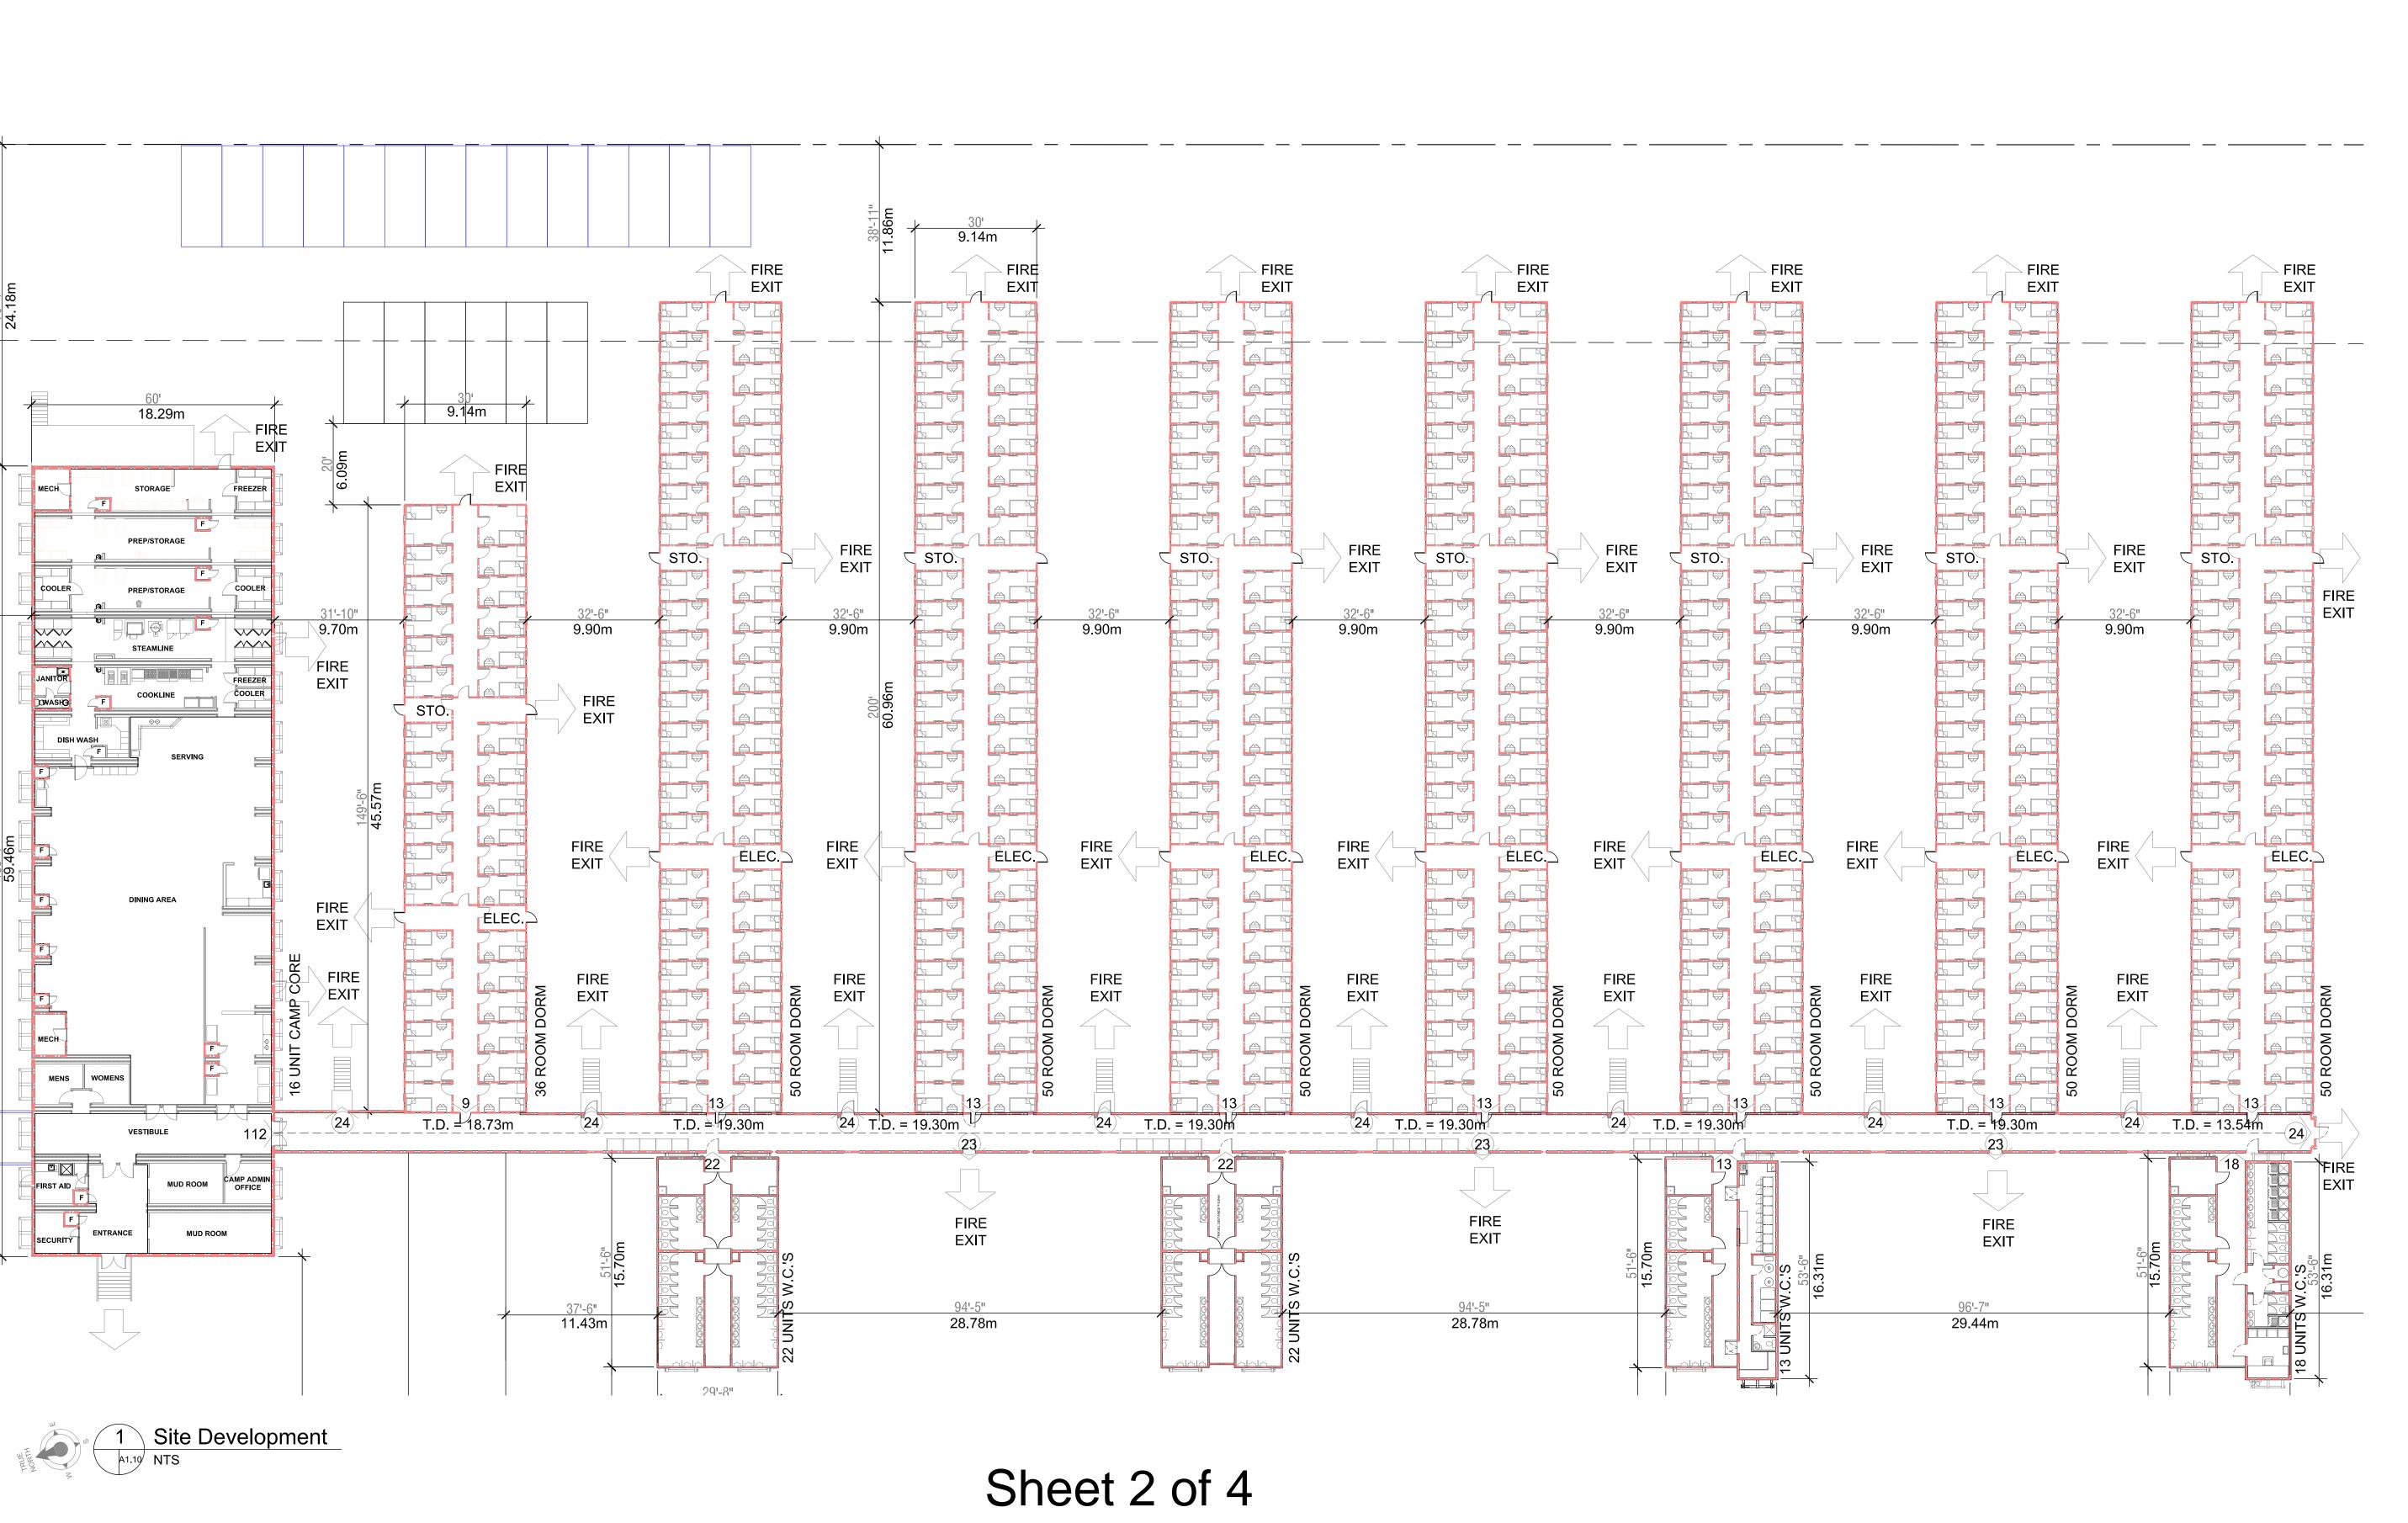



LEGEND

1HR. FIRE RATED ASSEMBLY

OCCUPANT LOAD AT OPENING

COMMON PATH OF EGRESS TRAVEL

CUMMULATIVE OCCUPANT LOAD AT OPENING

**BUILDING EXIT** 

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2018-11-27

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### Horizon North

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ENGINEER:	JOHN LEHNERS, P. ENG.
PROJECT No.:	170109
SHEET ISSUE DATE:	NOVEMBER 27, 2018
PROJECT STATUS:	FOR BUILDING PERMIT

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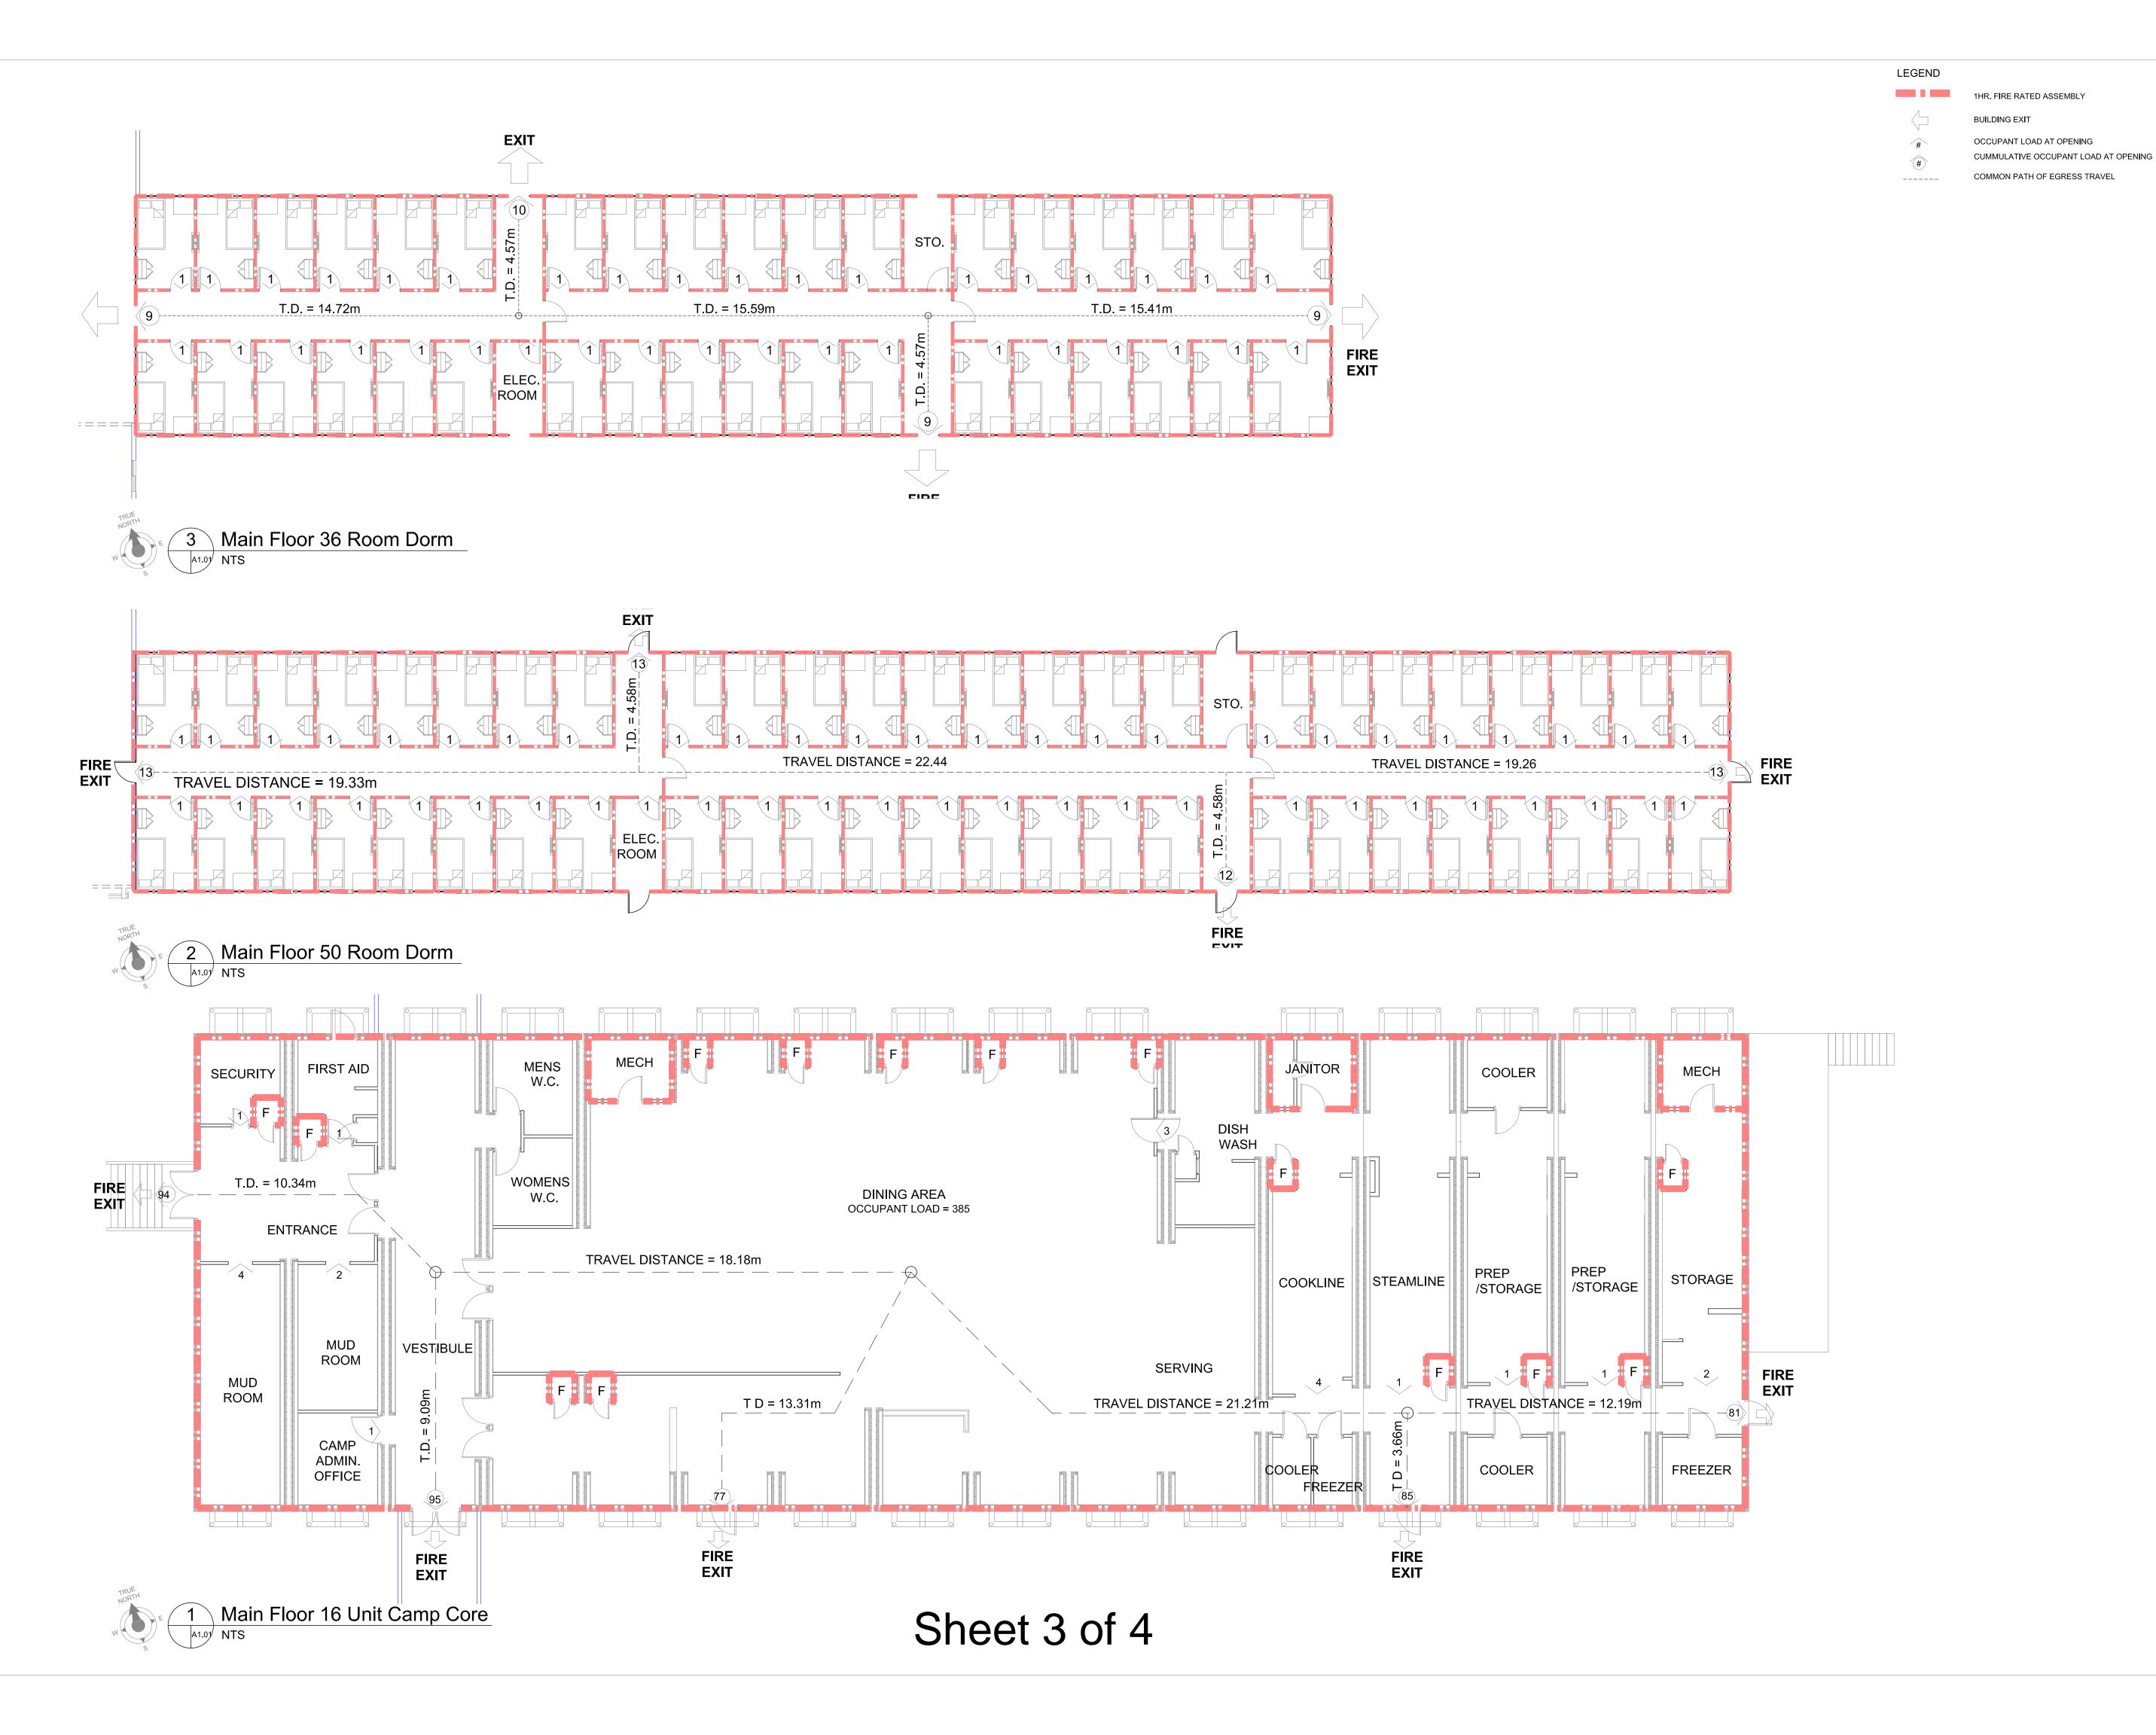
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DESCRIPTION

Code Compliance Summary

A1.01







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### Horizon North

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	ENGINEER:	JOHN LEHNERS, P. ENG.
	PROJECT No.:	170109
	SHEET ISSUE DATE:	NOVEMBER 27, 2018
	PROJECT STATUS:	FOR BUILDING PERMIT

PROJECT


### Baffinland Iron Mines

DESCRIPTION

Code Compliance Summary

A1.02

SHEET 3

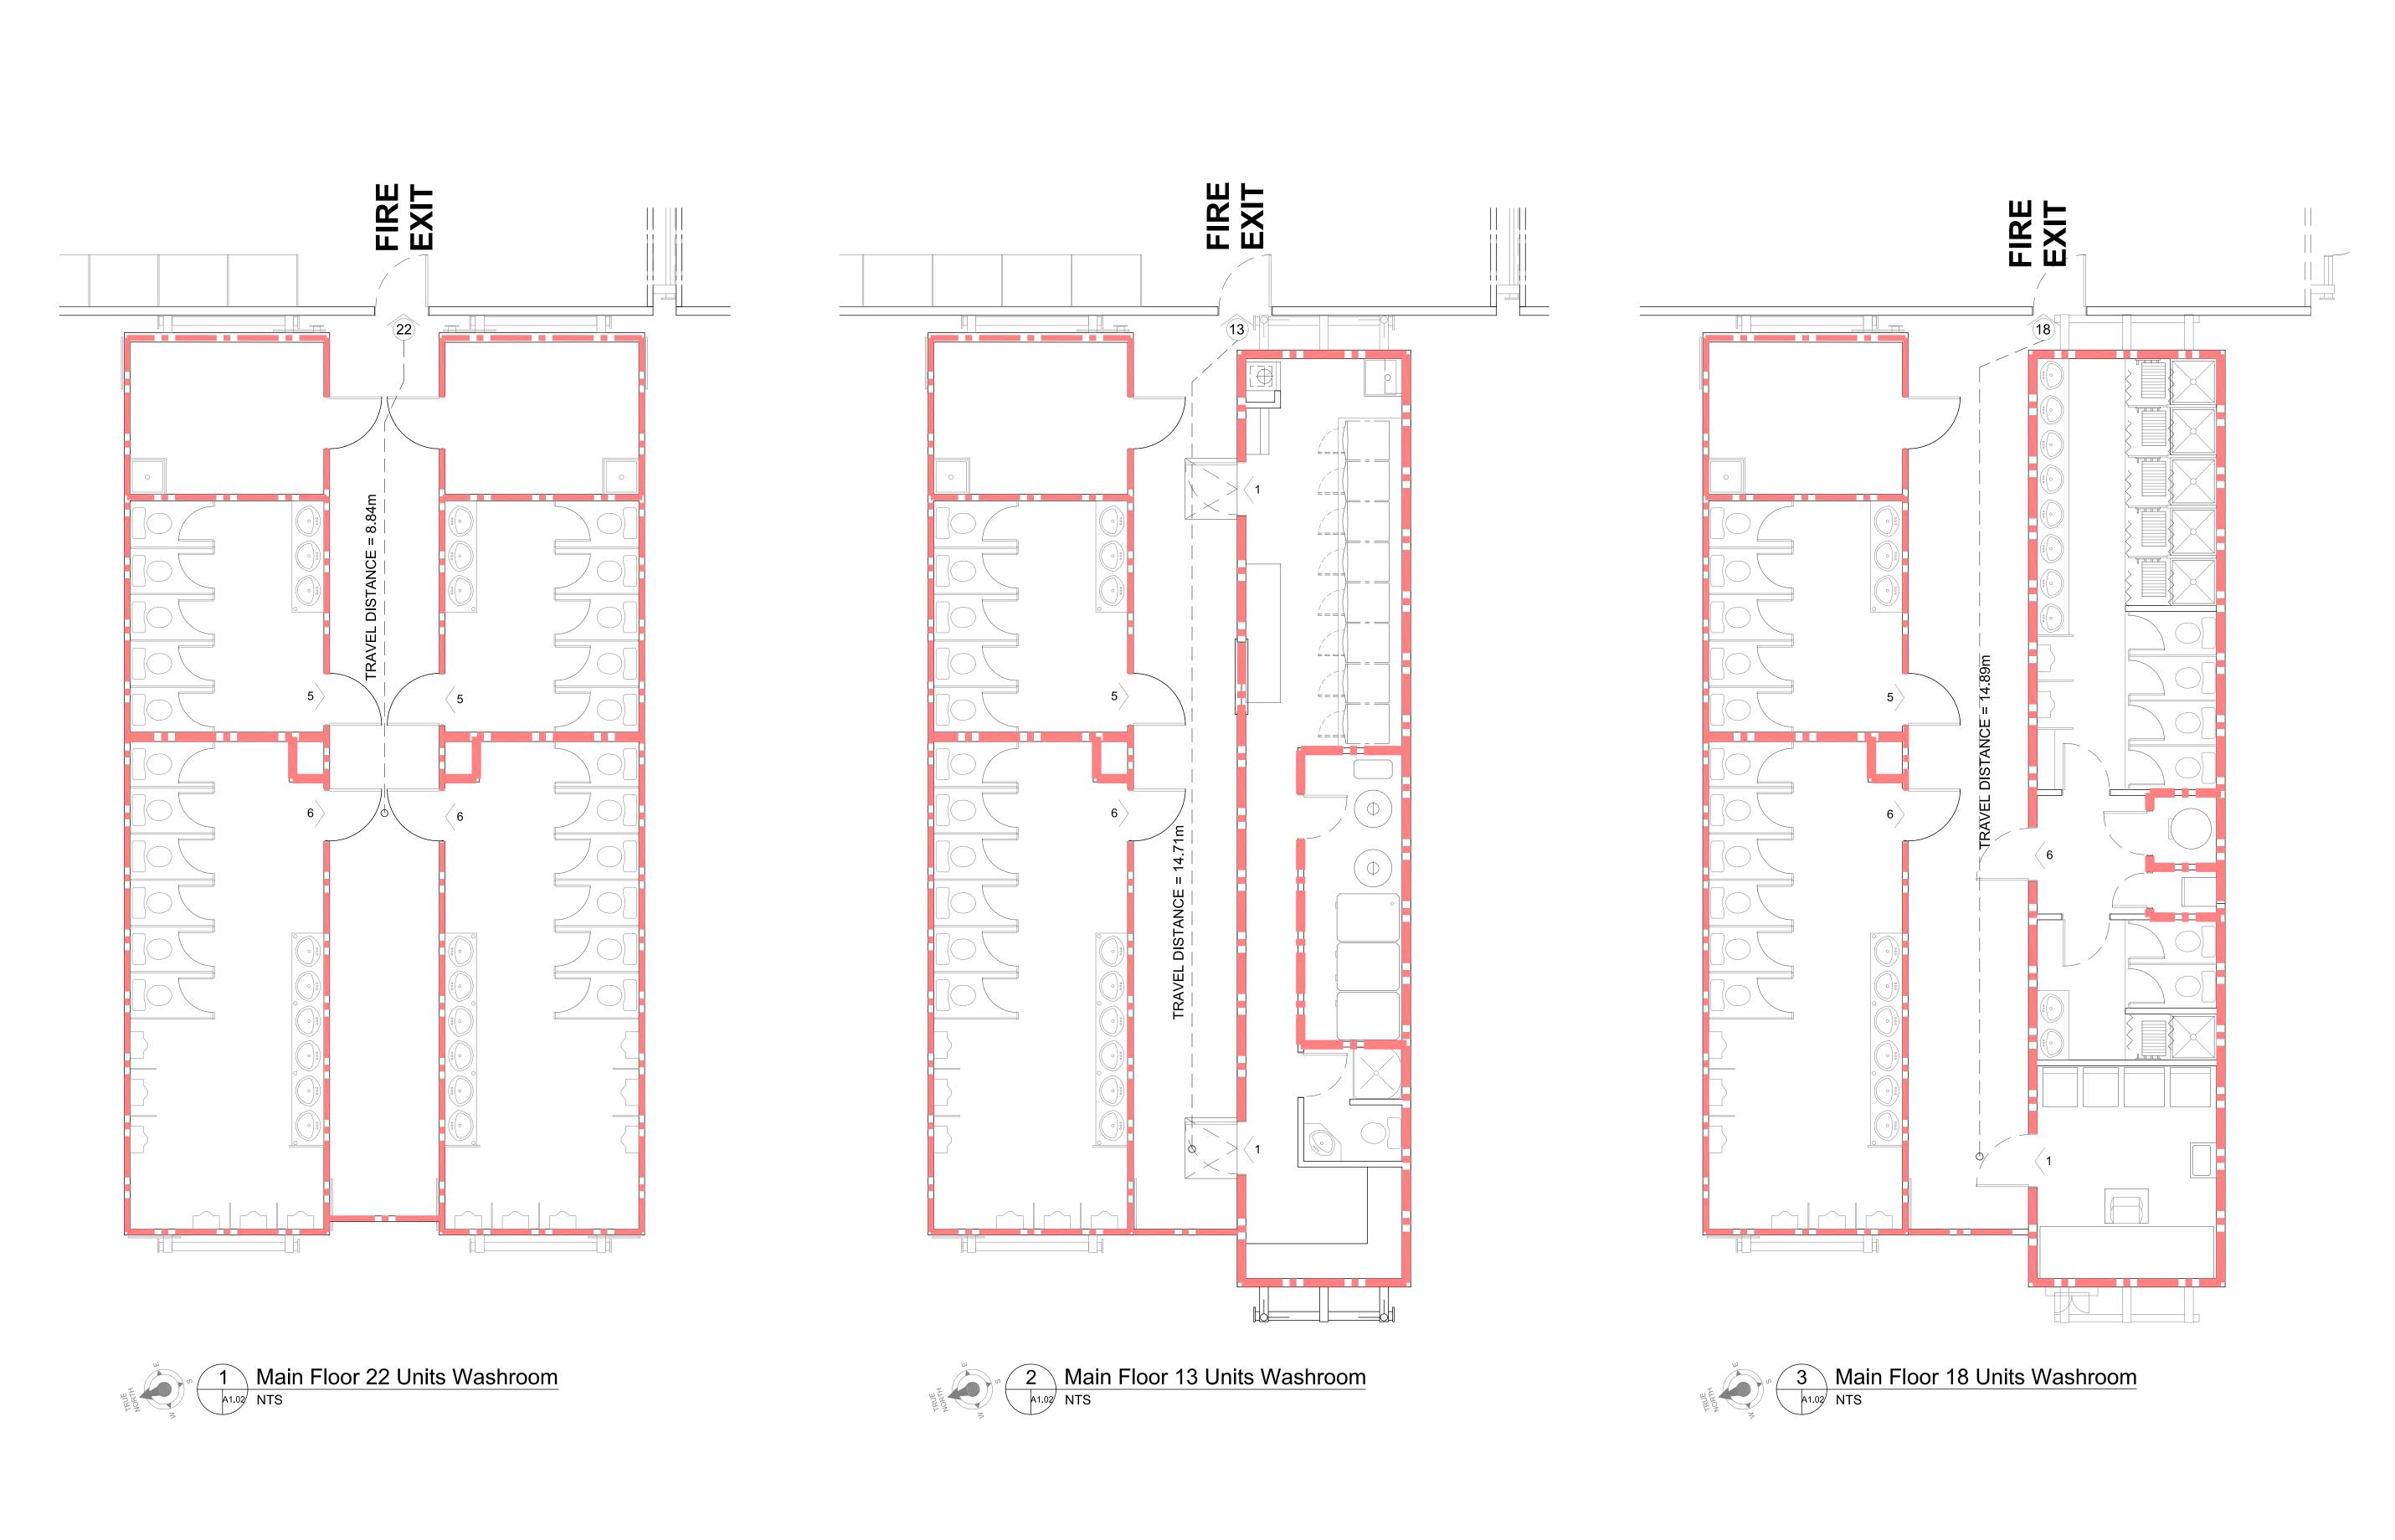

Sheet 4 of 4

LEGEND

1HR. FIRE RATED ASSEMBLY

OCCUPANT LOAD AT OPENING

COMMON PATH OF EGRESS TRAVEL

CUMMULATIVE OCCUPANT LOAD AT OPENING

BUILDING EXIT

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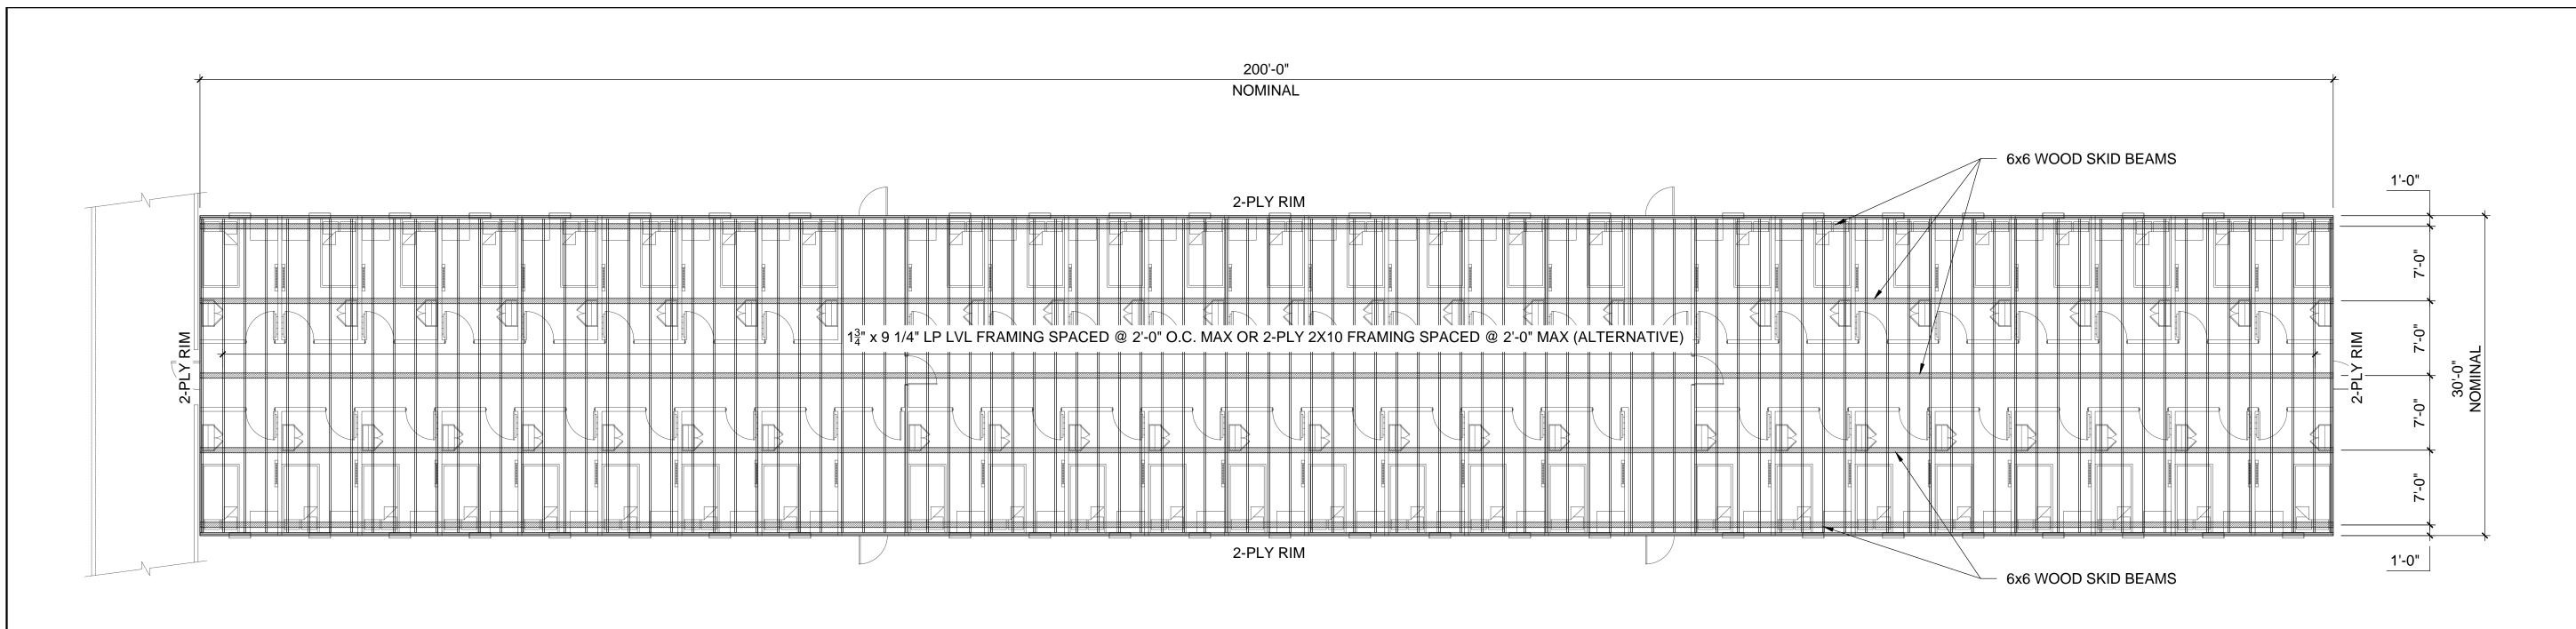
### Horizon North

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CHECKED BY:	C.M. VALIENTE
ENGINEER:	JOHN LEHNERS, P. ENG.
PROJECT No.:	170109
SHEET ISSUE DATE:	NOVEMBER 27, 2018
PROJECT STATUS:	FOR BUILDING PERMIT

### Baffinland Iron Mines


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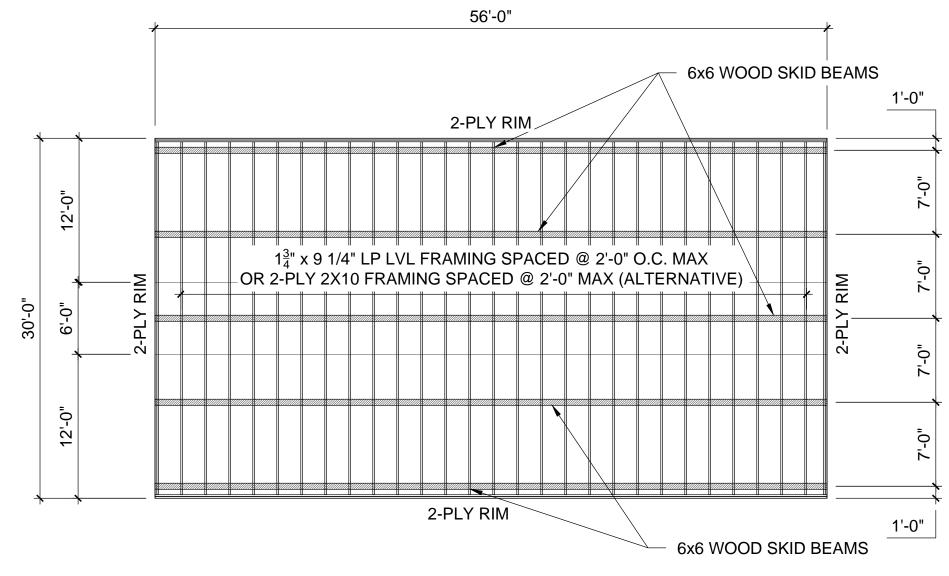
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#### 50 PERSON PER COMPLEX FRAMING PLAN

SCALE : 1/8"=1'-0" AREA = 6000 SF (558 SM)





### CHANGING ROOM FRAMING PLAN

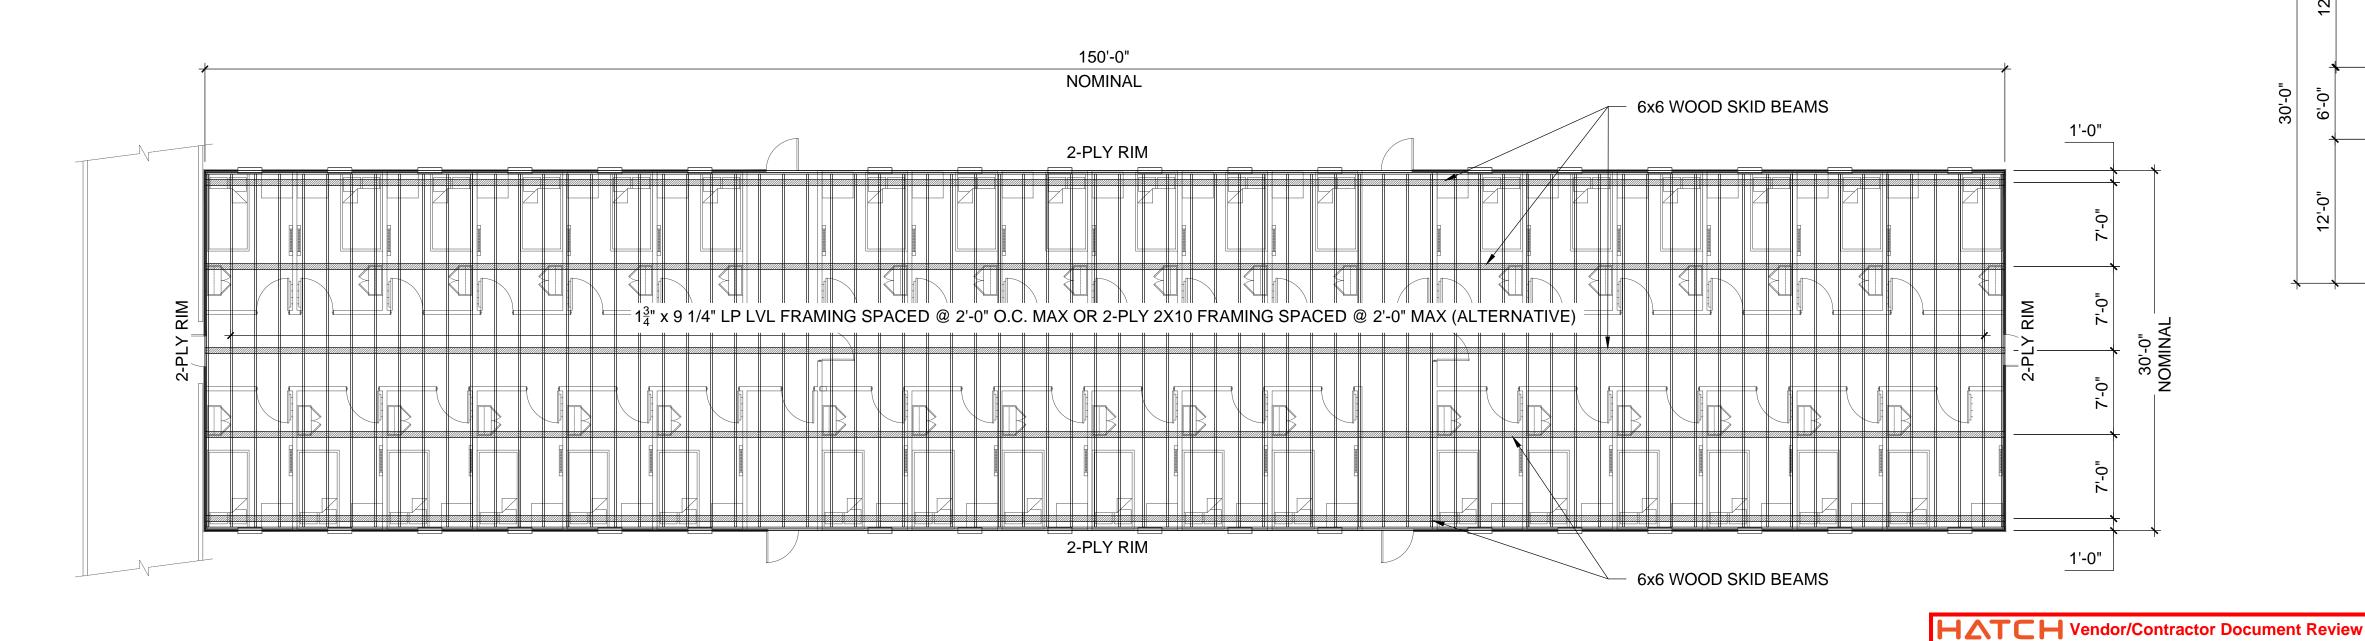SCALE : 1/8"=1'-0" AREA = 1680 SF (156 SM)

### ROOF DESIGN LOADS

DEAD LOAD	10 PSF
SNOW LOAD	74.4 PSF

### FLOOR DESIGN LOADS

DEAD LOAD	20 PSF
FLOOR LOAD	40 PSF

### 36 PERSON PER COMPLEX FRAMING PLAN

SCALE : 1/8"=1'-0" AREA = 4500 SF (418 SM)

Sheet 1 of 3

Date Received		
F	Review Grade	Next Submittal Status
C2 - Proceed	to next submission & status with exceptions as noted to mission & status	☐ Certified ☐ As-Built
C3 - Do not presubmit	roceed. Revise as noted &	☐Internal Review
Next Submittal Da	ate:	☐Certified/☐As-Built
•	er submission required - Complet ied Final ☐ Final ☐ Cance	
Package Enginee	r: Name, signature and date	latolety dec 6, 20,
warrant or represent tha	ral conformity with the specifications. Accept at the information contained on this drawing/o ponsibilty for correct design, details & dimen wing/document.	locument is either accurate or
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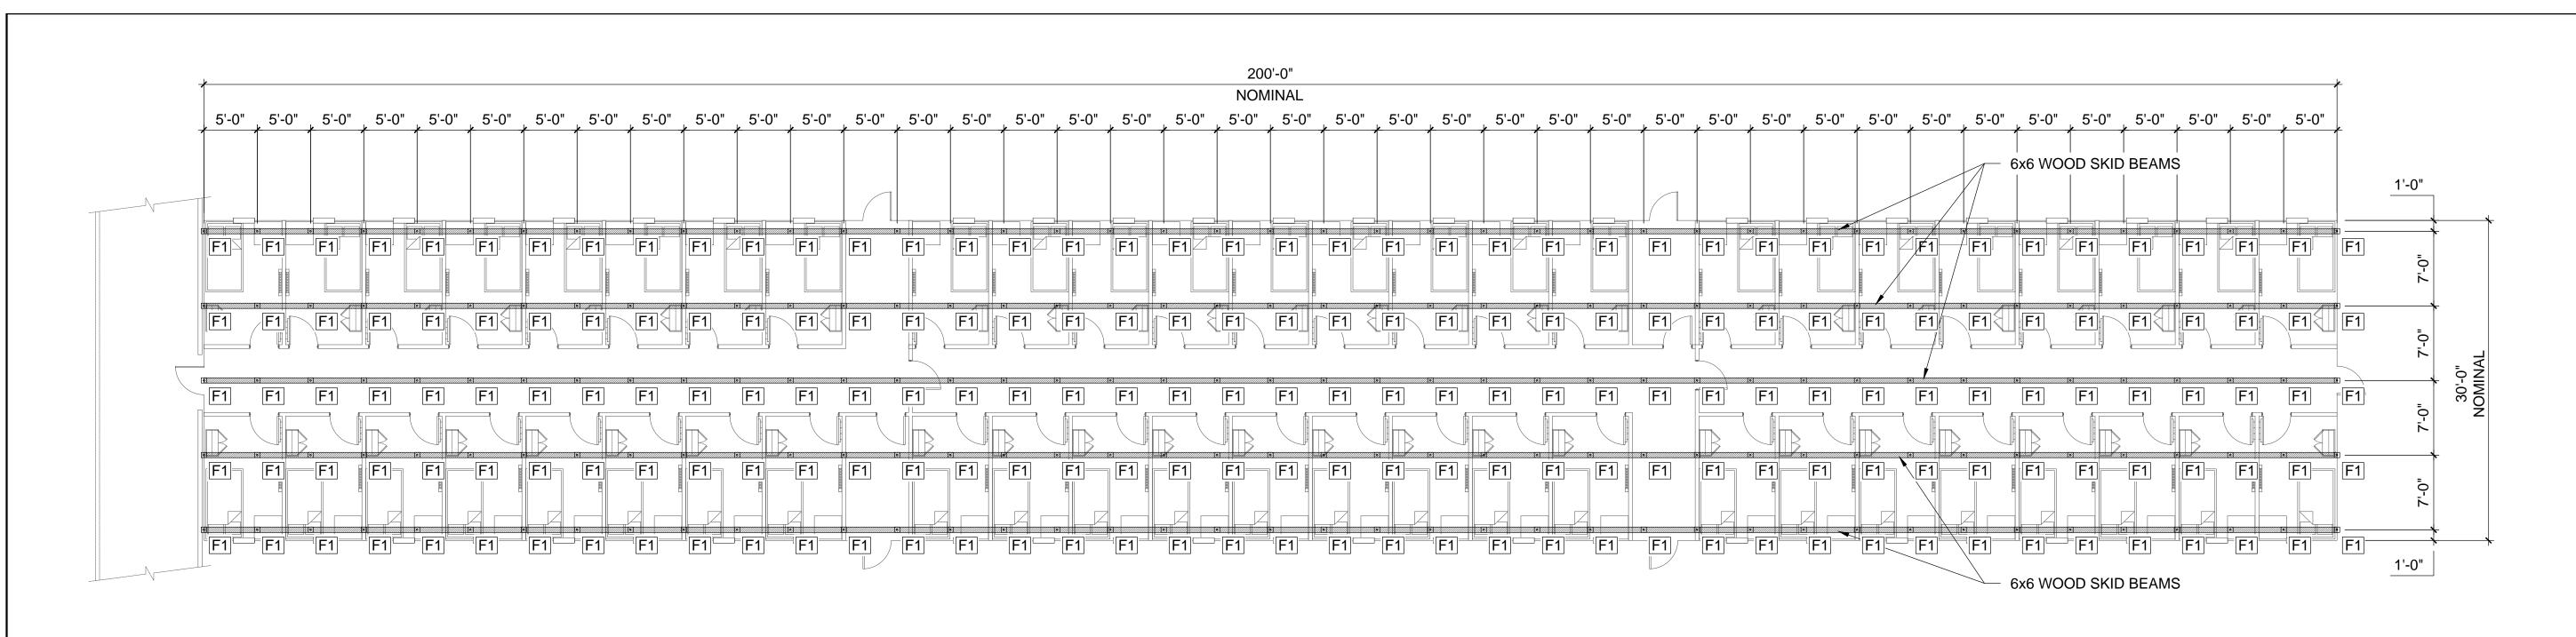
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SCALE : AS	SHOWN	
DRAWN BY :	NG	
CHECKED:	JL	

# BAFFINLAND IRON MINES


DORM COMPLEX AND CHANGING ROOM
BAFFINLAND
FRAMING PLAN


SF-001



#### 50 PERSON PER COMPLEX FOUNDATION PLAN

SCALE : 1/8"=1'-0" AREA = 6000 SF (558 SM)

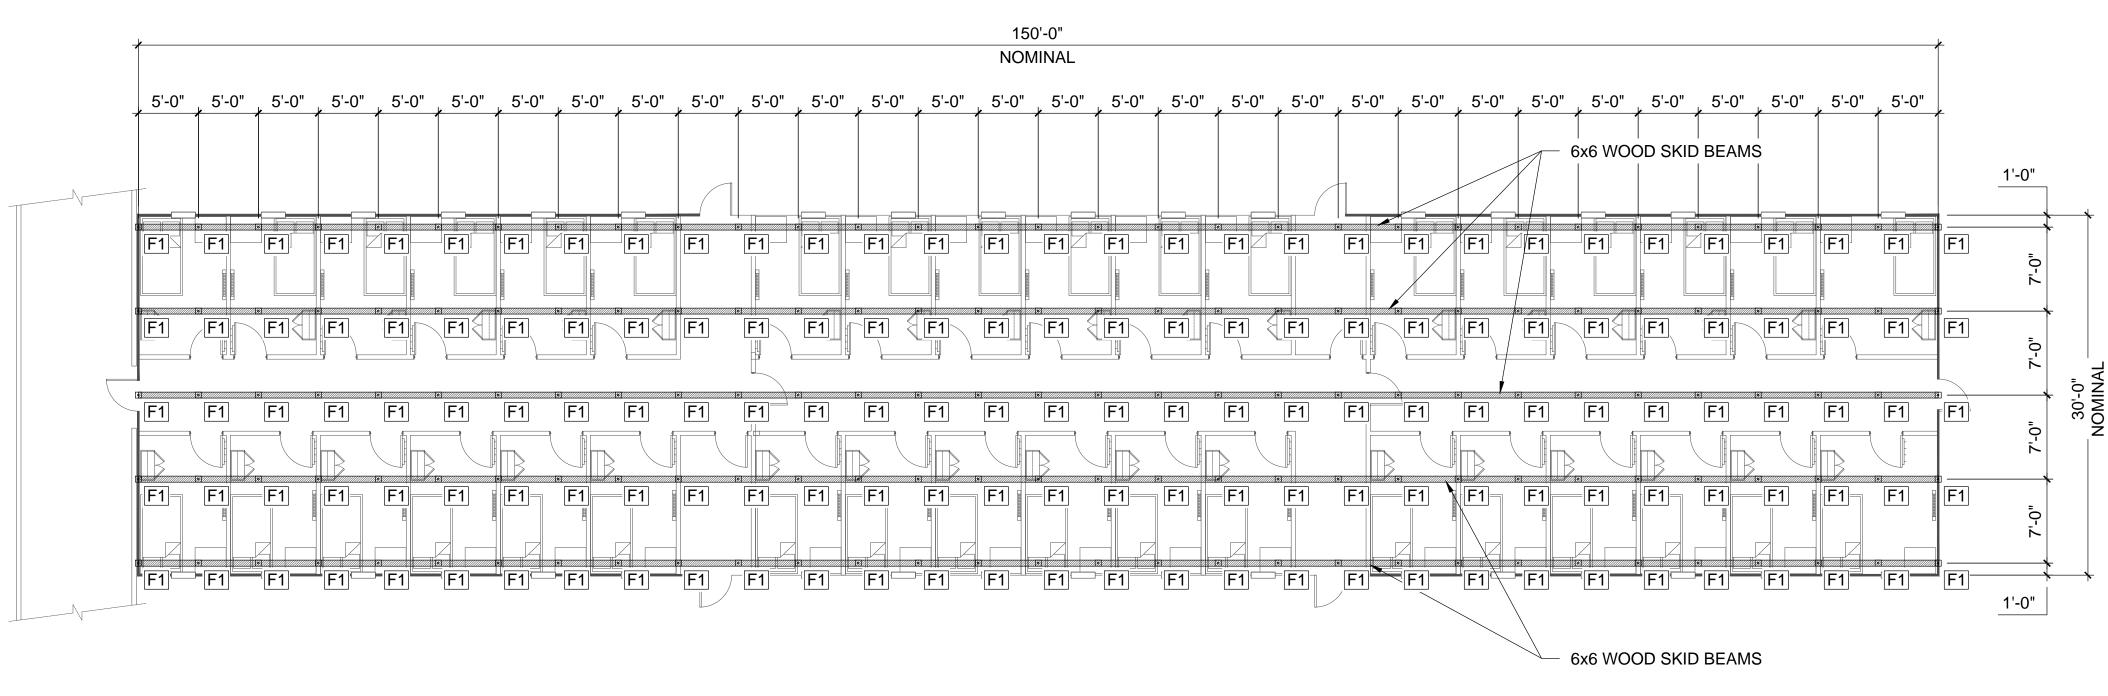

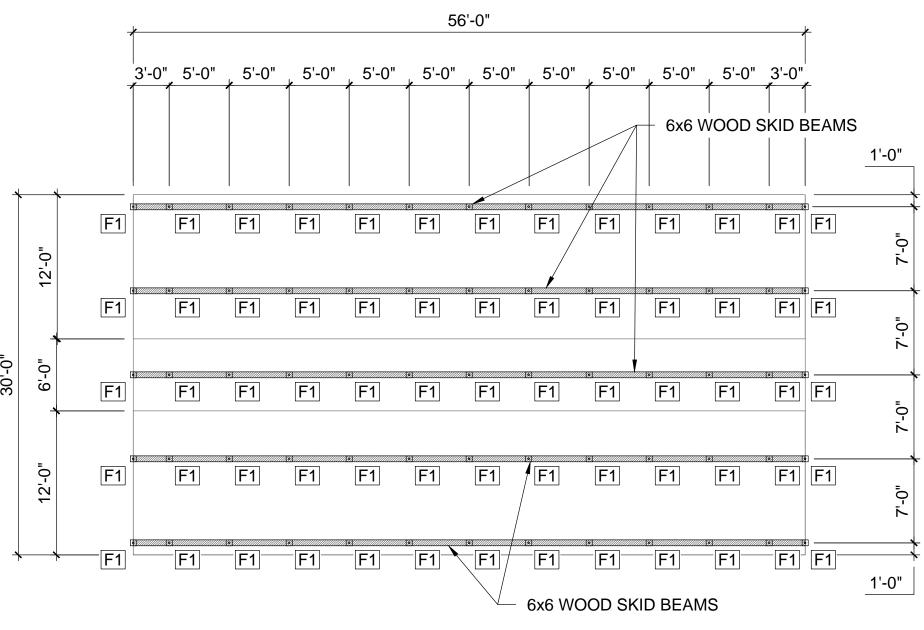

### CHANGING ROOM FOUNDATION PLAN

SCALE : 1/8"=1'-0" AREA = 1680 SF (156 SM)

#### 36 PERSON PER COMPLEX FOUNDATION PLAN

SCALE: 1/8"=1'-0" AREA = 4500 SF (418 SM)

Sheet 2 of 3

#### FOUNDATION SCHEDULE:

MARK	TYPE
F1	2 LAYERS OF 6X6 UNTREATED BLOCKING ON 1" MINUS GRAVEL ON BEDROCK

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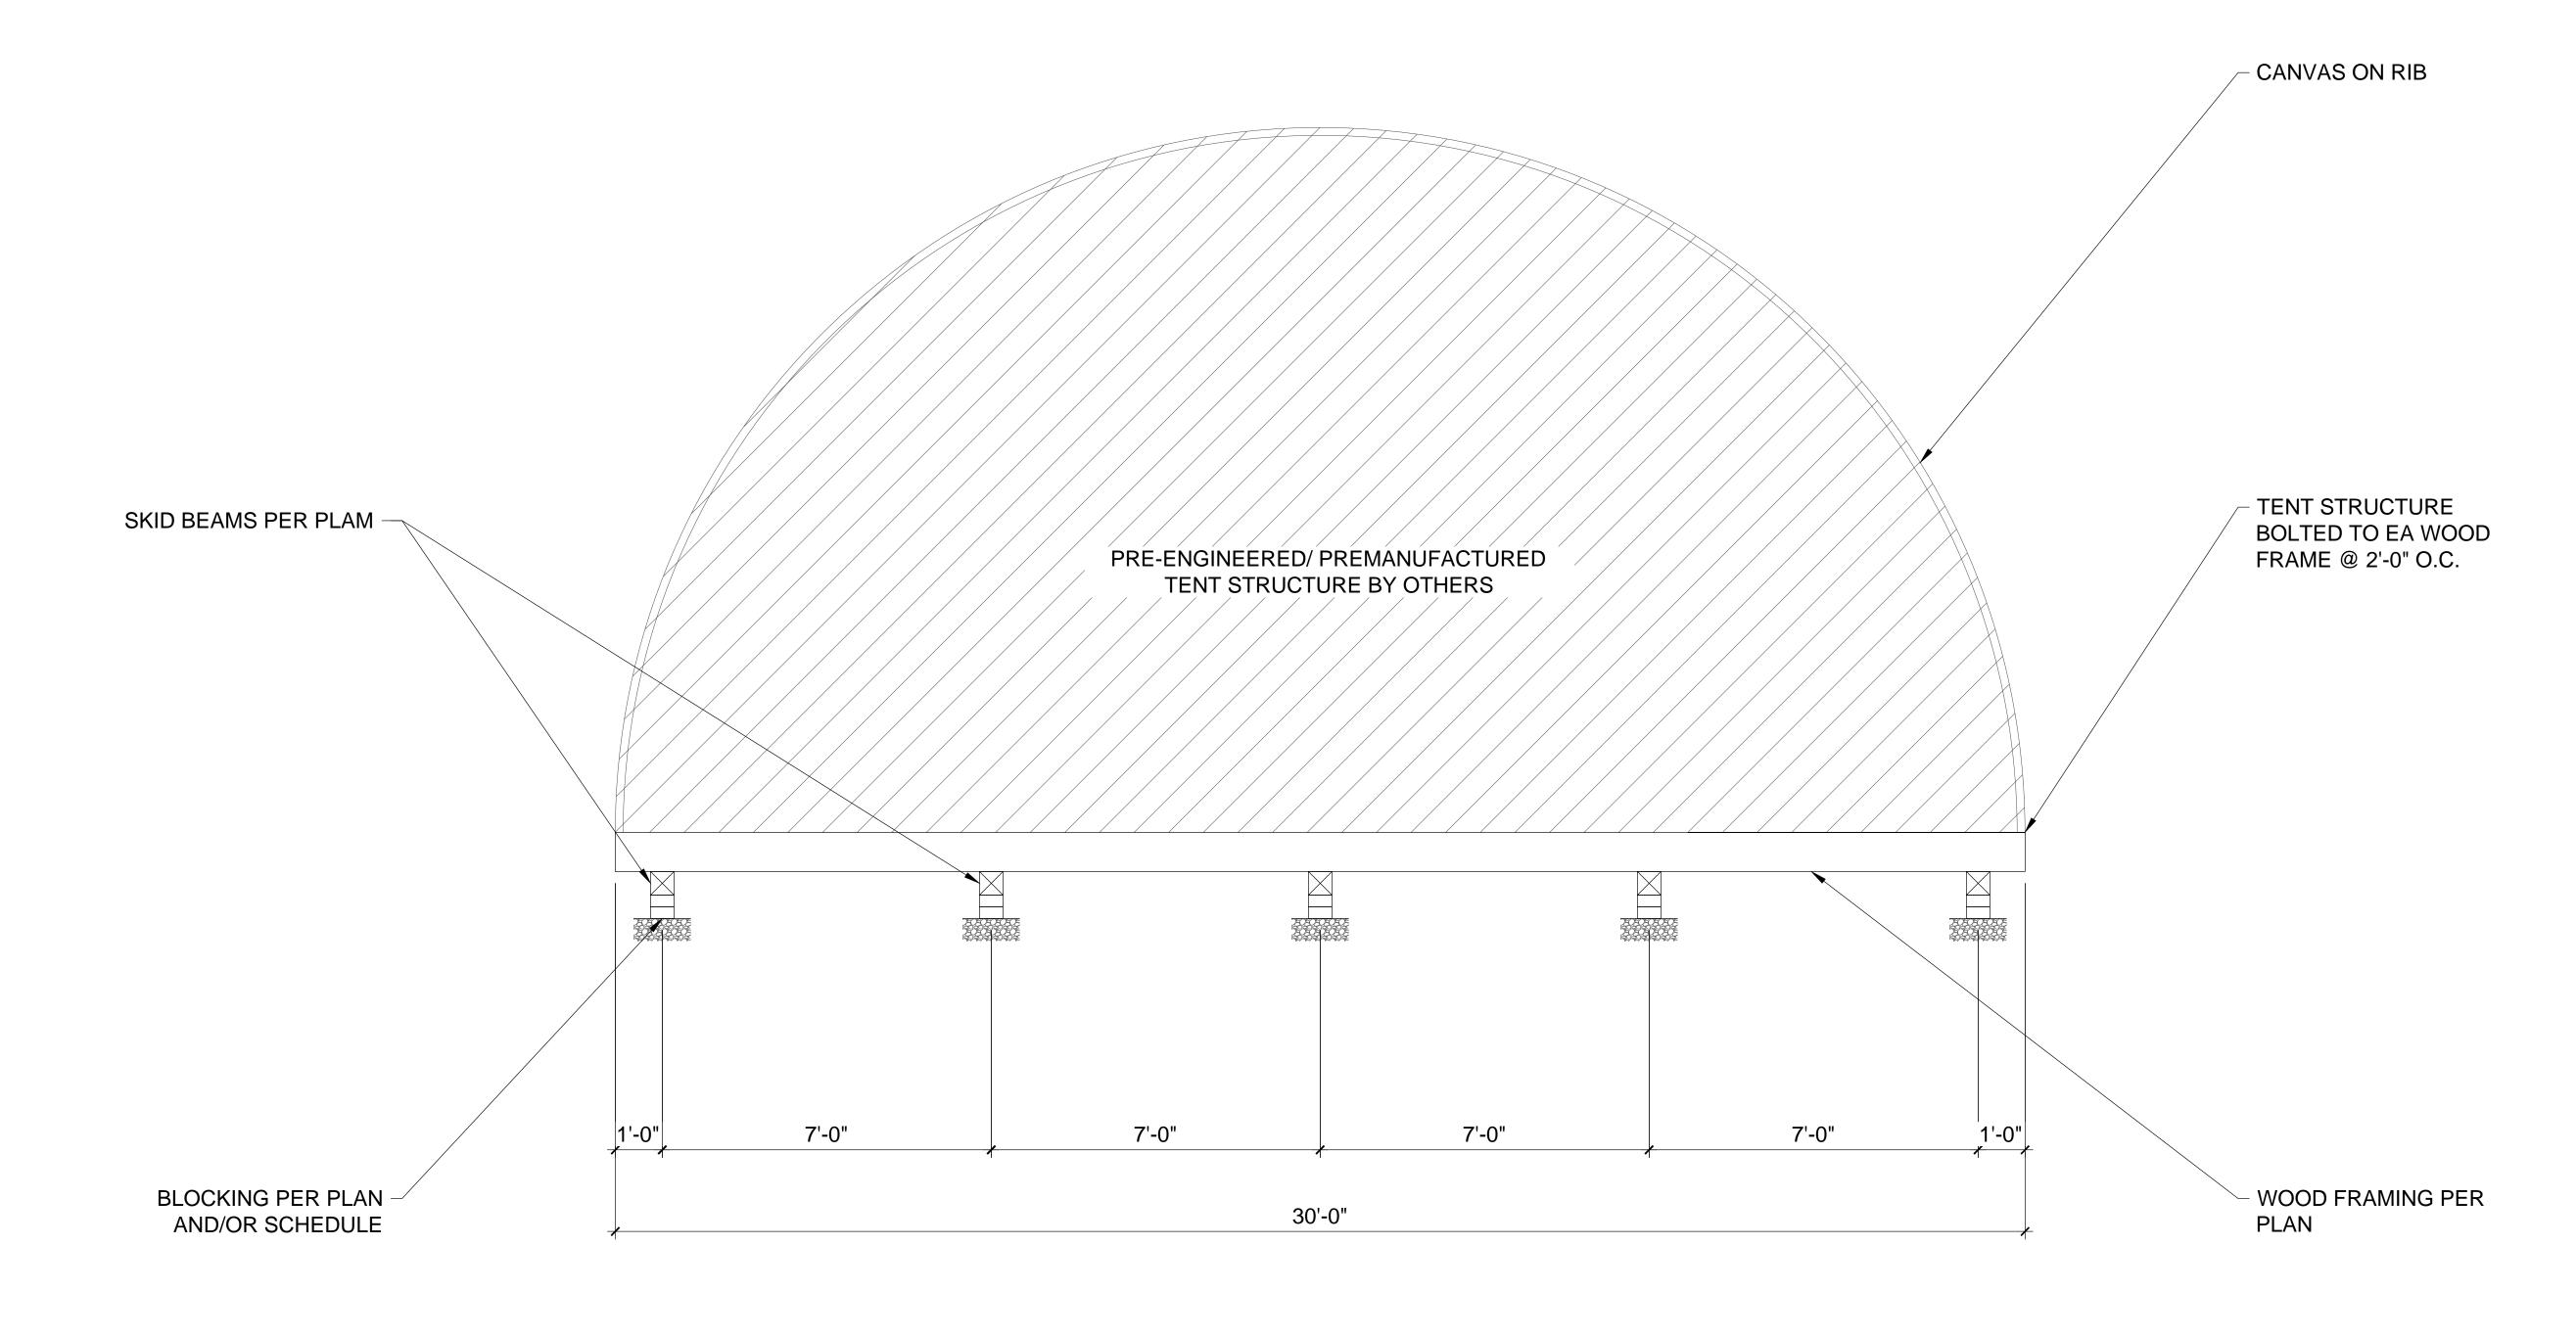


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CHECKED :	11	

BAFFINLAND IRON MINES

OORM COMPLEX AND CHANGING ROOM
BAFFINLAND
FOUNDATION PLAN

SF-002



TYPICAL SECTION SCALE: NONE

## Sheet 3 of 3

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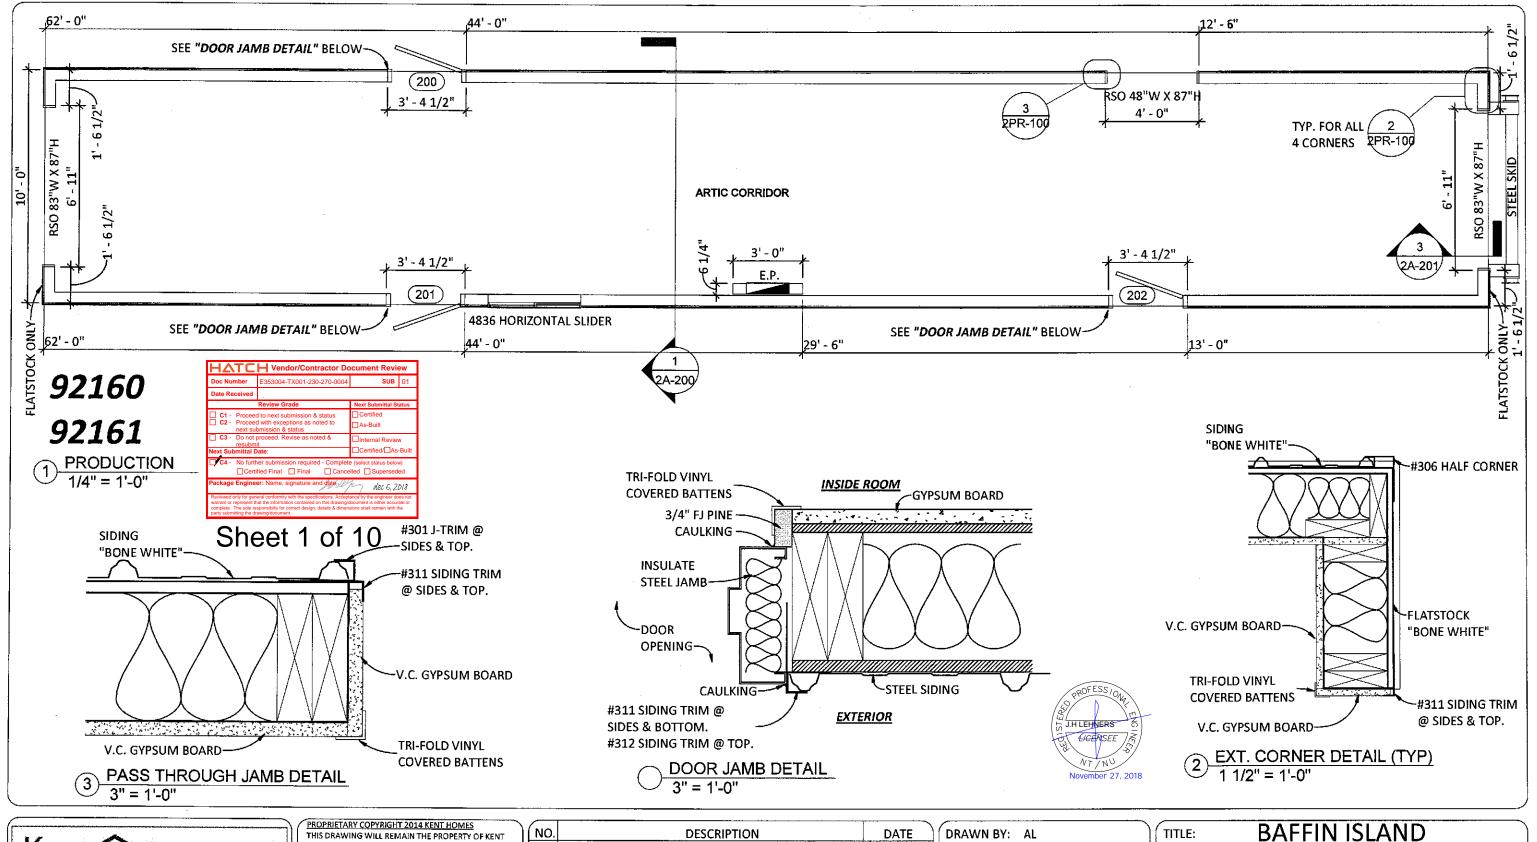




PROJ#: 24015	BAFFINLAND IRON MINES
SCALE : AS SHOWN	DORM COMPLEX AND CHANGING ROOM
DRAWN BY : NG	BAFFINLAND
CHECKED: JL	

DORM COMPLEX AND CHANGING ROOM BAFFINLAND **SECTION** 

SF-003





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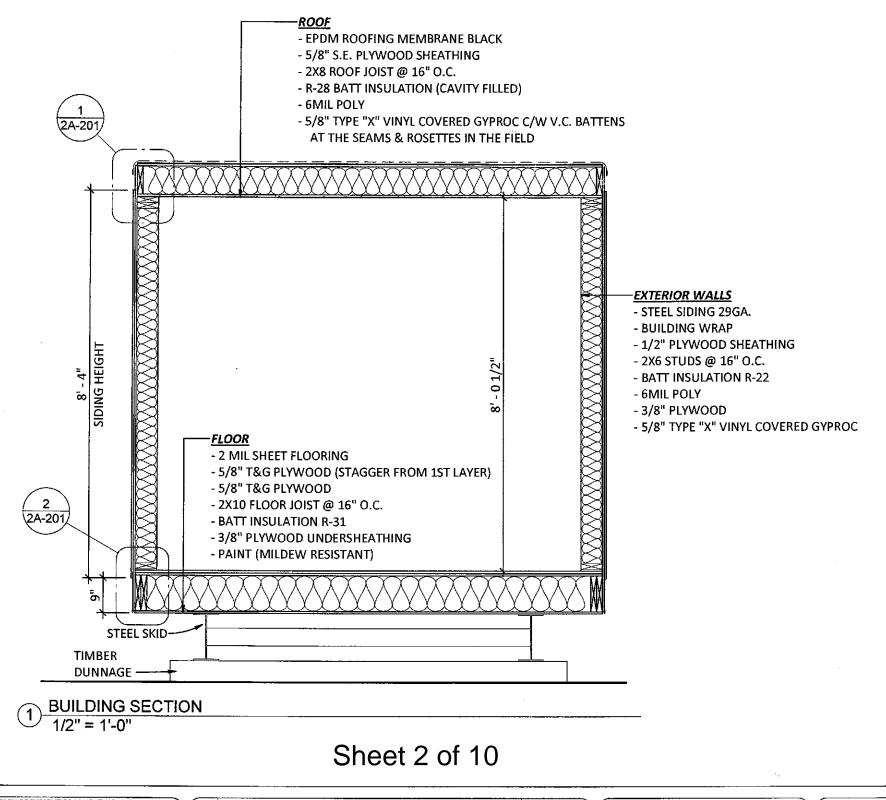
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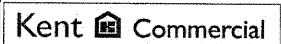
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СНК ВҮ:	PM
DATE:	06/21/18
SCALE:	As indicated
PROJECT NO:	92160-92161
TYPE:	10'-0" X 62'-0"

ARCTIC CORRIDOR
LINE LAYOUT
HORIZON NORTH

SHEET NO.: 2PR-100





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TYPE:	10'-0" X 62'-0"


TITLE: BAFFIN ISLAND


ARCTIC CORRIDOR

CROSS SECTION

HORIZON NORTH

SHEET NO.: 2A-200

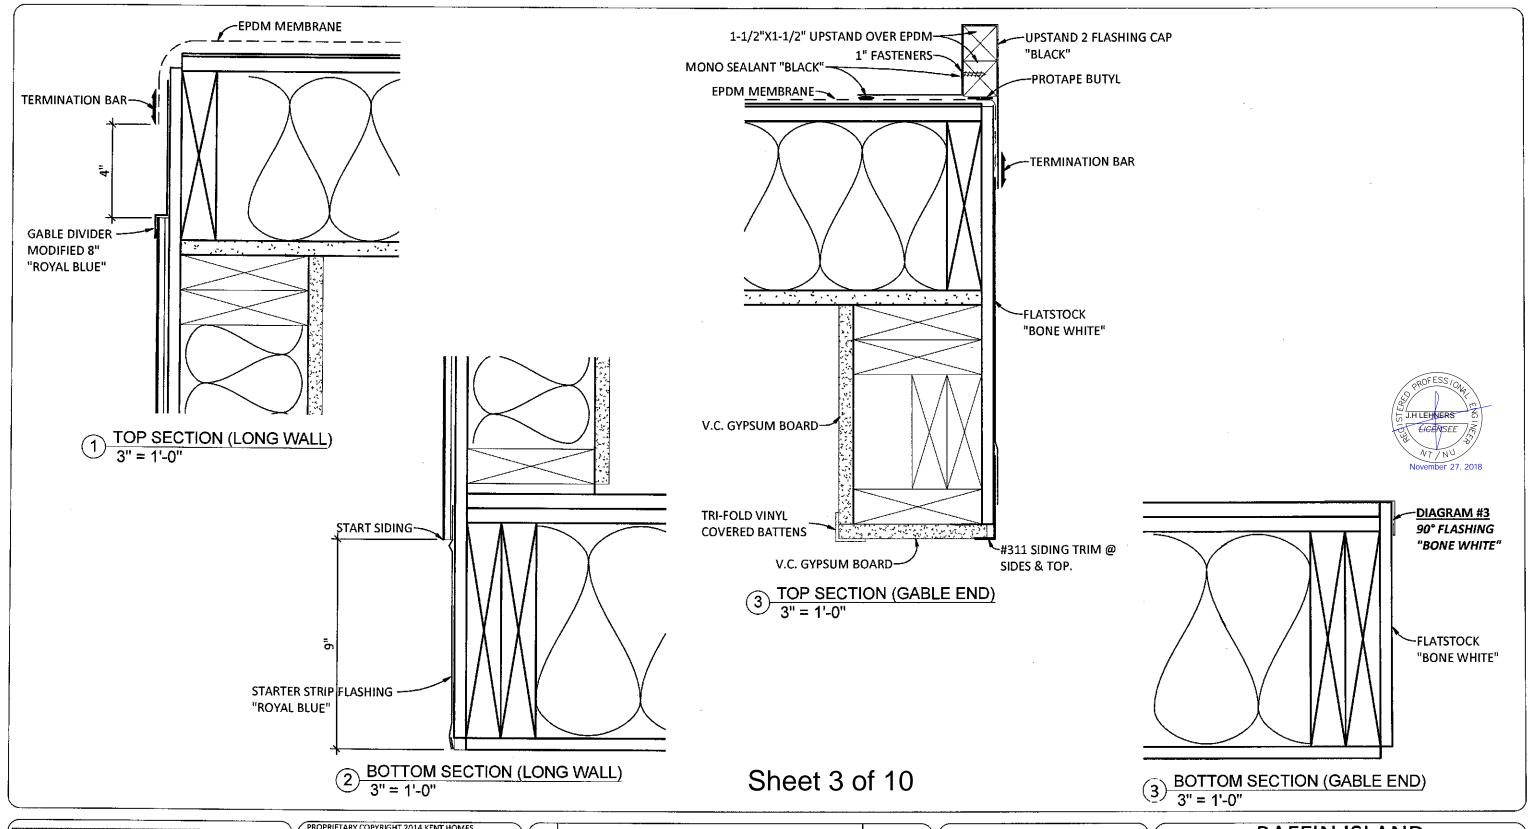

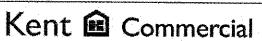

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TITLE: BAFFIN ISLAND

ARCTIC CORRIDOR

SECTION DETAILS


HORIZON NORTH

SHEET NO.: 2A-201

#### FINISH SCHEDULE

<u>ITEM</u>	MATERIAL	MAKE & MODEL	<u>COLOR</u>
<u>FLOORS</u>			
FLOORING	2.0mm SHEET FLOORING	POLYFLOR XL PU	FOSSIL 3710
BASEBOARD	4" RUBBER BASEBOARD	JOHNSONITE	#48 GREY
WALLS & CEILINGS			
WALL FINISH EXTERIOR	STEEL SIDING 29 ga.	IDEAL - AMERI-CANA	BONE WHITE (MAIN BUILDING)
			ROYAL BLUE (TOP & BOTTOM)
WALL FINISH INTERIOR	5/8" VINYL COVERED GYPROC	·	LINEN GREY 669
WALL BATTENS	5/16"X1-3/16" VINYL COVERED		LINEN GREY 669
WALLS (WASHROOMS)	NRP PREGLUED ON 5/8" GYPROC		WHITE
CEILING FINISH	5/8" VINYL COVERED GYPROC		ADOBE WHITE
CEILING TRIMS	BATTENS & ROSETTES		WHITE
DOORS & WINDOWS			
EXT DOORS & FRAMES	METAL DOOR & FRAME		SALT & PEPPER 6182-42
INT DOORS & FRAMES	METAL DOOR & FRAME		SALT & PEPPER 6182-42
WINDOW CASING	PVC COLONIAL		GREY
WINDOW BUILD-UP	PINE 1X6		WHITE
CABINETS & COUNTERTOPS			
CABINET	MELAMINE BOX	GLENWOOD	GREY WOLF
CABINET DOORS	SHAKER OAK	GLENWOOD	GREY WORF
CABINET HANDLES	BP505195	RICHELIEU	BRUSHED NICKEL
COUNTERTOP	POST FORMED	BELANGER	4954-22 ITALIAN WHITE PESCO



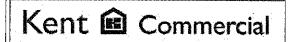

A better way to build

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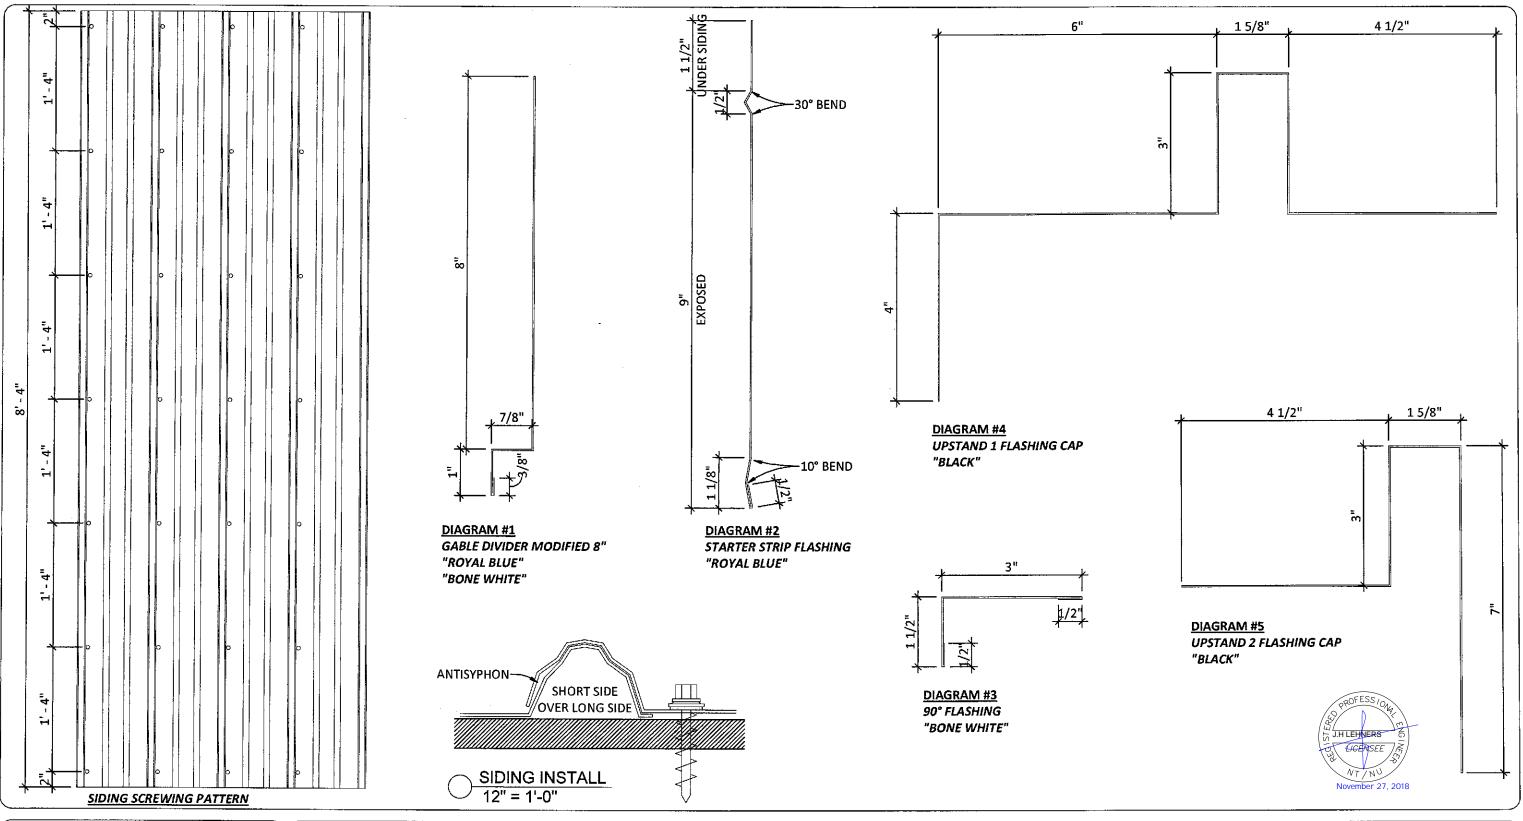
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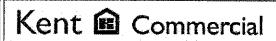
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TITLE: **BAFFIN ISLAND** ARCTIC CORRIDOR **FINISH SCHEDULE** 

2DT-100

HORIZON NORTH SHEET NO.:





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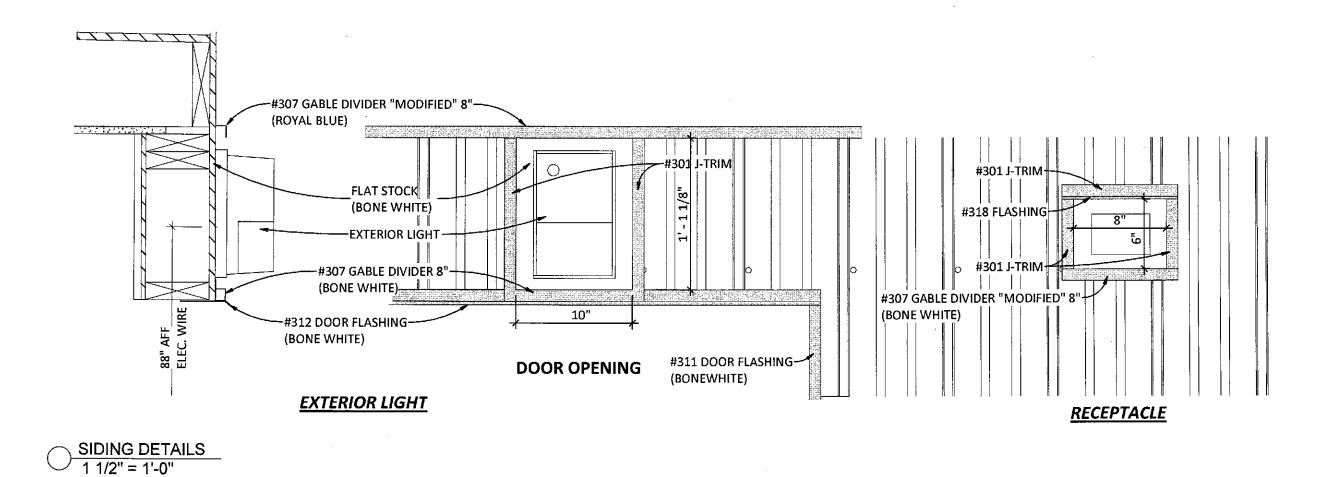
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TITLE: BAFFIN ISLAND

ARCTIC CORRIDOR
SIDING TRIM
HORIZON NORTH

SHEET NO.: 2DT-101



Sheet 6 of 10



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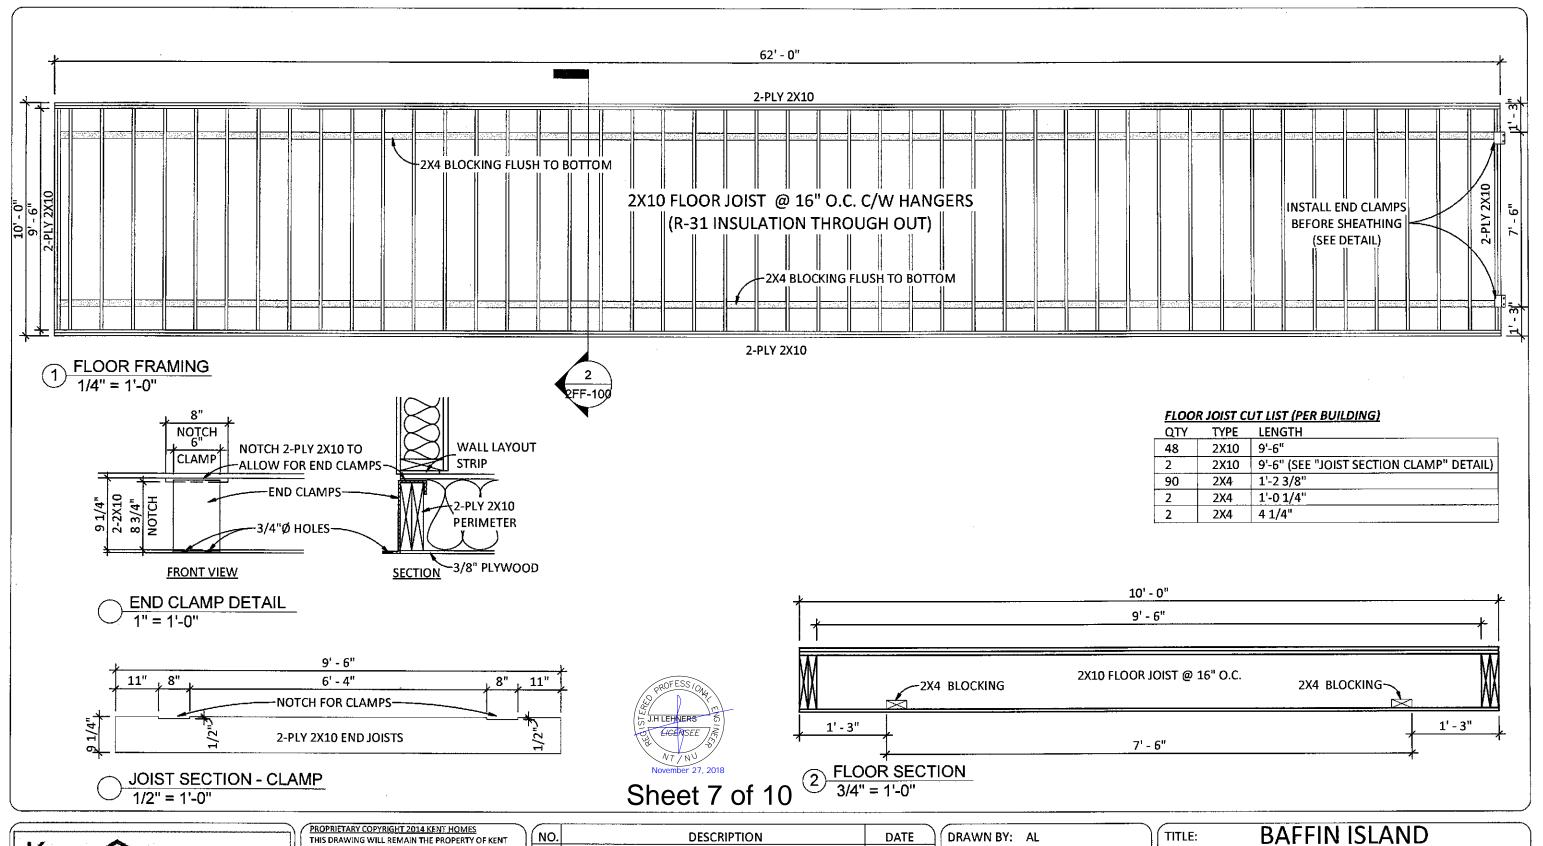
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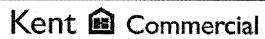
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DATE:	06/21/18
SCALE:	1 1/2" = 1'-0"
PROJECT NO:	92160-92161
TYPE:	10'-0" X 62'-0"

TITLE: BAFFIN ISLAND
ARCTIC CORRIDOR
SIDING DETAILS
HORIZON NORTH

SHEET NO.: 2DT-102





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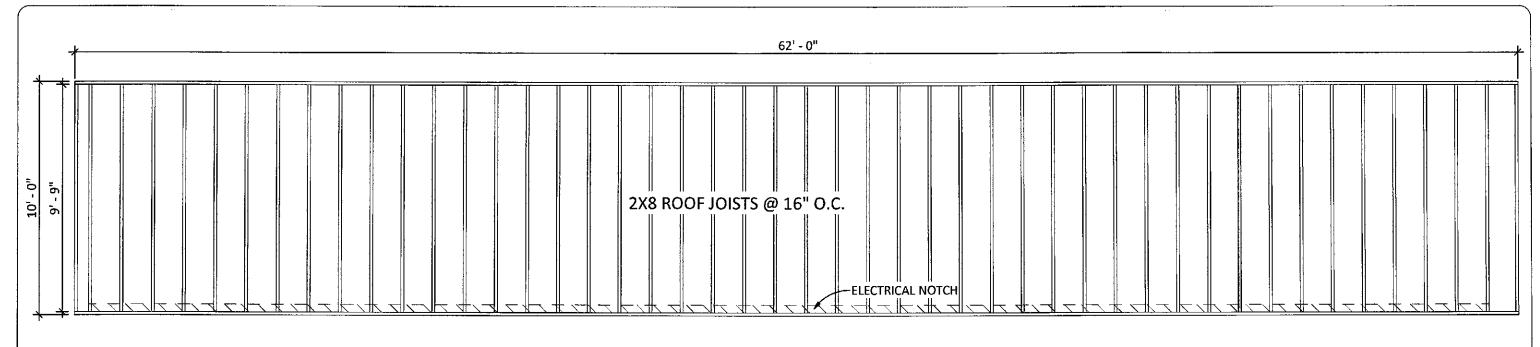
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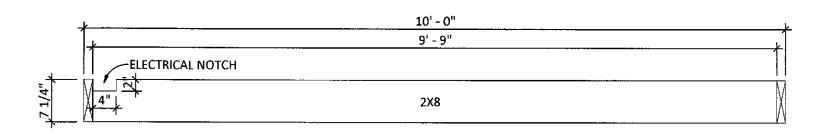
ARCTIC CORRIDOR
FLOOR FRAMING
HORIZON NORTH

SHEET NO.:

2FF-100



2 ROOF FRAMING 1/4" = 1'-0"



#### **ROOF JOIST CUT LIST (PER BUILDING)**

QTY	TYPE	LENGTH
22	2X8	9'-9" (WITH ELECTRICAL NOTCH)





### Kent @ Commercial

ROOF SECTION 3/4" = 1'-0"

A better way to build

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TITLE: BAFFIN ISLAND


ARCTIC CORRIDOR

ROOF FRAMING


HORIZON NORTH

SHEET NO.: 2FR-100

### 1ST LAYER - 5/8" T@G PLYWOOD SHEATHING (GLUED TO JOIST)

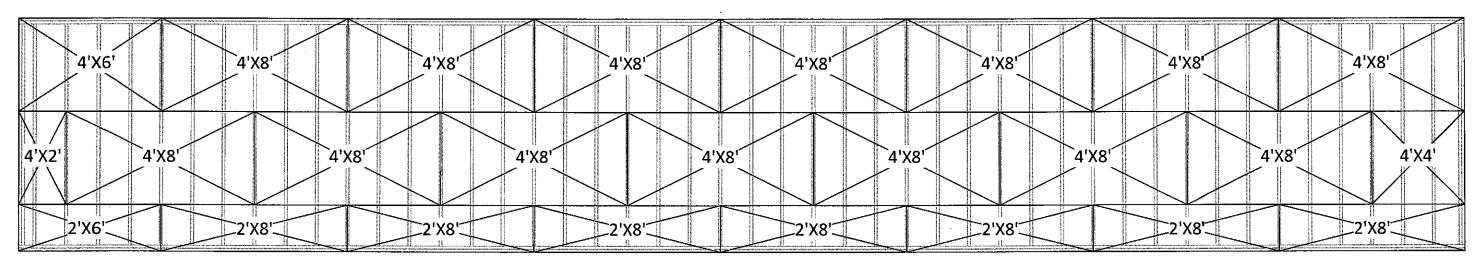

### 2ND LAYER - 5/8" T@G PLYWOOD SHEATHING (GLUED TO 1ST LAYER)

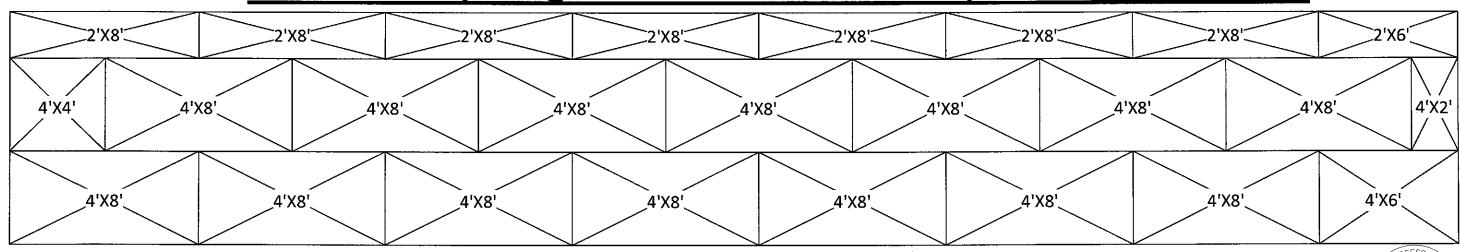

#### Sheet 9 of 10

### Kent @ Commercial

A better way to build

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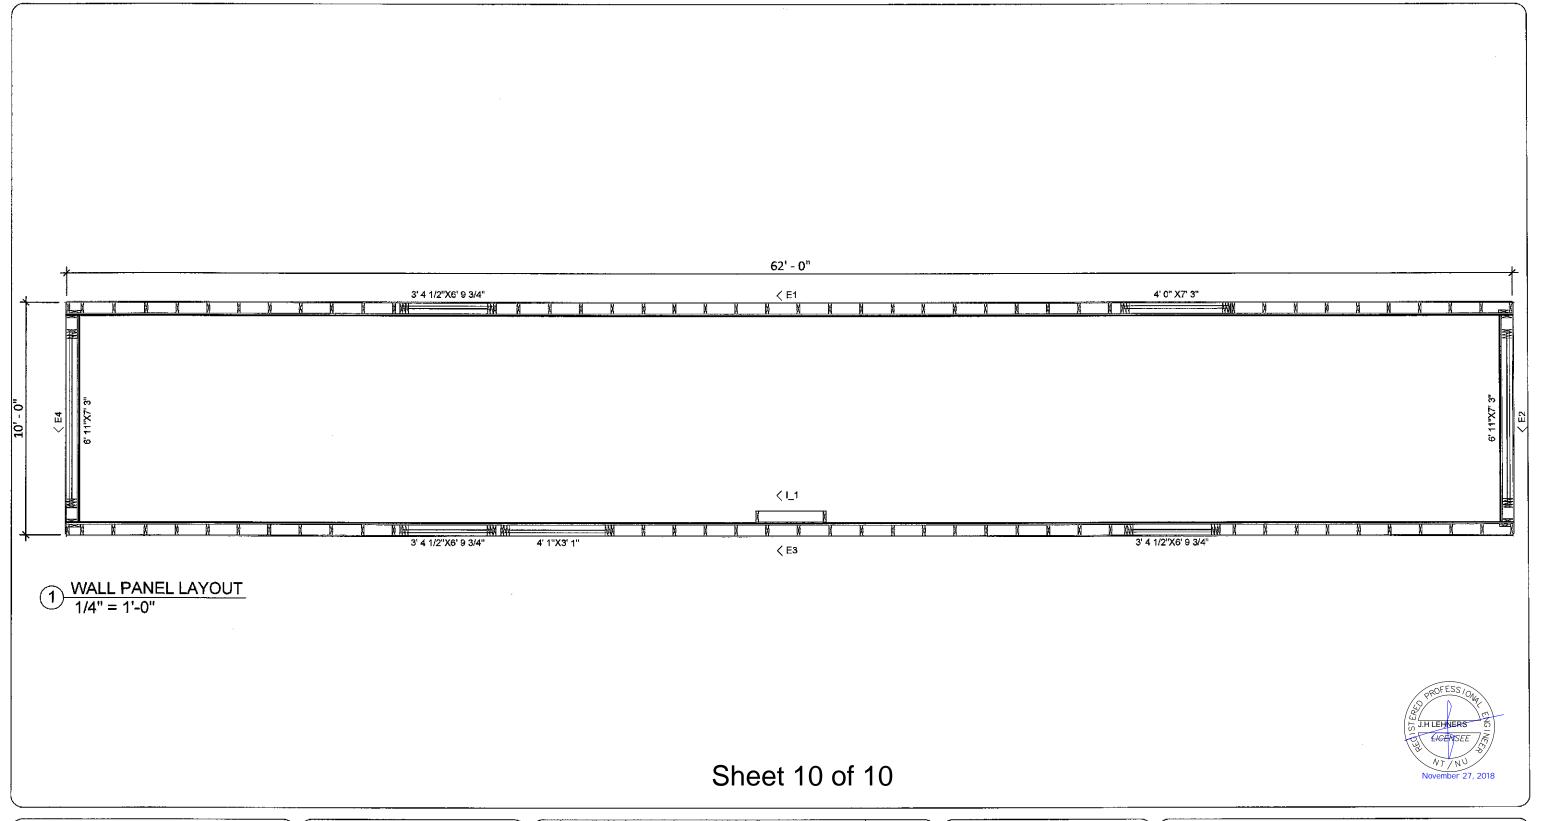
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7	TYPE:	10'-0" X 62'-0"


**BAFFIN ISLAND** TITLE: **ARCTIC CORRIDOR** FLOOR SHEATHING HORIZON NORTH

2FS-100

SHEET NO .:

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		DATE:	06/21/18
		SCALE:	1/4" = 1'-0"
		PROJECT NO: 92160-92161	
		TYPE:	10'-0" X 62'-0"

TITLE: BAFFIN ISLAND
ARCTIC CORRIDOR
WALL LAYOUT
HORIZON NORTH

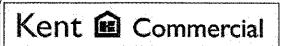SHEET NO.: 2WL-100