



<u>DEMO - EXISTING MAIN FLOOR PLAN</u>

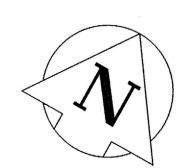

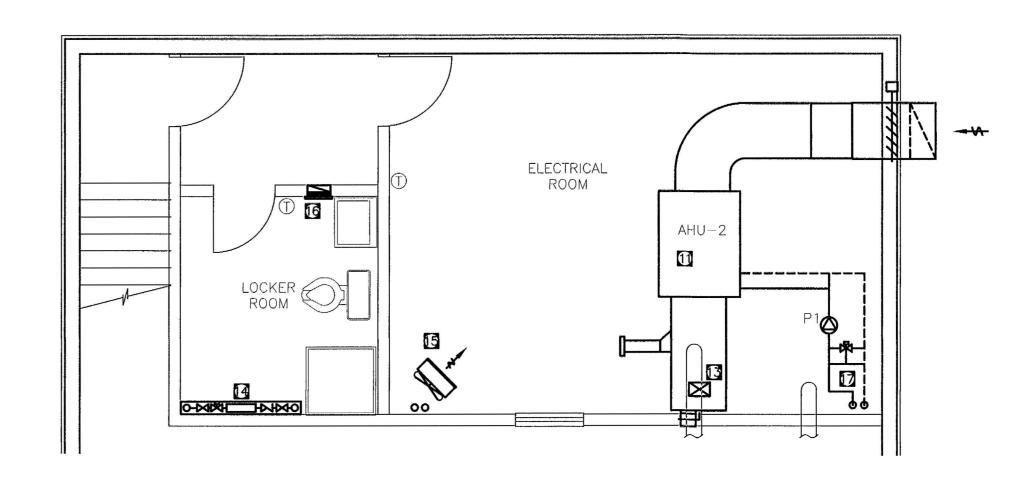

<u>DEMO – SECOND FLOOR LEVEL</u>

EXIST. SEWAGE PLANT DECOMMISSIONING NOTES

1 REMOVE & RELOCATE OF UNIT HEATER.

TO BE RE-USED IN NEW TRUCK BAY.

2 REMOVE & RELOCATE OF UNIT HEATER. TO BE RE-USED IN NEW TRUCK BAY.

3 REMOVE & RELOCATE OF UNIT HEATER. TO BE RE-USED IN NEW TRUCK BAY.

4 REMOVE & RELOCATE OF UNIT HEATER. TO BE RE-USED IN NEW TRUCK BAY.

5 REMOVE THRU WALL DUCT AND SEAL OPENING TO MATCH EXISTING.

6 EXISTING PLATE HEAT EXCHANGER TO BE RELOCATED

7 REMOVE & DISPOSE OF EXHAUST FAN, REPLACE WITH EXPLOSION PROOF

8 REMOVE & DISPOSE OF EXHAUST FAN C/W ALL ASSOCIATED HARDWARE, WALL PENETRATIONS TO BE PATCHED TO MATCH EXISTING.

1 REMOVE AND DISPOSE OF EXHAUST FAN, WALL PENETRATIONS TO BE PATCHED TO MATCH EXISTING.

@ REMOVE AND DISPOSE OF AHU-1

11 REMOVE AND DISPOSE OF AHU-2

ZEXISTING HOT WATER STORAGE TANK TO BE RELOCATED

EXISTING DUCT WORK TO BE REMOVED, WALL/FLOOR PENETRATIONS TO BE PATCHED TO MATCH EXISTING.

A EXISTING FIN TUBE RADIANT HEATER TO REMAIN.

EXISTING RADIANT HEATER TO REMAIN.

6 EXISTING EXHAUST FAN TO REMAIN.

REMOVE AND DISPOSE OF ALL EXISTING HYDRONIC HEATING PIPE WORK LOCATED IN PROCESS ROOM.

18 DELETED

19 EXISTING UNIT HEATER TO BE RELOCATED

REMOVE AND DISPOSE OF ALL EXISTING HYDRONIC HEATING PIPE WORK LOCATED IN MECHANICAL ROOM.

CUT BACK AND LOOP PIPING, WITH FLANGED FITTINGS, AS CLOSE TO GRADE AS REASONABLE, EXISTING HOT WATER LINES FROM POWER CORPORATION.

(TYP. OF 2) REMOVE EXISTING GRATED FLOOR DRAIN COVER. DRAIN TO BE PLUGGED AND PATCHED WITH CONCRETE TO MATCH EXISTING FLOOR SURFACE. FLOOR DRAIN PIPE TO BE ABANDONED.

SAW-CUT EXISTING CONCRETE FLOOR SECTION TO SUIT NEW PLUMBING MODIFICATIONS REQUIRED FOR NEW FLOOR DRAIN, CLEANOUT & RELOCATED SINK. (FLOOR TO BE PATCHED TO MATCH EXISTING UPON COMPLETION)



This drawing is the exclusive property of Nuna Burnside and the reproduction of any part without prior written consent of this office is strictly prohibited.

2. The contractor shall verify all dimensions, levels, and datums on site and report any discrepancies or omissions to this office prior to construction.

3. This drawing is to be read and understood in conjunction with all other plans and documents applicable to this project. 4. Do not scale the drawings.

Issue / Revision PERMIT TO PRACTICE NOVEMBER 2012 ISSUED FOR 66% SUBMISSION ISSUED FOR 99% SUBMISSION JANUARY 2012 G Sopawick FEBRUARY 2013 ISSUED FOR TENDER PERMIT NUMBER: P 535 REVISED AS PER ADDENDUM 1 TO 4 APRIL 2013 AND ISSUED FOR CONSTRUCTION The Association of Professional Engineers, Geologists and Geophysicists of NWT/NU





Nuna Burnside Engineering & Environmental LTD. 106B Scurfield Blvd., Winnipeg, Manitoba telephone (204) 949-7110 fax (204) 949-7111 web www.neeganburnside.com

GOVERNMENT OF NUNAVUT COMMUNITY & GOVERNMENT SERVICES

RANKIN INLET SEWAGE TREATMENT PLANT

Drawing Title
DEMOLITION - EXISTIN
DEMOLITION — EXISTING MECHANICAL EQUIPMEN

Drawn By A.H.	Checked By D.MacK.	Drawing No.	
Scale 1:50	Project No. 300031281	M-1	