


MECHANICAL HYDRONIC PIPING - MEZZANINE FLOOR PLAN
1:50

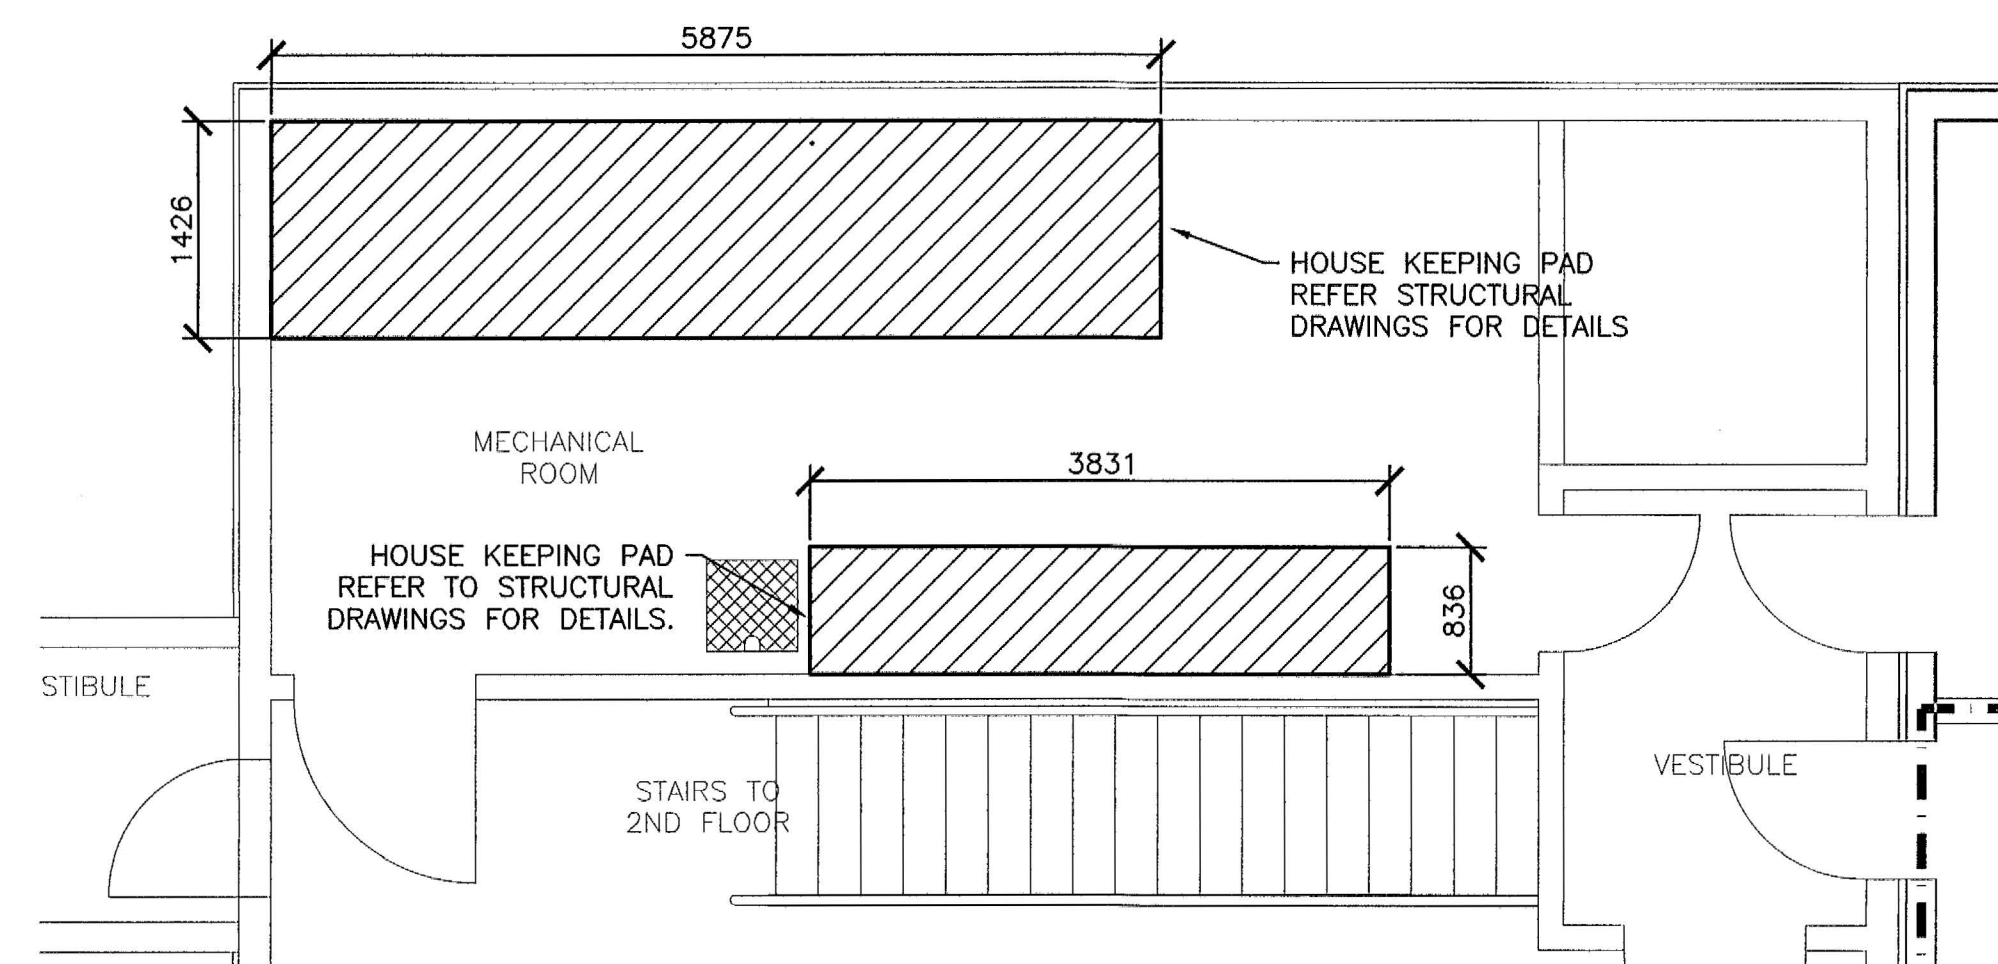


MECHANICAL ROOM HOUSE KEEPING PAD PLAN
1:50

1. This drawing is the exclusive property of Nuna Burnside and the reproduction of any part without prior written consent of this office is strictly prohibited.
2. The contractor shall verify all dimensions, levels, and datums on site and report any discrepancies or omissions to this office prior to construction.
3. This drawing is to be read and understood in conjunction with all other plans and documents applicable to this project.
4. Do not scale the drawings.

Issue / Revision	Date
1 ISSUED FOR 99% SUBMISSION	JANUARY 2013
2 ISSUED FOR TENDER	FEBRUARY 2013
3 REVISED AS PER ADDENDUM 1 TO 4 AND ISSUED FOR CONSTRUCTION	APRIL 2013

PERMIT TO PRACTICE
Nuna Burnside Engineering and Environmental Ltd.
Signature: *[Signature]*
Date: May 27/13
PERMIT NUMBER: P 535
The Association of Professional Engineers,
Geologists and Geophysicists of NWT/NU

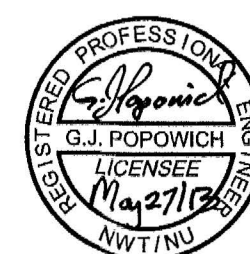

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Client: GOVERNMENT OF NUNAVUT
COMMUNITY & GOVERNMENT
SERVICES
RANKIN INLET
SEWAGE TREATMENT PLANT

Drawing Title: SECOND FLOOR
MECHANICAL HYDRONIC
HEATING LAYOUT

Drawn By A.H.	Checked By D.Mack.	Drawing No.
Scale AS NOTED	Project No. 300031281	M-6