


## MECHANICAL HYDRONIC PIPING - MEZZANINE FLOOR PLAN 1:50

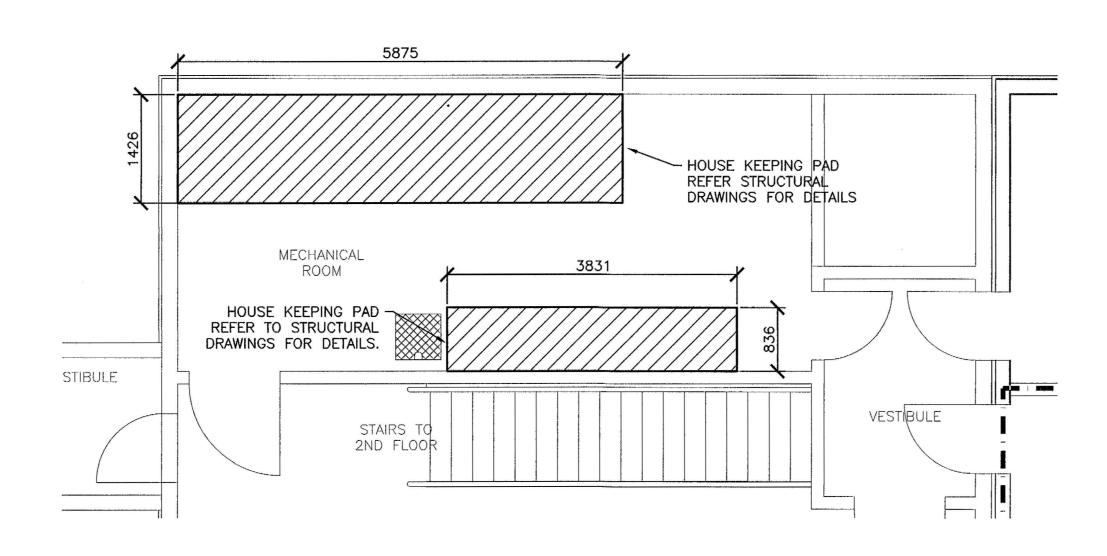

## MECHANICAL ROOM HOUSE KEEPING PAD PLAN

	<ol> <li>This drawing is the exclusive property of Nuna Burnside and the reproduction of any part without prior written consent of this office is strictly prohibited.</li> </ol>	
	<ol> <li>The contractor shall verify all dimensions, levels, and datums on site and report any discrepancies or omissions to this office prior to construction.</li> </ol>	ŀ
***************************************	<ol> <li>This drawing is to be read and understood in conjunction with all other plans and documents applicable to this project.</li> </ol>	ŀ
	4. Do not scale the drawings.	L

	Issue / Revision	Date
1	ISSUED FOR 99% SUBMISSION	JANUARY 2013
2	ISSUED FOR TENDER	FEBRUARY 2013
3	REVISED AS PER ADDENDUM 1 TO 4 AND ISSUED FOR CONSTRUCTION	APRIL 2013

PERMIT TO PRACTICE
Nuna Burnside Engineering and Environmental Ltd.

Signature

May 27/13

PERMIT NUMBER: P 535

The Association of Professional Engineers,
Geologists and Geophysicists of NWT/NU



## Mana Burnside

Nuna Burnside Engineering & Environmental LTD. 106B Scurfield Blvd., Winnipeg, Manitoba telephone (204) 949-7110 fax (204) 949-7111 web www.neeganburnside.com

Silvine
GOVERNMENT OF NUNAVUT COMMUNITY & GOVERNMENT SERVICES
RANKIN INLET SEWAGE TREATMENT PLANT

Drawing Title
SECOND FLOOR MECHANICAL HYDRONIC HEATING LAYOUT
MECHANICAL HYDRONIC
HEATING LAYOUT

Drawn By A.H.	Checked By D.MacK.	Drawing No.  M-6
Scale AS NOTED	Project No. 300031281	