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Nunalingni Kavamatkunnilu Pivikhaqautikkut
Ministère des Services Communautaires et gouvernementaux

Cambridge Bay Water System-new IPH

'as-built drawings'

March 29, 2016

Nunavut Water Board P.O. Box 119 Gjoa Haven, NU X0B 1L0

Attention: Karen Kharyan, Ph. D, P. Eng., Manager of Licensing

RE: Cambridge Bay Water System new IPH - "as built drawings"

Dear Mr. Karen,

GN-CGS is pleased to submit to Nunavut Water Board the attached file of "as built" drawings of Cambridge Bay Water System new Intake Pump House (IPH), prepared and issued by Stantec Consultants. The construction works done by Sanaqatiit Construction with supervision by Stantec consultants and the project was management by CGS.

These drawings are part of the complete set of drawings of the project works carried in Phase-1

We hope that Nunavut Water Board will find these 'as-built drawings' valuable in operating the Water Licence 3BM-CAM 1520 for water supply to the Hamlet of Cambridge Bay.

Best Regards,

Shah Alam, P. Eng. E.P.

Municipal Planning Engineer,

Community and Government Services

Kitikmeot Region, Cambridge Bay, Nu

Phone: 867-983-4156, fax: 867-983-4124

Email: salam@gov.nu.ca

Enclosure: 'as-built' drawings (pages) of new IPH

Cc: Sean B. Joseph, Technical Advisor, NWB

Baba Pedersen, Resource management Officer, AANDC





D-401 D-402

D - 403

M-101 M-102

M-501 M-502 M-601 M-602

E-101 E-102

E-103 E-104 E-105


CAMBRIDGE BAY POTABLE WATER SYSTEM PHASE 1 - AS-BUILT


MARCH 2016


Stantec Project Number: 144901252 GN Project Number: 11-4002

LIST OF DRAWINGS

CIVIL		PROCESS DRAWINGS
PLAN & PROFILE OF WATER INTAKE LINE INTAKE LINES DETAILS BUILDING WALL PENETRATION & PIPE SUPPORT DETAILS ACCESS VAULT STANDARD DETAILS ACCESS VAULT PIPING LAYOUT PUMP AND DISCHARGE PIPE DETAILS	C-104 C-105 C-501 C-502	TRUCKFILL AND VAULT SCHEMATIC DIAGRAMS TRUCKFILL DETAILS EQUIPMENT USE TABLE MECHANICAL SITE PLAN MECHANICAL LAYOUT DETAILS DETAILS DETAILS AND CONTROLS SCHEMATIC HEATING SCHEMATIC
STRUCTURAL		FUEL OIL SCHEMATIC
SKID AND SUBFLOOR LAYOUT AND DETAILS STRUCTURAL DETAILS STRUCTURAL SECTIONS STAIR DETAILS TRUCKFILL ARM DETAILS STRUCTURAL NOTES	S-501 S-502 S-503 S-504 S-505 S-506	ELECTRICAL LEGEND, SITE PLAN AND DETAILS SINGLE LINE DIAGRAM, GENERATOR ROOM DETAIL AND SERVICE CALCULATIONS
BUILDING FLOOR PLAN, ASSEMBLIES & SCHEDULES BUILDING ELEVATIONS DETAILS	A-101 A-201 A-301	LIGHTING FLOOR PLAN AND LUMINAIRE SCHEDULE POWER FLOOR PLAN AND MOTOR SCHEDULE HEAT TRACE DETAILS

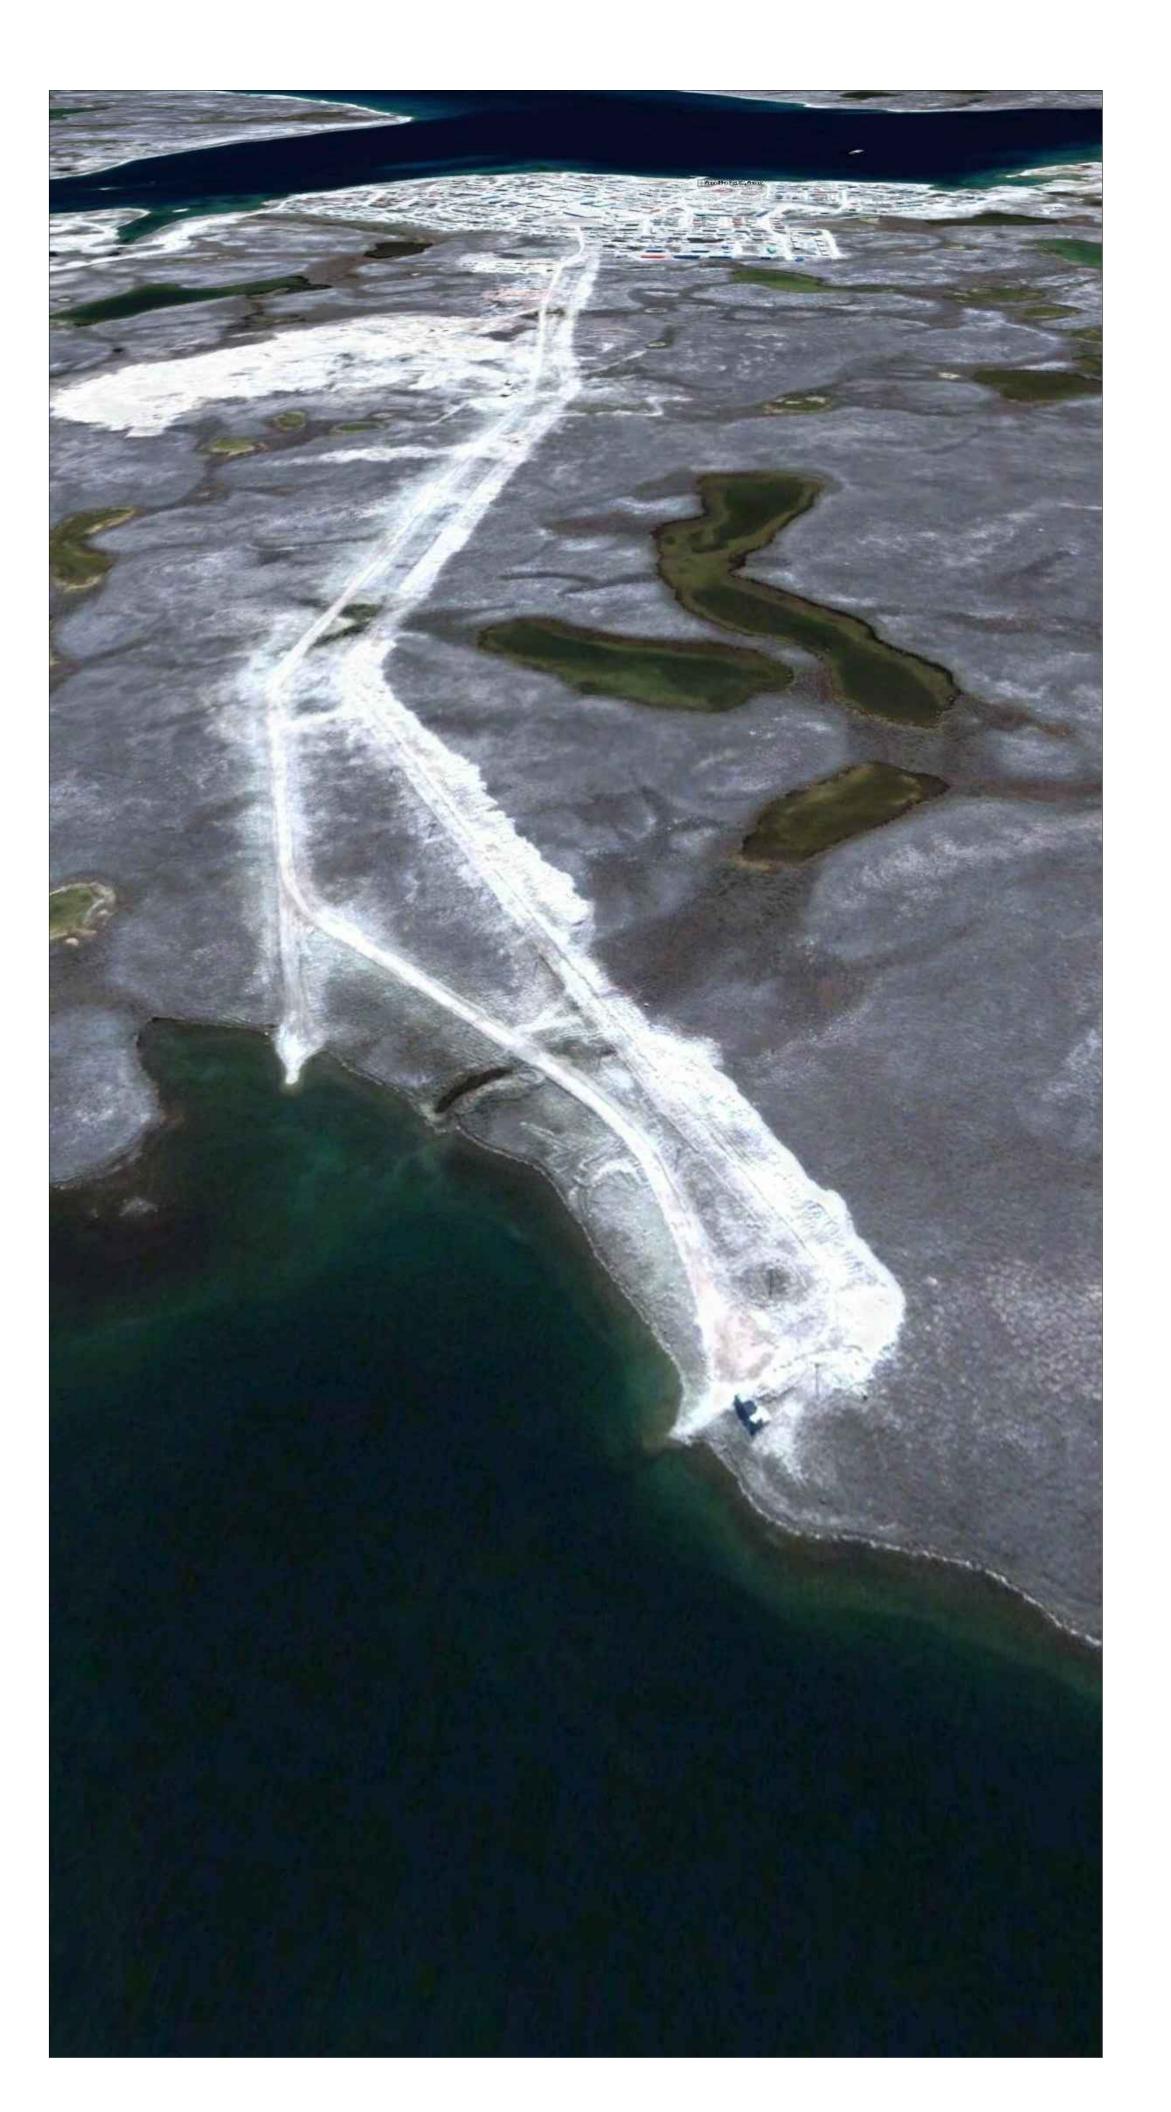

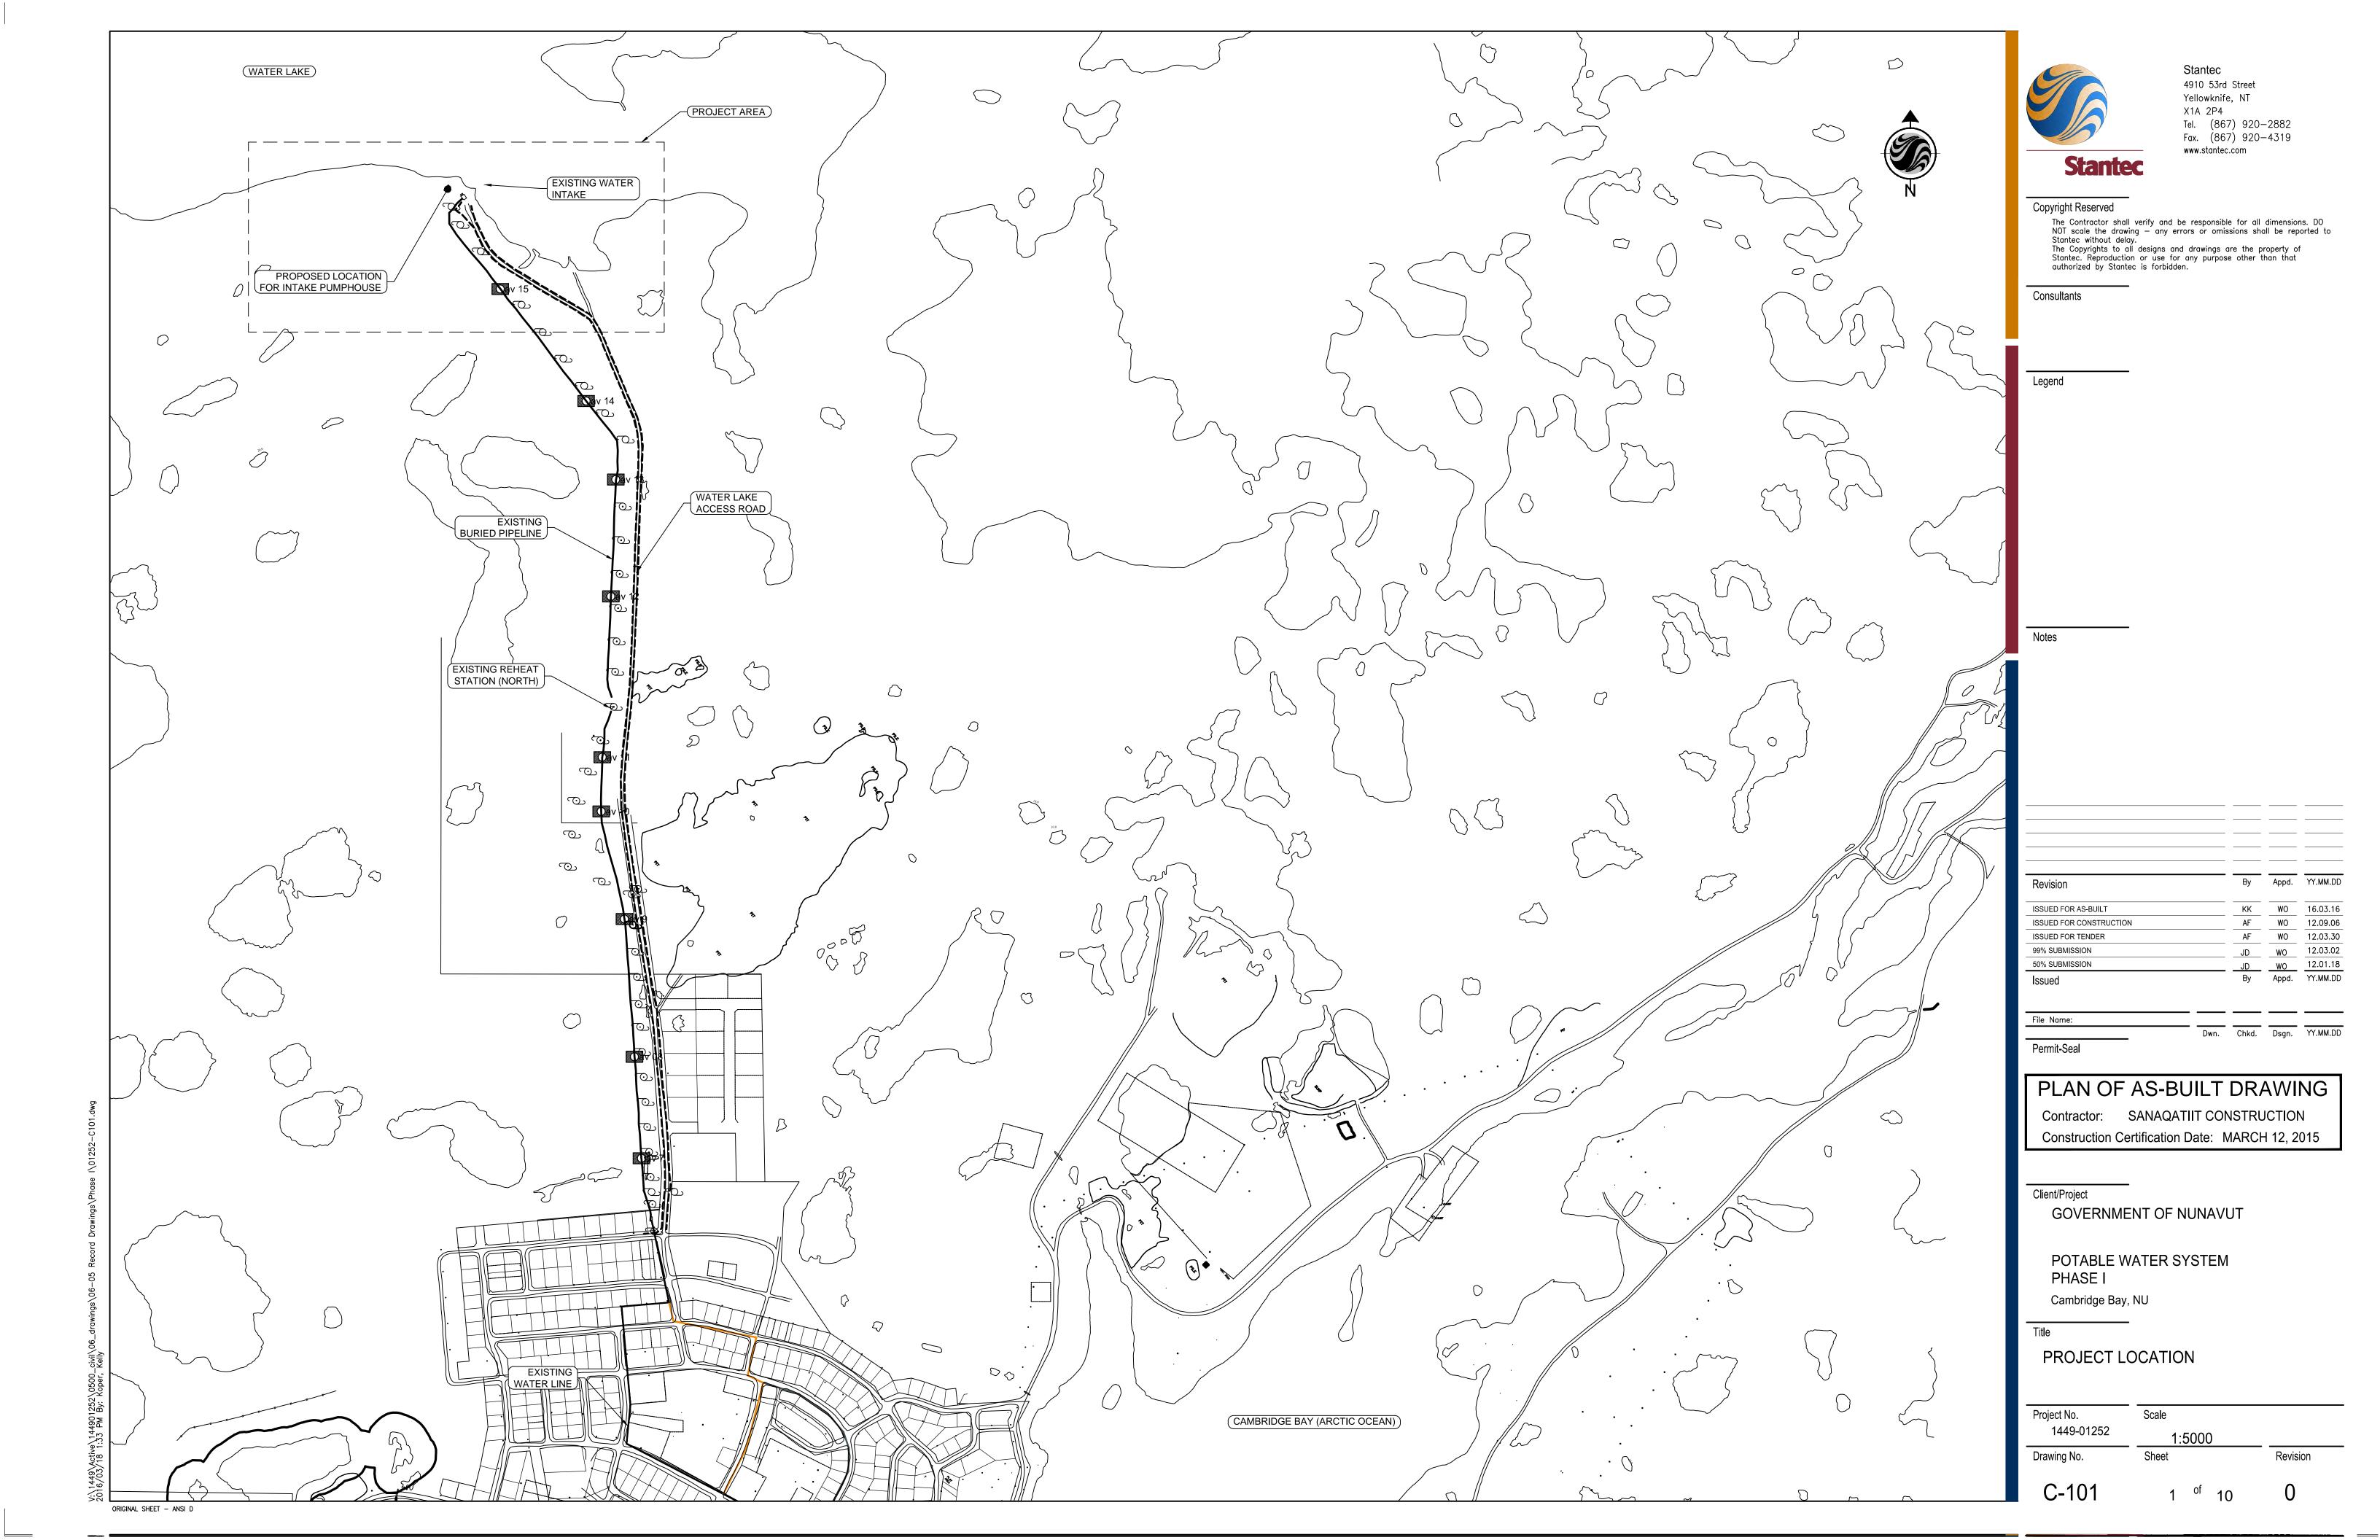

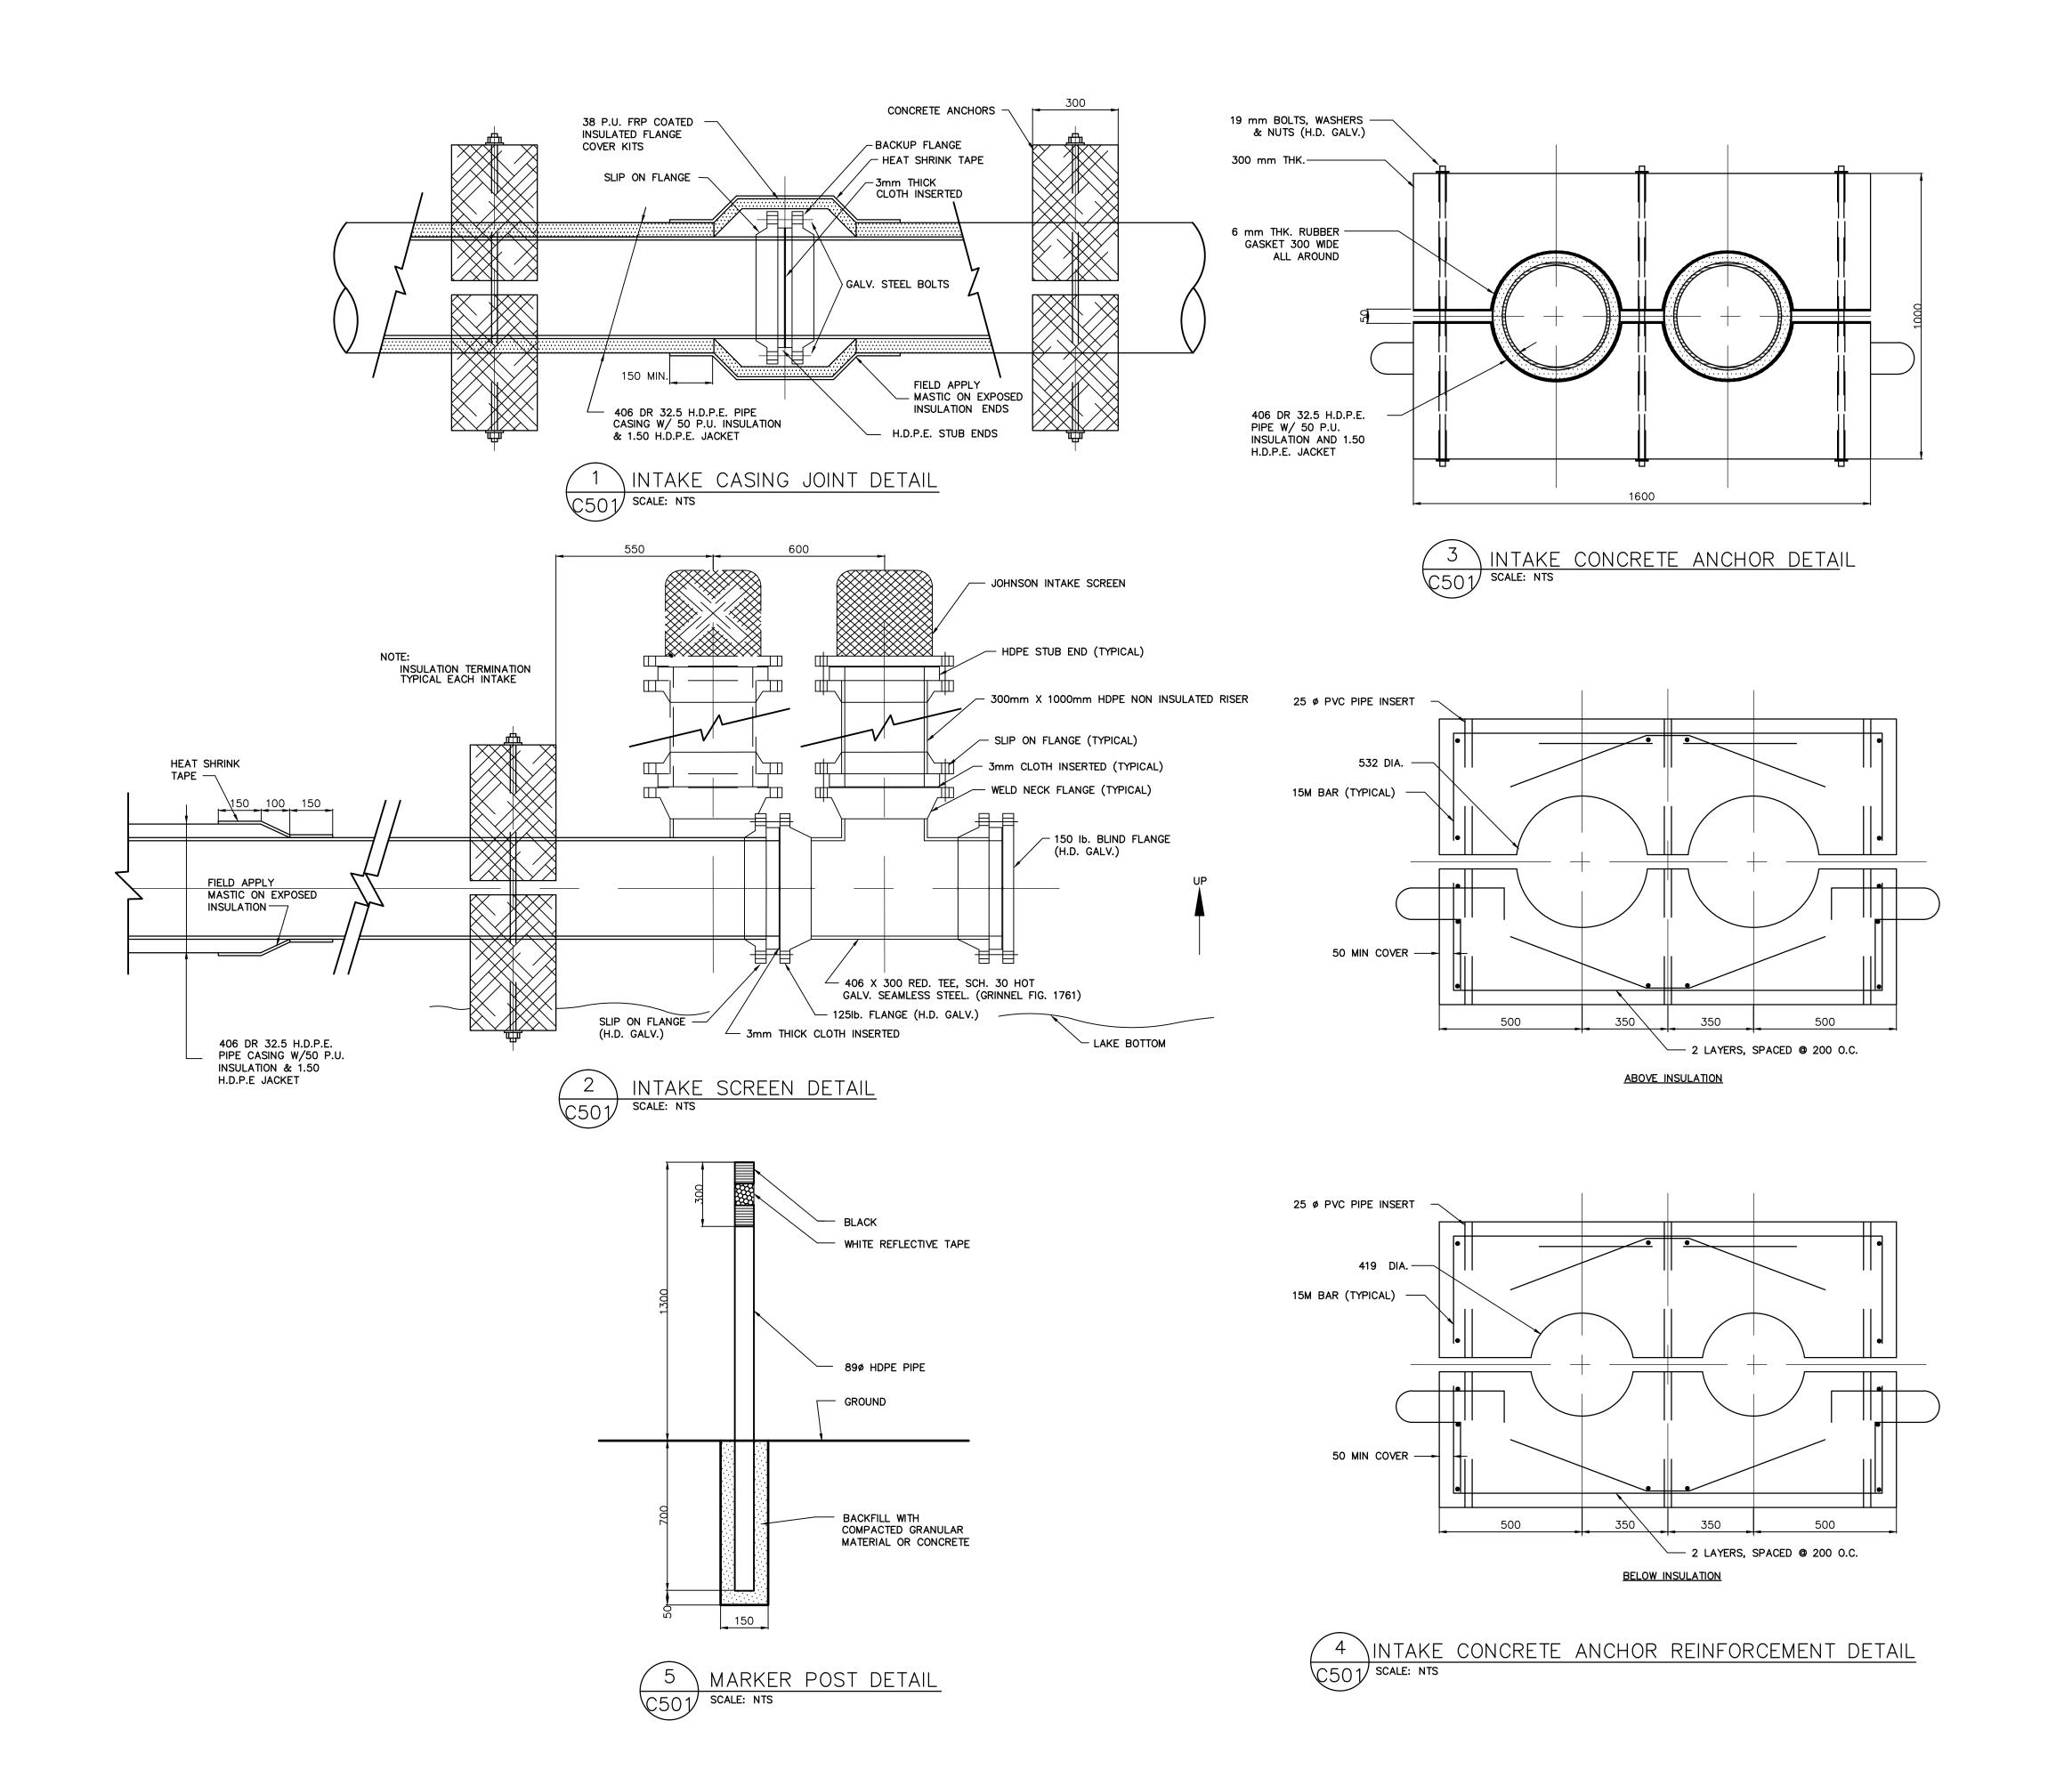



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Legend

Motoc

CONTRACTOR TO CONFIRM INSULATED AND NON-INSULATED HDPE
PIPE CASING DIAMETERS
 REBATE DIAMETERS IN CONCRETE ANCHORS TO BE 12MM LARGER

REBATE DIAMETERS IN CONCRETE ANCHORS TO BE 12MM LAF THAN OD OF INSULATED AND NON-INSULATED PIPES.

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Revision		Бу	Appu.	11.IVIIVI.DD
ISSUED FOR AS-BUILT		KK	WO	16.03.16
ISSUED FOR CONSTRUCTION		AF	WO	12.09.06
ISSUED FOR TENDER		AF	WO	12.03.30
99% SUBMISSION				12.03.02
50% SUBMISSION		JD	WO	12.01.18
Issued		Ву	Appd.	YY.MM.DD
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	Dwn.	Chkd.	Dsgn.	YY.MM.DD

PLAN OF AS-BUILT DRAWING

Contractor: SANAQATIIT CONSTRUCTION
Construction Certification Date: MARCH 12, 2015

Client/Project

Permit-Seal

GOVERNMENT OF NUNAVUT


POTABLE WATER SYSTEM PHASE I


Cambridge Bay, NU

INTAKE LINES
DETAILS

Project No. 1449-01252	Scale AS SHOWN	
Drawing No.	Sheet	Revision
C-501	6 of 10	0

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File Name:			

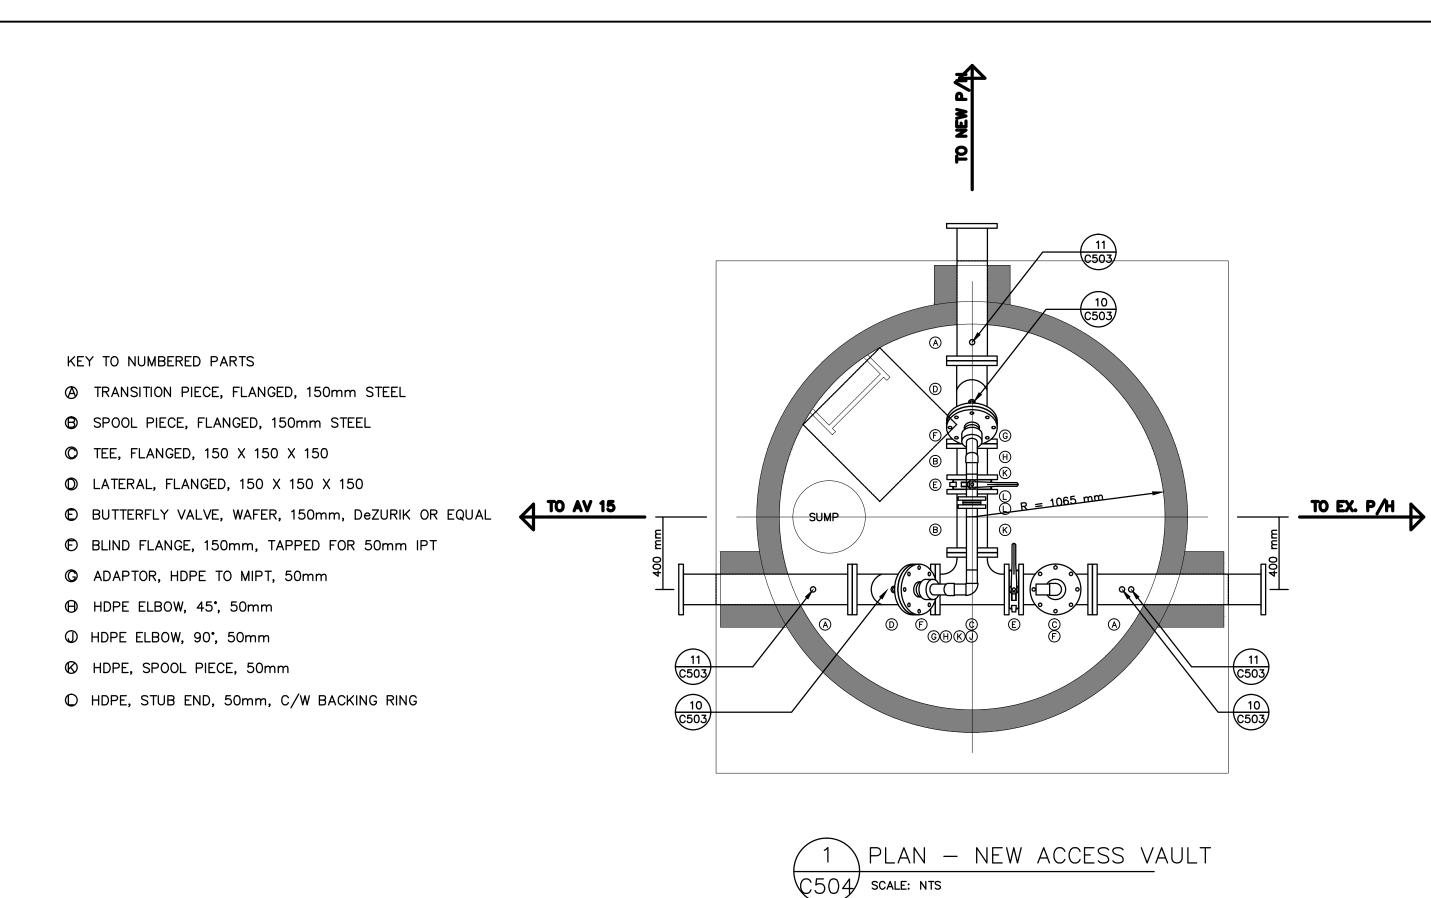PLAN OF AS-BUILT DRAWING

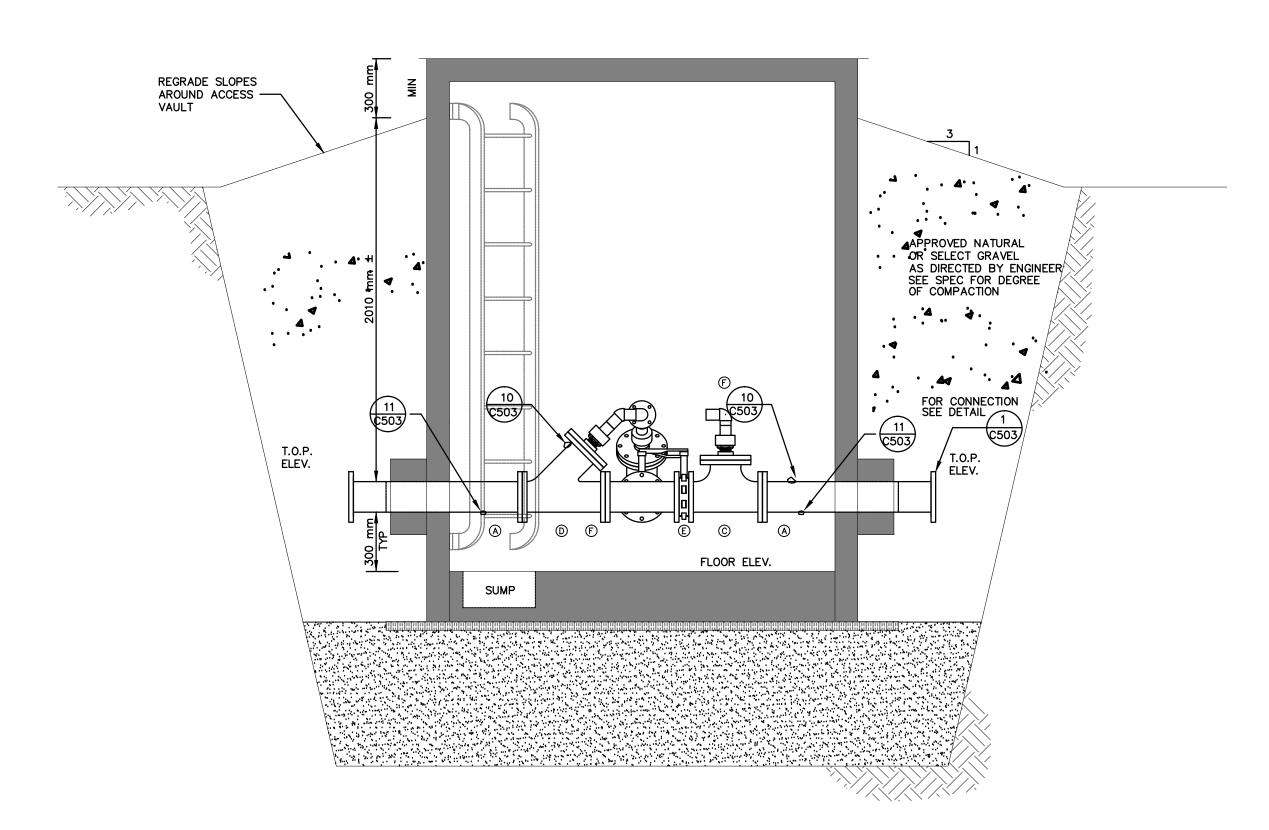Contractor: SANAQATIIT CONSTRUCTION Construction Certification Date: MARCH 12, 2015


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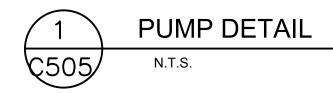
POTABLE WATER SYSTEM PHASE I


Cambridge Bay, NU

ACCESS VAULT PIPING LAYOUT

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Issued		Ву	Appd.	YY.MM.DD
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PLAN OF AS-BUILT DRAWING

Contractor: SANAQATIIT CONSTRUCTION
Construction Certification Date: MARCH 12, 2015

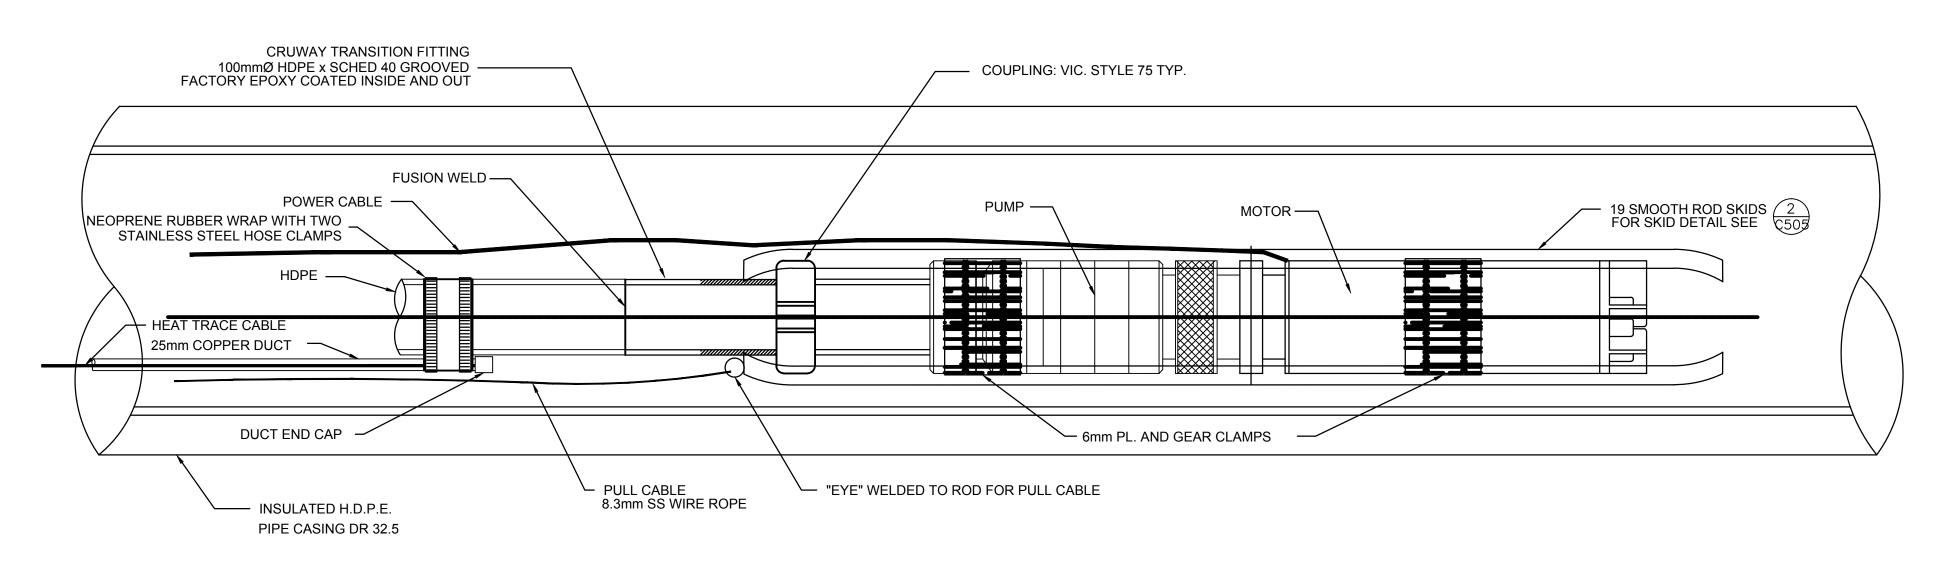Client/Project

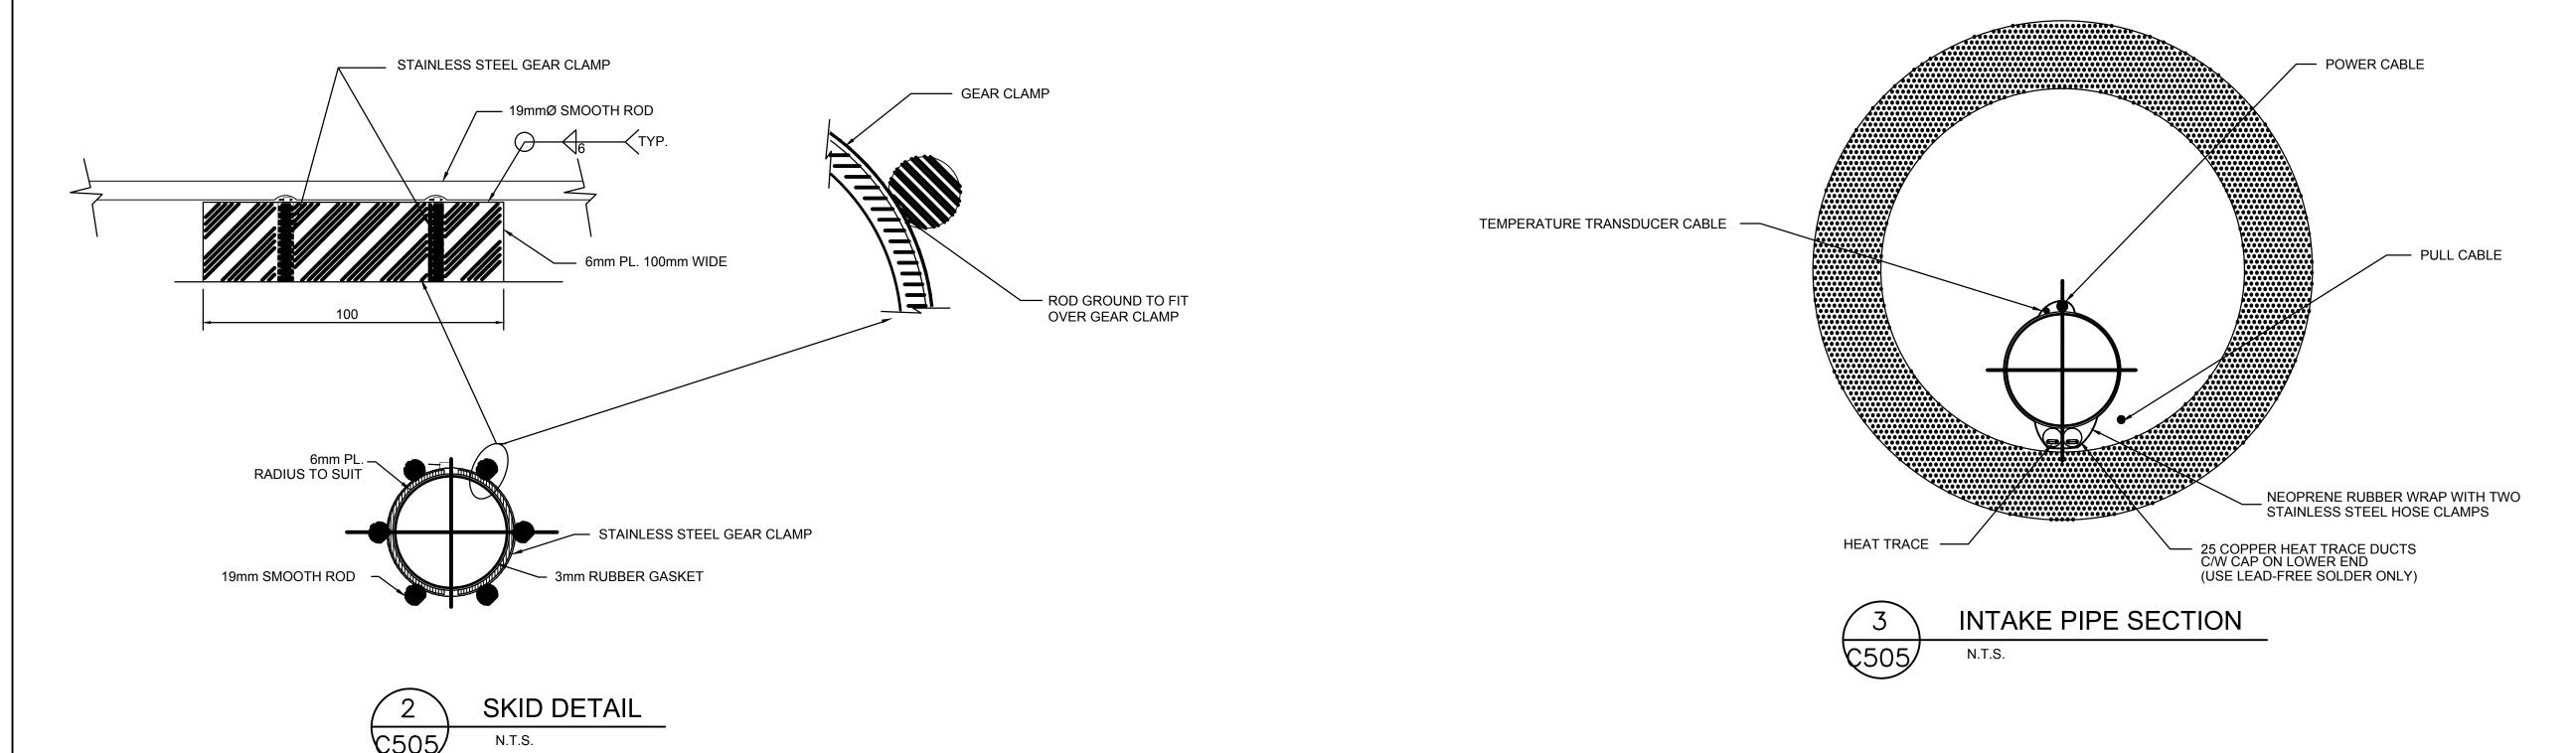
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POTABLE WATER SYSTEM PHASE I

Cambridge Bay, NU


PUMP & DISCHARGE PIPE DETAILS


•	Project No. 1449-01252	Scale N.T.S.	
•	Drawing No.	Sheet	Revision
	C-505	10 of 10	0

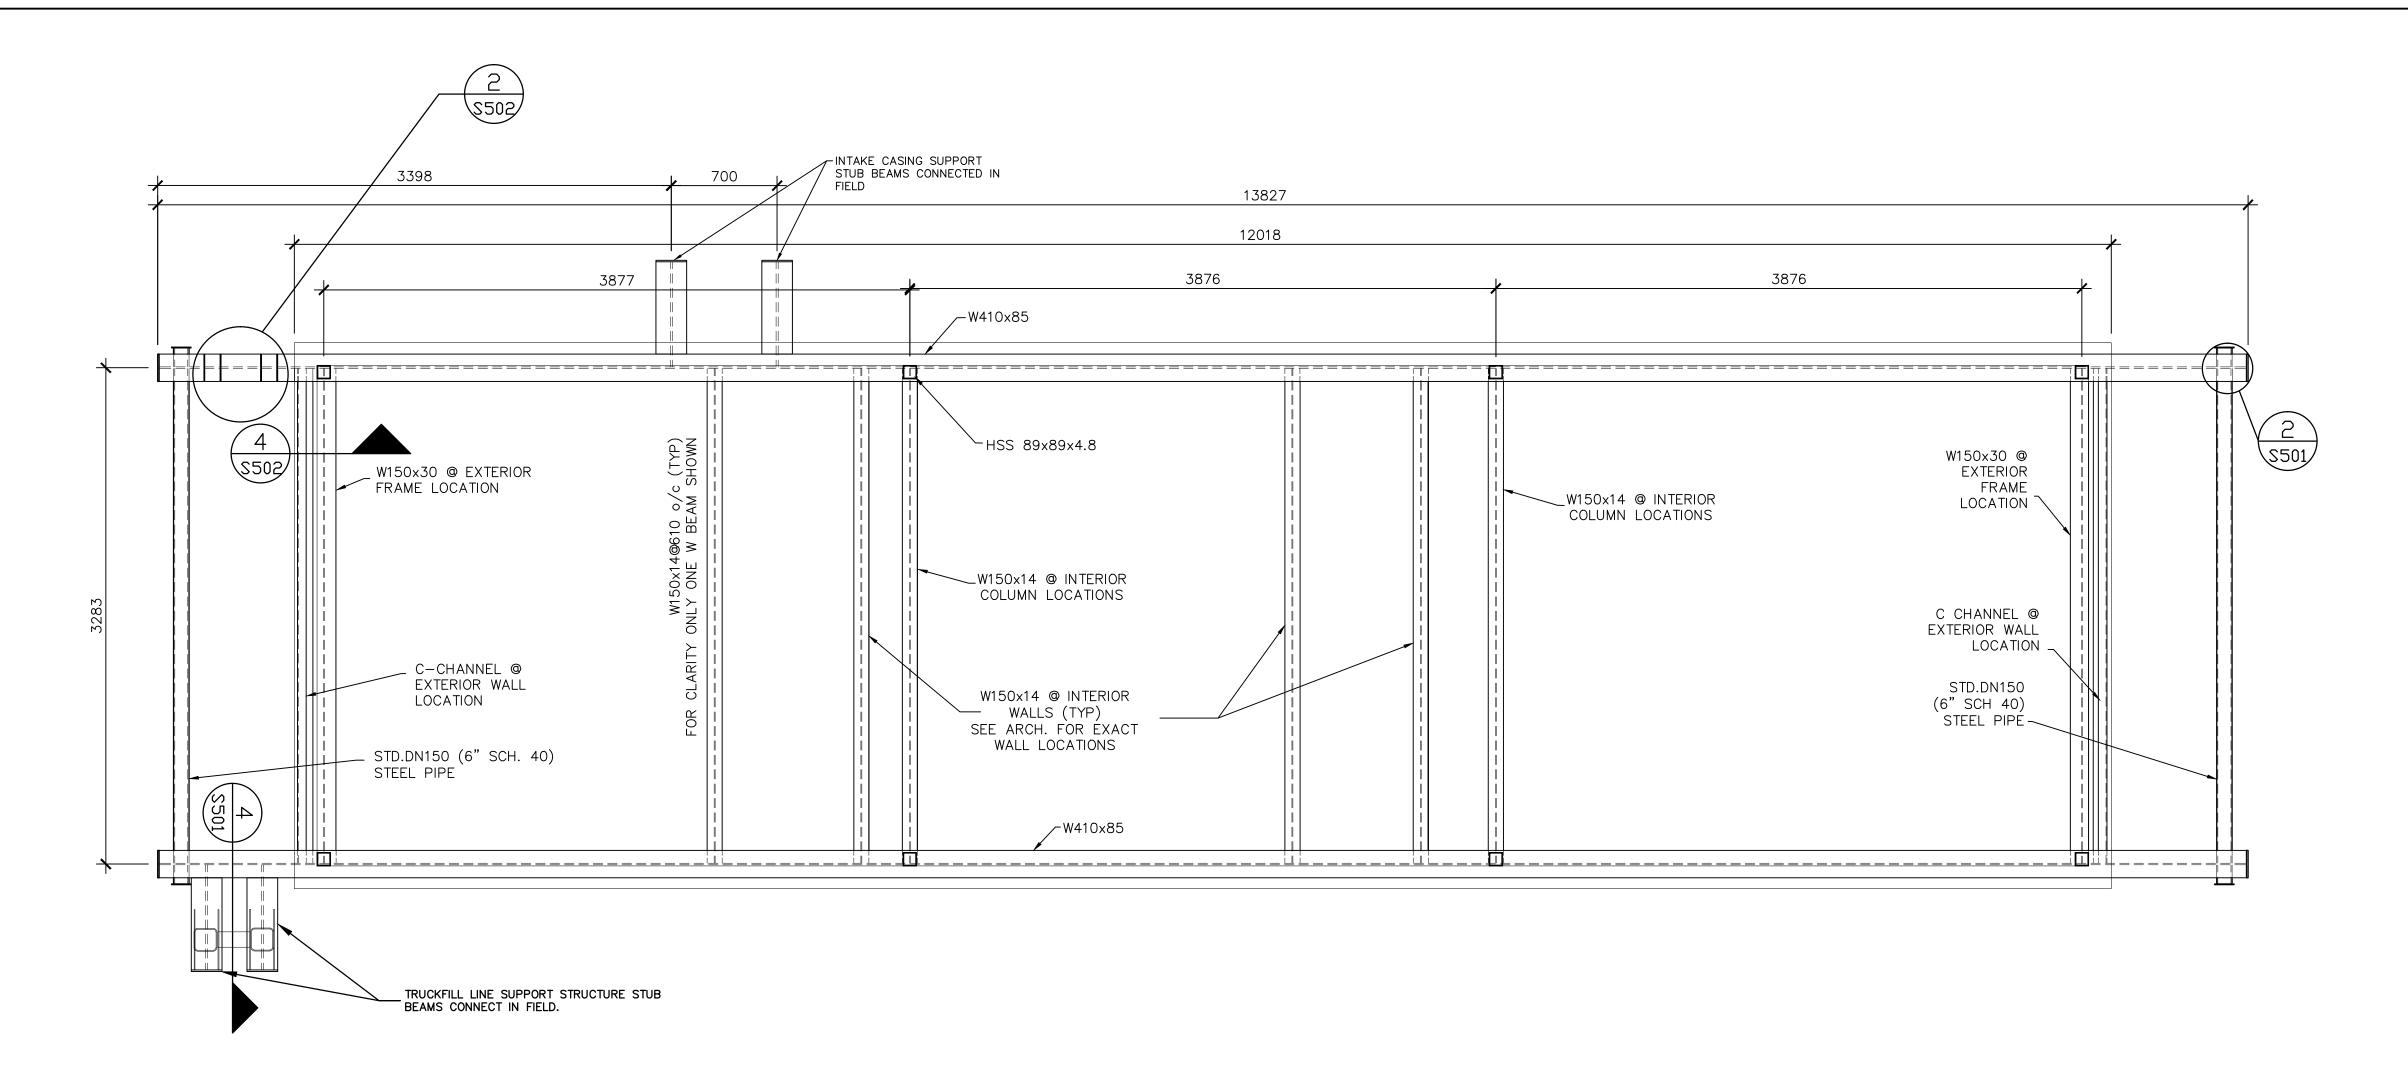

SKID AND SUBFLOOR ASSEMBLY

S501 SCALE 1:25

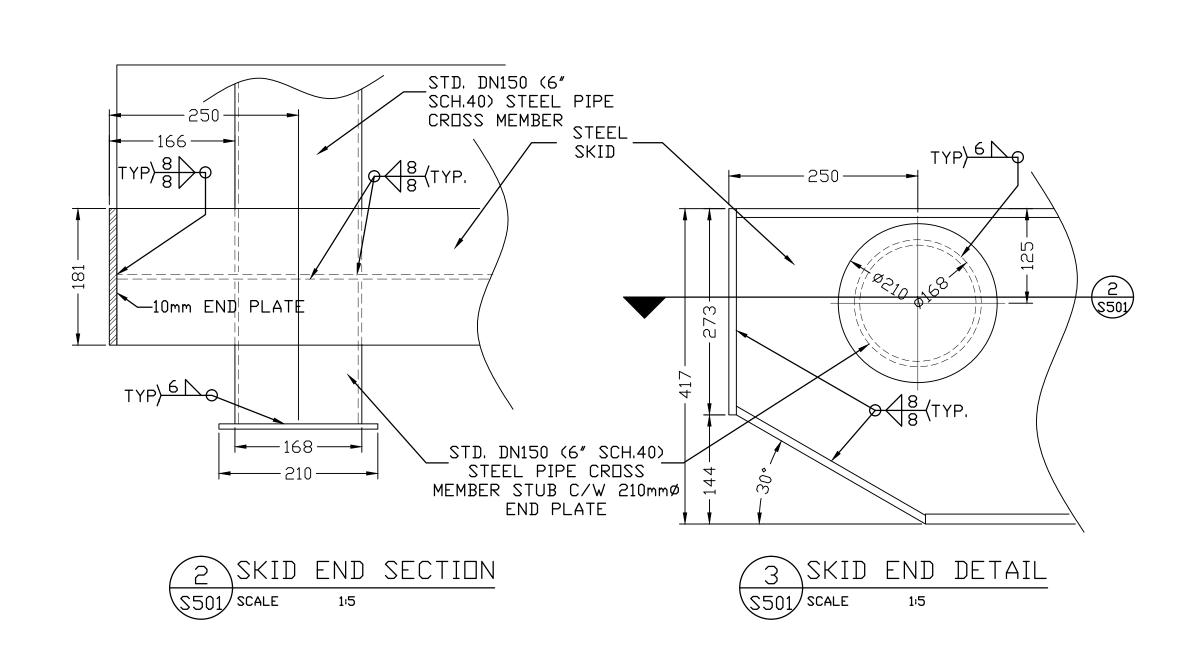

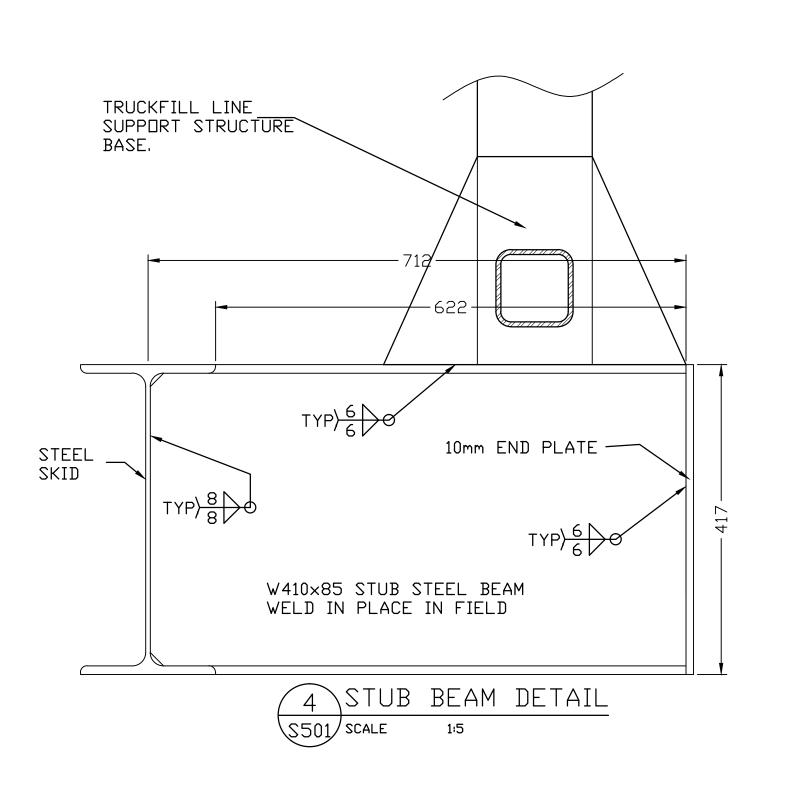



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Walter Orr P.Eng.

Legend

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Revision		Ву	Appd.	YY.M
ISSUED FOR AS-BUILT		KK		16.0
ISSUED FOR CONSTRUCTION		AF	WO	12.0
99%SUB.		K.K.	W.O.	12.02
50%SUB.		J.D.	W.O.	12.01
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File Name:		_	_	_
	Dwn.	Chkd.	Dsgn.	YY.M
Permit-Seal				

PLAN OF AS-BUILT DRAWING

Contractor: SANAQATIIT CONSTRUCTION

Construction Certification Date: MARCH 12, 2015

Client/Project

Goverment of Nunavut

POTABLE WATER SYSTEM PHASE 1


Cambridge Bay, NU

SKID ,SUBFLOOR LAYOUT

AND DETAILS

Project No. 144901252	Scale AS NOTED	
Drawing No.	Sheet	Revision
S-501	1 of 6	0

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Structural

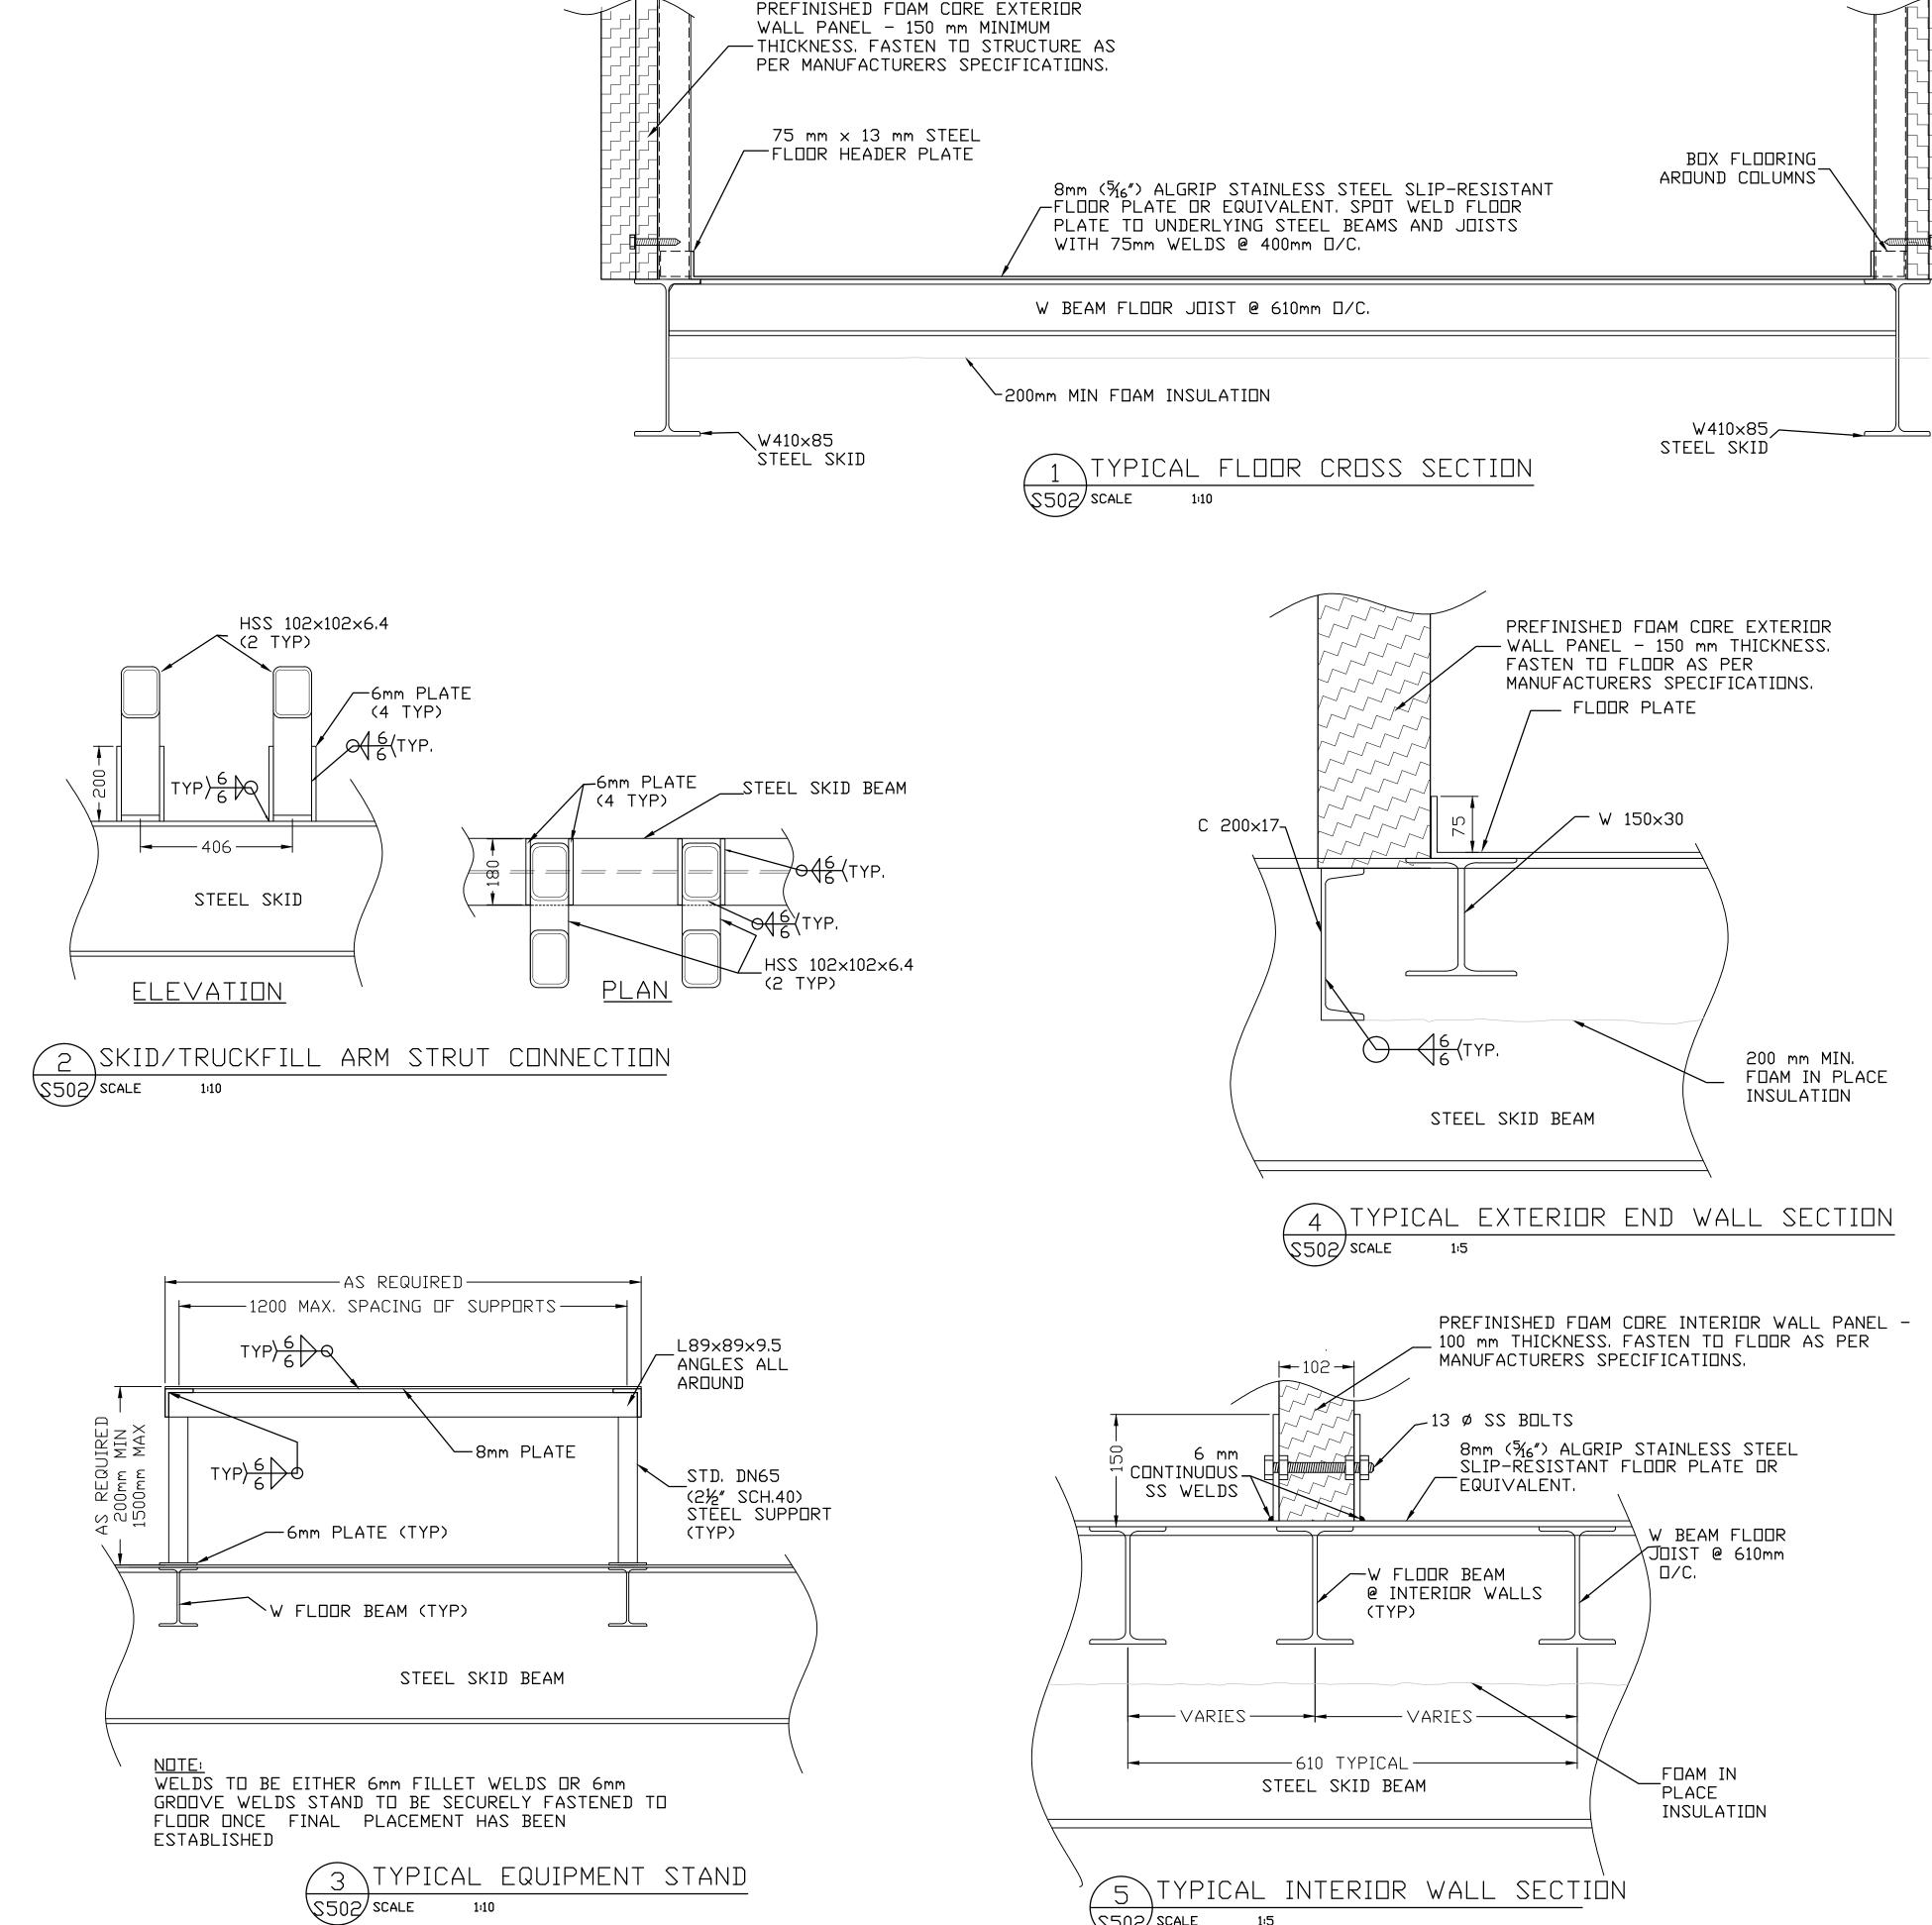Walter Orr P.Eng.

Legend

K.K. W.O. 12.03.30 ISSUED FOR TENDER By Appd. YY.MM.DD Revision ISSUED FOR AS-BUILT KK WO 16.03.16 ISSUED FOR CONSTRUCTION AF WO 12.09.06 K.K. W.O. 12.02.02 99%SUB. 50%SUB. J.D. W.O. 12.01.18 By Appd. YY.MM.DD Issued File Name: Dwn. Chkd. Dsgn. YY.MM.DD

Permit-Seal

PLAN OF AS-BUILT DRAWING Contractor: SANAQATIIT CONSTRUCTION

Construction Certification Date: MARCH 12, 2015

Client/Project


Goverment of Nunavut


POTABLE WATER SYSTEM PHASE 1

Cambridge Bay, NU

STRUCTURAL DETAILS

Project No. 144901252	Scale AS NOTED	
Drawing No.	Sheet	Revision
S-502	2 of 6	0

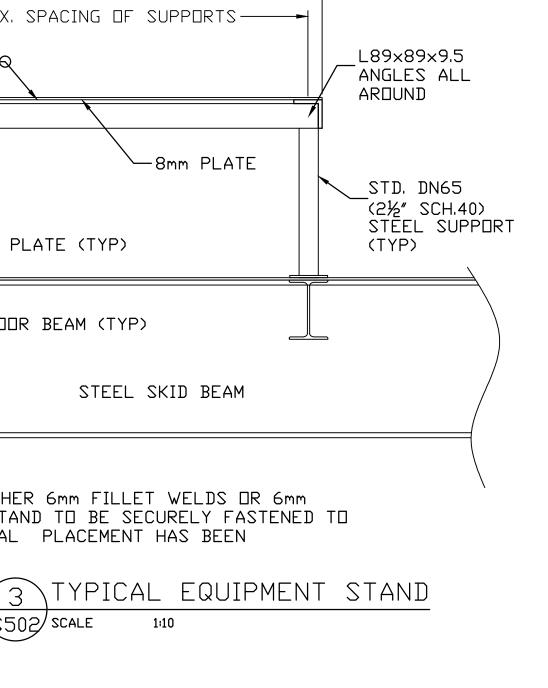

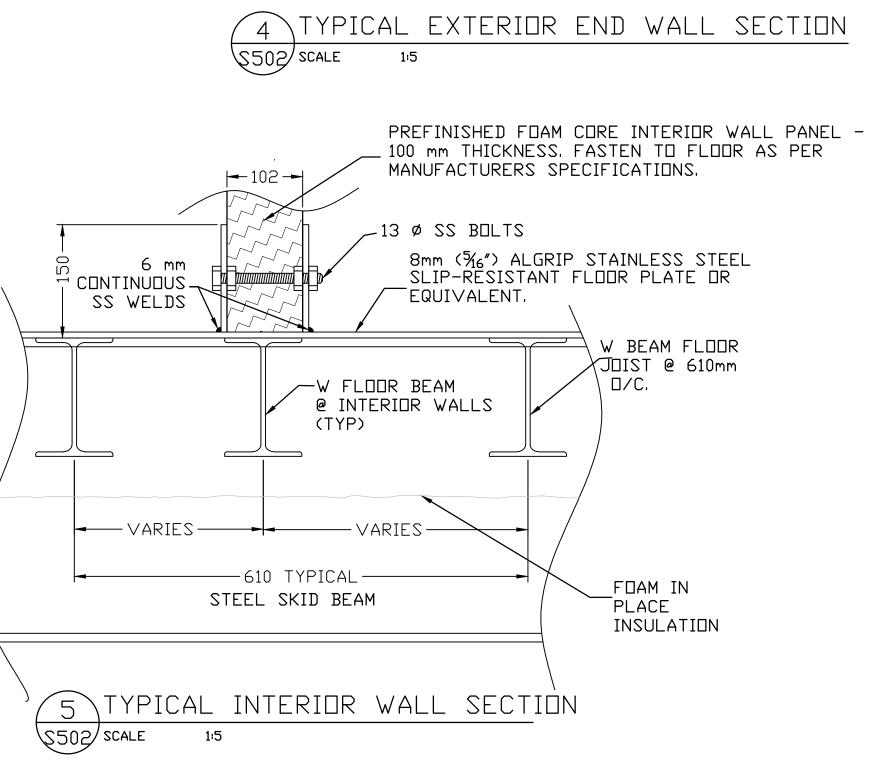

150 STEEL PIPE -SCHEDULE 40 FILLED WITH CONCRETE (SEE NOTE 1> FINISH GRADE 460mmø SONOTUBE -FILLED WITH CONCRETE (SEE NOTE 1> WIRE MESH REINFORCING 152 × $152 \times MW18.7 \times$ MW18.7 ← 40 CLEAR 1. ALL CONCRETE SHALL HAVE 28 DAY COMPRESSIVE STRENGTH OF 25 MPa. SLUMP OF 75 mm+/-10%, AIR ENTRANCE 5-7% AND MAXIMUM AGGREGATE SIZE OF 20mm, CONCRETE QUALITY CONTROL TESTING MUST BE

↓ PIPE & S□N□TUBE

FINISHED SMOOTH


BANDS. (SEE NOTE


CONCRETE CAP

REFLECTIVE

COMPLETED BY QUALIFIED PERSONNEL AND REPORTS TO BE SUBMITTED TO THE ENGINEER. 2. BOLLARD TO BE PAINTED YELLOW WITH REFLECTIVE BANDS.

TYPICAL BOLLARD DETAIL \$502 SCALE 1:10

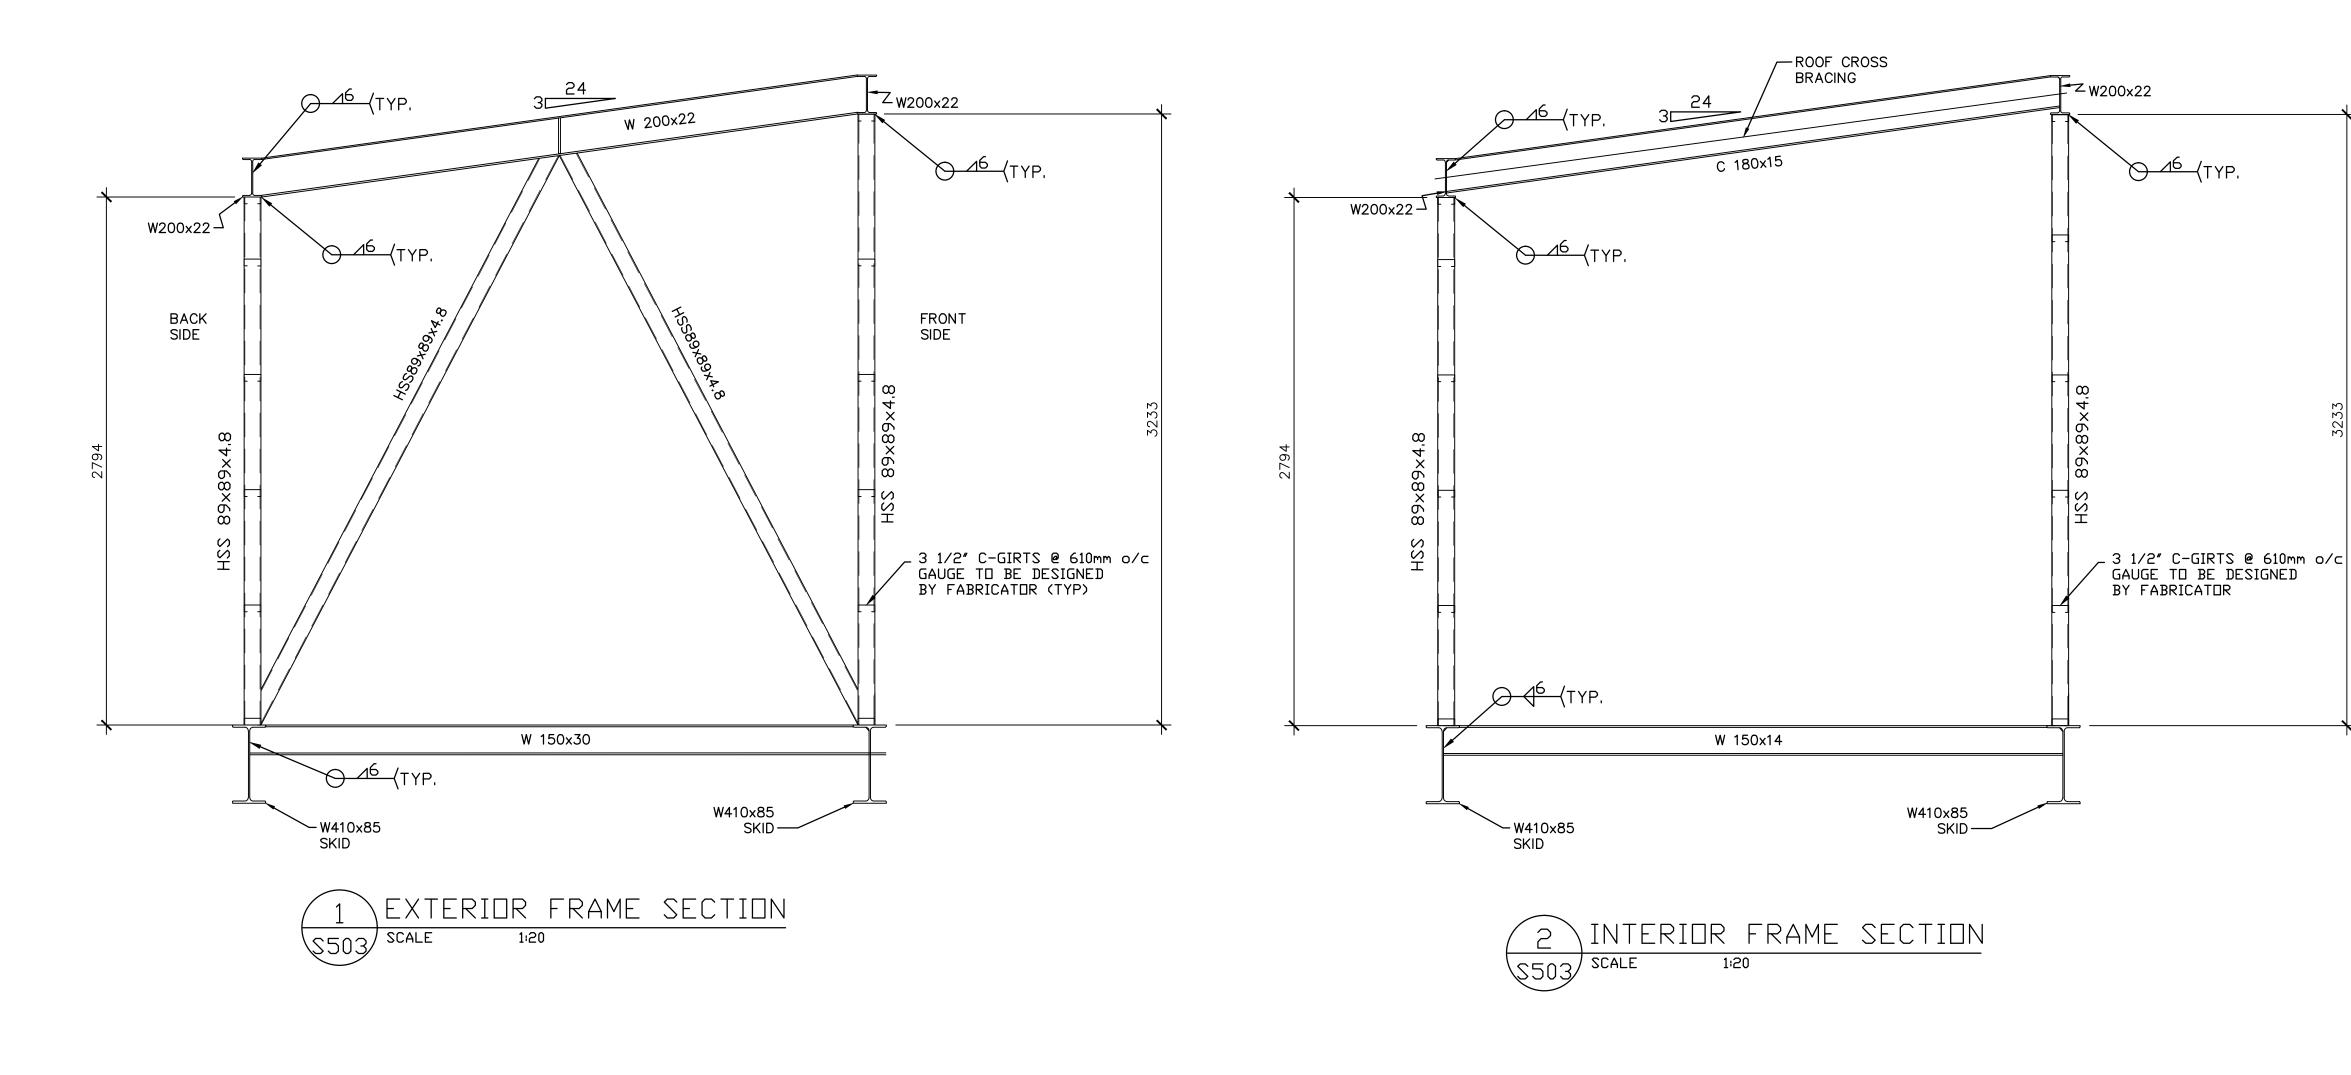

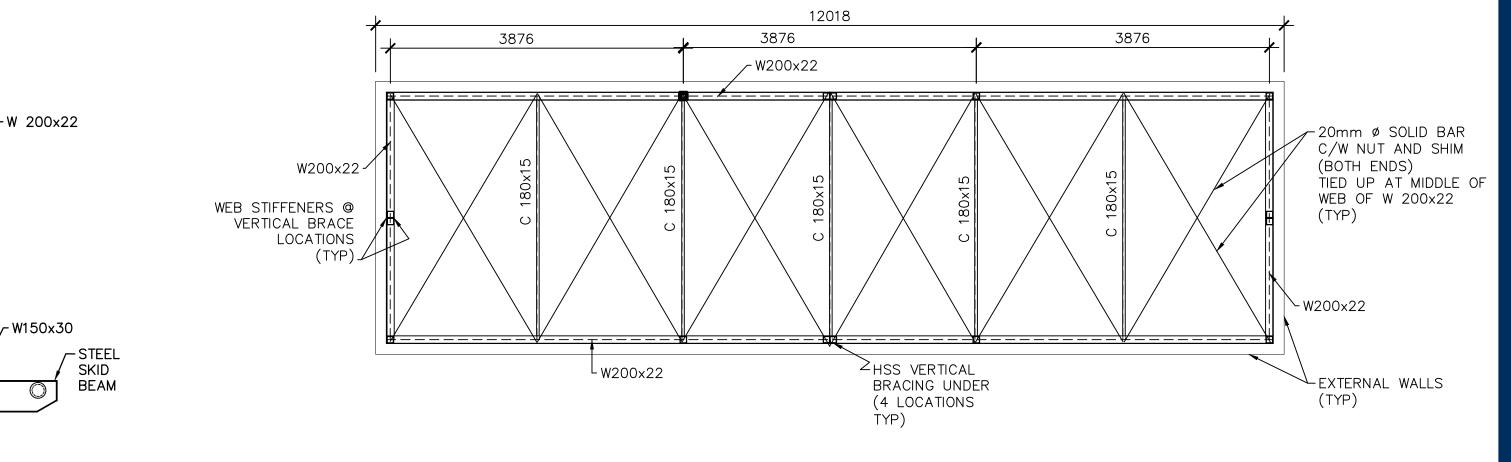

BRACING ASSEMBLY

NOTE: ALL DIMENSIONS ARE APPROXIMATE . FOR CORRECT BUILDING SIZE SEE ARCHITECTURAL DRAWINGS.

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Structural

Walter Orr P.Eng.

Legend

Notes

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Revision	By	W.O. Appd.	YY.MM.DI
ISSUED FOR AS-BUILT	KK	WO	16.03.16
ISSUED FOR CONSTRUCTION	AF	WO	12.09.06
99%SUB.	K.K.	W.O.	12.02.02
50%SUB.	J.D.	W.O.	12.01.18
Issued	By	Appd.	YY.MM.D[

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PLAN OF AS-BUILT DRAWING

Contractor: SANAQATIIT CONSTRUCTION Construction Certification Date: MARCH 12, 2015

Client/Project


Goverment of Nunavut

POTABLE WATER SYSTEM PHASE 1


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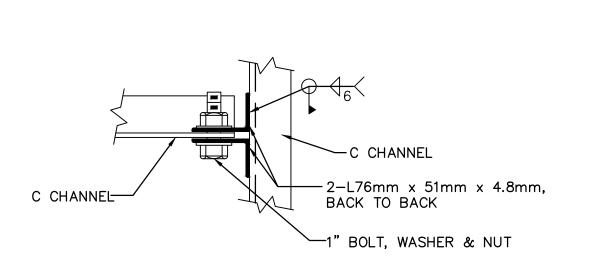
STRUCTURAL SECTIONS

Project No. 144901252	Scale AS NOTED	
Drawing No.	Sheet	Revision
S-503	3 of 6	0

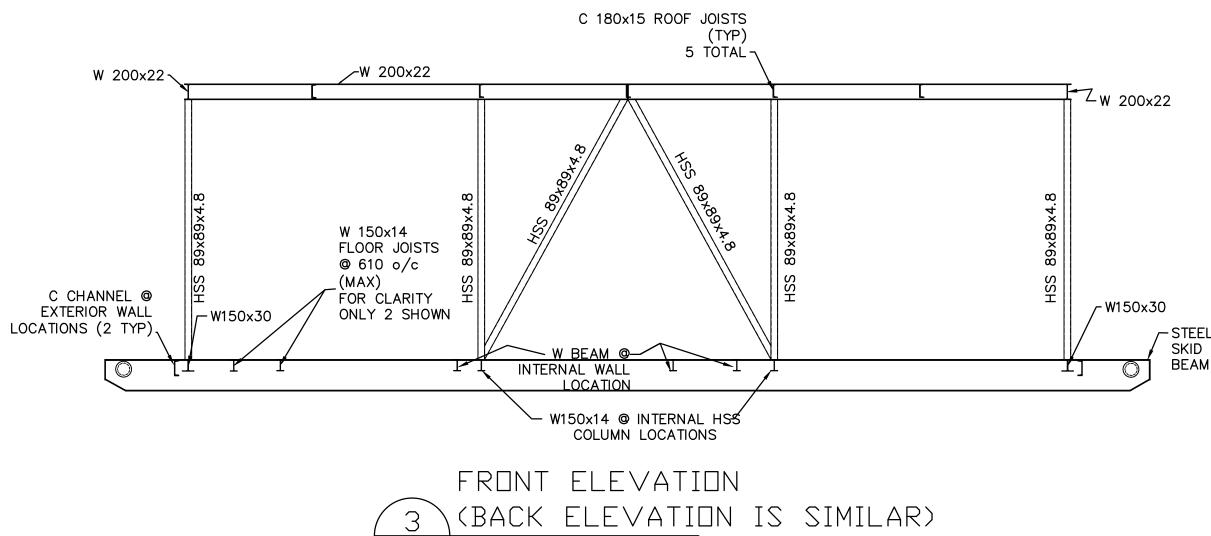


S203 SCALE




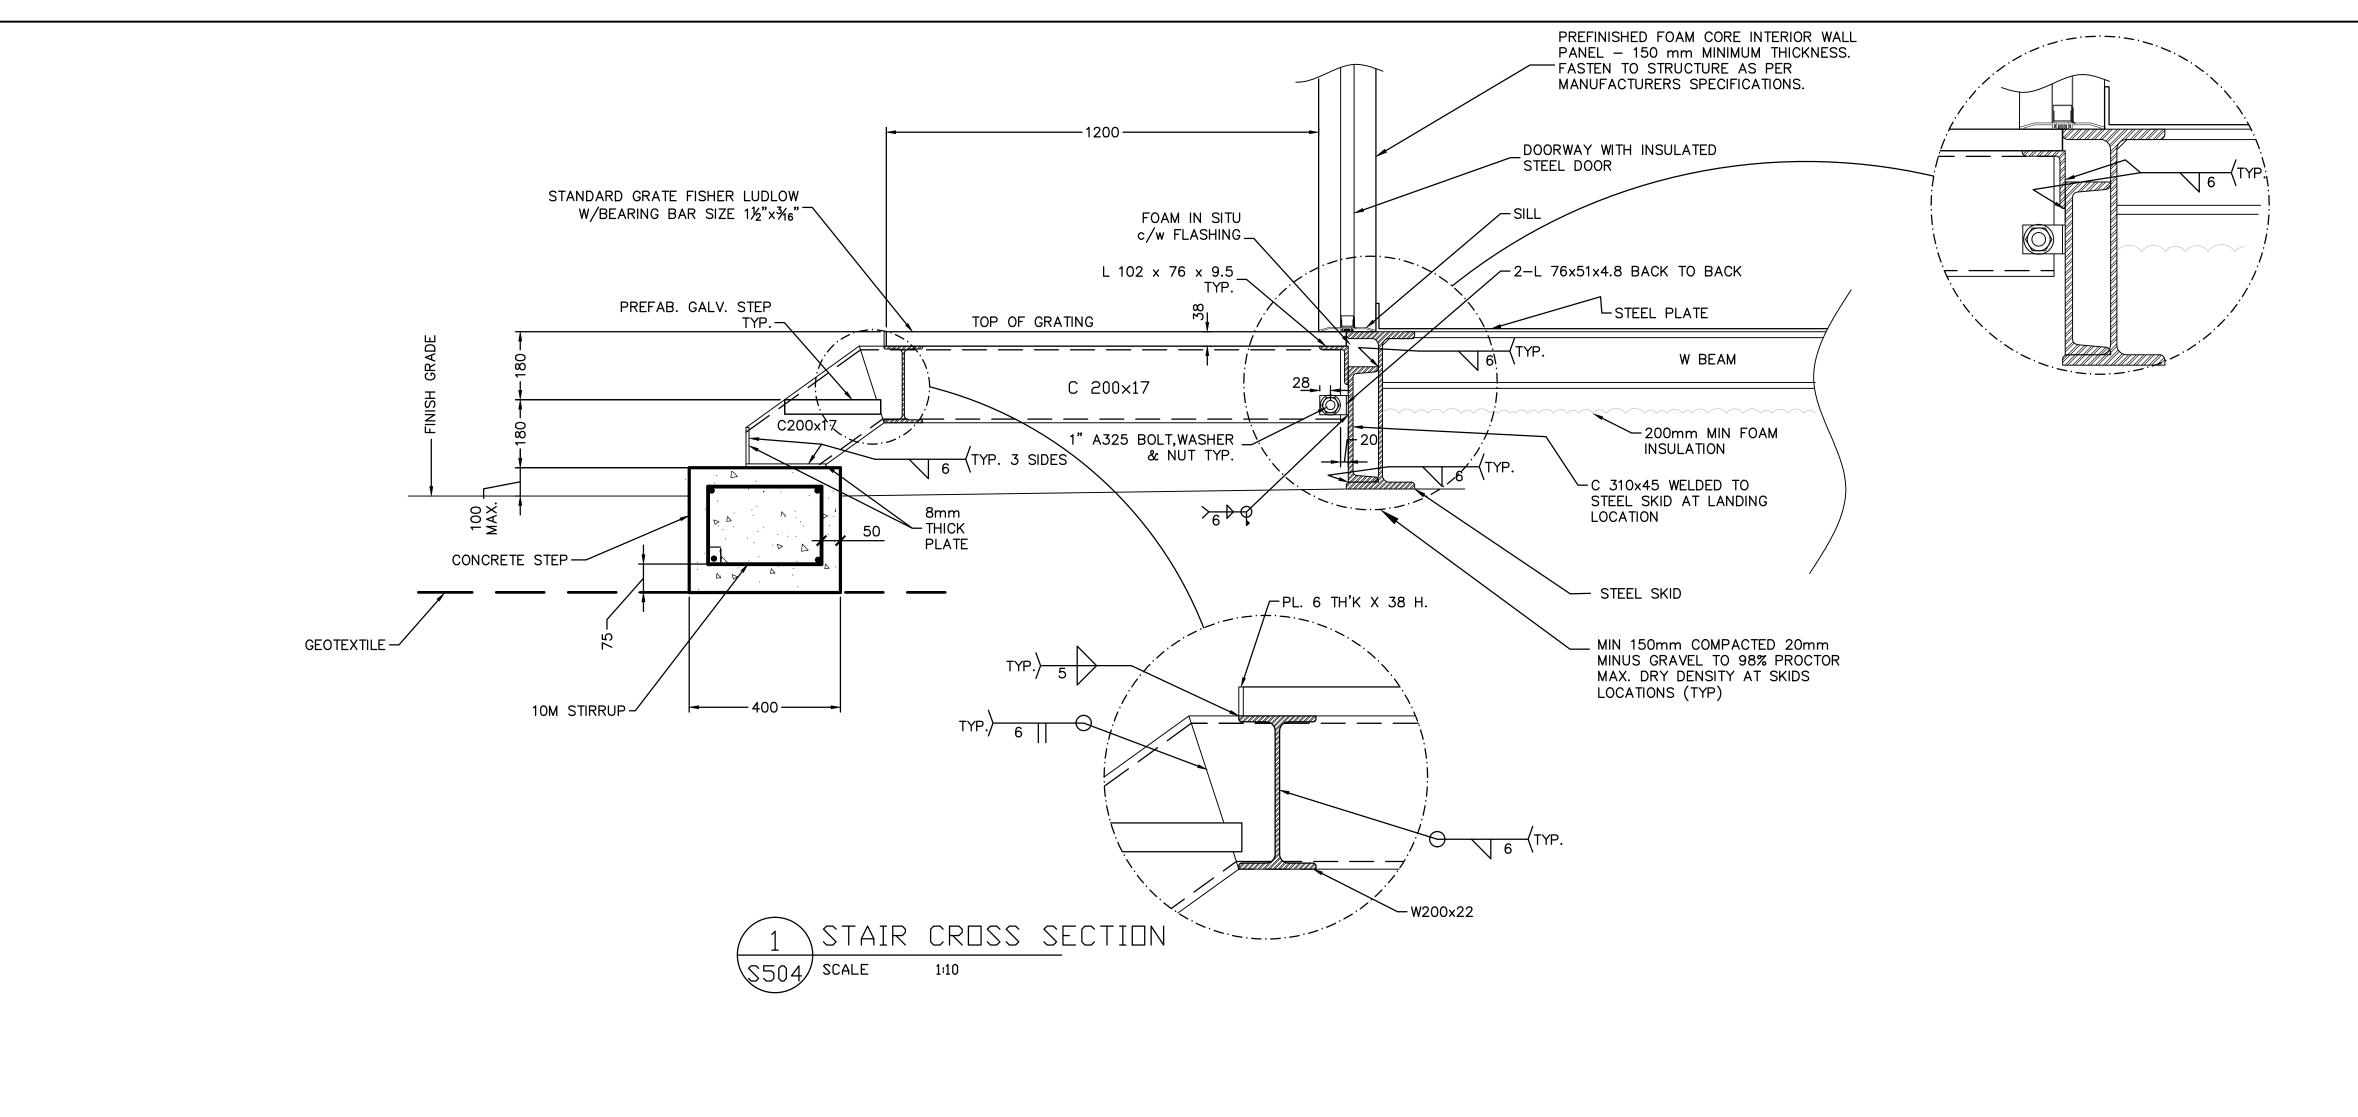

STAIR PINNED CONNECTION PLAN
S504 SCALE N.T.S.

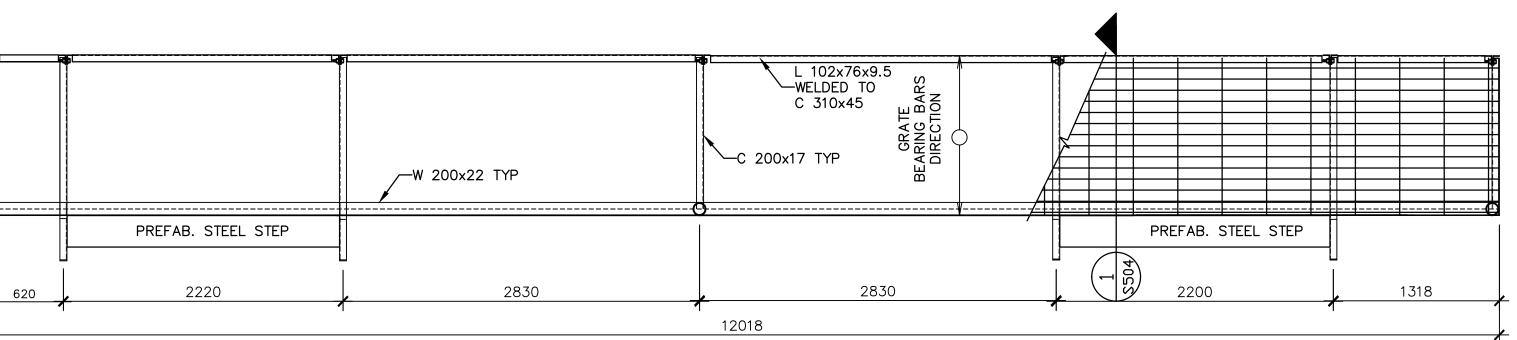

3 PLAN VIEW-LANDING \$504 SCALE 1:30

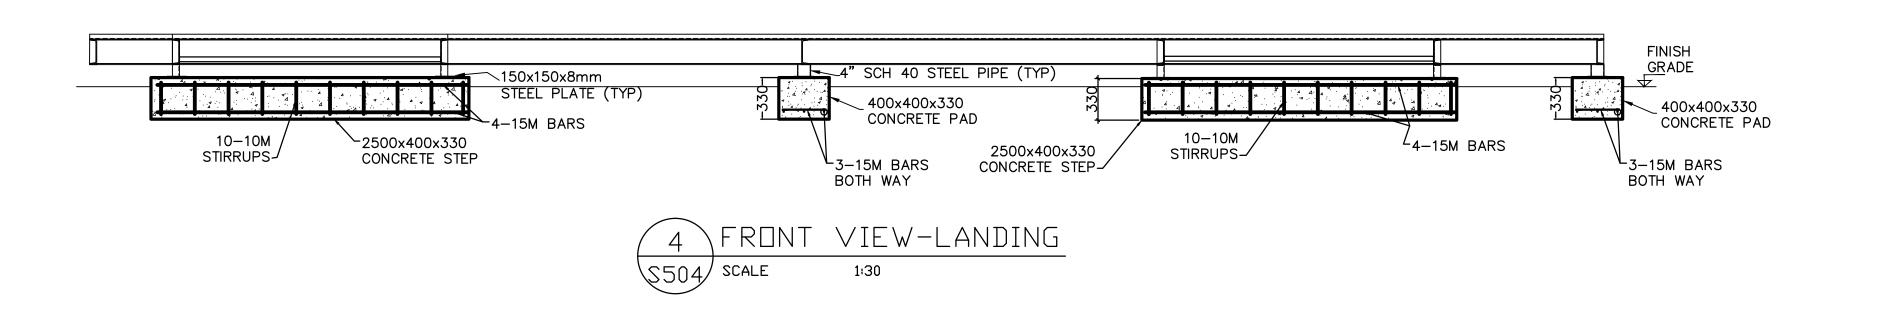



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Revision				
ISSUED FOR AS-BUILT		KK	WO	16.03.16
ISSUED FOR CONSTRUCTION		AF	WO	12.09.06
99%SUB.		K.K.	W.O.	12.02.02
50%SUB.		J.D.	W.O.	12.01.18
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PLAN OF AS-BUILT DRAWING

Contractor: SANAQATIIT CONSTRUCTION
Construction Certification Date: MARCH 12, 2015

Client/Project

Goverment of Nunavut


POTABLE WATER SYSTEM PHASE 1

Cambridge Bay, NU

Title STAIR DETAILS

Project No. 144901252	Scale AS NOTED	
Drawing No.	Sheet	Revision
S-504	4 of 6	0

1449\Acti 6/03/18

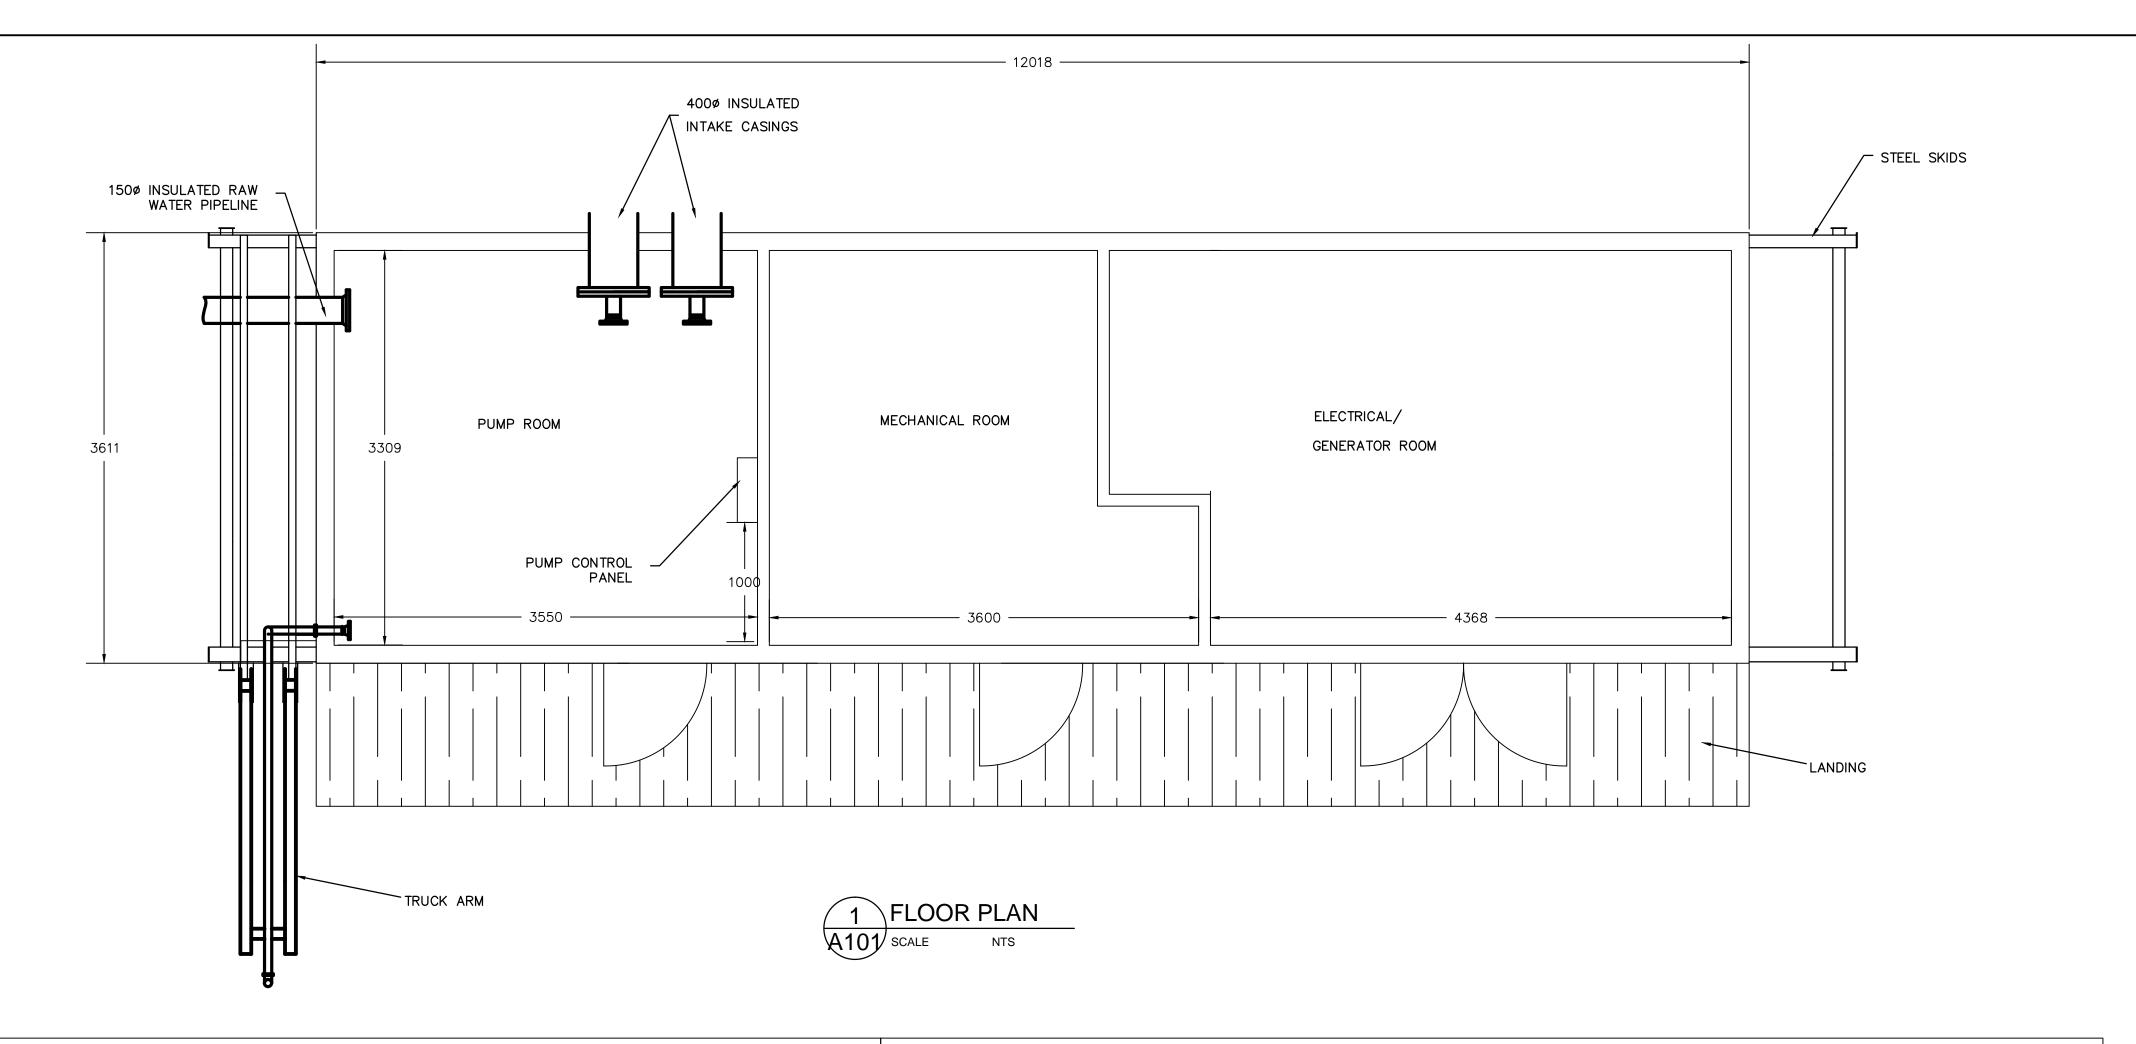

ROOF CONSTRUCTION ASSEMBLIES

R1 ROOF (152 MM, RSI 8.13 / R-46) 152 MM THICK PRE-FINISHED INSULATED METAL ROOF PANEL, PROFILE & CONFIGURATION AS PER EXTERIOR ELEVATIONS, COLOUR; AS PER OWNER MECHANICAL FASTENERS AS PER MANUFACTURER'S SPECIFICATIONS TO STEEL SUPPORT FRAMES AS PER STRUCTURAL DRAWINGS

EXTERIOR WALL CONSTRUCTION ASSEMBLIES

EW1 EXTERIOR WALL (152 MM, RSI 8.13 / R-46)

152 MM THICK PRE-FINISHED INSULATED METAL WALL PANEL, PROFILE & CONFIGURATION AS PER EXTERIOR ELEVATIONS, COLOUR; AS PER OWNER MECHANICAL FASTENERS AS PER MANUFACTURER'S SPECIFICATIONS TO STEEL SUPPORT FRAMES AS PER STRUCTURAL DRAWINGS

FLOOR CONSTRUCTION ASSEMBLIES

F1 MAIN FLOOR - NONCOMBUSTIBLE CONSTRUCTION (230 MM, RSI 8.45 / R-48)

8 MM STAINLESS STEEL SLIP RESISTANT FLOOR PLATE, ALL SEAMS WELDED W150x JOISTS @ 610 MM O.C. WELDED TO STEEL BEAMS AS PER STRUCTURAL DRAWINGS. 203 MM POLYURETHANE SPRAY FOAMED REQUIRED FOR TOTAL FLOOR SYSTEM, DEPTH OF 230mm

SPUN OLEFIN WEATHER BARRIER 19 MM PRE-FINISHED METAL CLADDING SOFFIT LINER PANEL, MECHANICAL FASTENED AS PER MANUFACTURER

INTERIOR WALL CONSTRUCTION ASSEMBLIES

- 1. REFER TO FLOOR PLANS FOR PARTITION LOCATIONS.
- 2. ALL STEEL STUD PARTITIONS TO HAVE MID-HEIGHT CONTINUOUS BRIDGING CHANNEL C/W BRIDGING ANGLE CLIP.
- 3. LOCATE CONTROL JOINTS AT 10M O.C. ON 1500 MODULE OR ABOVE DOOR FRAME CORNER WHEREVER POSSIBLE. 4. PARTITIONS NOT SPECIFICALLY DESIGNATED SHALL BE CONSIDERED TO BE CONSTRUCTED AS A GW1 WALL ASSEMBLY AND EXTEND 150 MM ABOVE FINISHED CEILING.
- 5. ACOUSICALLY SEAL PERIPHERY OF WALL AND ALL PENETRATIONS AIRTIGHT.

INTERIOR WALL CONSTRUCTION ASSEMBLIES

GW1 (89 MM)

89mm THICK PRE-FINISHED PRE-INSULATED METAL WALL PANEL. COLOUR WHITE. MECHANICAL FASTENERS AS PER MANUFACTURER'S SPECIFICATIONS TO STEEL SUPPORT FRAMES AS PER STRUCTURAL DRAWINGS.



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Notes

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Revision		Ву	Appd.	YY.MM.DD
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PLAN OF AS-BUILT DRAWING

Contractor: SANAQATIIT CONSTRUCTION Construction Certification Date: MARCH 12, 2015

Client/Project


GOVERNMENT OF NUNAVUT

POTABLE WATER SYSTEM PHASE I

Cambridge Bay, NU

FLOOR PLAN, ASSEMBLIES, AND SCHEDULES

Project No. 1449-01252	Scale NTS	
Drawing No.	Sheet	Revision
A-101	1 of 3	0

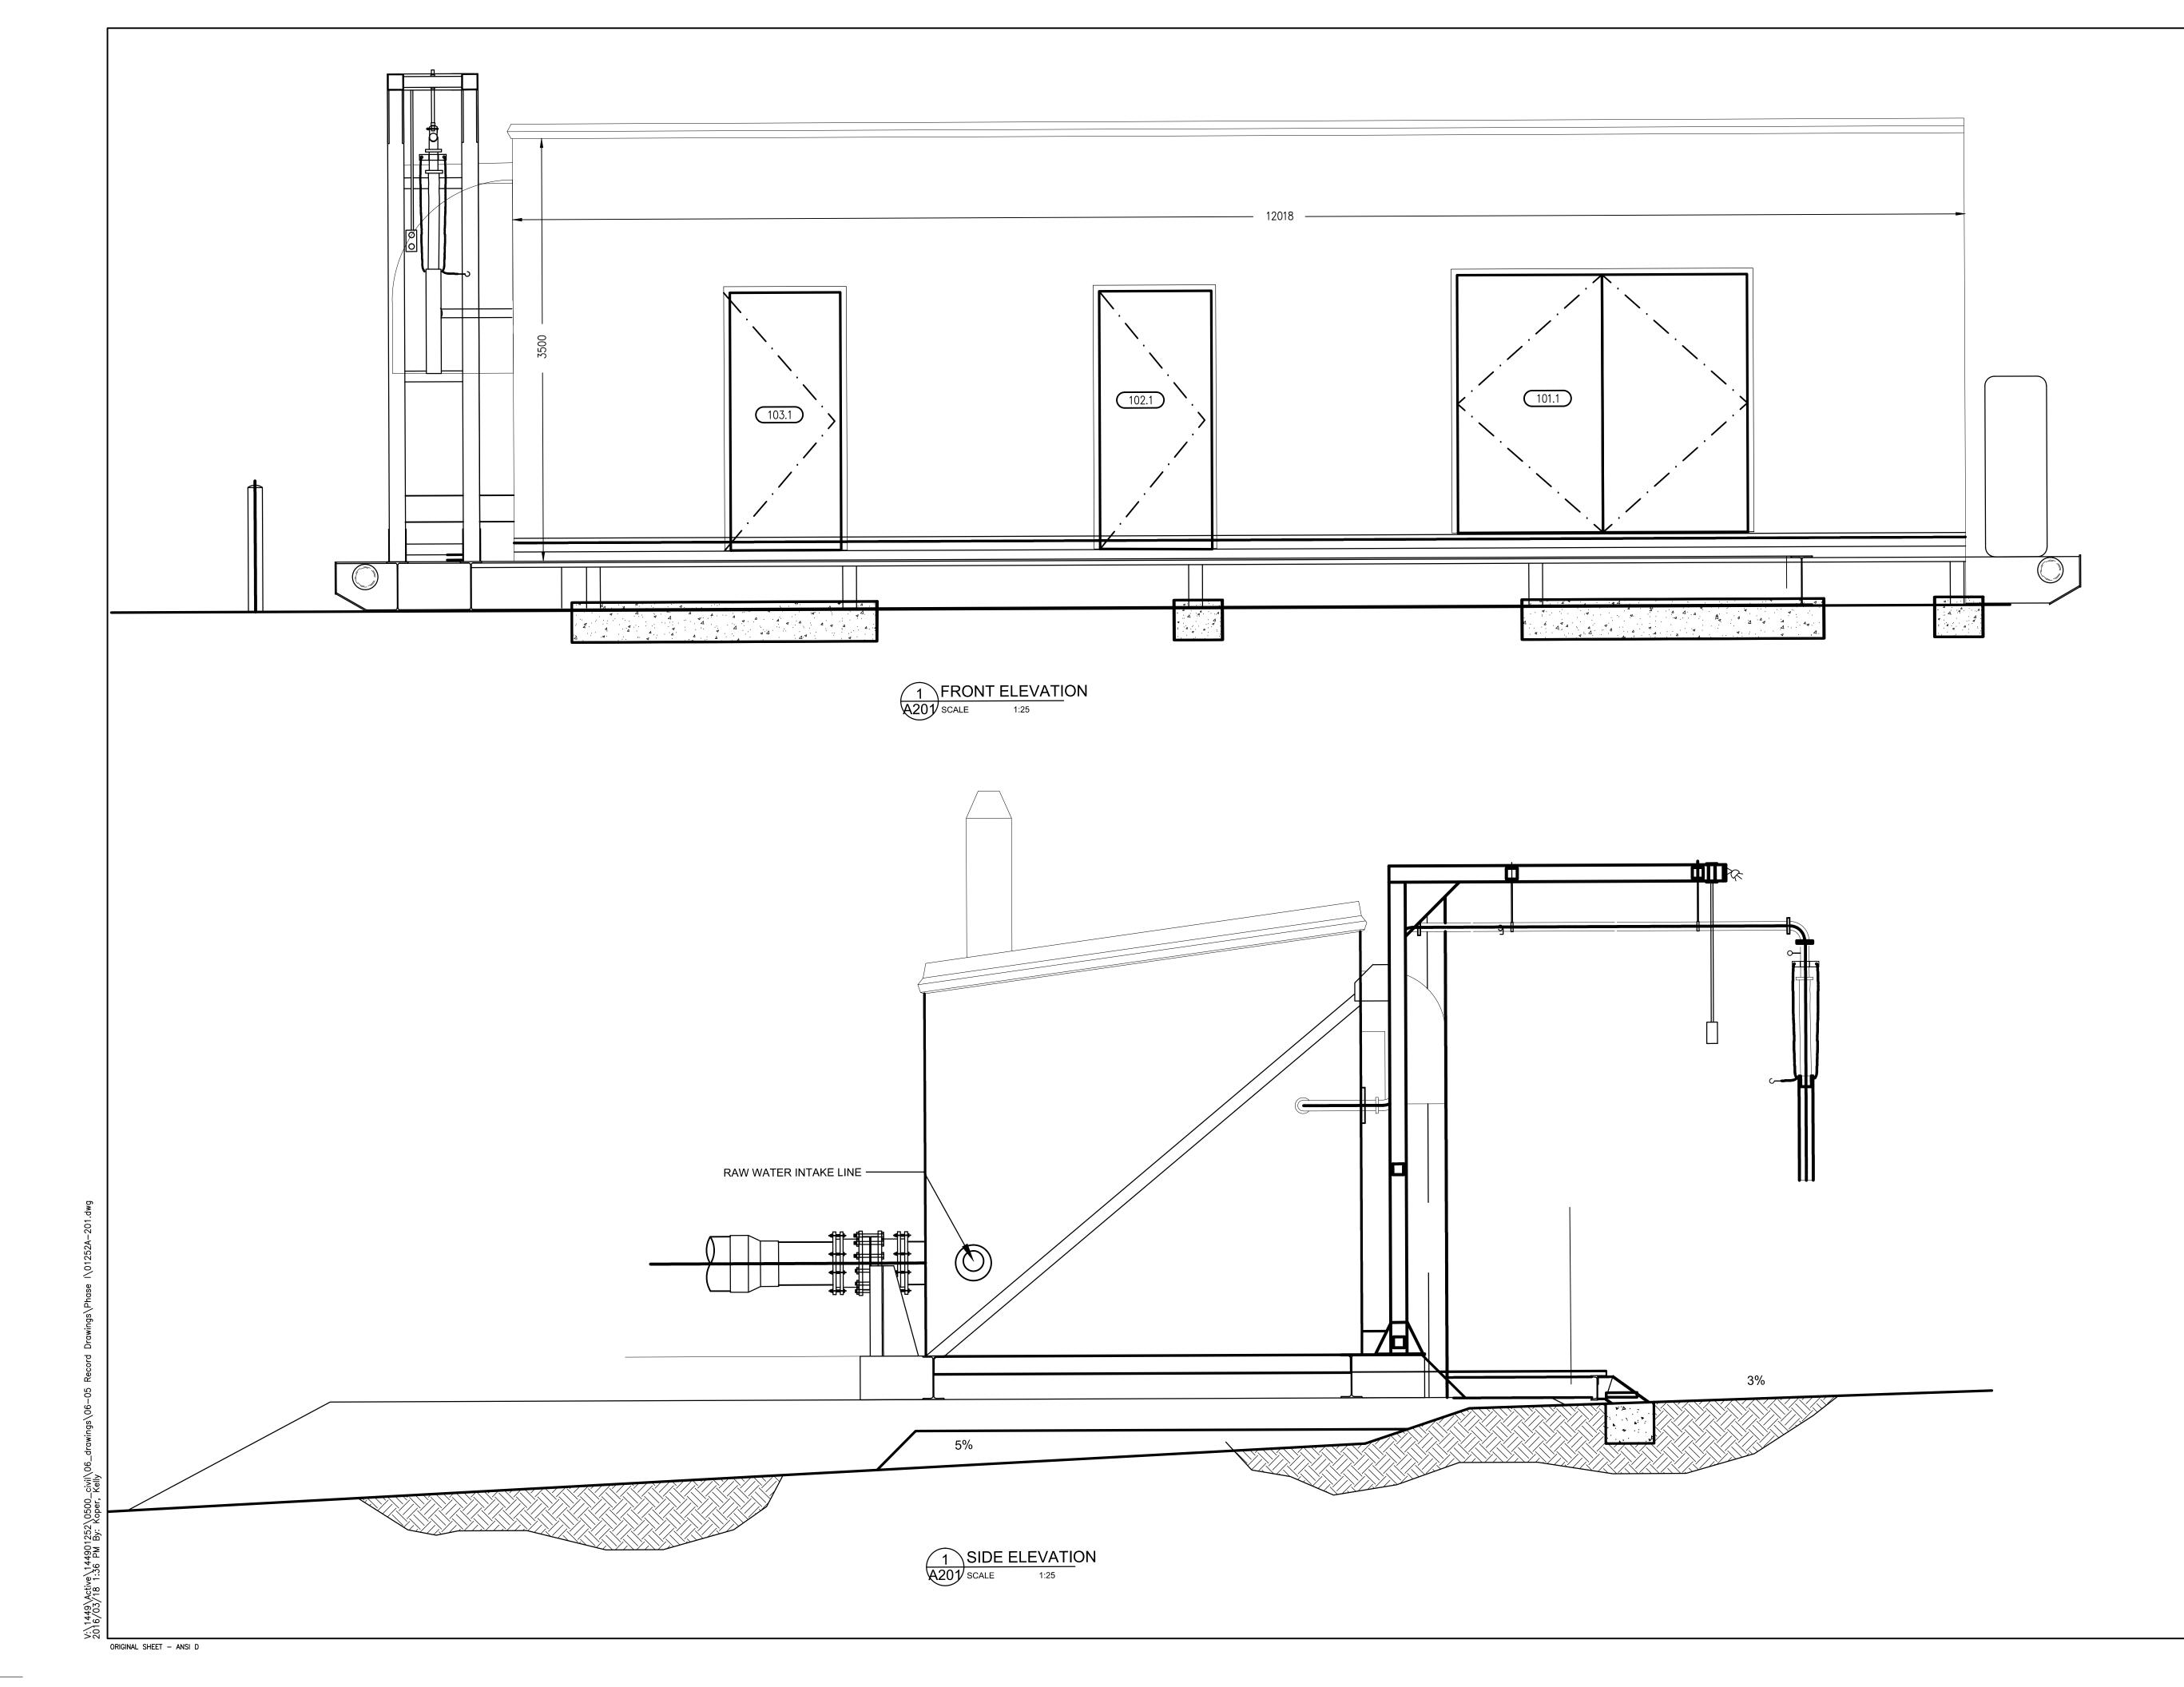



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PLAN OF AS-BUILT DRAWING

Contractor: SANAQATIIT CONSTRUCTION
Construction Certification Date: MARCH 12, 2015

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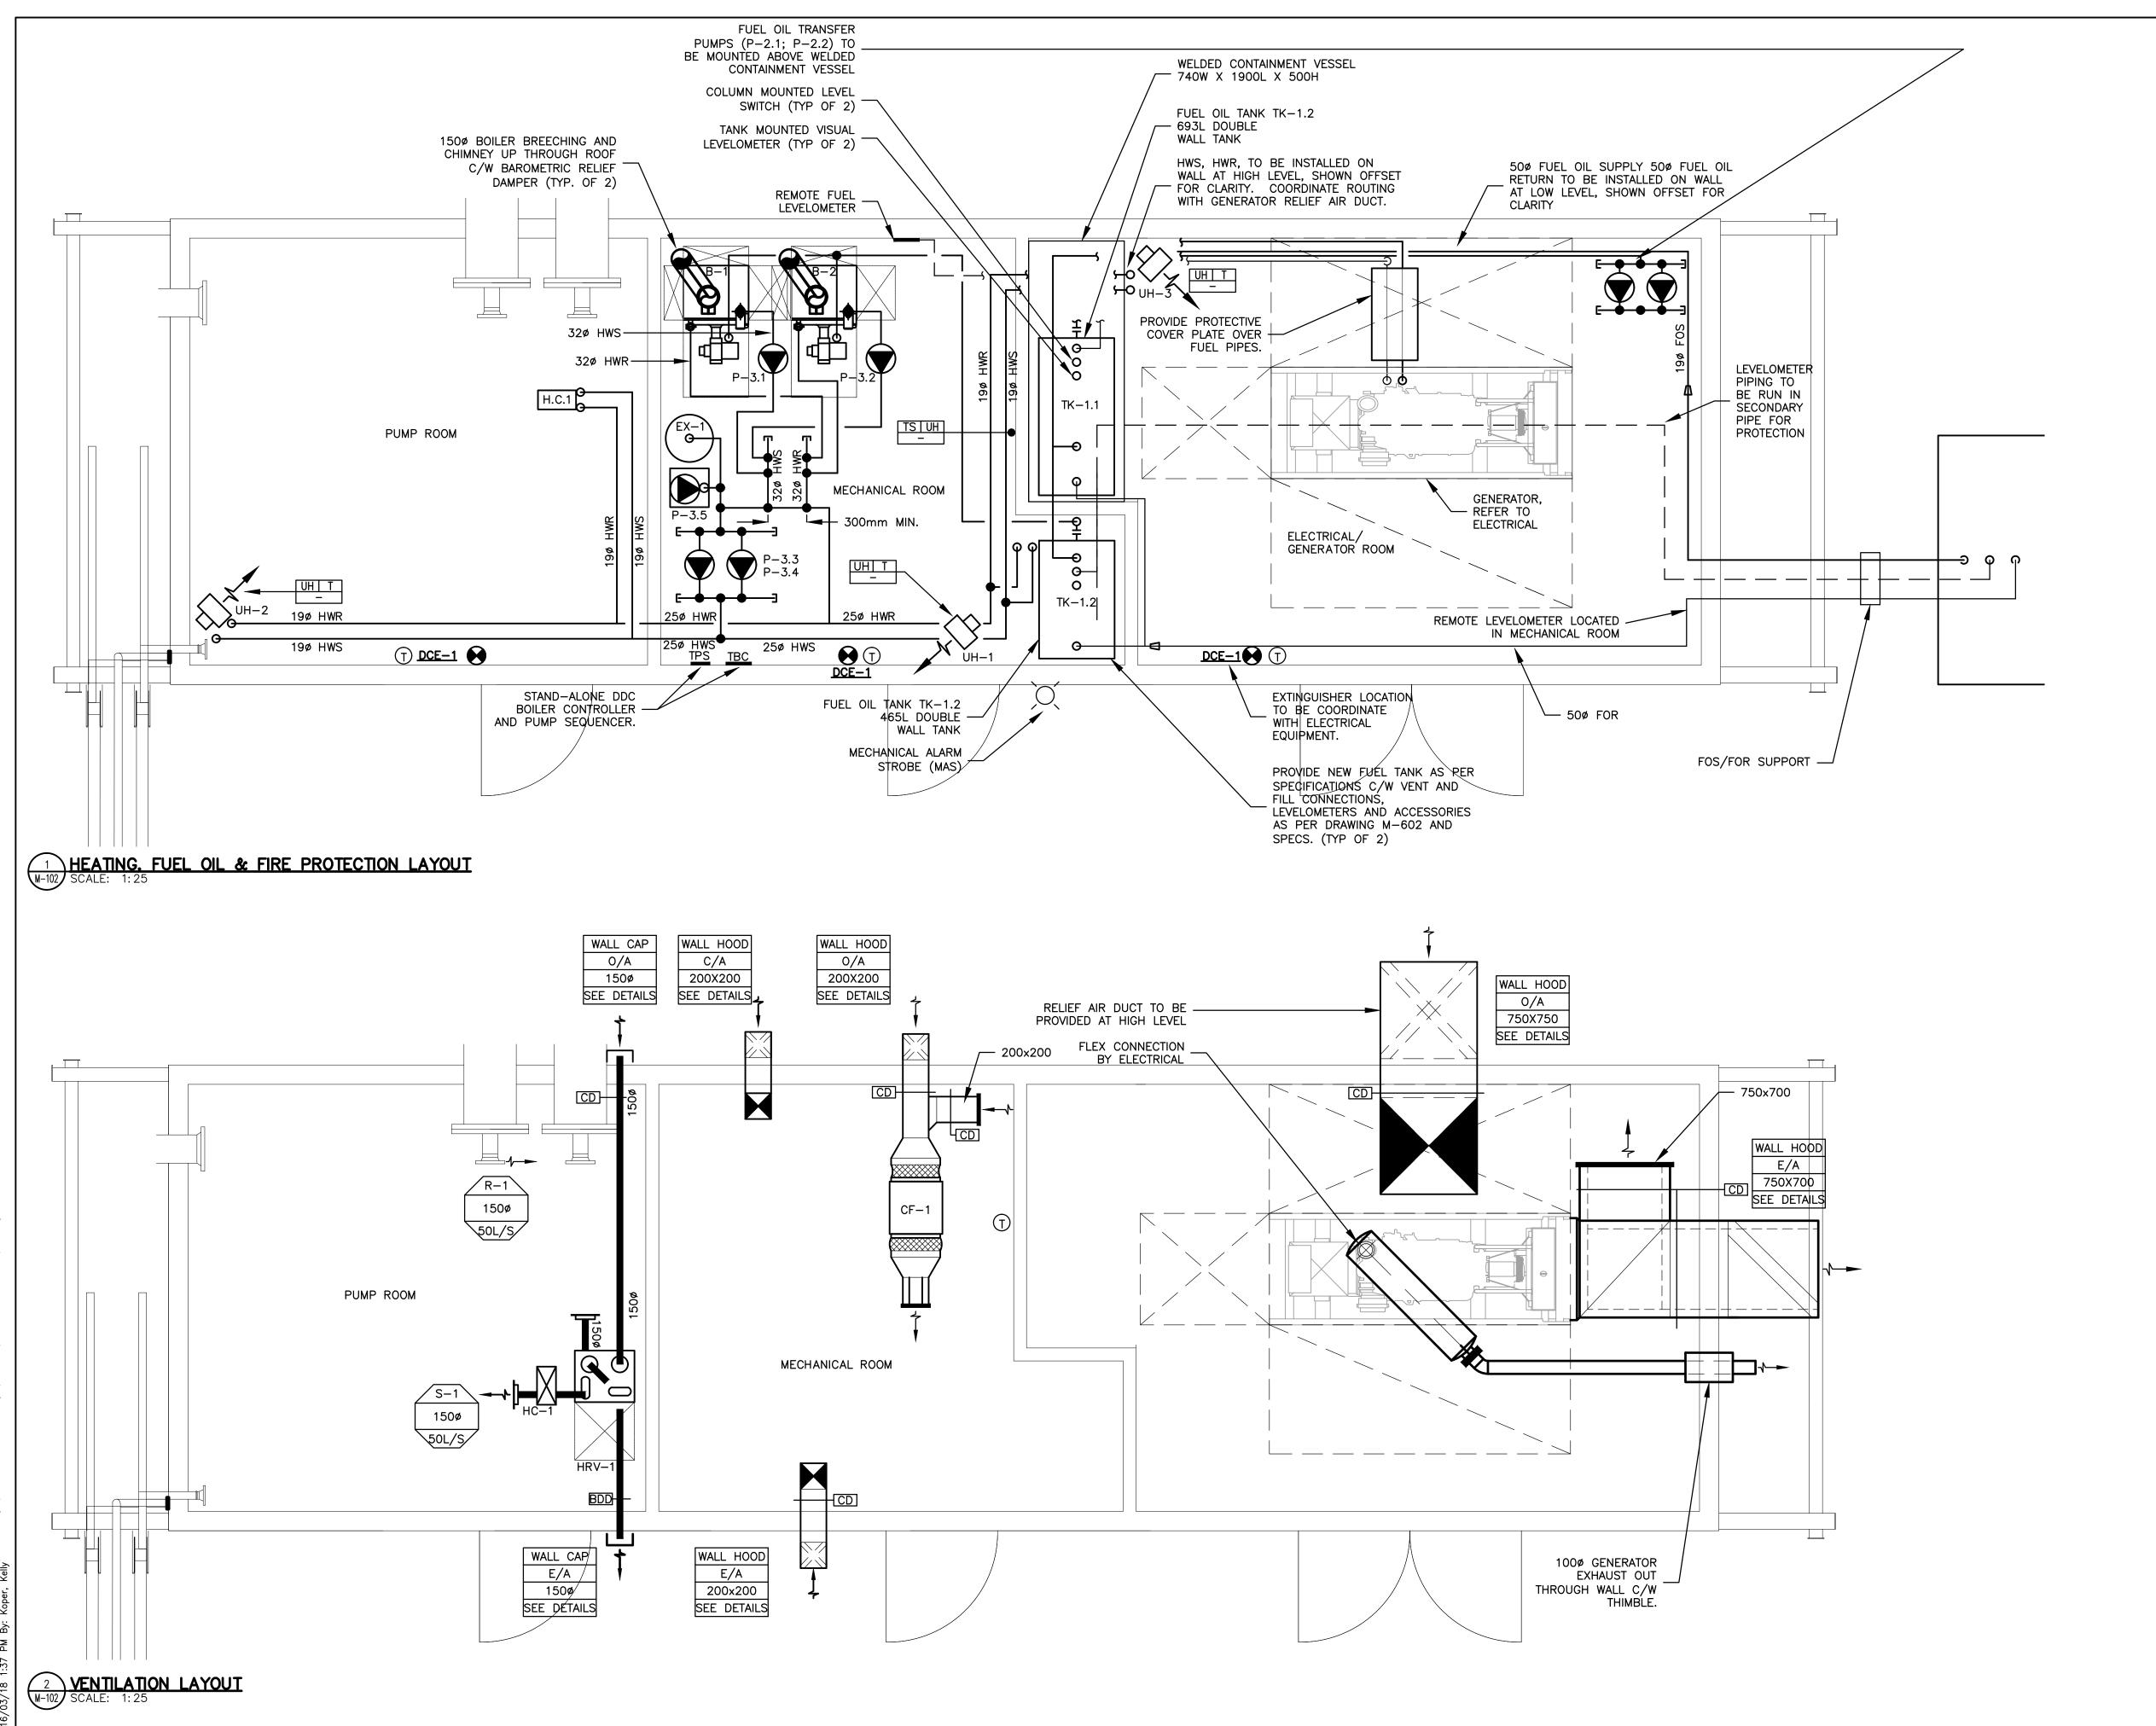
POTABLE WATER SYSTEM PHASE I

Cambridge Bay, NU

Title

BUILDING ELEVATIONS

Project No. 1449-01252	Scale AS SHOWN	
Drawing No.	Sheet	Revision
A-201	2 of 3	0





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ISSUED FOR CONSTRUCTION	BM	MP	12.08.30
ISSUED FOR ADDENDUM	NS	MP	12.05.02
ISSUED FOR TENDER			12.03.30
99% SUBMISSION	BM	MP	12.03.02
50% SUBMISSION	BM	MP	12.01.18
Issued	By	Appd.	YY.MM.DE

Permit-S

PLAN OF AS-BUILT DRAWING

Contractor: SANAQATIIT CONSTRUCTION

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Construction Certification Date: MARCH 12, 2015

Client/Project

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POTABLE WATER SYSTEM PHASE I

Cambridge Bay, NU

MECHANICAL LAYOUT

Project No.
1449-01252

Drawing No.


Scale

AS NOTED

Revision

-102

2 of 6

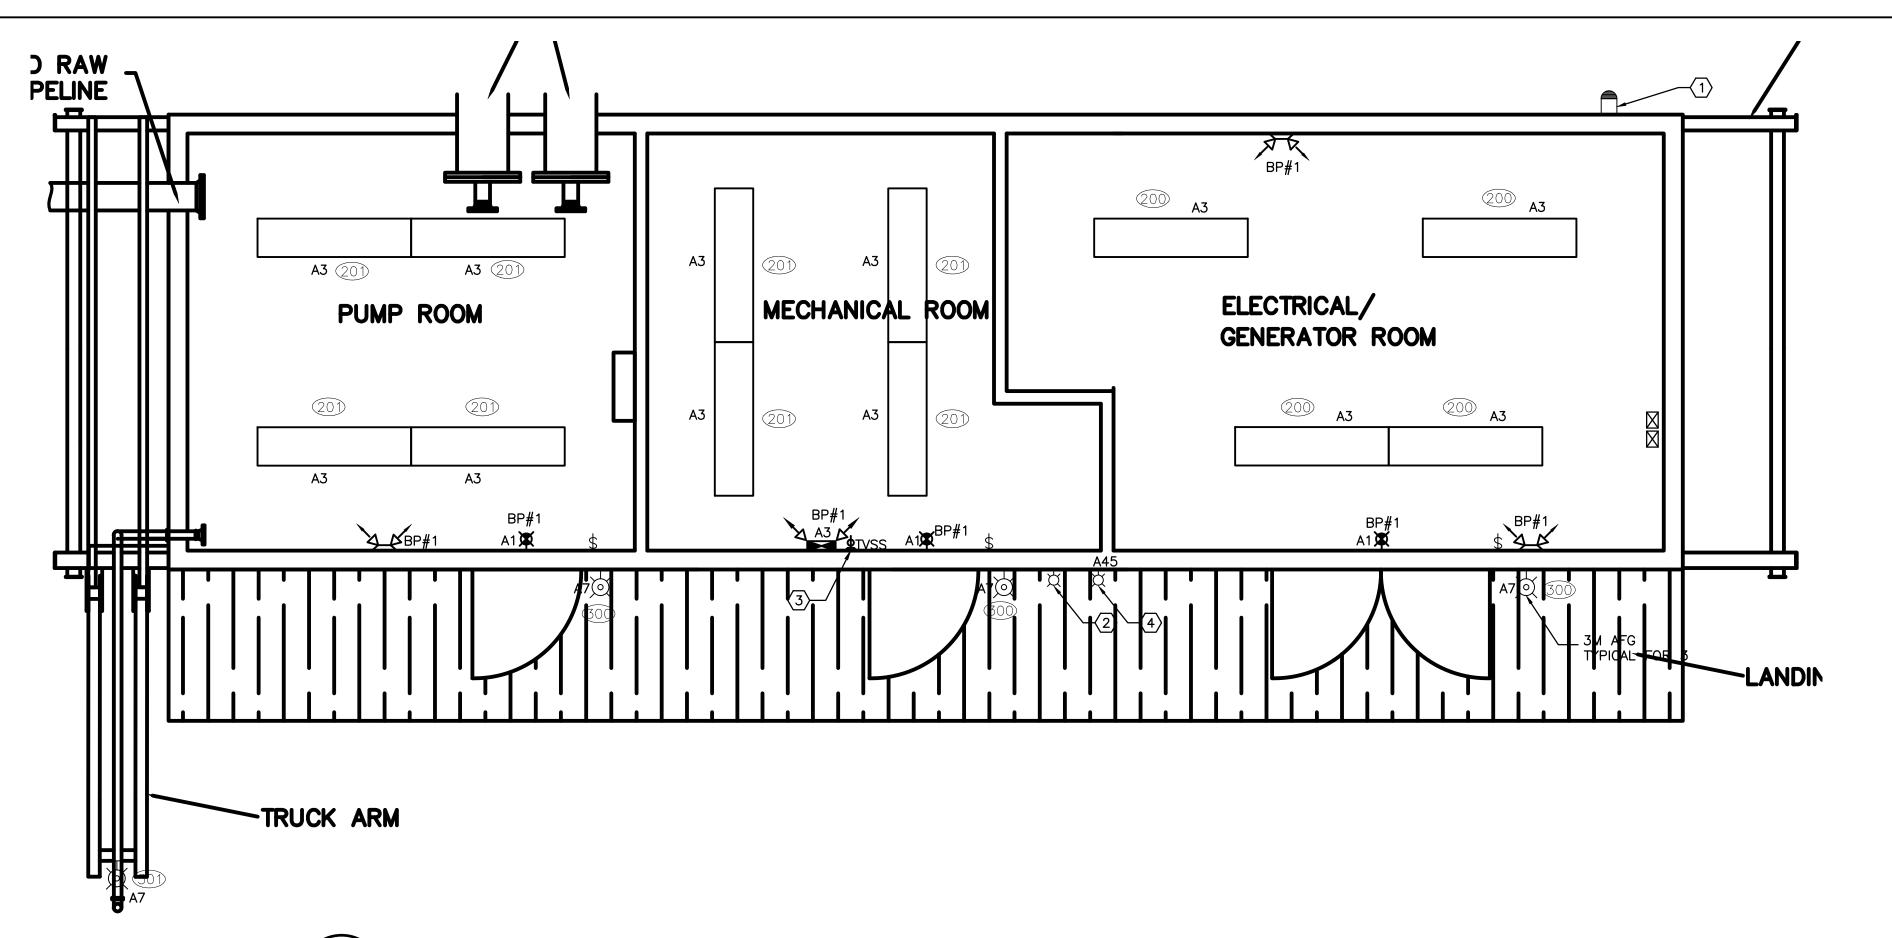

KEYNOTES:

- EXTERIOR LIGHTING PHOTOCELL INSTALL HIGHER ABOVE BUILDING, AWAY FROM OBSTRUCTION AND ARTIFICIAL LIGHT SOURCES, FACING NORTH.
- AMBER STROBE FOR MECHANICAL ALARM TO BE RIGIDLY MOUNTED WITH RIGID CONDUIT AND INSTALL ABOVE BUILDING AND TO BE VISIBLE FROM ROADSIDE. REFER SPECIFICATION SECTION 28 32 00 FOR DETAIL.
- (3) EMERGENCY BATTERY PACK ON TVSS RECEPTACLE.
- 4 FUEL TANK FULL LIGHT

PANEL: A

PROVIDE INTEGRAL TVSS, BREAKERS FOR HEAT TRACE #1 AND #2 ARE TO BE GFCI



4910 53rd Street Yellowknife, NT X1A 2P4 Tel. (867) 920-2882 Fax. (867) 920-4319 www.stantec.com

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Revision			Appu.	11.WIWI.DD
ISSUED FOR AS-BUILT		KK	WO	16.03.16
ISSUED FOR CONSTRUCTION		NJB		24.08.12
TENDER SUBMISSION		NJB		12.04.12
Issued		Ву	Appd.	YY.MM.DD
File Name:				
	Dwn.	Chkd.	Dsgn.	YY.MM.DD
Permit-Seal				

PLAN OF AS-BUILT DRAWING Contractor: SANAQATIIT CONSTRUCTION Construction Certification Date: MARCH 12, 2015

Client/Project

GOVERNMENT OF NUNAVUT

POTABLE WATER SYSTEM PHASE I

Cambridge Bay, NU

LIGHTING FLOOR PLAN AND LUMINAIRE SCHEDULE

Project No. 1449-01252	Scale	
Drawing No.	Sheet	Revision
E103	3 of 5	

LIGHTING AND EMERGENCY PLAN

SURFACE OR PENDENT MOUNTED FLUORESCENT STRIPLIGHT

LUMINAIRE SCHEDULE

	777 2. 233	HOUSING: FINISH: BALLAST: LAMP: ACCESSORIES: MOUNTING: MANUFACTURERS:	TWO F32T8 WIRE GUARD
	TYPE: 201	DESCRIPTION:	SURFACE OR PENDENT MOUNTED VAPORTIGHT INDUSTRIAL FLUORESCENT LUMINAIRE
		HOUSING:	1265 MM LONG FIBERGLASS HOUSING REINFORCED POLYESTER AND SELF-EXTINGUISHING PLASTIC WITH WATERTIGHT HUBS FOR CONDUIT ENTRY
1		LENS:	
1		BALLAST:	
1		LAMP:	TWO F32T8
ı		MOUNTING:	
		LISTING: MANUFACTURER:	•
	TYPE: 300	DESCRIPTION:	EXTERIOR WALL MOUNTED HID
1		HOUSING:	
1		LENS:	PATTERNED TAMPERED GLASS
1		FINISH:	DARK BRONZE POLYSTER POWER COAT -30 DEGREE, HIGH POWER FACTOR, 120V
1		BALLAST: LAMP:	
1		LISTING:	
1		ACCESSORIES:	MOUNTING ACCESSORIES AS REQUIRED - SEE DRAWINGS
		MANUFACTURER:	
	TYPE: 301	DESCRIPTION:	
		HOUSING:	DIE CAST ALUMINUM
		FINISH:	
-		GASKET:	FULL CIRCUMFERENCE SILICON GASKET

-40 DEGREE, HIGH POWER FACTOR, 120V

MOUNTING ACCESSORIES AS REQUIRED - SEE DRAWINGS

LUMARK FALCON HP-SF-50HP-H-120V-TR-SF/WG OR APPROVED EQUAL

ONE 50 WATT HPS

UL WET LOCATION LISTED

NOTES: 1. THIS LUMINAIRE SCHEDULE IS NOT COMPLETE WITHOUT A COPY OF THE PROJECT DOCUMENTS CONTAINING THE ELECTRICAL SPECIFICATIONS. 2. VERIFY LUMINAIRE VOLTAGE WITH BRANCH CIRCUIT SUPPLYING POWER TO LUMINAIRE PRIOR TO ORDERING. 3. VERIFY AND COORDINATE ALL CEILING TYPES WITH LUMINAIRE LOCATIONS. 4. PROVIDE LUMINAIRES COMPLETE WITH LAMP AND ALL ACCESSORIES FOR MOUNTING AS SHOWN ON DRAWINGS. FOR EXACT CEILING AND WALL TYPES REFER TO BUILDING DRAWINGS. 5. ALL FLUORESCENT LAMPS TO COMPLY WITH LOCAL AND NATIONAL TOXICITY RULES AND REGULATIONS, WHERE AVAILABLE. 6. SPECIFIED MANUFACTURERS ARE APPROVED TO SUBMIT BID WHERE SPECIFIED. INCLUSION DOES NOT RELIEVE MANUFACTURER FROM PROVIDING PRODUCT AS DESCRIBED. 7. EQUALS SHALL MEET THE DESCRIPTIONS LISTED AND IDENTIFIED BY THE CATALOG NUMBER INDICATED FOR ALL ELEMENTS AND PROPERTIES. THE MERE FACT THAT THE SERIES IS LISTED HEREIN DOES NOT AUTOMATICALLY QUALIFY ANY LUMINAIRE OF SUCH FAMILY AS EQUAL. 8. ALL THE AVERAGE MAINTAINED HORIZONTAL AND VERTICAL ILLUMINANCE LEVELS SHALL CONFORM TO THE 10th EDITION OF "LIGHTING HANDBOOK" ILLUMINATING ENGINEERING SOCIETY (IES) AND NATIONAL ENERGY CODE FOR BUILDINGS 2011 (NECB)

VOLTS: 120/2				/208	LOCATION: ELECTRICAL/GENERAT	BUSS: 250A					
		PHASE:	3		- FEEDER: REFER TO SINGLE LIN	E	MTG:	SURFAC			
		WIRE:	4				-			-	
			WATTS		<u> </u>	<u> </u>		WATTS			
CIRC	BRKR	Α	В	С	DESCRIPTION	DESCRIPTION	Α	В	С	BRKR	CIRC
* 1	1P15	50			EXIT SIGNS	RECEPTACLES PROCESS RM	375			1P15	2
3	1P15		1000		LIGHTS & EMERGENCY LGTHS	RECEPTACLES MECH RM		375		1P15	4
5	1P15				SPARE	RECEPTACLES GEN RM			250	1P15	6
7	1P15	400			EXTERIOR LIGHTS	RECEPTACLES EXTERIOR	250			1P15	8
9	1P15		176		B-1	SPARE				1P15	10
11	1P15			176	B-2	P-3.1			187	1P15	12
13	1P25	335			HRV-1	P-3.2	187			1P15	14
15	1P15		60		UH-1	P-3.3		478		1P15	16
17	1P15			60	UH-2	P-3.4			478	1P15	18
19	1P15	60			UH-3	P-3.5	100		<u> </u>	1P15	20
21	1P15		100	<u> </u>	MAS	P-M1	1	125			22
23	1P15			100	TBS	P-P5.2		,	125	1	24
25	1P15	100		1,00	TPS	<u> </u>	125		1		26
27	1P15	,,,,	150		MISC. LOADS-GEN RM	- P-P1	125	40		3P15	28
29	1P15			50	CF-1				150	0. 20	30
	11 10			"					100		
31	1P15	5000			GEN SET BLOCK HEATER FOP-1	SEIMENS CONTROL PNL	5000			1P15	32
33	1P15		5000		FOP-2			5000]	34
35	1P15			5000		MECH ALARM-FUEL FULL			5000		36
37		1667				HEAT TRACE #1 CONTROLLERS	2250			2P15	38
39	3P40		1667		AB	TIEAT TRACE #1 CONTROLLERS		2250		21 13	40
41				1667		HEAT TRACE #2			2250		42
43	1P15	100			GEN ROOM QUAD RECP	THEAT TRACE #2	2250				44
45	1P15				GEN ROOM QUAD RECP	AUTODIALER		100		1P15	46
47	1P15				BATTERY CHANRGER	SPARE				1P15	48
49											50
51	3P110				RWP-2	RWP-1				3P110	52
53					7						54
55	20.40				LIEAT TRACE #4	LIEAT TRACE #2				2042	56
57	2P40				HEAT TRACE #1	HEAT TRACE #2				2P40	58
59					SPACE	SPACE					60
TO:	TAL	7712	8153	7053			10537	8368	8440	TOT	<u>. </u>
				L , 555	<u> </u>	1	1.0007	L 5555	1 5+40	<u> </u>	, \L
		TAL =	18249								
		TAL =	16521								
			15493		0.100 /000 \100 = 5						
	EL TOT	AL =	50263		@120/208 VOLTS 3 PHASE	139.5	AMPS				
EMAR PRO		OCK-ON	DEVICE	ON BR	EAKER.						

ORIGINAL SHEET - ANSI D

TYPE: 200 DESCRIPTION:


BALLAST:

LAMP:

LISTING:

ACCESSORIES:

MANUFACTURER:

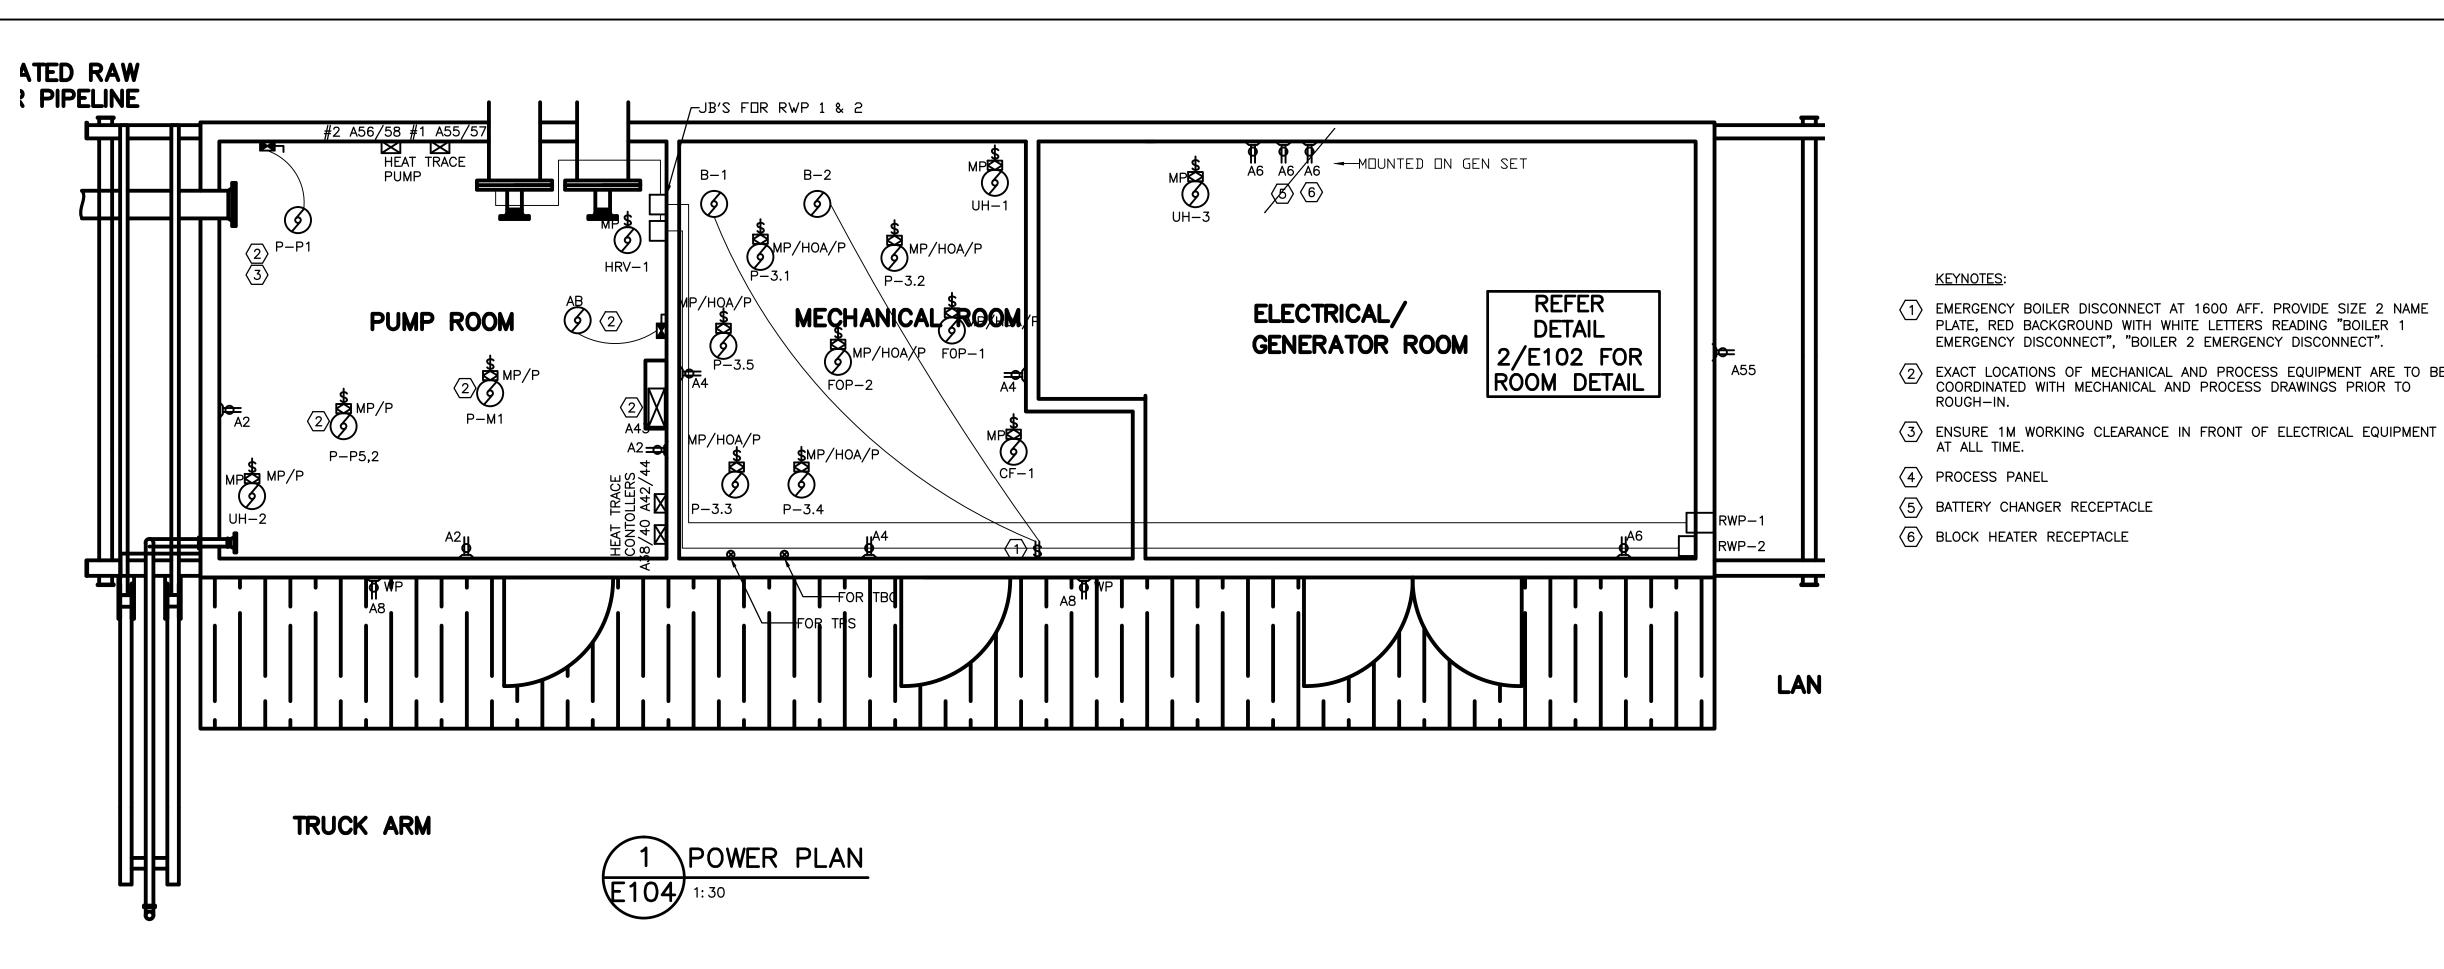

MECHANICAL MOTOR LIST										
MOTOR	DESCRIPTION	LOCATION	H.P.	VOLTS	PHASE	FLA	BRANCH CIRCUIT	BREAKER	SOURCE	CONTROL
B-1	HW BOILER	MECH RM	0.235	120	1	5.8	2CON #12 CU RW90-XLPE, 1 #12 CU GND, IN 16 MM C	15	A9	LRD
B-2	HW BOILER	MECH RM	0.235	120	1	5.8	2CON #12 CU RW90-XLPE, 1 #12 CU GND, IN 16 MM C	15	A11	LRD
HRV-1	HEAT RECOVERY VENTILATOR	MECH RM	0.446	120	1	9.8	2CON #10 CU RW90-XLPE, 1 #12 CU GND, IN 16 MM C	25	A13	MMP/P
P-3.1	PRIMARY HW CIRC. PUMP	MECH RM	0.25	120	1	5.8	2CON #12 CU RW90-XLPE, 1 #12 CU GND, IN 16 MM C	15	A12	MMP/HOA/R/P NOTE D
P-3.2	PRIMARY HW CIRC. PUMP	MECH RM	0.25	120	1	5.8	2CON #12 CU RW90-XLPE, 1 #12 CU GND, IN 16 MM C	15	A14	MMP/HOA/R/P NOTE D
P-3.3	SECONDARY HE CIRC. PUMP	MECH RM	0.64	120	1	12.2	2CON #10 CU RW90-XLPE, 1 #12 CU GND, IN 16 MM C	15	A16	MMP/HOA/R/P NOTE D
P-3.4	SECONDARY HE CIRC. PUMP	MECH RM	0.64	120	1	12.2	2CON #10 CU RW90-XLPE, 1 #12 CU GND, IN 16 MM C	15	A18	MMP/HOA/R/P NOTE D
P-3.5	HW MAKE-UP PUMP	MECH RM	FRACT	120	1	_	2CON #12 CU RW90-XLPE, 1 #12 CU GND, IN 16 MM C	15	A20	MMP/HOA/R/P
FOP-1	FUEL OIL PIMP	MECH RM	0.500	120	1	9.8	2CON #10 CU RW90-XLPE, 1 #12 CU GND, IN 16 MM C	15	A33	MMP/HOA/R/P
FOP-2	FUEL OIL PIMP	MECH RM	0.500	120	1	9.8	2CON #10 CU RW90-XLPE, 1 #12 CU GND, IN 16 MM C	15	A35	MMP/HOA/R/P
UH-1	UNIT HEATER	MECH RM	FRACT	120	1	_	2CON #12 CU RW90-XLPE, 1 #12 CU GND, IN 16 MM C	15	A15	MMP/R/P NOTE D
UH-2	UNIT HEATER	PUMP RM	FRACT	120	1	_	2CON #12 CU RW90-XLPE, 1 #12 CU GND, IN 16 MM C	15	A17	MMP/R/P NOTE D
UH-3	UNIT HEATER	ELEC RM	FRACT	120	1	_	2CON #12 CU RW90-XLPE, 1 #12 CU GND, IN 16 MM C	15	A19	MMP/R/P NOTE D
CF-1	COOLING FAN	MECH RM	FRACT	120	1	_	2CON #12 CU RW90-XLPE, 1 #12 CU GND, IN 16 MM C	15	A29	MMP/R/P NOTE D
MAS	MECHANICAL ALARM STROBE	MECH RM	FRACT	120	1	_	2CON #12 CU RW90-XLPE, 1 #12 CU GND, IN 16 MM C	15	A36	BY DIVISION 23
		MECH RM	FRACT	120	1		2CON #12 CU RW90-XLPE, 1 #12 CU GND, IN 16 MM C	15	A23	NOTE E
		MECH RM	FRACT	120	1	_	2CON #12 CU RW90-XLPE, 1 #12 CU GND, IN 16 MM C	15	A25	NOTE E
	MISCELLANEOUS 24V LOADS	GENERATOR RM	FRACT	120	1	_	2CON #12 CU RW90-XLPE, 1 #12 CU GND, IN 16 MM C	15	A27	MMP/R/P

PROCESS MOTOR LIST										
MOTOR	DESCRIPTION	LOCATION	H.P.	VOLTS	PHASE	FLA	BRANCH CIRCUIT	BREAKER	SOURCE	CONTROL
RWP-1	RAW WATER PUMP -1	END OF INTAKE LINE	15	208	3	46.2	SEE SINGLE LINE	110	A50,52,54	CMS/GF NOTE F
RWP-2	RAW WATER PUMP -2	END OF INTAKE LINE	15	208	3	46.2	SEE SINGLE LINE	110	A49,51,53	CMS/GF NOTE F
		PROCESS ROOM	5	208	3	16.72	SEE SINGLE LINE	40		
P-P1	PUMP 1 RECIRC	PROCESS ROOM	0.5	208	3	2.2	3CON #12 CU RW90-XLPE, 1 #12 CU GND, IN 16 MM C	15	A26,28,30	CMS
P-P5,2	CHLORINATION PUMP	PROCESS ROOM	0.2	120	1	1	2CON #12 CU RW90-XLPE, 1 #12 CU GND, IN 16 MM C	15	A24	MMP/R/P
P-M1	CHLORINE MIXING MOTOR	PROCESS ROOM	FRACT	120	1	ı	2CON #12 CU RW90-XLPE, 1 #12 CU GND, IN 16 MM C	15	A22	MMP/R/P

NOTES:

- A. MOTOR SCHEDULE IS FOR ESTIMATING PURPOSES ONLY. CONFIRM ALL MOTOR FULL LOAD CURRENTS WITH NAMEPLATES AND SIZE MOTOR DISCONNECTS, BREAKERS, FEEDERS AND OVERLOADS ACCORDINGLY.
- B. CONFIRM MECHANICAL EQUIPMENT LOCATIONS WITH DIVISION 23.
- C. COORDINATE THE LOCATIONS OF ALL LINE VOLTAGE PILOT DEVICES WITH DIVISION 23 AND PROVIDE CONDUIT AND WIRING AS NECESSARY
- D. PROVIDE RACEWAY AND WIRING FROM LINE-VOLTAGE THERMOSTAT PROVIDED BY DIV-23 TO THE UNIT.
- E. EQUIPMENT WITH HARDWIRE CONNECTION.
- F. PROVIDE RACEWAY, WIRING AND ACCESSORIES BETWEEN RWP-1 AND RWP-2 FOR INTERLOCK. ONE PUMP RUNNING AT A TIME.

CONTROL DEVICE LEGEND

LRD - LOAD RATED DISCONNECT

MAG - MAGNETIC STARTER CMS - MAGNETIC STARTER WITH DISCONNECT

MMP - MANUAL MOTOR PROTECTION

/R – WITH LOAD RATED RELAY

/HOA - WITH H-O-A SWITCH

/K – KEYED

/P - PILOT LIGHT

/SS - SOFT START

/GF - GROUND FAULT DETECTION



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KEYNOTES:

4 PROCESS PANEL

(5) BATTERY CHANGER RECEPTACLE

6 BLOCK HEATER RECEPTACLE

(1) EMERGENCY BOILER DISCONNECT AT 1600 AFF. PROVIDE SIZE 2 NAME

EMERGENCY DISCONNECT", "BOILER 2 EMERGENCY DISCONNECT".

PLATE, RED BACKGROUND WITH WHITE LETTERS READING "BOILER 1

(2) EXACT LOCATIONS OF MECHANICAL AND PROCESS EQUIPMENT ARE TO BE COORDINATED WITH MECHANICAL AND PROCESS DRAWINGS PRIOR TO

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Legend

By Appd. YY.MM.DD Revision ISSUED FOR AS-BUILT KK WO 16.03.16 ISSUED FOR CONSTRUCTION 24.08.12 By Appd. YY.MM.DD Dwn. Chkd. Dsgn. YY.MM.DD Permit-Seal

PLAN OF AS-BUILT DRAWING

Contractor: SANAQATIIT CONSTRUCTION Construction Certification Date: MARCH 12, 2015

Client/Project

GOVERNMENT OF NUNAVUT

POTABLE WATER SYSTEM PHASE I

Cambridge Bay, NU

POWER FLOOR PLAN AND MOTOR SCHEDULE

Project No. 1449-01252	Scale	
Drawing No.	Sheet	Revision

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