

ರ್ಯ ರ ಲ ನಿ ರ ರ ಎ ನಿ ್ ನ ನಿ ಗಿ ರ ರ Department of Community and Government Services Nunalingni Kavamatkunnilu Pivikhaqautikkut Ministère des Services Communautaires et gouvernementaux

Gjoa Haven Water Licence: 3BM-GJO 1318 Water System Upgrading

March 21, 2016

Nunavut Water Board P.O. Box 119 Gjoa Haven, NU X0B 1L0

Attention: Karen Kharatyan, Ph D., P. Eng., Manager of Licensing

**RE:** Water System upgrading and SCADA control

### Dear Mr. Karen,

The Hamlet of Gjoa Haven is pleased to submit to Nunavut Water Board the attached file of "as-built" drawings for water System upgrade completed in 2015.

The Licensee has a plan for SCADA upgrading to control system in summer 2016 for the monitoring and operation of Water intake, delivery and treatment process. With this upgrading, the program will not be affected or any changes to the approved process. This maintenance is a part of the system designed and developed for the Gjoa Haven Water intake and delivery process.

We hope that Nunavut Water Board will find this report and enclosed as-built drawings in operating the Water Licence.

Best Regards,

Shah Alam, P. Eng., E.P.

Municipal Planning Engineer, Government of Nunavut Community and Government Services Kitikmeot Region, Cambridge Bay, Nu Phone: 867-983-4156, fax: 867-983-4123

E. mail: <a href="mailto:salam@gov.nu.ca">salam@gov.nu.ca</a>

Enclosure: as-built drawings, Water Line upgrading

Cc: David Stockley, Senor Administrative Officer (SAO), Gjoa Haven, NU

Baba Pedersen, Resource management Officer, AANDC

### **EXECUTIVE SUMMARY:**

This Report for the Hamlet of Gjoa Haven (the Licensee) to the Nunavut Water Board (NWB) has been prepared to meet requirements of the Nunavut Water Board Licence 3BM-GJO 1318, Part E, item 4, Conditions apply to Modification and Construction to facility of Water supply. This report covers the period from 01 January to 31 December 2015.

Water intake from Swan Lake through twin intake pumps, delivered by 6 inch HDPE buried line to the treatment plant building 3 km away where it treated in pressure filters followed by chlorination before truck fill and supplied to household tank by hamlet operated water trucks.

Buried water line insulation damaged to some portion and the line suffered winter freeze up partly during last 2-3 winters. It required continued excess water releasing from the buried line outside when the storage tank is full and no truck fill outside. This damaged line was replaced with new 6 inch HDPE insulated pipe during the last summer. With this replacement, water intake and supply efficiency increased but no changes to system, structure or program.

Mechanical upgrading also done to water system during the fiscal years 2014-2015 which included:

- Replacement of intake pumps and regulating valves at intake pumphouse (IPH)
- Water recirculation pressure pumps at IPH and 2- Heat Exchanger stations.
- Replacement of boilers with higher heat supply efficiency
- Replaced shell-in-tube heat exchangers at IPH and water treatment plant (WTP)

Plan for SCADA upgrading to water system control is in summer 2016, a construction tender out for such works which may include the PLC reprograming to provide correct information on time for water intake, flow rate, body temperature and any information helpful to secure service and facility.

Included: 'as-built' drawings for water System Upgrading by Stantec consulting Engineers



# GOVERNMENT OF NUNAVUT COMMUNITY AND GOVERNMENT SERVICES

PROJECT: WATER SUPPLY PIPELINE UPGRADES

LOCATION: GJOA HAVEN, NU

GN PROJECT NO: 14-4002

STANTEC PROJECT NO: 144902165

ISSUED FOR RECORD


# LIST OF DRAWINGS

C-101 PROJECT LOCATION PLAN

C-102 SITE PLAN

C-201 PIPELINE PLAN AND PROFILE STN 0+000 TO STN 0+720 C-202 PIPELINE PLAN AND PROFILE STN 0+720 TO STN 1+400

C-501 PIPE CONNECTION AND BERM DETAILS

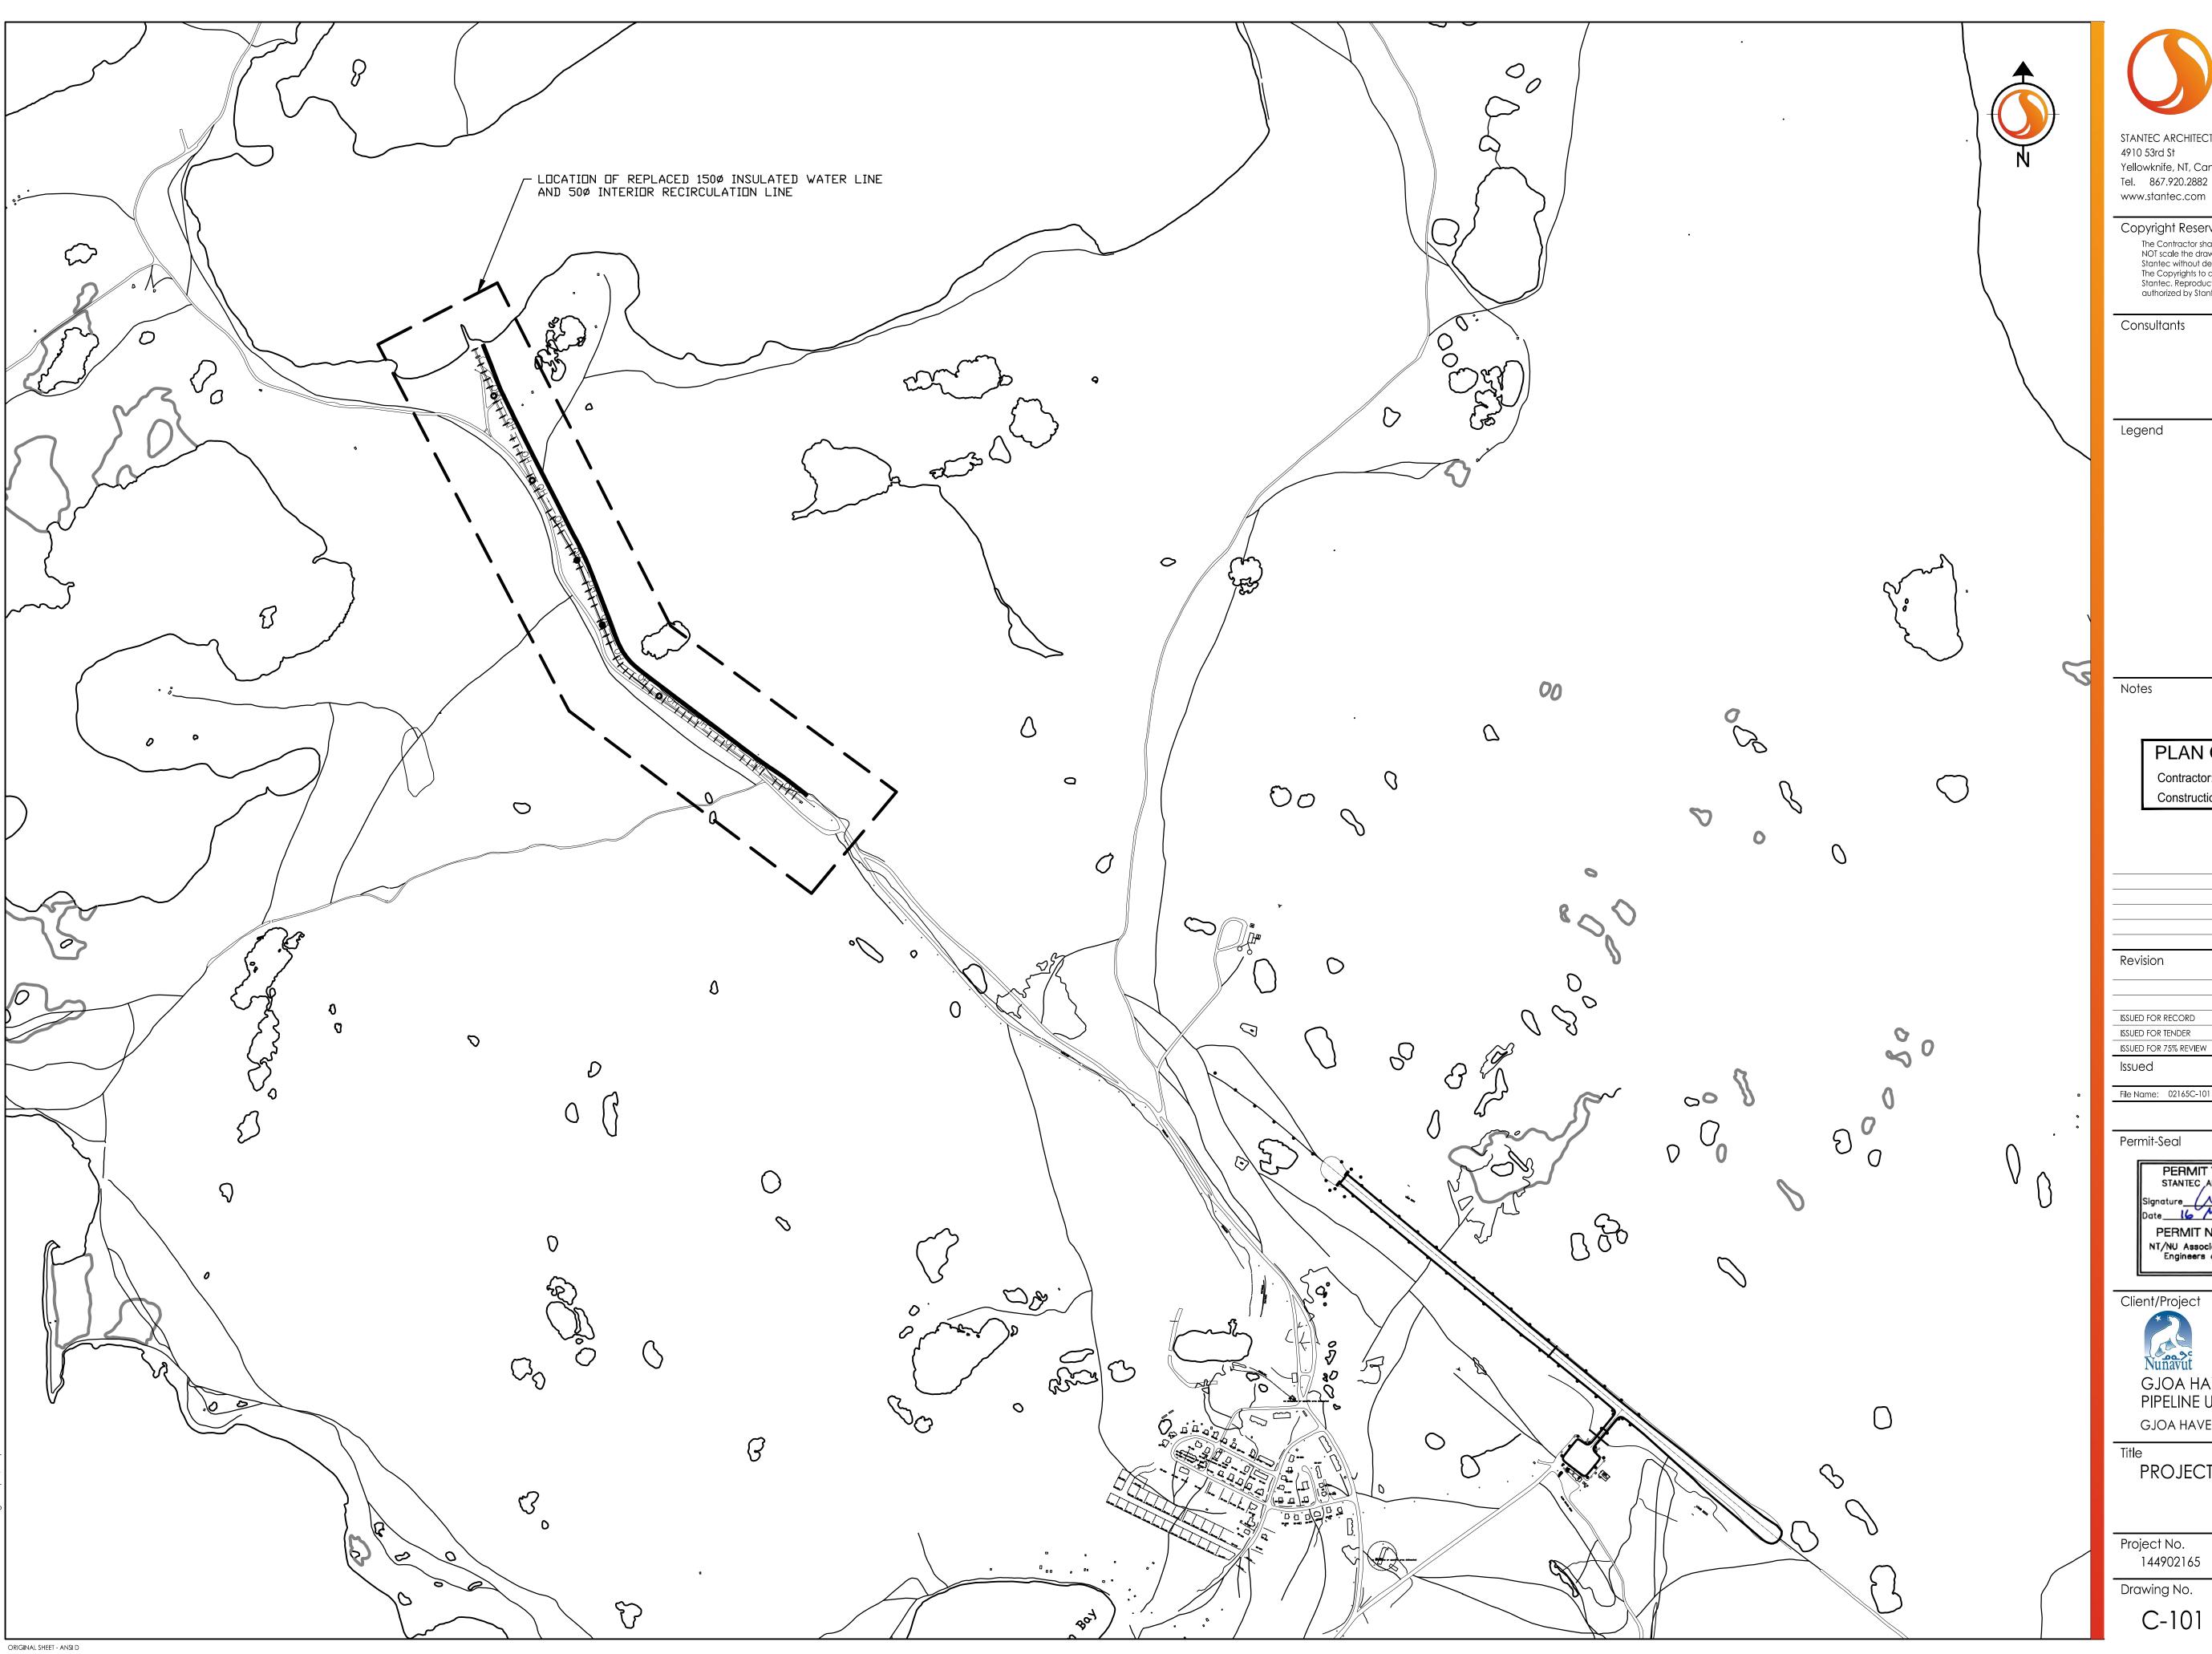



STANTEC ARCHITECTURE LTD.

4910 53rd St Yellowknife, NT, Canada X1A 2P4 Tel. 867.920.2882

Copyright Reserved

The Contractor shall verify and be responsible for all dimensions. DO NOT scale the drawing - any errors or omissions shall be reported to Stantec without delay.

The Copyrights to all designs and drawings are the property of Stantec. Reproduction or use for any purpose other than that authorized by Stantec is forbidden.

Consultants


Legend


# PLAN OF RECORD DRAWING

Contractor: KUDLIK CONSTRUCTION LTD Construction Certification Date: December 9, 2015

Revision		Ву	Appd.	YY.MM.DD
ISSUED FOR RECORD		KK	WO	16.03.17
ISSUED FOR TENDER		AK	WO	15.02.28
ISSUED FOR 75% REVIEW		AK	WO	14.12.12
Issued		Ву	Appd.	YY.MM.DD
File Name: 02165C-101 RECORD.DWG				
	Dwn.	Chkd.	Dsgn.	YY.MM.DD

Permit-Seal

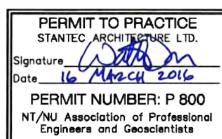

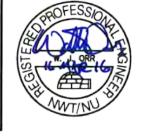




GJOA HAVEN WATER SUPPLY PIPELINE UPGRADES

GJOA HAVEN, NU

PROJECT LOCATION PLAN

Project No. 144902165	Scale 1:7500	
Drawing No.	Sheet	Revision
C-101	1 of 5	A / O

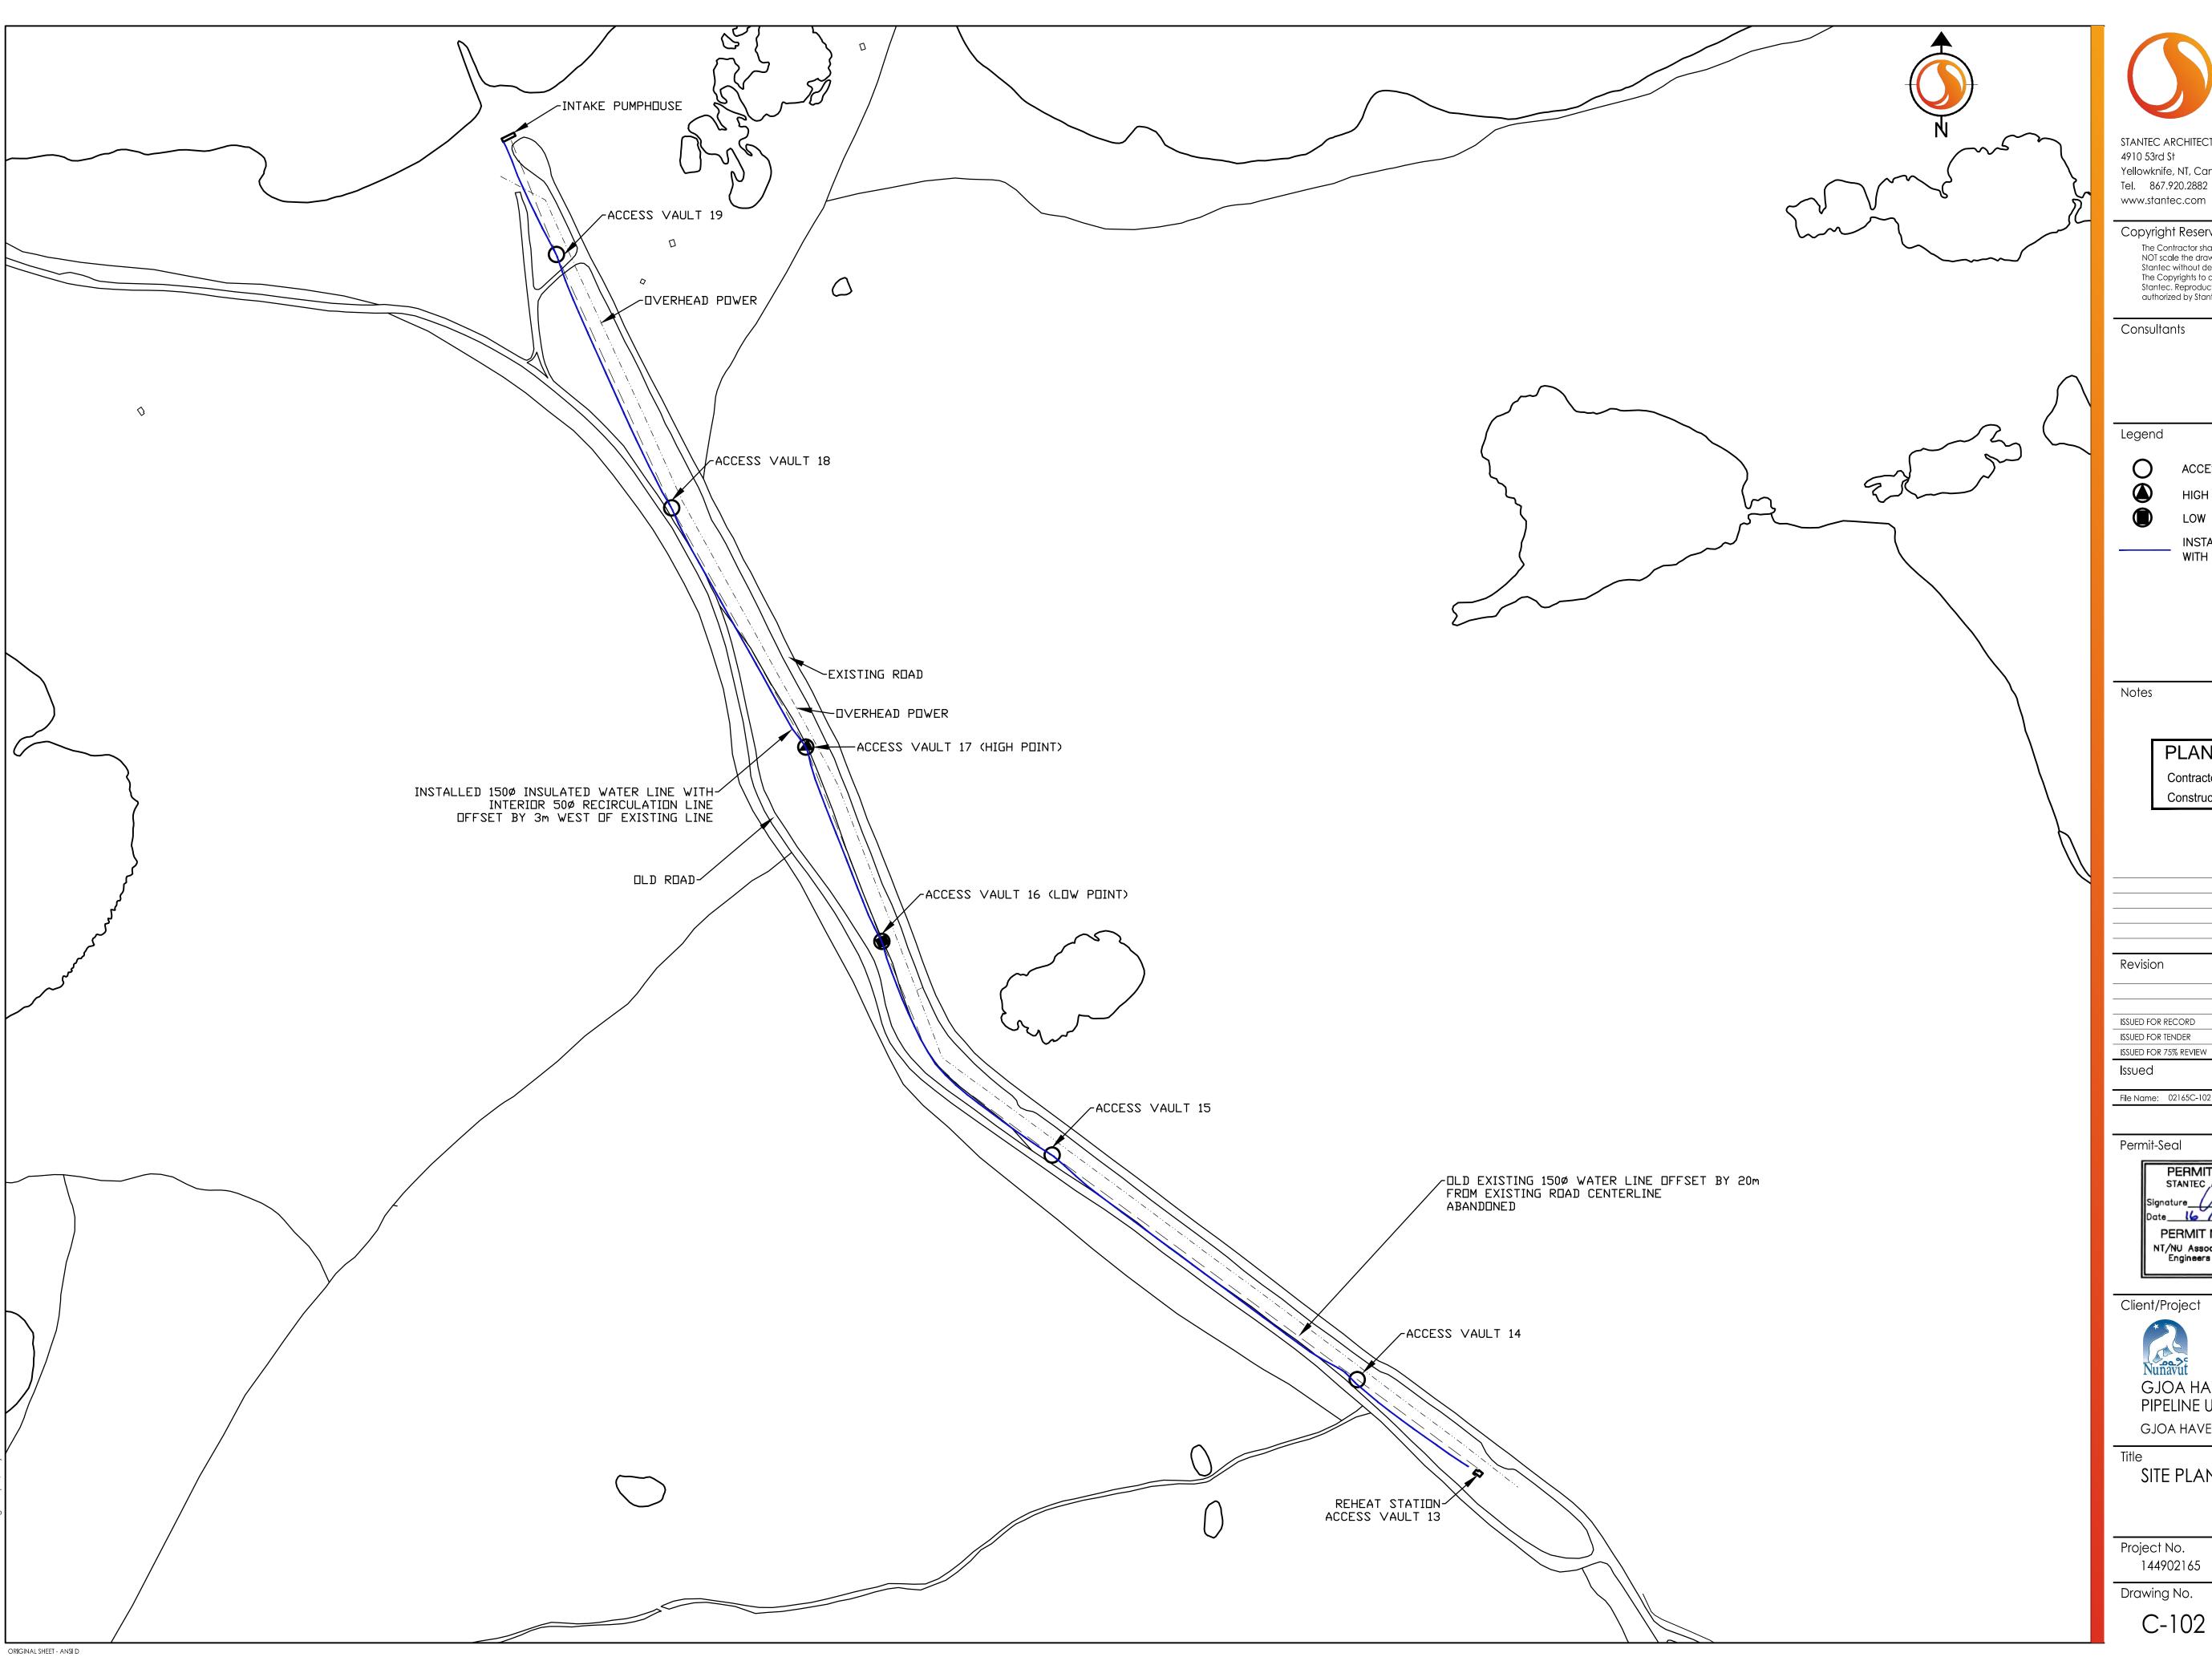



STANTEC ARCHITECTURE LTD.

Yellowknife, NT, Canada X1A 2P4 Tel. 867.920.2882

### Copyright Reserved

The Contractor shall verify and be responsible for all dimensions. DO NOT scale the drawing - any errors or omissions shall be reported to Stantec without delay. The Copyrights to all designs and drawings are the property of Stantec. Reproduction or use for any purpose other than that authorized by Stantec is forbidden.

ACCESS VAULT

HIGH POINT (AIR VENTS)

LOW POINT (DRAIN)

INSTALLED 150Ø INSULATED WATER LINE WITH INTERIOR 500 RECIRCULATION LINE


# PLAN OF RECORD DRAWING

Contractor: KUDLIK CONSTRUCTION LTD Construction Certification Date: December 9, 2015

Revision		Ву	Appd.	YY.MM.DD
ISSUED FOR RECORD		KK	WO	16.03.17
ISSUED FOR TENDER		AK	WO	15.02.28
ISSUED FOR 75% REVIEW		AK	WO	14.12.12
Issued		Ву	Appd.	YY.MM.DD
File Name: 02165C-102 RECORD.DWG				
	Dwn.	Chkd.	Dsgn.	YY.MM.DD

Permit-Seal

PERMIT TO PRACTICE PERMIT NUMBER: P 800 NT/NU Association of Professional Engineers and Geoscientists

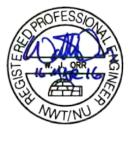

Client/Project





GJOA HAVEN WATER SUPPLY PIPELINE UPGRADES

GJOA HAVEN, NU

SITE PLAN

Project No.	Scale	
Project No. 144902165	1:2500	
Drawing No.	Sheet	Revision
C-102	2 of 5	A / O

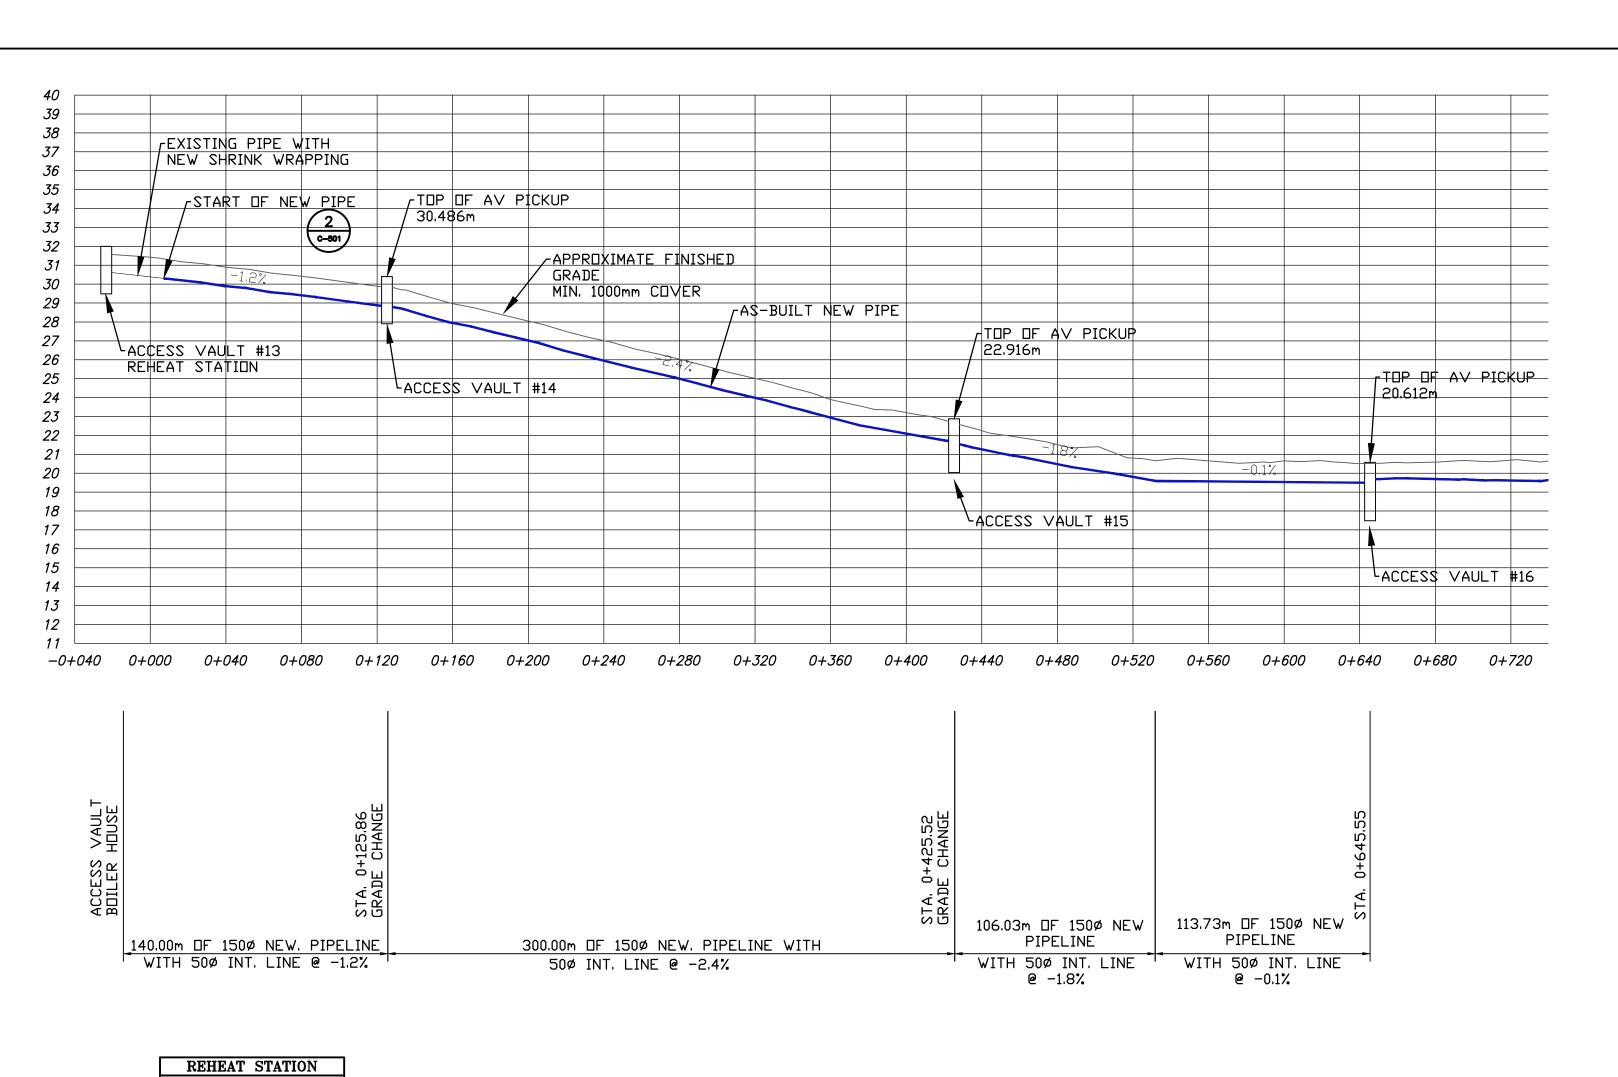

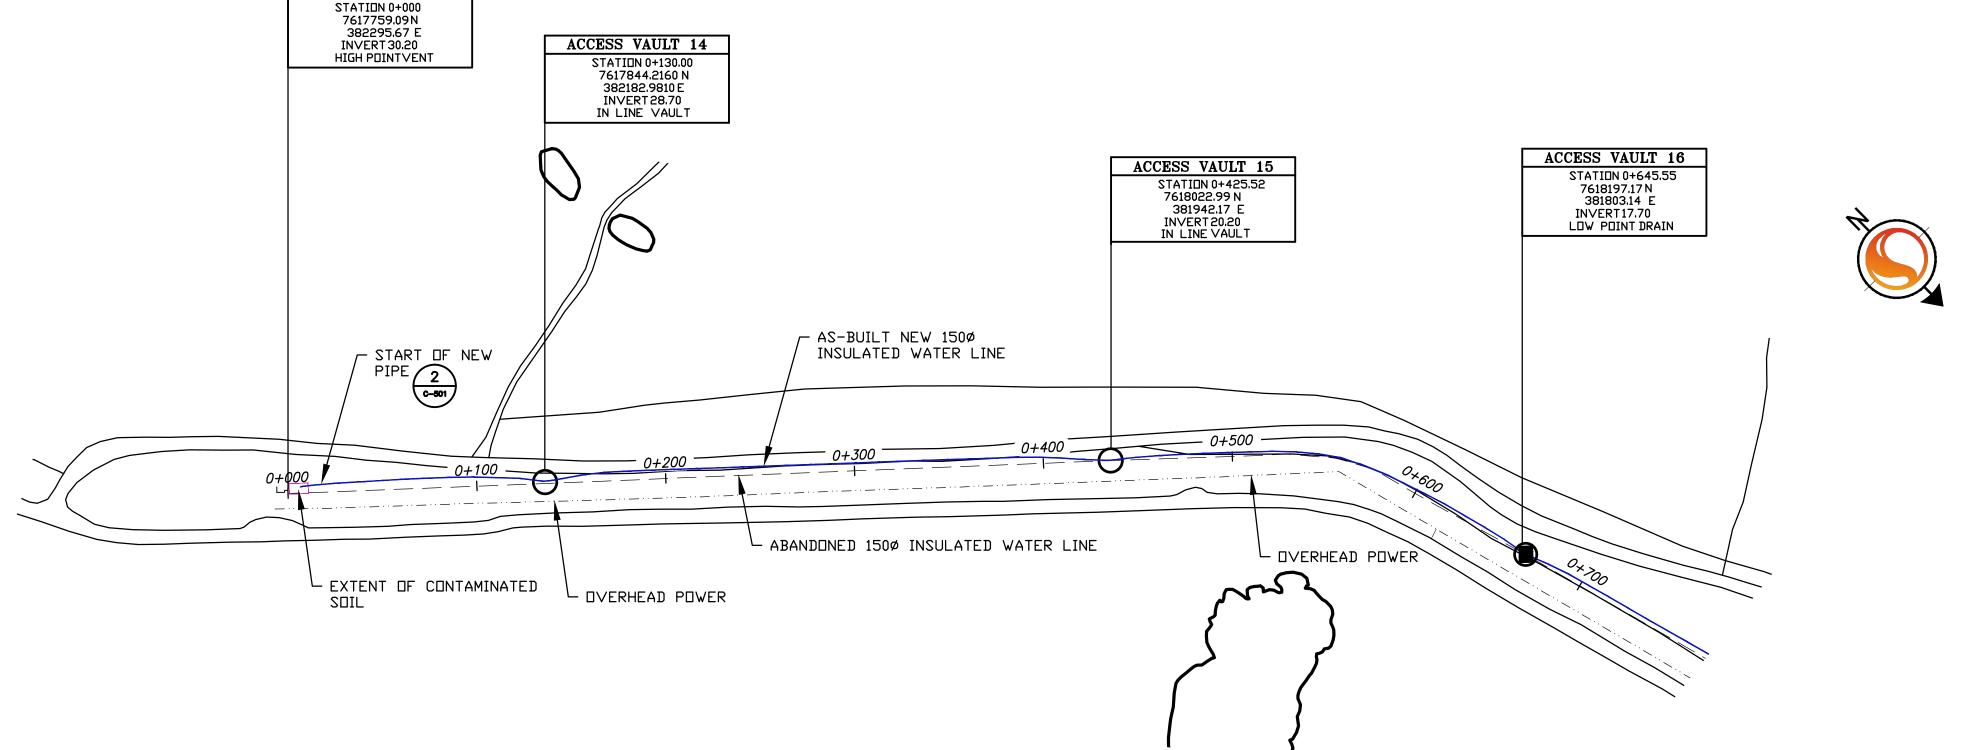



STANTEC ARCHITECTURE LTD.
4910 53rd St
Yellowknife, NT, Canada X1A 2P4
Tel. 867.920.2882
www.stantec.com

### Copyright Reserved

The Contractor shall verify and be responsible for all dimensions. DO NOT scale the drawing - any errors or omissions shall be reported to Stantec without delay.

The Copyrights to all designs and drawings are the property of Stantec. Reproduction or use for any purpose other than that authorized by Stantec is forbidden.

Consultants

Legend

INCLINE VAULT

HIGH POINT (AIR VENT) VAULT

ACCESS VAULT PROFILE

INSTALLED 150Ø INSULATED WATER LINE WITH INTERIOR 50Ø RECIRCULATION LINE

Note

## PLAN OF RECORD DRAWING

Contractor: KUDLIK CONSTRUCTION LTD

Construction Certification Date: December 9, 2015

Revision		Ву	Appd.	YY.MM.
ISSUED FOR RECORD		KK	WO	16.03.17
ISSUED FOR TENDER		AK	WO	15.02.28
ISSUED FOR 75% REVIEW		AK	WO	14.12.12
Issued		Ву	Appd.	YY.MM.D
File Name: 02165C-201 RECORD.DWG				
	Dwn.	Chkd.	Dsgn.	YY.MM.D

Permit-Seal

PERMIT TO PRACTICE
STANTEC ARCHITECTURE LTD.

Signature
Date
16 Macu 2016

PERMIT NUMBER: P 800

NT/NU Association of Professional Engineers and Geoscientists




Client/Project

Nunavut GJOA HAVEN WATER SUPPLY PIPELINE UPGRADES GJOA HAVEN, NU

itle

PIPELINE PLAN AND PROFILE STN 0+000 to 0+720

Project No.	Scale	
144902165	1:2000	
Drawing No.	Sheet	Revision
C-201	3 of 5	A/0

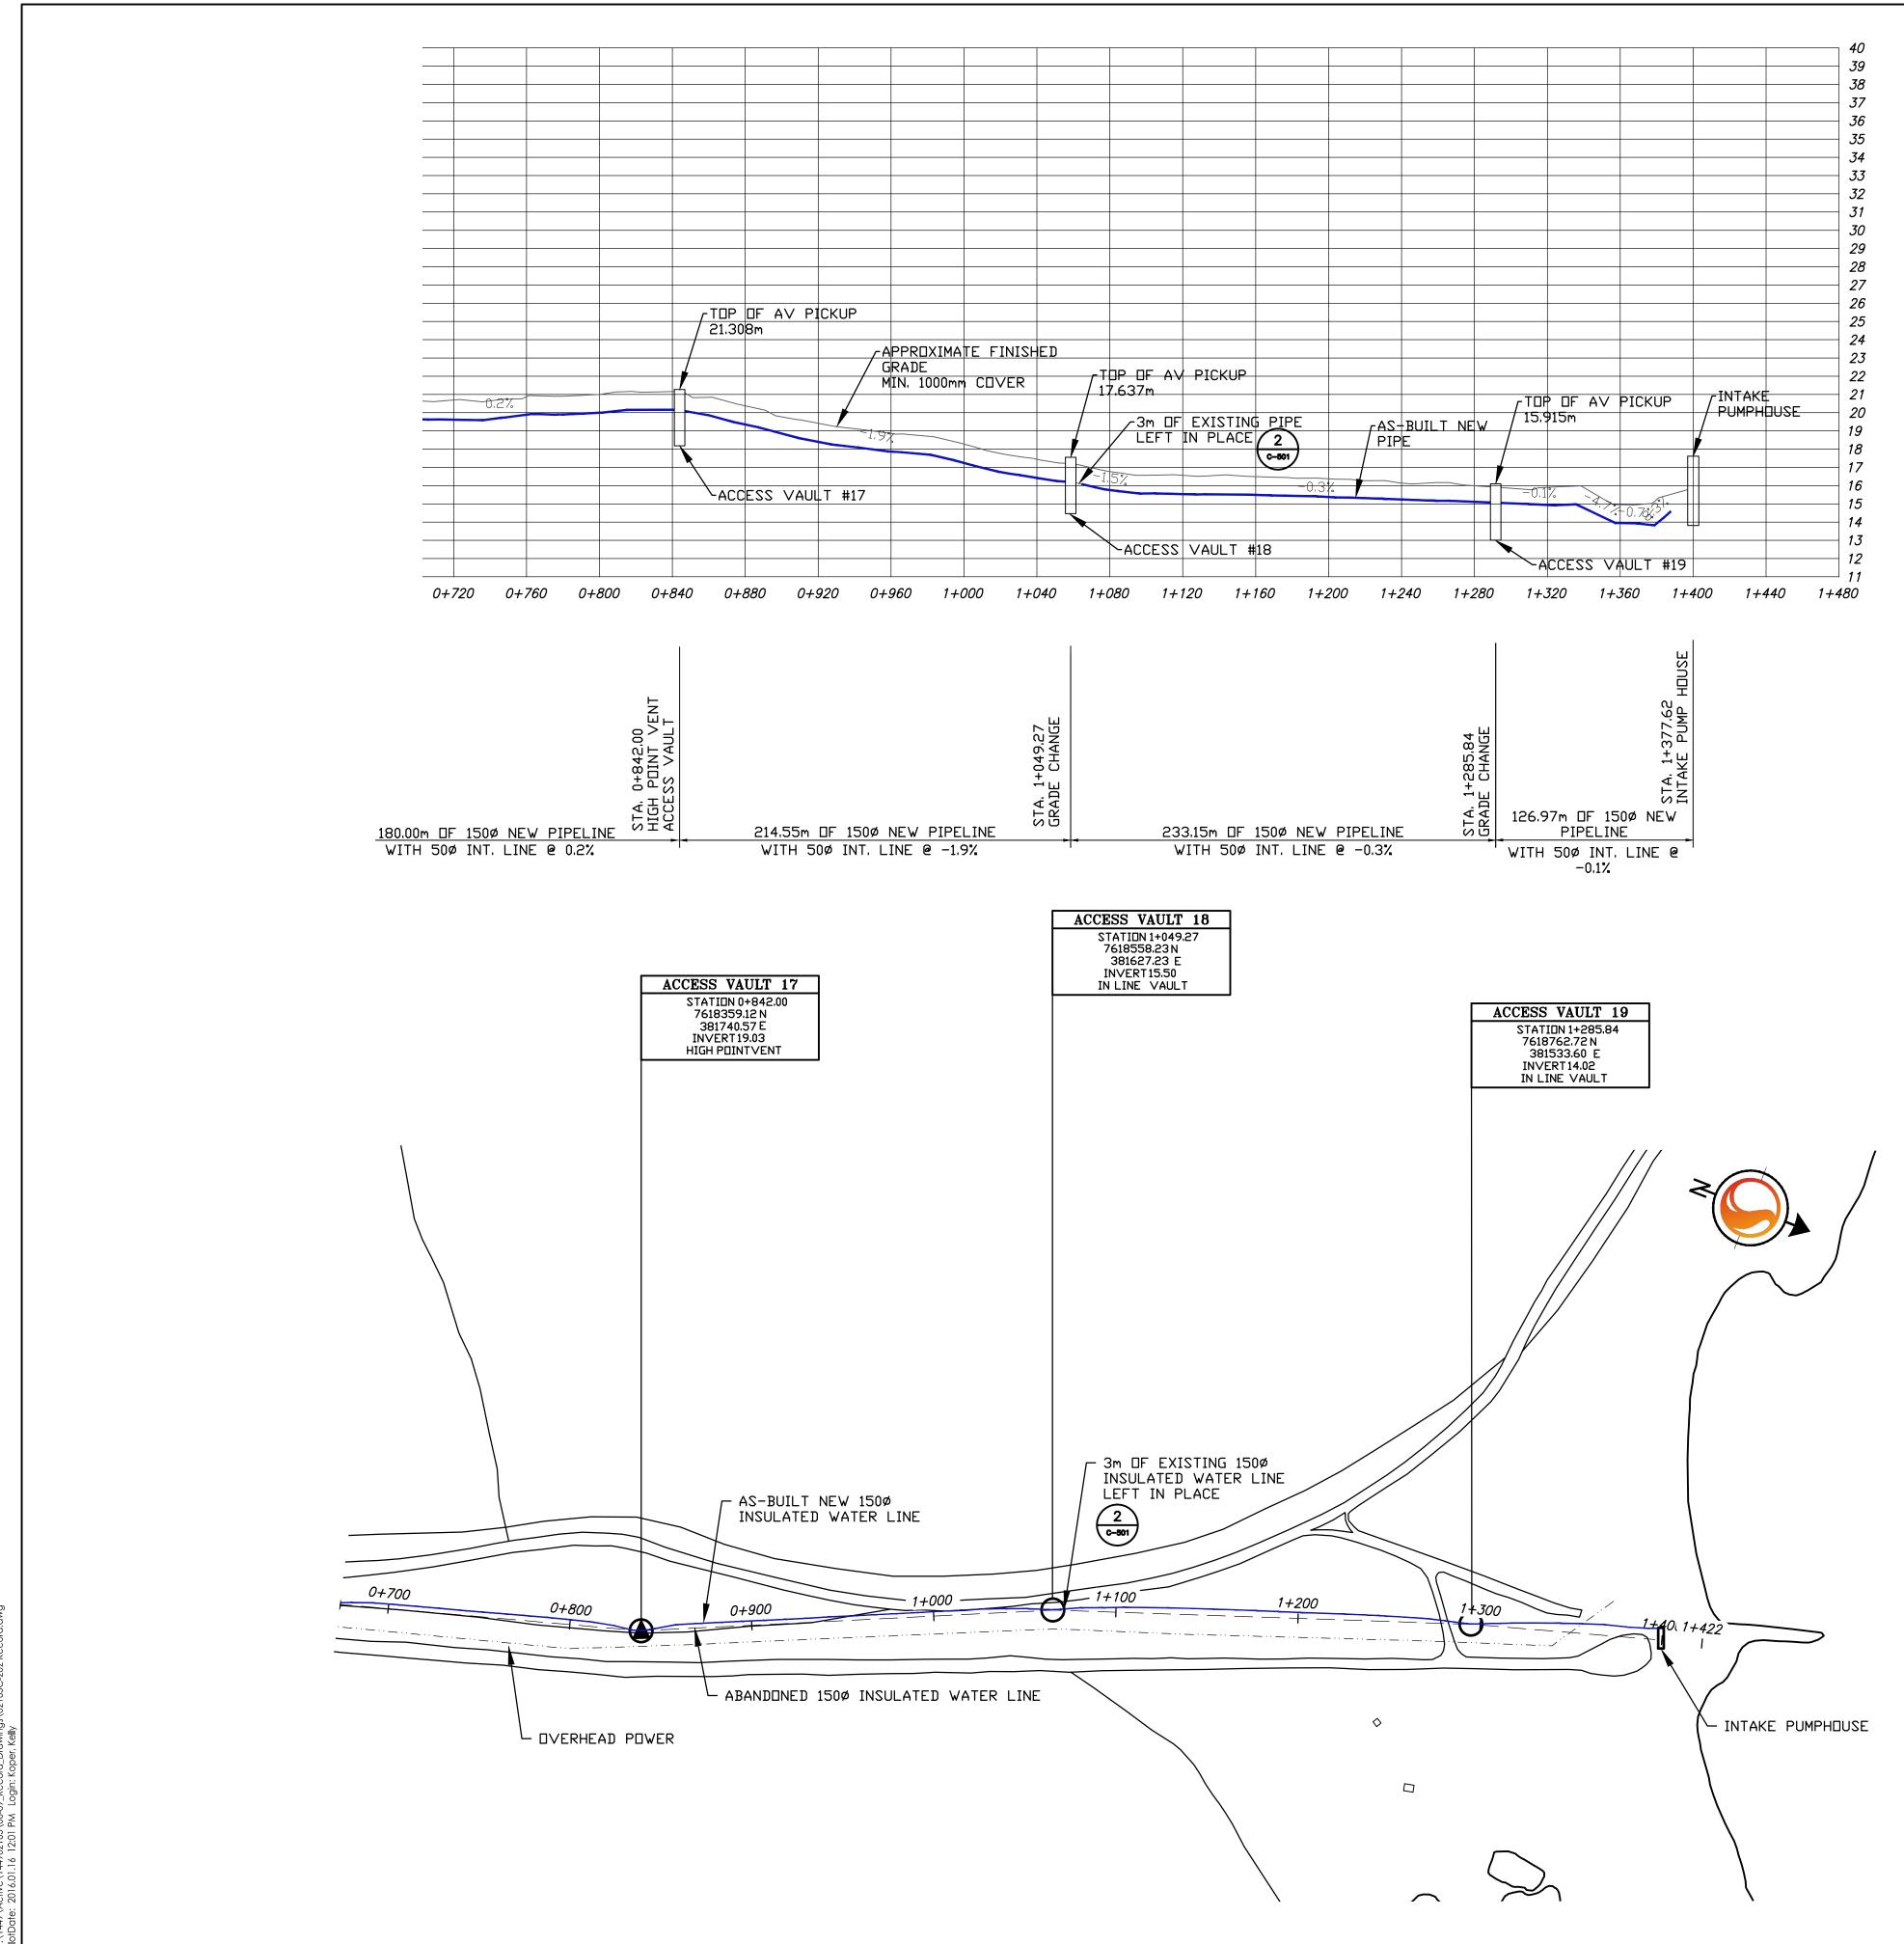



STANTEC ARCHITECTURE LTD.
4910 53rd St
Yellowknife, NT, Canada X1A 2P4
Tel. 867.920.2882
www.stantec.com

### Copyright Reserved

The Contractor shall verify and be responsible for all dimensions. DO NOT scale the drawing - any errors or omissions shall be reported to Stantec without delay.

The Copyrights to all designs and drawings are the property of Stantec. Reproduction or use for any purpose other than that authorized by Stantec is forbidden.

Consultants

Legend

\_\_\_\_\_\_\_INCL

INCLINE VAULT

HIGH POINT (AIR VENT) VAULT

ACCESS VAULT PROFILE

INSTALLED 150¢ INSULATED WATER LINE WITH INTERIOR 50¢ RECIRCULATION LINE

Notes


# PLAN OF RECORD DRAWING

Contractor: KUDLIK CONSTRUCTION LTD

Construction Certification Date: December 9, 2015

Revision	Ву	Appd.	YY.MM.DD
ISSUED FOR RECORD			16.03.17
ISSUED FOR TENDER	 AK	WO	15.02.28
ISSUED FOR 75% REVIEW	AK	WO	14.12.12
Issued	 By	Appd.	YY.MM.DI

Permit-Seal

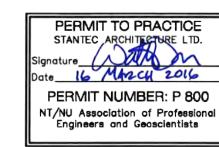

Client/Project



GJOA HAVEN WATER SUPPLY PIPELINE UPGRADES


GJOA HAVEN, NU

Title

PIPELINE PLAN AND PROFILE STN 0+720 to 1+400

Project No. 144902165	Scale 1:2000	
Drawing No.	Sheet	Revision
C-202	4 of 5	A/0

ORIGINAL SHEET - ANSI D

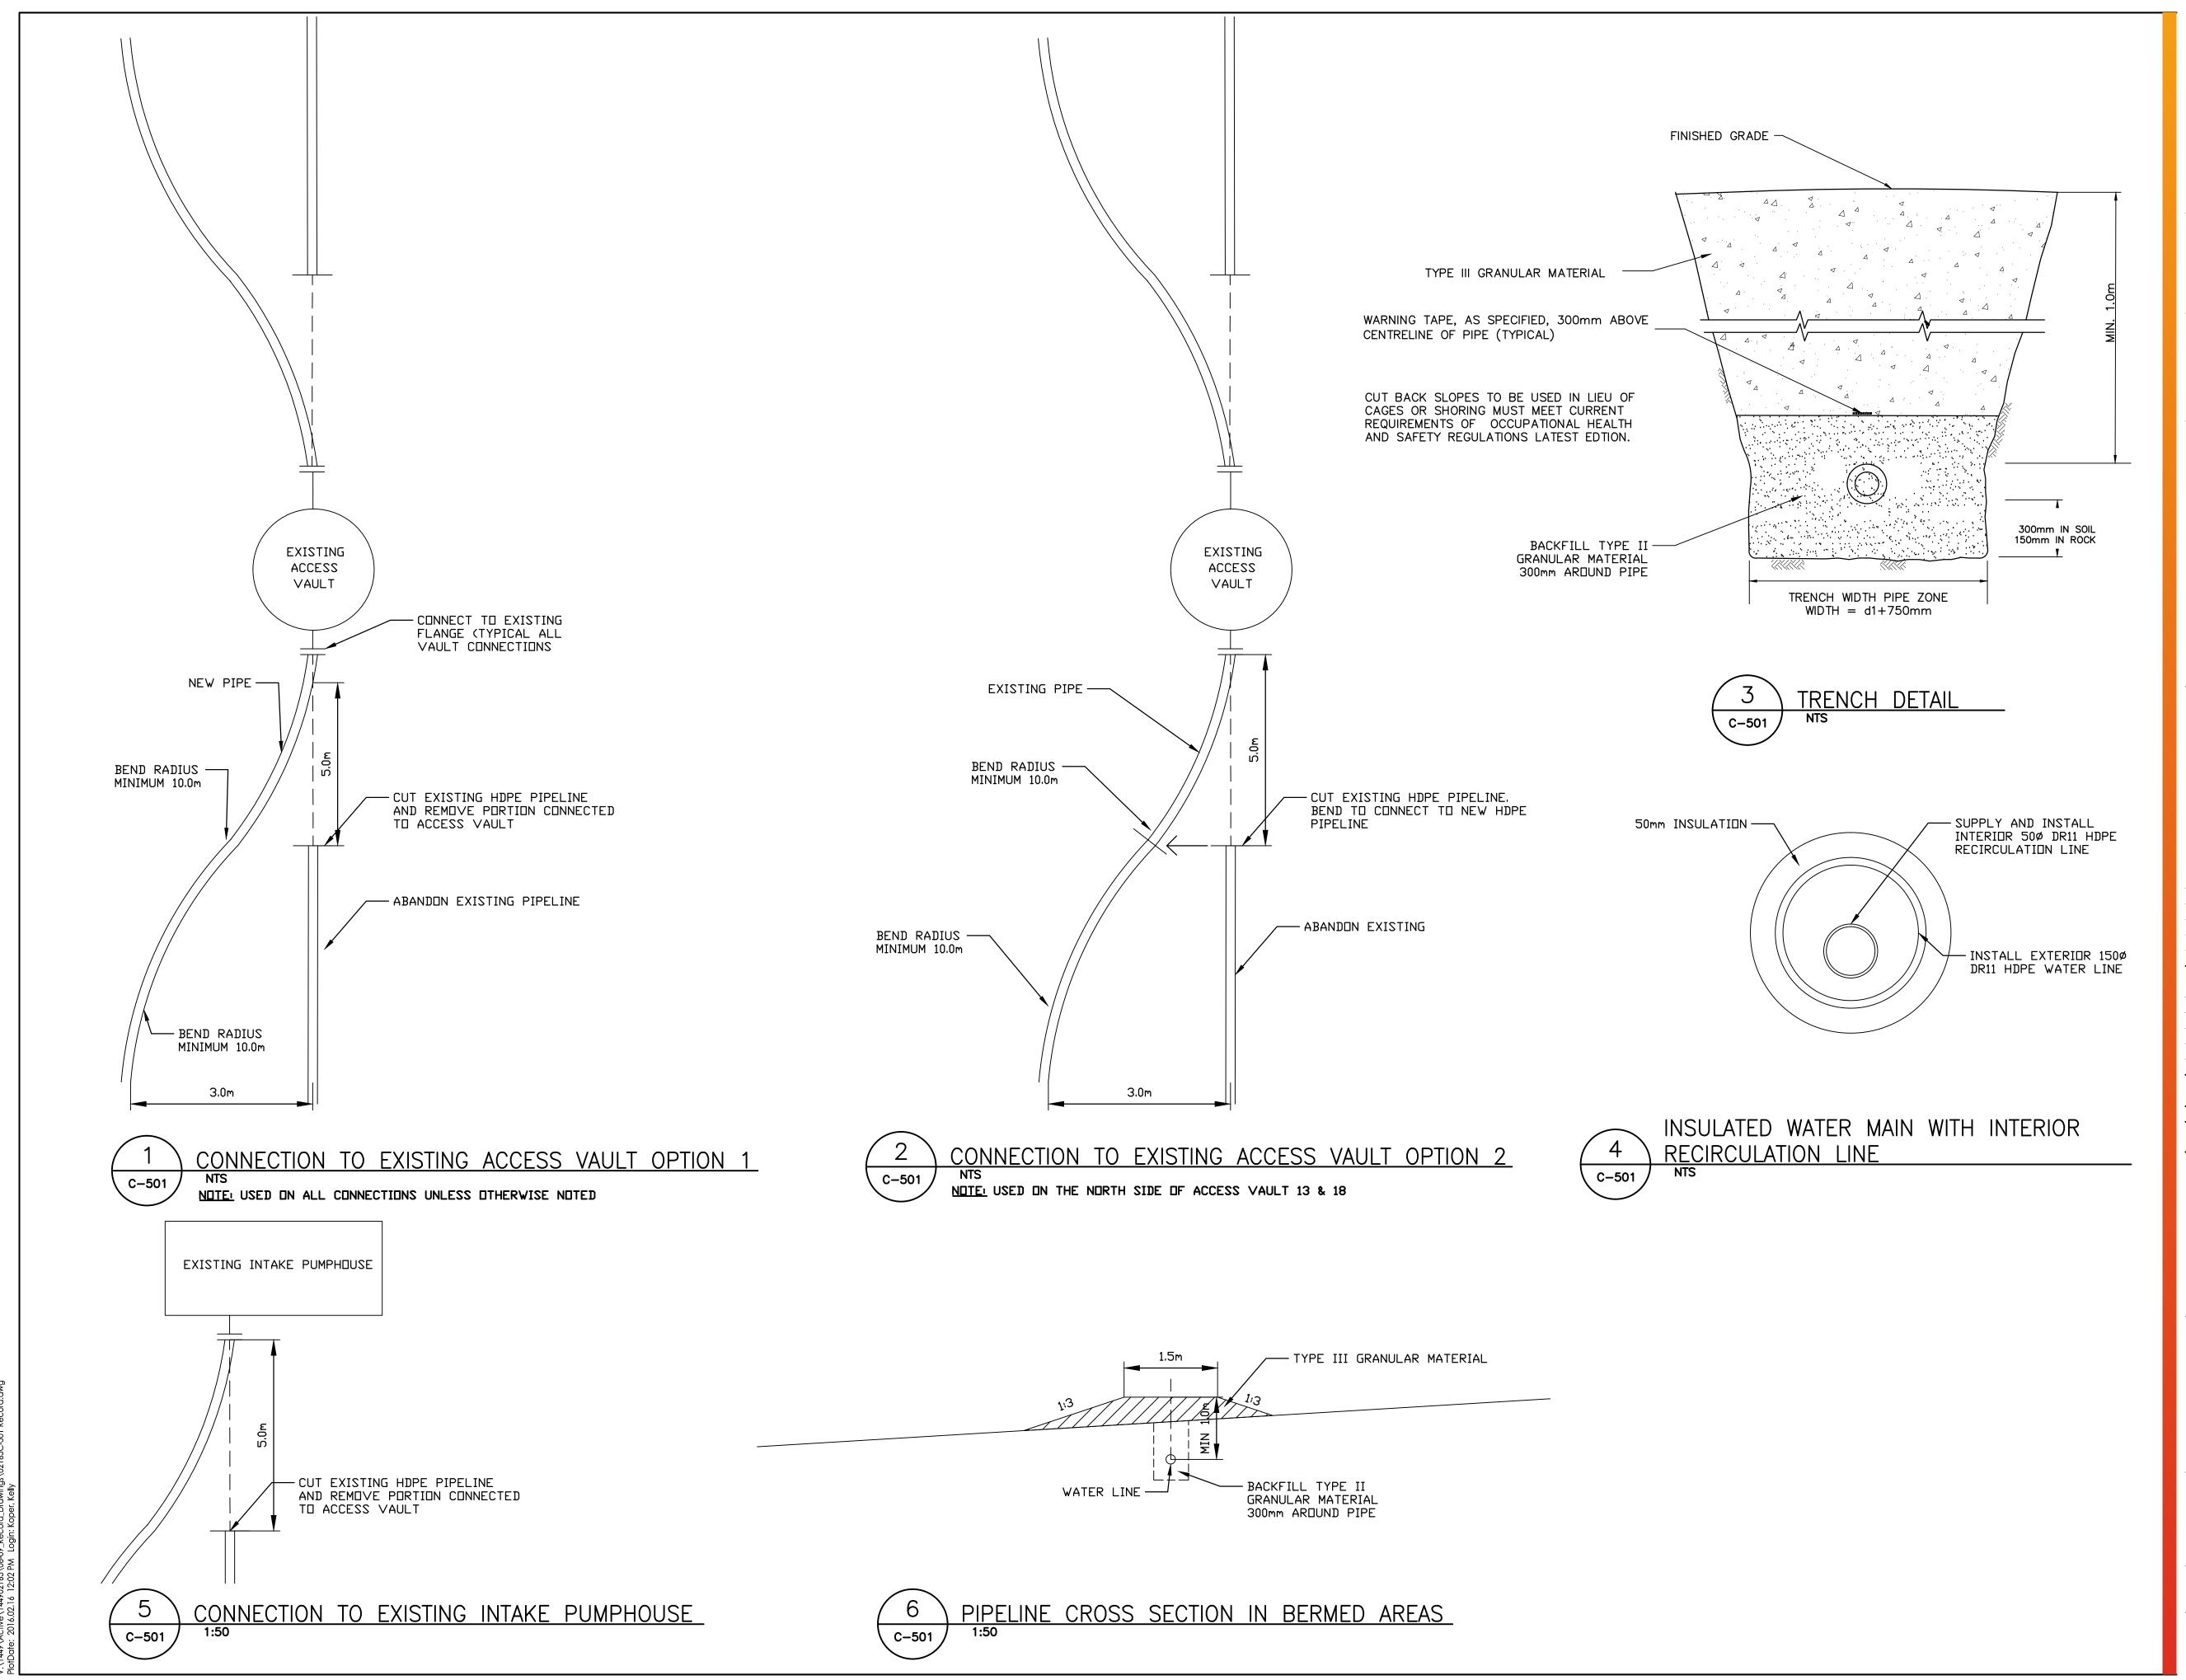



STANTEC ARCHITECTURE LTD. 4910 53rd St Yellowknife, NT, Canada X1A 2P4 Tel. 867.920.2882

### Copyright Reserved

www.stantec.com

The Contractor shall verify and be responsible for all dimensions. DO NOT scale the drawing - any errors or omissions shall be reported to Stantec without delay. The Copyrights to all designs and drawings are the property of Stantec. Reproduction or use for any purpose other than that authorized by Stantec is forbidden.

Consultants


Legend

# PLAN OF RECORD DRAWING

Contractor: KUDLIK CONSTRUCTION LTD Construction Certification Date: December 9, 2015

Revision		Ву	Appd.	YY.MM.DD
ISSUED FOR RECORD		KK	WO	16.03.17
ISSUED FOR TENDER		AK	wo	15.02.28
ISSUED FOR 75% REVIEW		AK	wo	14.12.12
Issued		Ву	Appd.	YY.MM.DD
File Name: 02165C-501 RECORD.DWG		_		
_	Dwn.	Chkd.	Dsgn.	YY.MM.DD

Permit-Seal

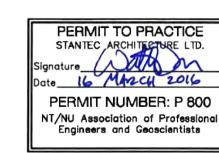



Client/Project



PIPELINE CONNECTION AND BERM DETAILS

Project No. 144902165	Scale AS SHOWN	
Drawing No.	Sheet	Revision
C-501	5 of 5	A/0