Attachment **E**

For-Construction Drawings and Description of the Water and Sewage Treatment Infrastructure Upgrades

Water and Sewage Treatment Infrastructure Upgrades

Purpose

The purpose of the proposed Water and Sewage Treatment Infrastructure Upgrades is to replace or upgrade the existing water (raw and sewage) storage and treatment systems at the Eureka HAWS and to treat up to 28m³/day of wastewater. Stamped and certified for-construction drawings of the Water and Sewage Treatment Infrastructure Upgrades are attached below.

Description

Development of a new raw water storage reservoir and associated infrastructure as well as incorporation of the existing raw water storage reservoir. A new packaged wastewater treatment plant will also be installed, as well as upgrades and conversion of the existing wastewater lagoon to a retention pond. Wastewater discharge piping and overflow will also be upgraded.

The work is expected to commence in June 2022 and be completed by 2025. The new wastewater treatment plant will be sealifted to site and consists of four (4), 6m long high-cube shipping containers with peak hour flow capacity of 28m³/day. In 2022, site preparation will commence which will include levelling and preparing pads. Other earthworks will include excavation, placement of granular, compaction, and grading including construction of berms. Drains and thermistors will then be installed within the underlying soil for the reservoir.

Once the packaged wastewater treatment is installed, the existing sewage lagoon will be converted to a retention pond. Treated effluent that meets the parameters identified in Part D, Item 10 of the Licence will be discharged into the ocean.

In 2023, the construction of the new raw water storage area will continue and include installation of sand, drainage piping, a dual liner, and geotextiles. As well, pump stations will be positioned, and a raw water storage basin will be filled with water. In 2024, the pump stations will be connected so water from the existing reservoir can be transferred to the new reservoir. In 2025, inspections will be undertaken.

Plans for Operation

The Summary of Operation and Maintenance Procedures for Drinking Water, Sewage, Solid Waste Disposal and Waste Treatment Facilities (June 2021 Amendment Renewal Application, Attachment E) previously provided will be revised to include details specific to the new facilities. This will be shared with the NWB within 90-days after completion of construction in 2023.

Plans for Decommissioning

Plans for decommissioning of the water and sewage treatment facilities is consistent with the Interim Abandonment & Restoration Plan previously provided (June 2021 Amendment Renewal Application, Attachment F). The Abandonment and Restoration Objectives, and actions to be taken to achieve objectives for the "pumphouse, water reservoir, water diversion area, and sewage lagoon," all apply to this amendment and remain unchanged.



Travaux publics et Services gouvernementaux Canada

REAL PROPERTY SERVICES Western Region SERVICES IMMOBILIERS

Région de l'ouest

DRAWING LIST

G-0001	COVER SHEET
C-0001	CIVIL - OVERALL EXISTING SITE PLAN
C-0002	CIVIL - OVERALL PROPOSED SITE PLAN
C-0003	CIVIL - NEW RAW WATER RESERVOIR PROPOSED SITE PLAN
C-0004	CIVIL - RETENTION BASIN UPGRADE & WASTEWATER PROPOSED SITE PLAN
C-0005	CIVIL - CREEK PUMP STATION CROSS SECTIONS
C-0006	CIVIL - RESERVOIR PUMP STATION PLAN AND SECTION VIEWS
C-0007	CIVIL - UPGRADED RETENTION BASIN PLAN, CROSS SECTIONS AND DETAILS
C-0008	CIVIL - OVERALL PROPOSED MATERIAL HAUL ROUTE
C-0009	CIVIL - CONTAMINATED SOIL STORAGE CELL PLAN, CROSS SECTION AND LOCATION PLAN
C-3001	CIVIL - NEW RAW WATER STORAGE RESERVOIR PROFILES AND SECTIONS
C-3002	CIVIL - UPGRADED RETENTION BASIN PROFILES AND SECTIONS
C-5001	CIVIL - GENERAL CIVIL DETAILS SHEET 1 OF 2
C-5002	CIVIL - GENERAL CIVIL DETAILS SHEET 2 OF 2
S-0001	STRUCTURAL - PACKAGED WASTEWATER TREATMENT PLANT AND PUMP STATIONS LOCATION PLAN
S-0002	STRUCTURAL - PACKAGED WASTEWATER TREATMENT PLANT PLAN
S-0003	STRUCTURAL - CREEK, RAW WATER AND RETENTION BASIN PUMP STATIONS PLANS
S-0004	STRUCTURAL - PACKAGED WASTEWATER TREATMENT PLANT AND PUMP STATION CRIBBING PLANS
S-3001	STRUCTURAL - PACKAGED WASTEWATER TREATMENT PLANT AND TYPICAL PUMP STATION PLANS AND SECTIONS
S-4001	STRUCTURAL - PACKAGED WASTEWATER TREATMENT PLANT ELEVATIONS
S-4002	STRUCTURAL - RESERVOIR AND RETENTION BASIN PUMP STATION ELEVATIONS
S-5001	STRUCUTRAL - PACKAGED WASTEWATER TREATMENT PLANT AND PUMP STATIONS CRIBBING DETAILS
N-0001	PROCESS & INSTRUMENTATION - OVERALL DIAGRAM & SCHEMATICS LEGEND, ABBREVIATIONS AND INSTRUMENTATION
N-0002	PROCESS & INSTRUMENTATION - PACKAGED WASTEWATER TREATMENT PLANT & LIFT STATION PRETREATMENT DIAGRAM
N-0003	PROCESS & INSTRUMENTATION - PACKAGED WASTEWATER TREATMENT PLANT AERATION, SEDIMENTATION & BLOWER DIAGRA
N-0004	PROCESS & INSTRUMENTATION - PACKAGED WASTEWATER TREATMENT PLANT FINAL DISINFECTION DIAGRAM
N-0005	PROCESS & INSTRUMENTATION - PACKAGED WASTEWATER TREATMENT PLANT BLOWERS AND SOLIDS DIAGRAM
N-0006	PROCESS & INSTRUMENTATION - RAW WATER RECIRCULATION SYSTEM AND BACKUP INTAKE
N-0007	PROCESS & INSTRUMENTATION - RAW WATER RECIRCULATION SYSTEM DIAGRAM
D-0001	PROCESS MECHANICAL - EXISTING LIFT STATION UPGRADE PLAN, SECTION AND DETAIL
D-0001 D-0002	PROCESS MECHANICAL - RAW WATER RESERVOIR PUMP STATION PLAN
D-3001	PROCESS MECHANICAL - RAW WATER RESERVOIR RAW WATER SUPPLY AND CHLORINATION CROSS SECTION AND DETAILS
D-5001	PROCESS MECHANICAL - GENERAL PIPING DETAILS SHEET 1 OF 2
D-5002	PROCESS MECHANICAL - GENERAL PIPING DETAILS SHEET 2 OF 2
H-0001	MECHANICAL - EUREKA STATION PARTIAL MAIN FLOOR PLAN
E-0000	ELECTRICAL - LEGEND
E-0001	ELECTRICAL - SITE PLAN
E-0002	ELECTRICAL - CATEGORY & HAZARDOUS AREA CLASSIFICATION
E-0003	ELECTRICAL - PUMP HOUSES & UPGRADED EXISTING LIFT STATION PLANS
E-0004	ELECTRICAL - EXISTING LIFT STATION PLAN
E-0005	ELECTRICAL - GENERATOR BUILDING PLAN
E-0006	ELECTRICAL - SCHEDULES
E-0007	ELECTRICAL - SINGLE LINE DIAGRAM
F-0008	FLECTRICAL - DETAILS

PUBLIC WORKS AND GOVERNMENT SERVICES CANADA

310-269 Main Street, R3C 1B3 WINNIPEG, MANITOBA


EUREKA, NUNAVUT


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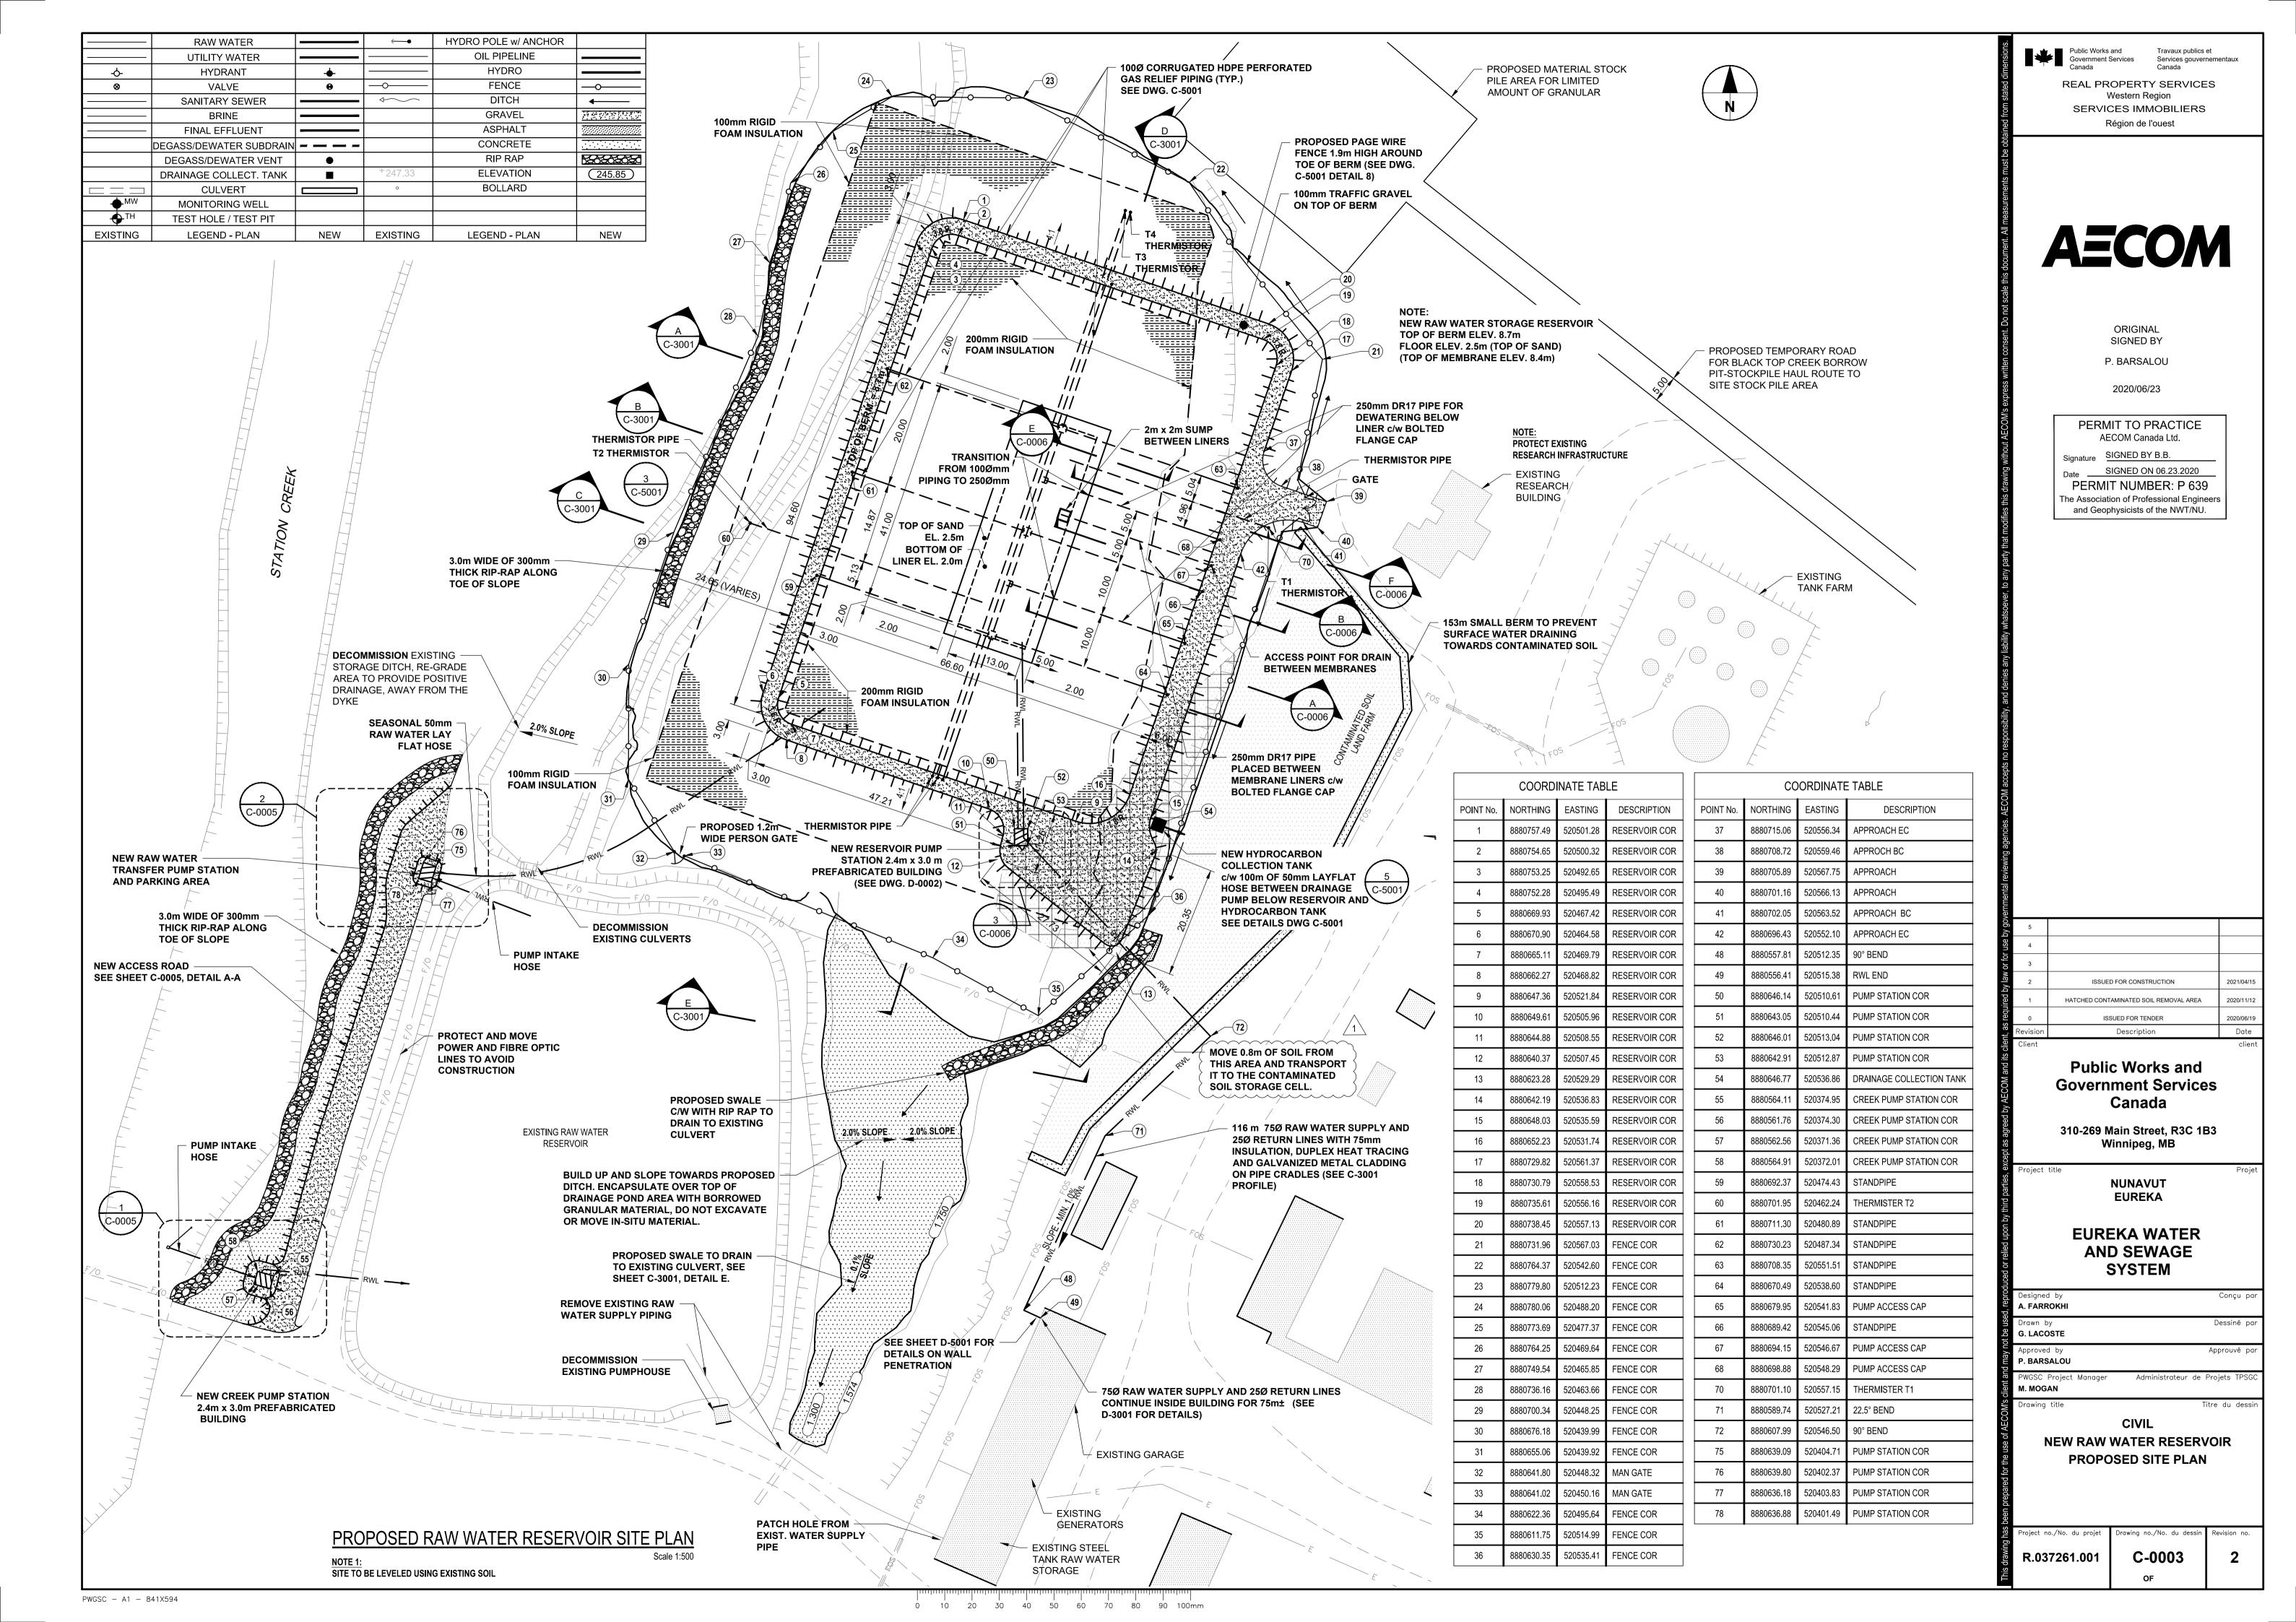
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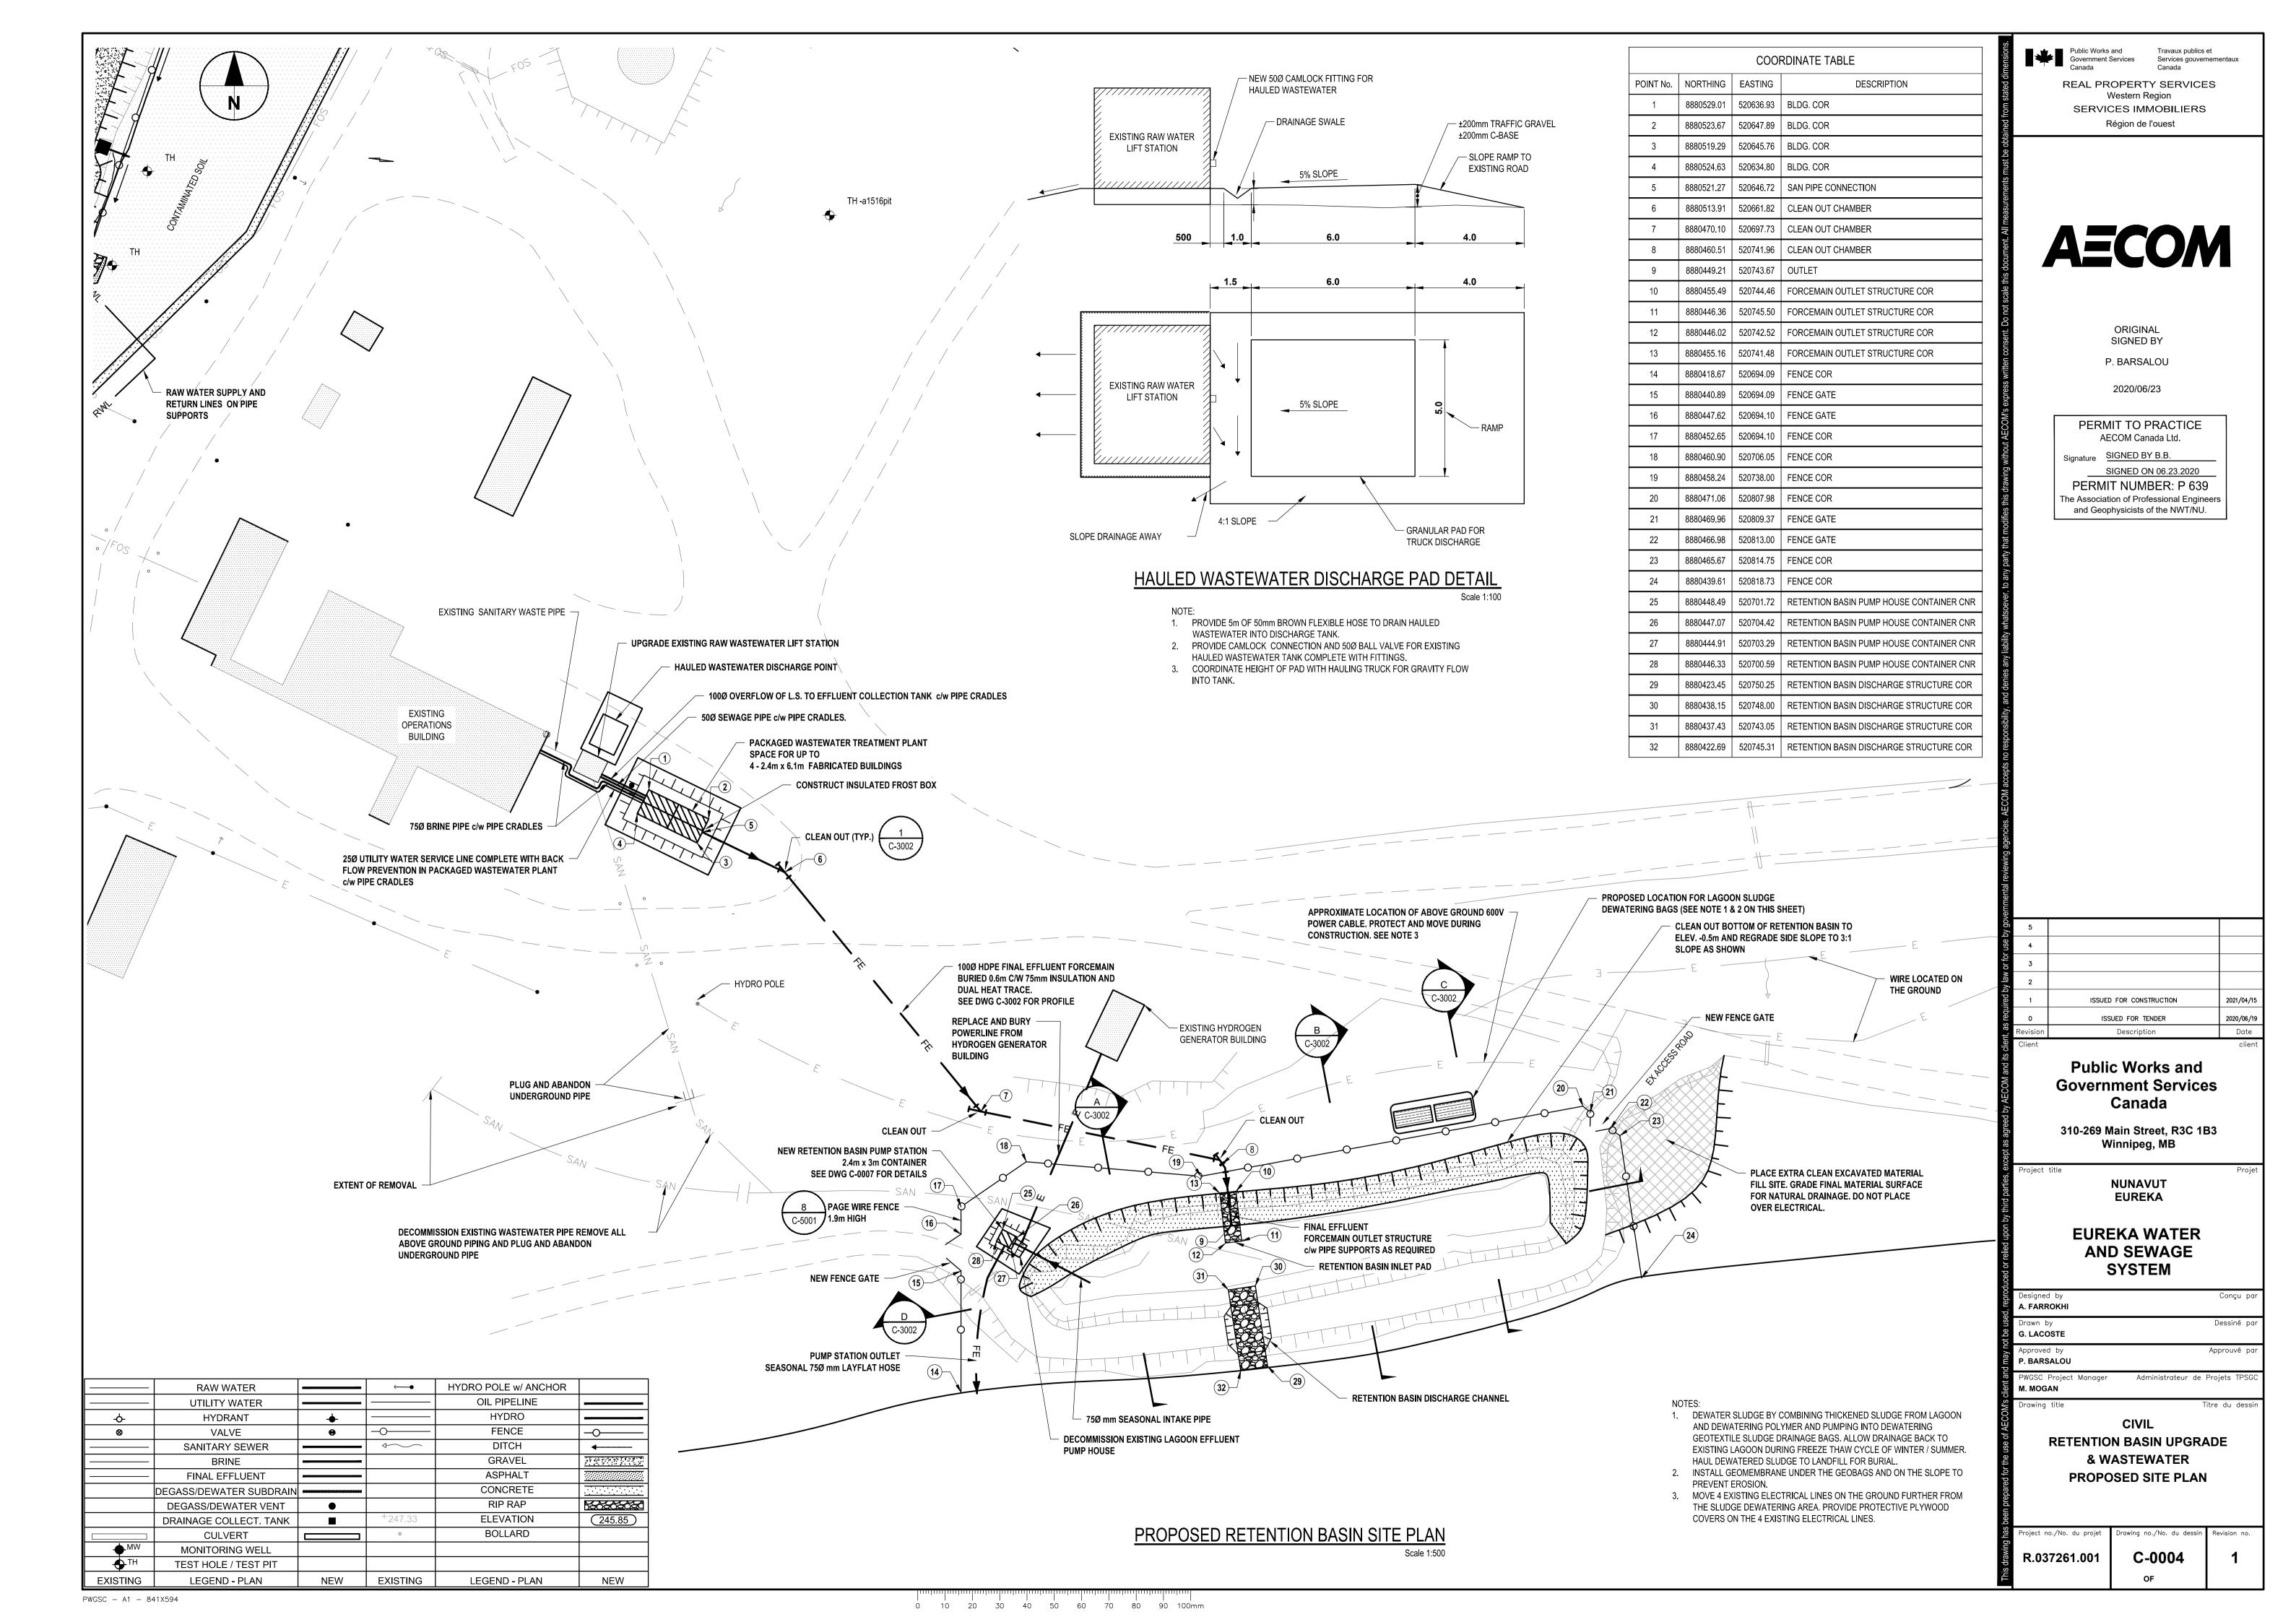











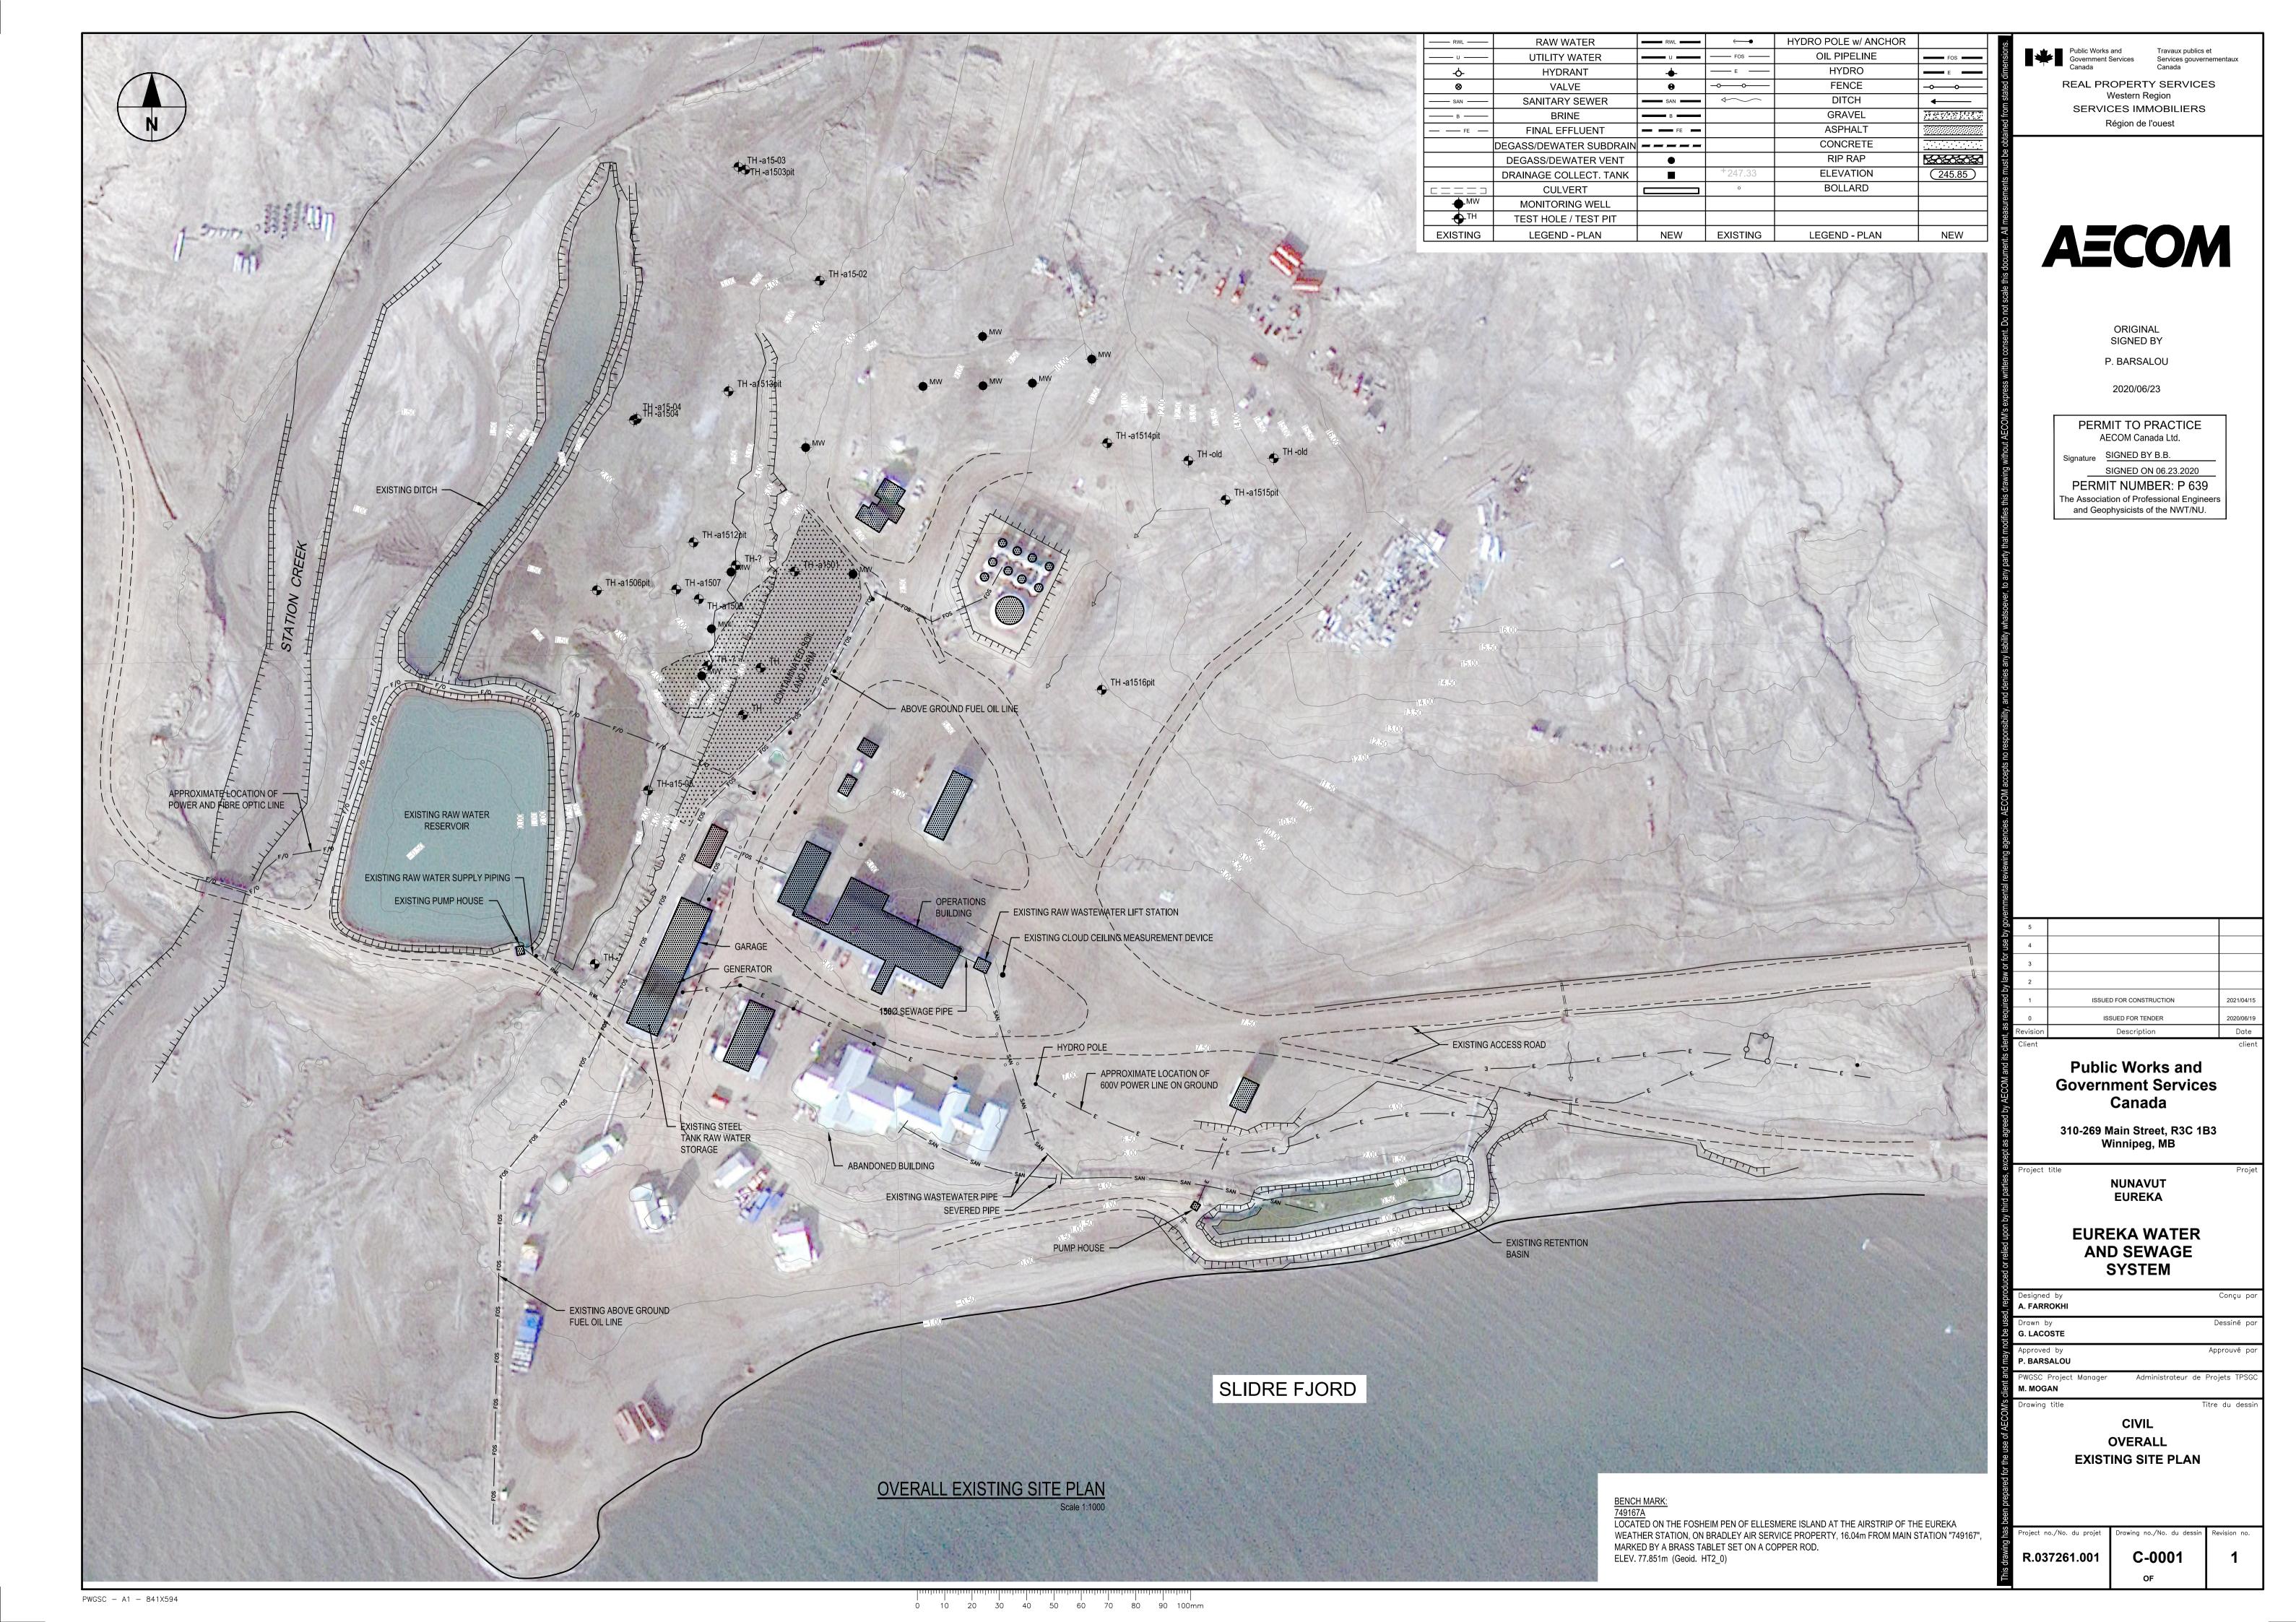


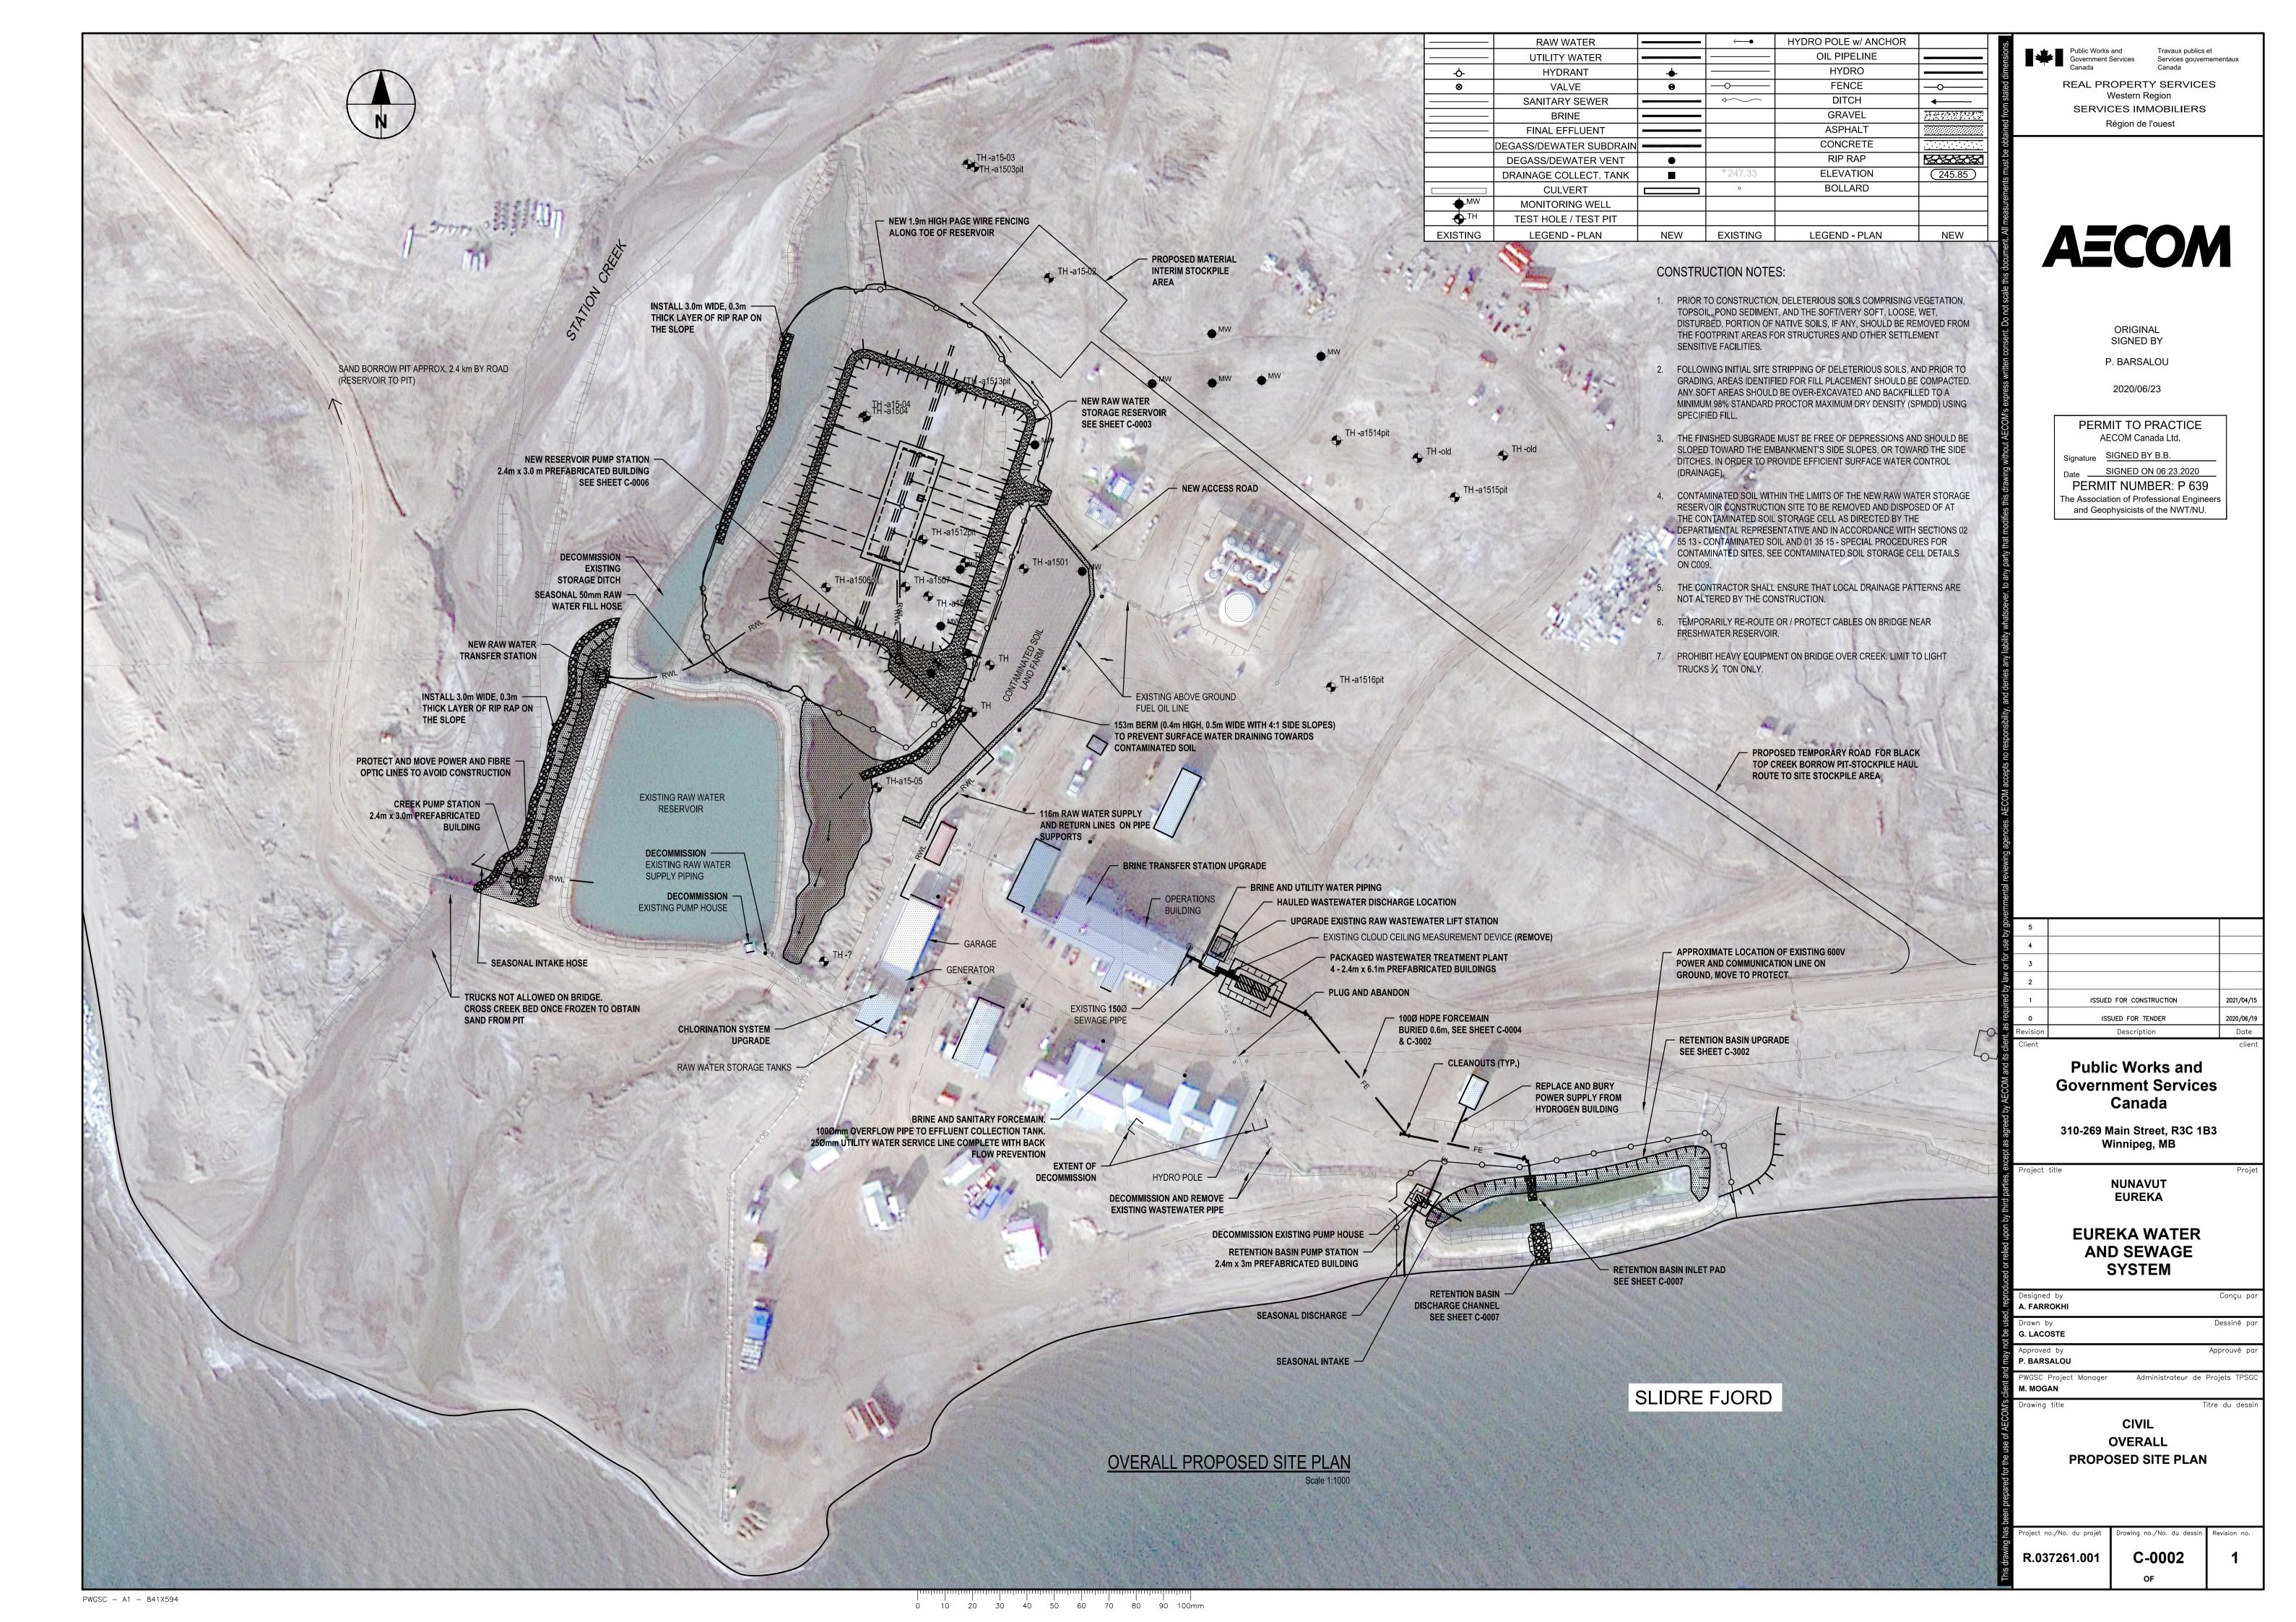


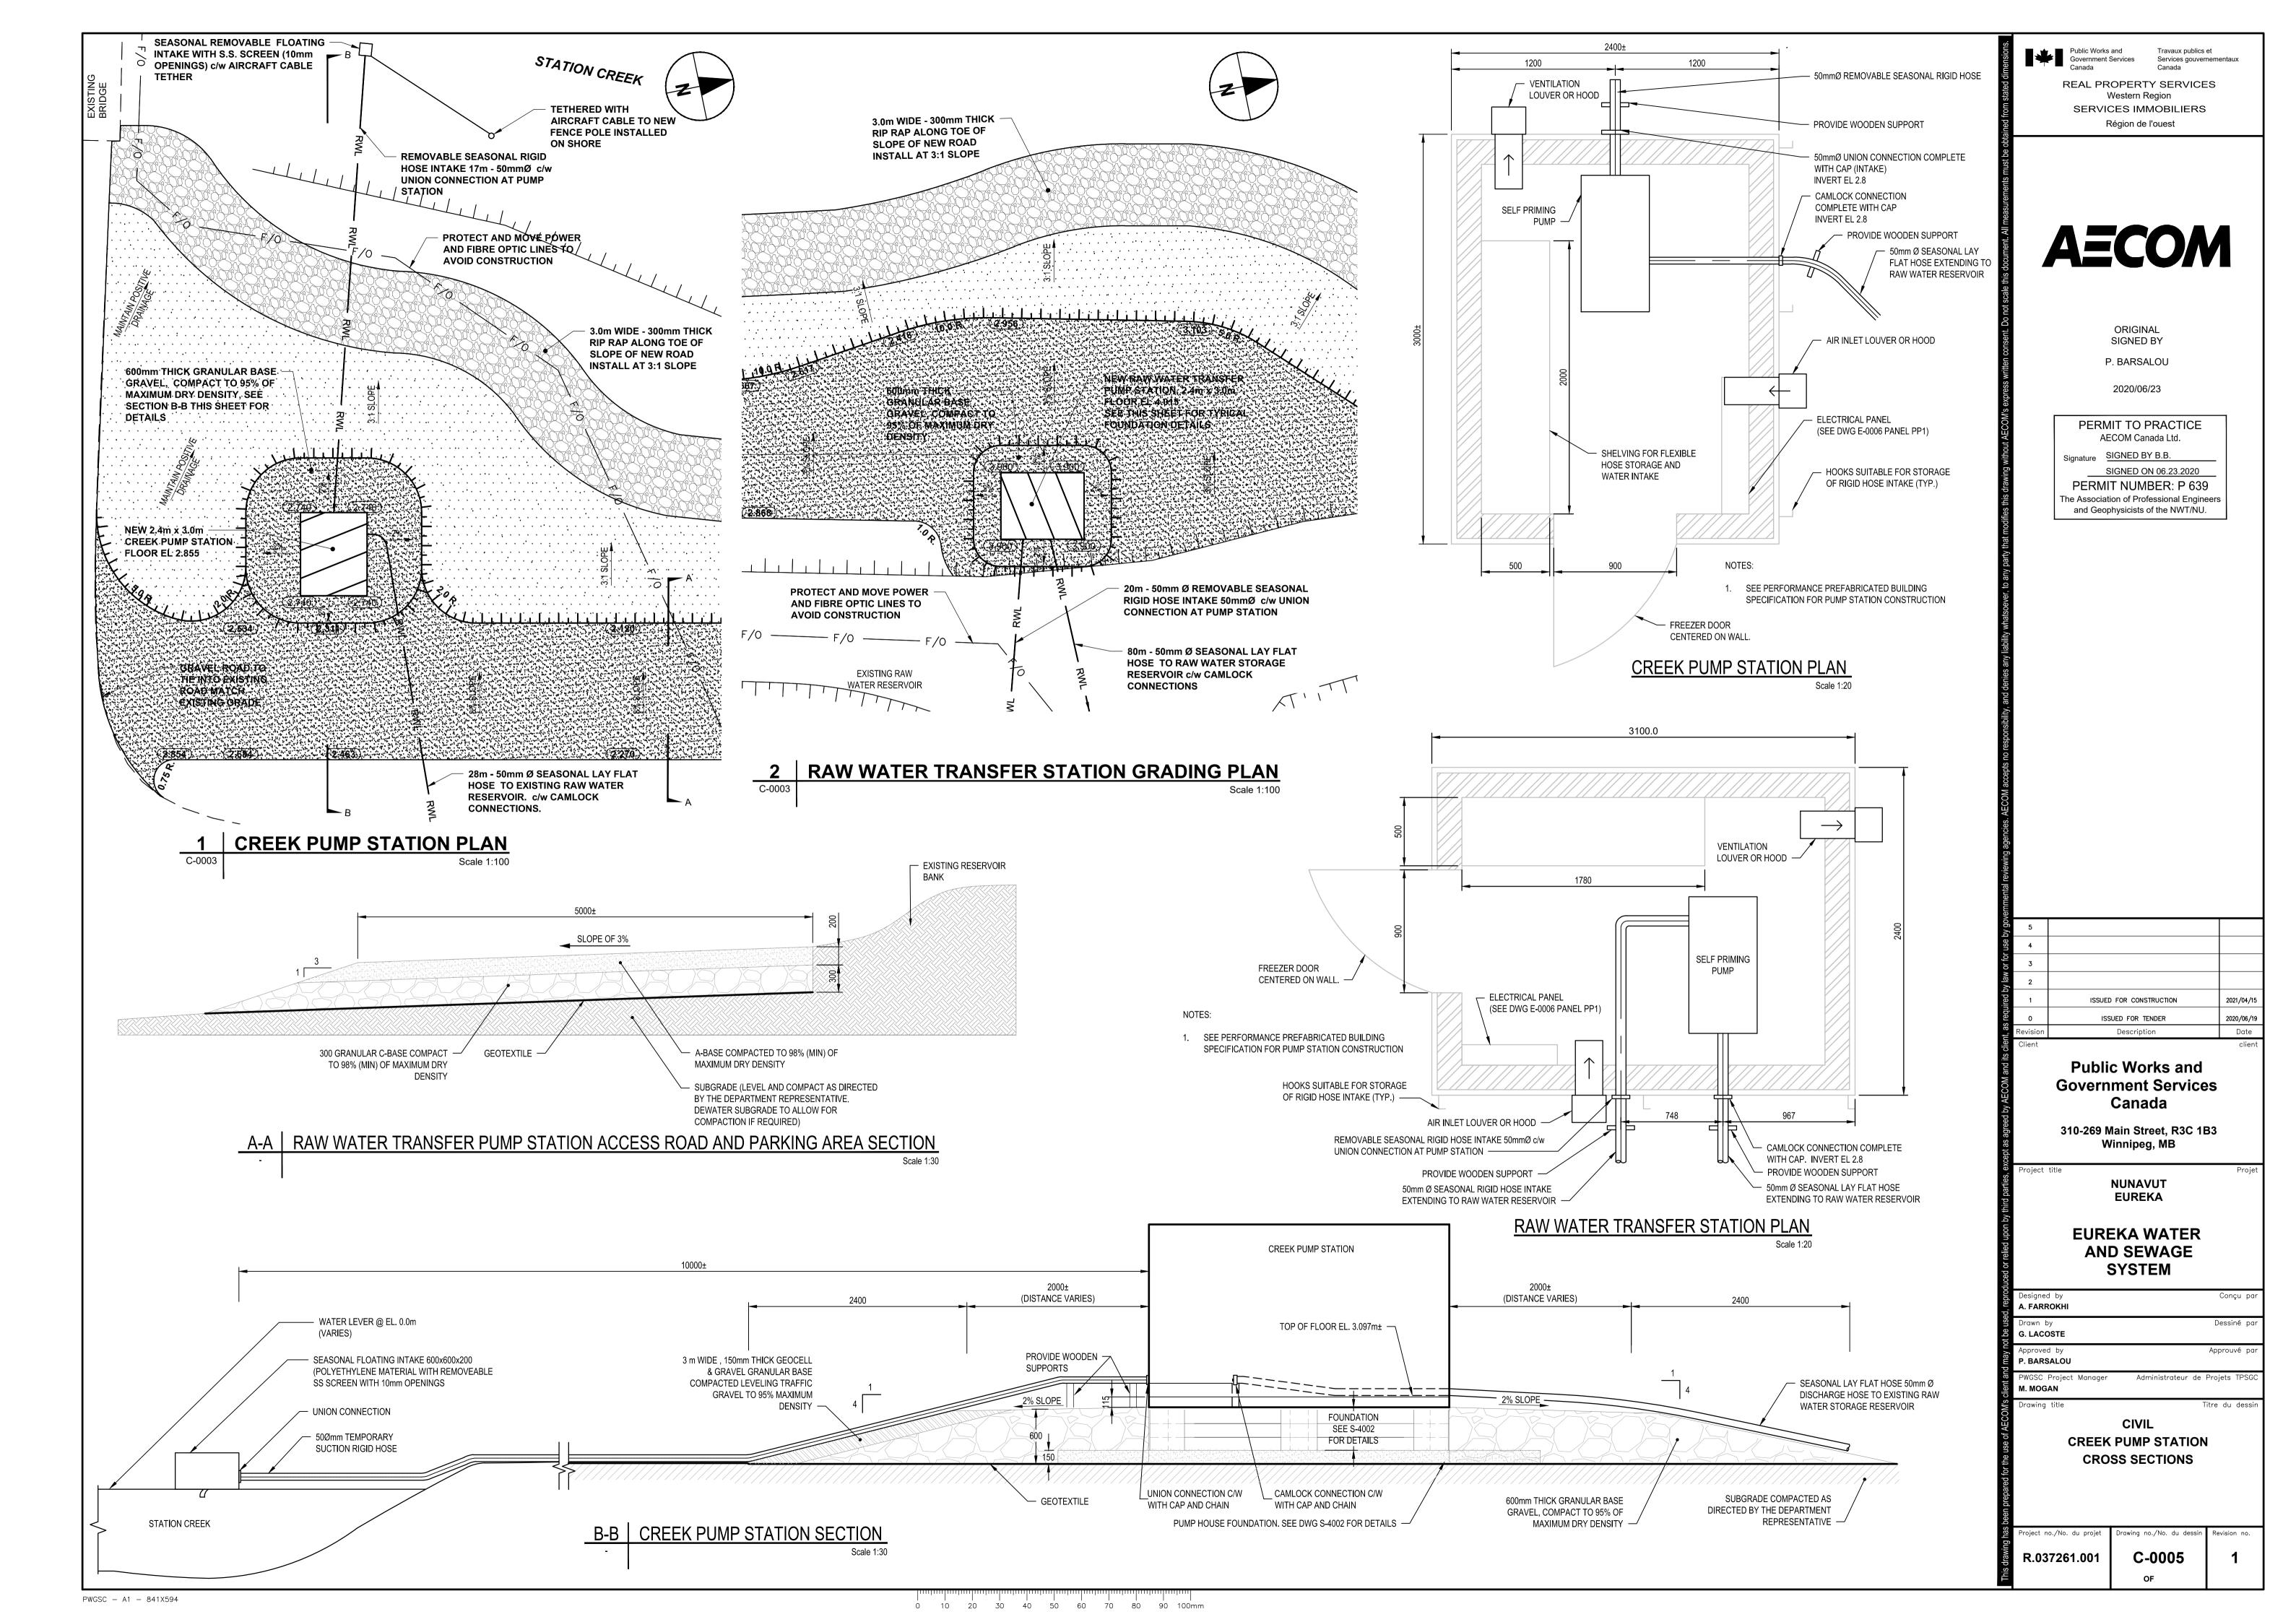

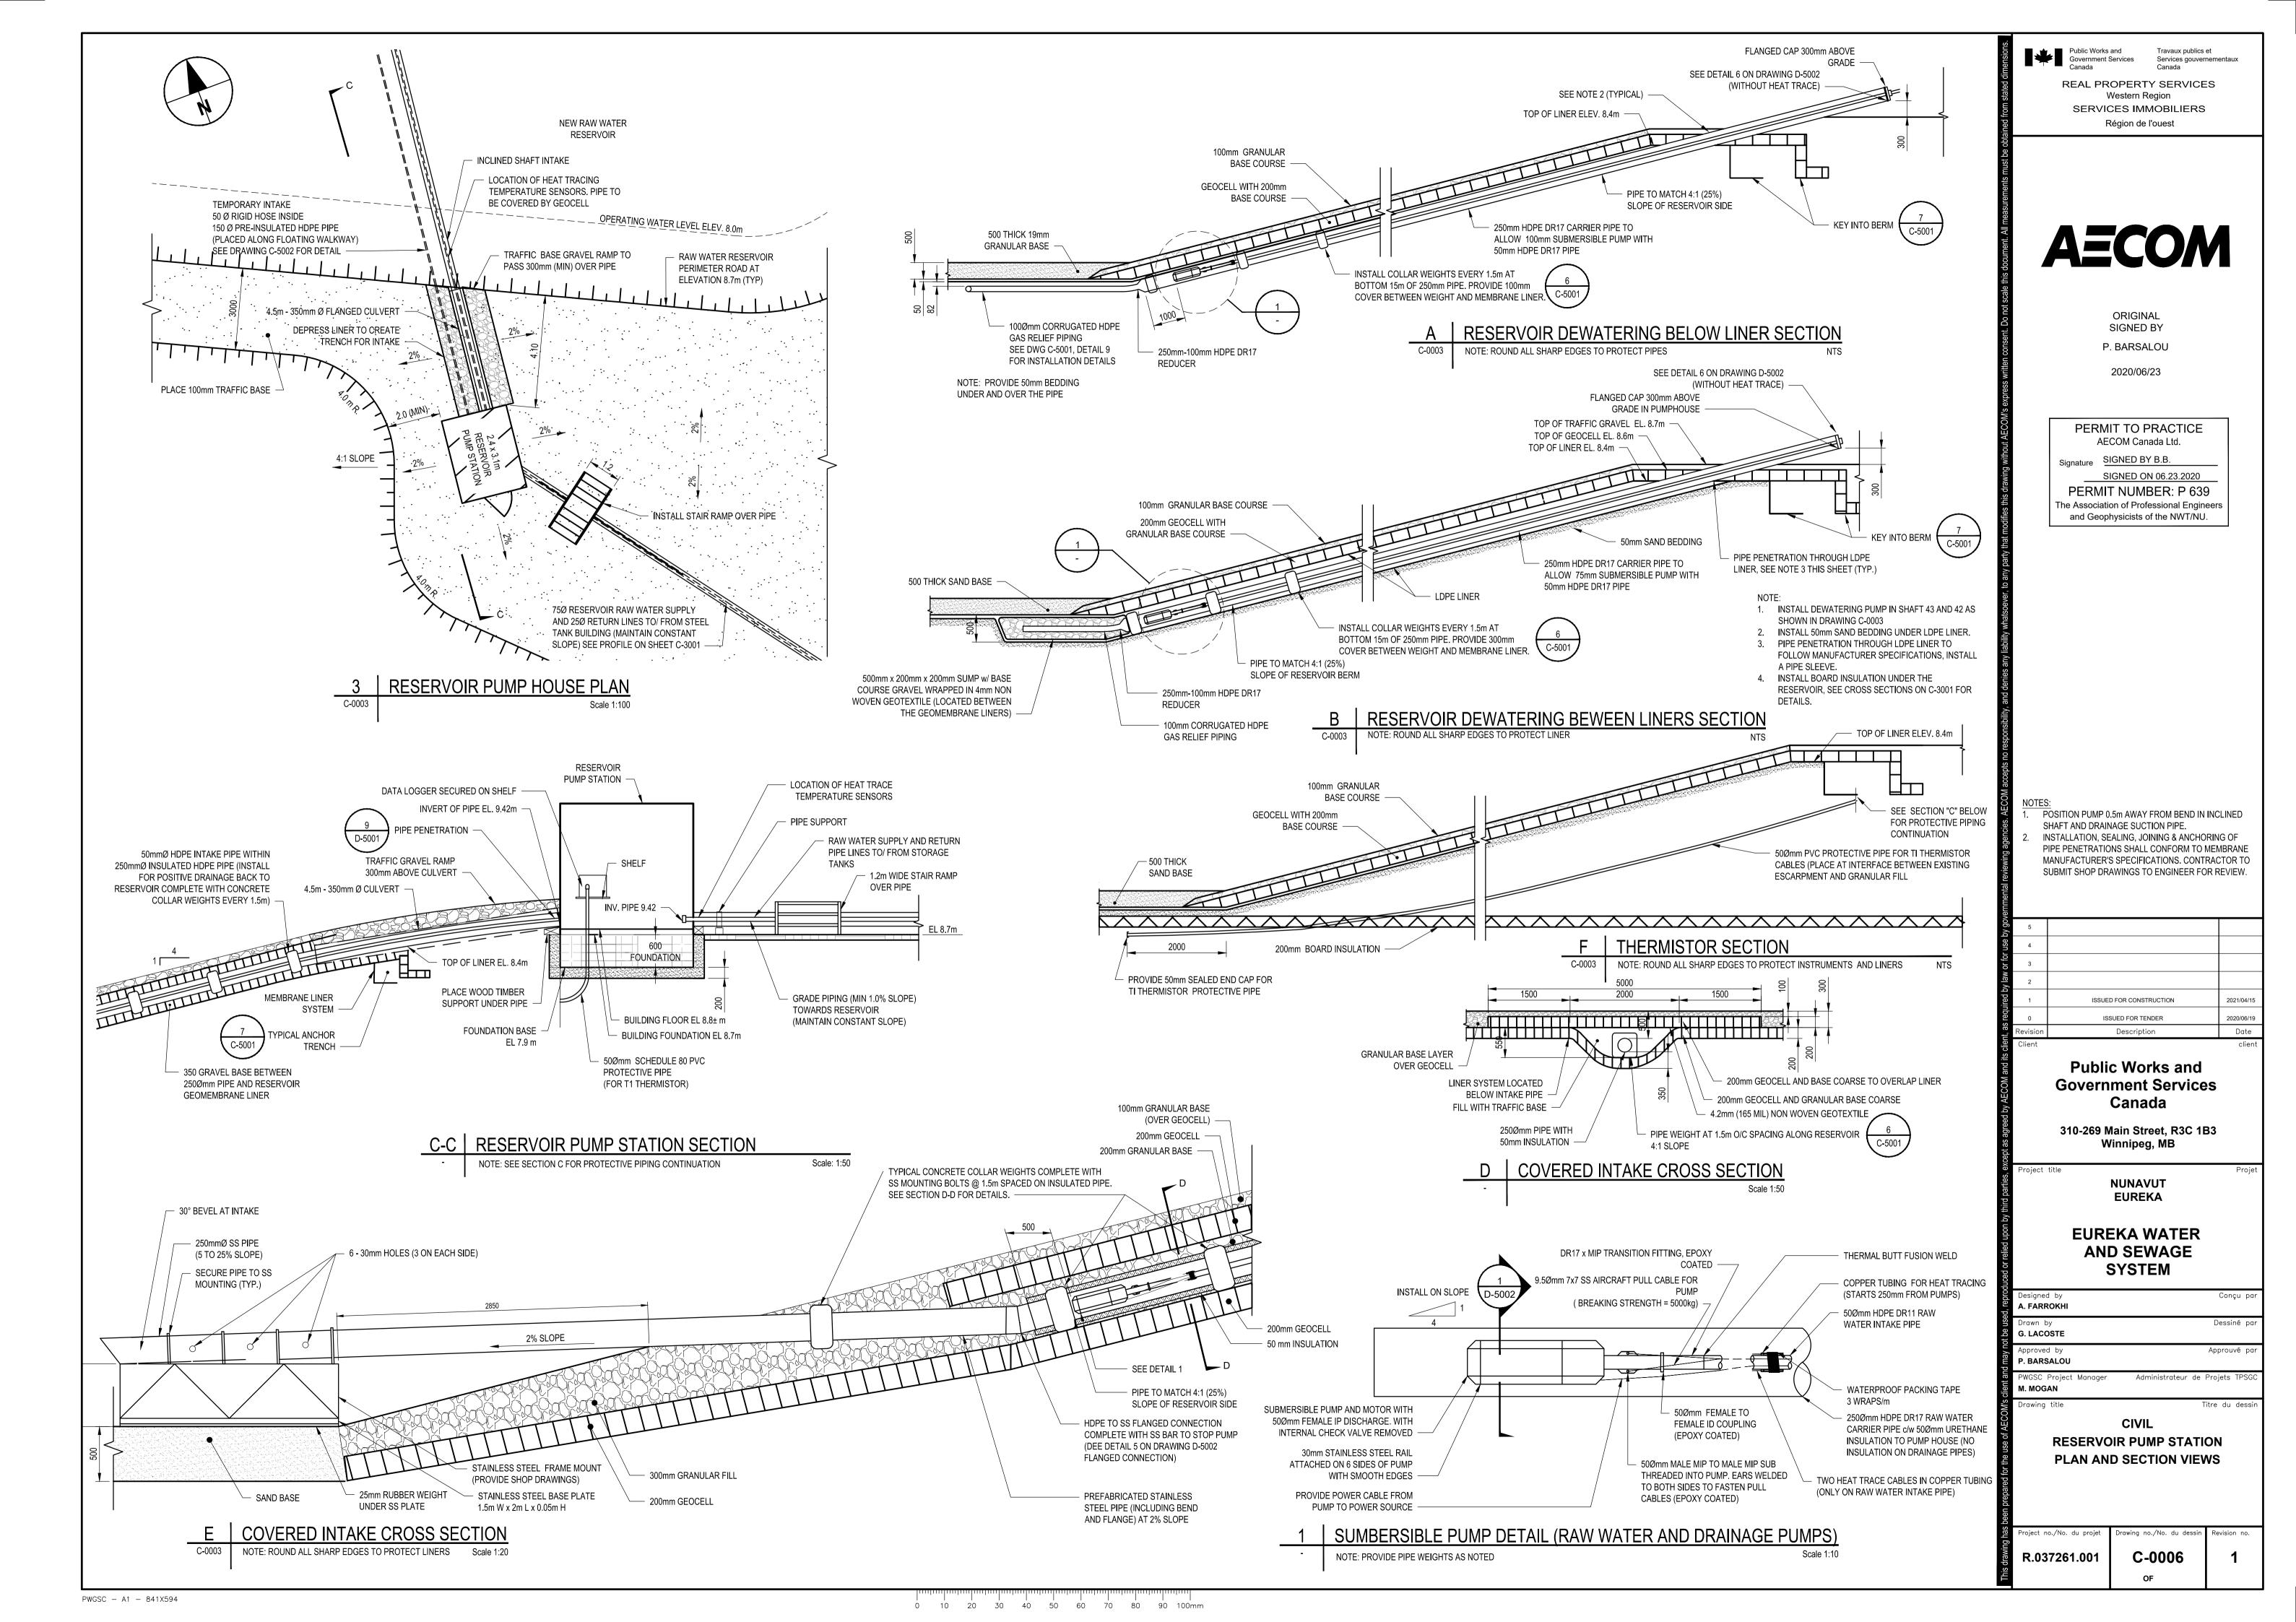

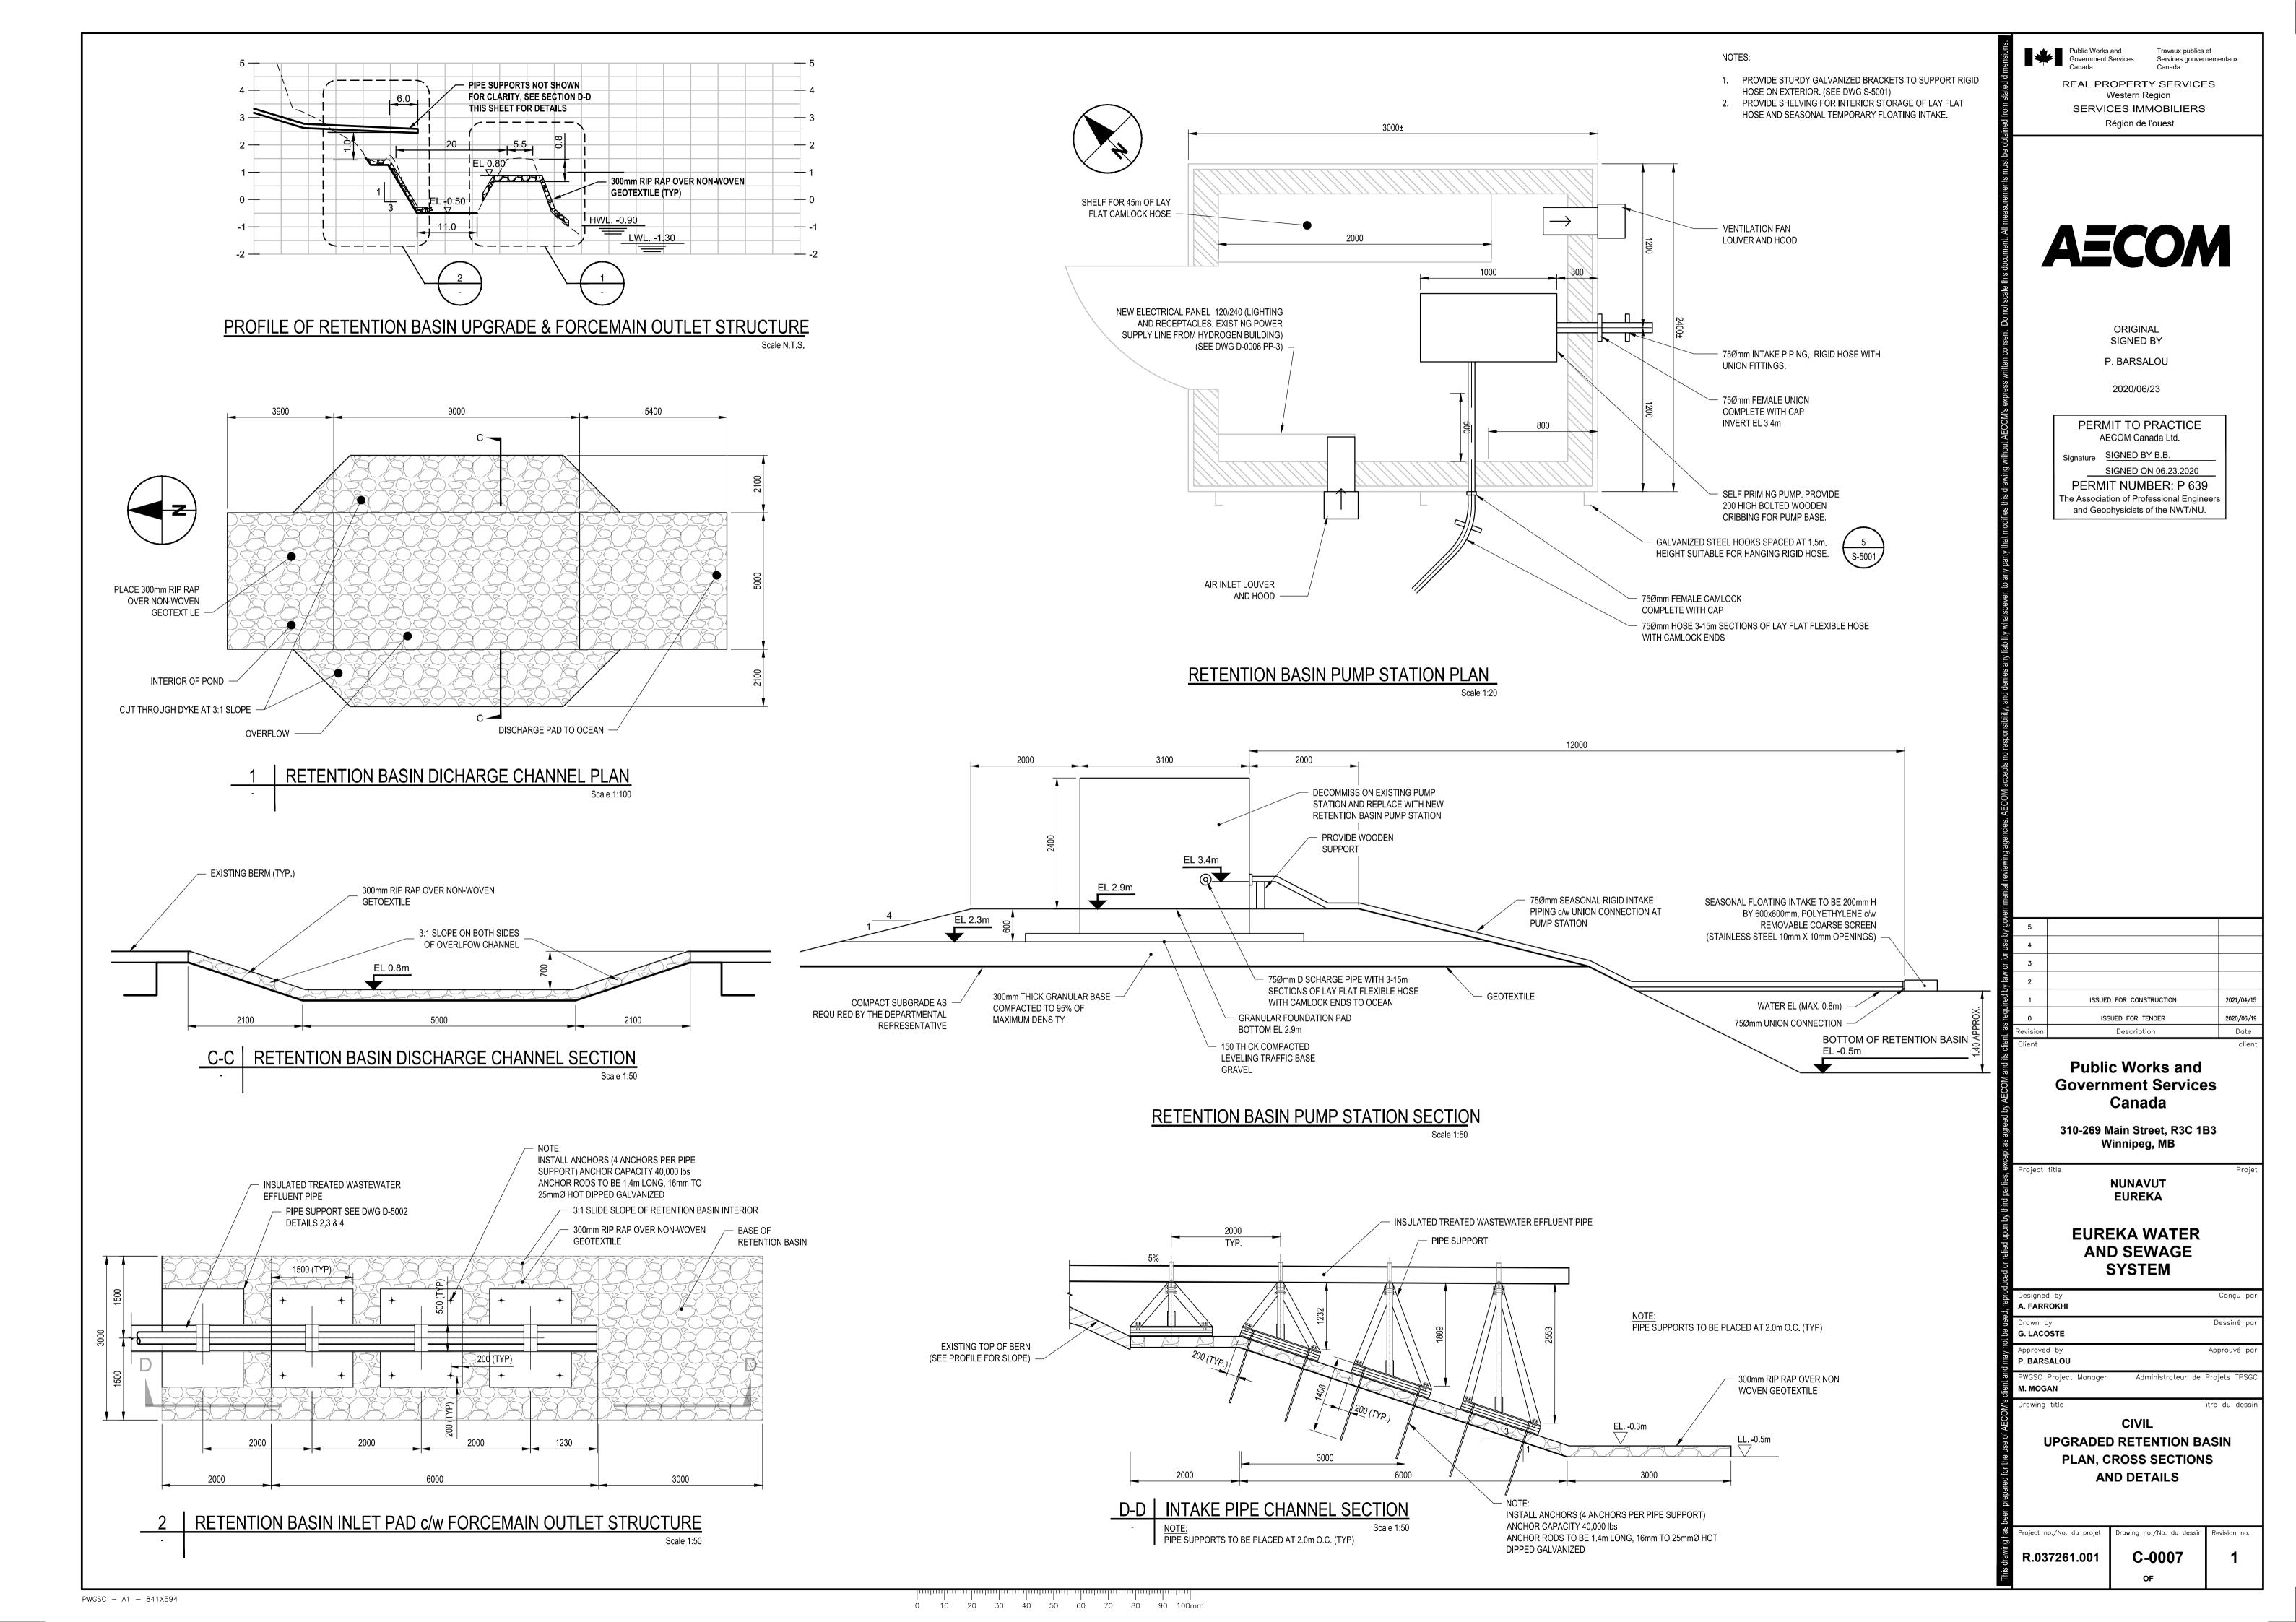

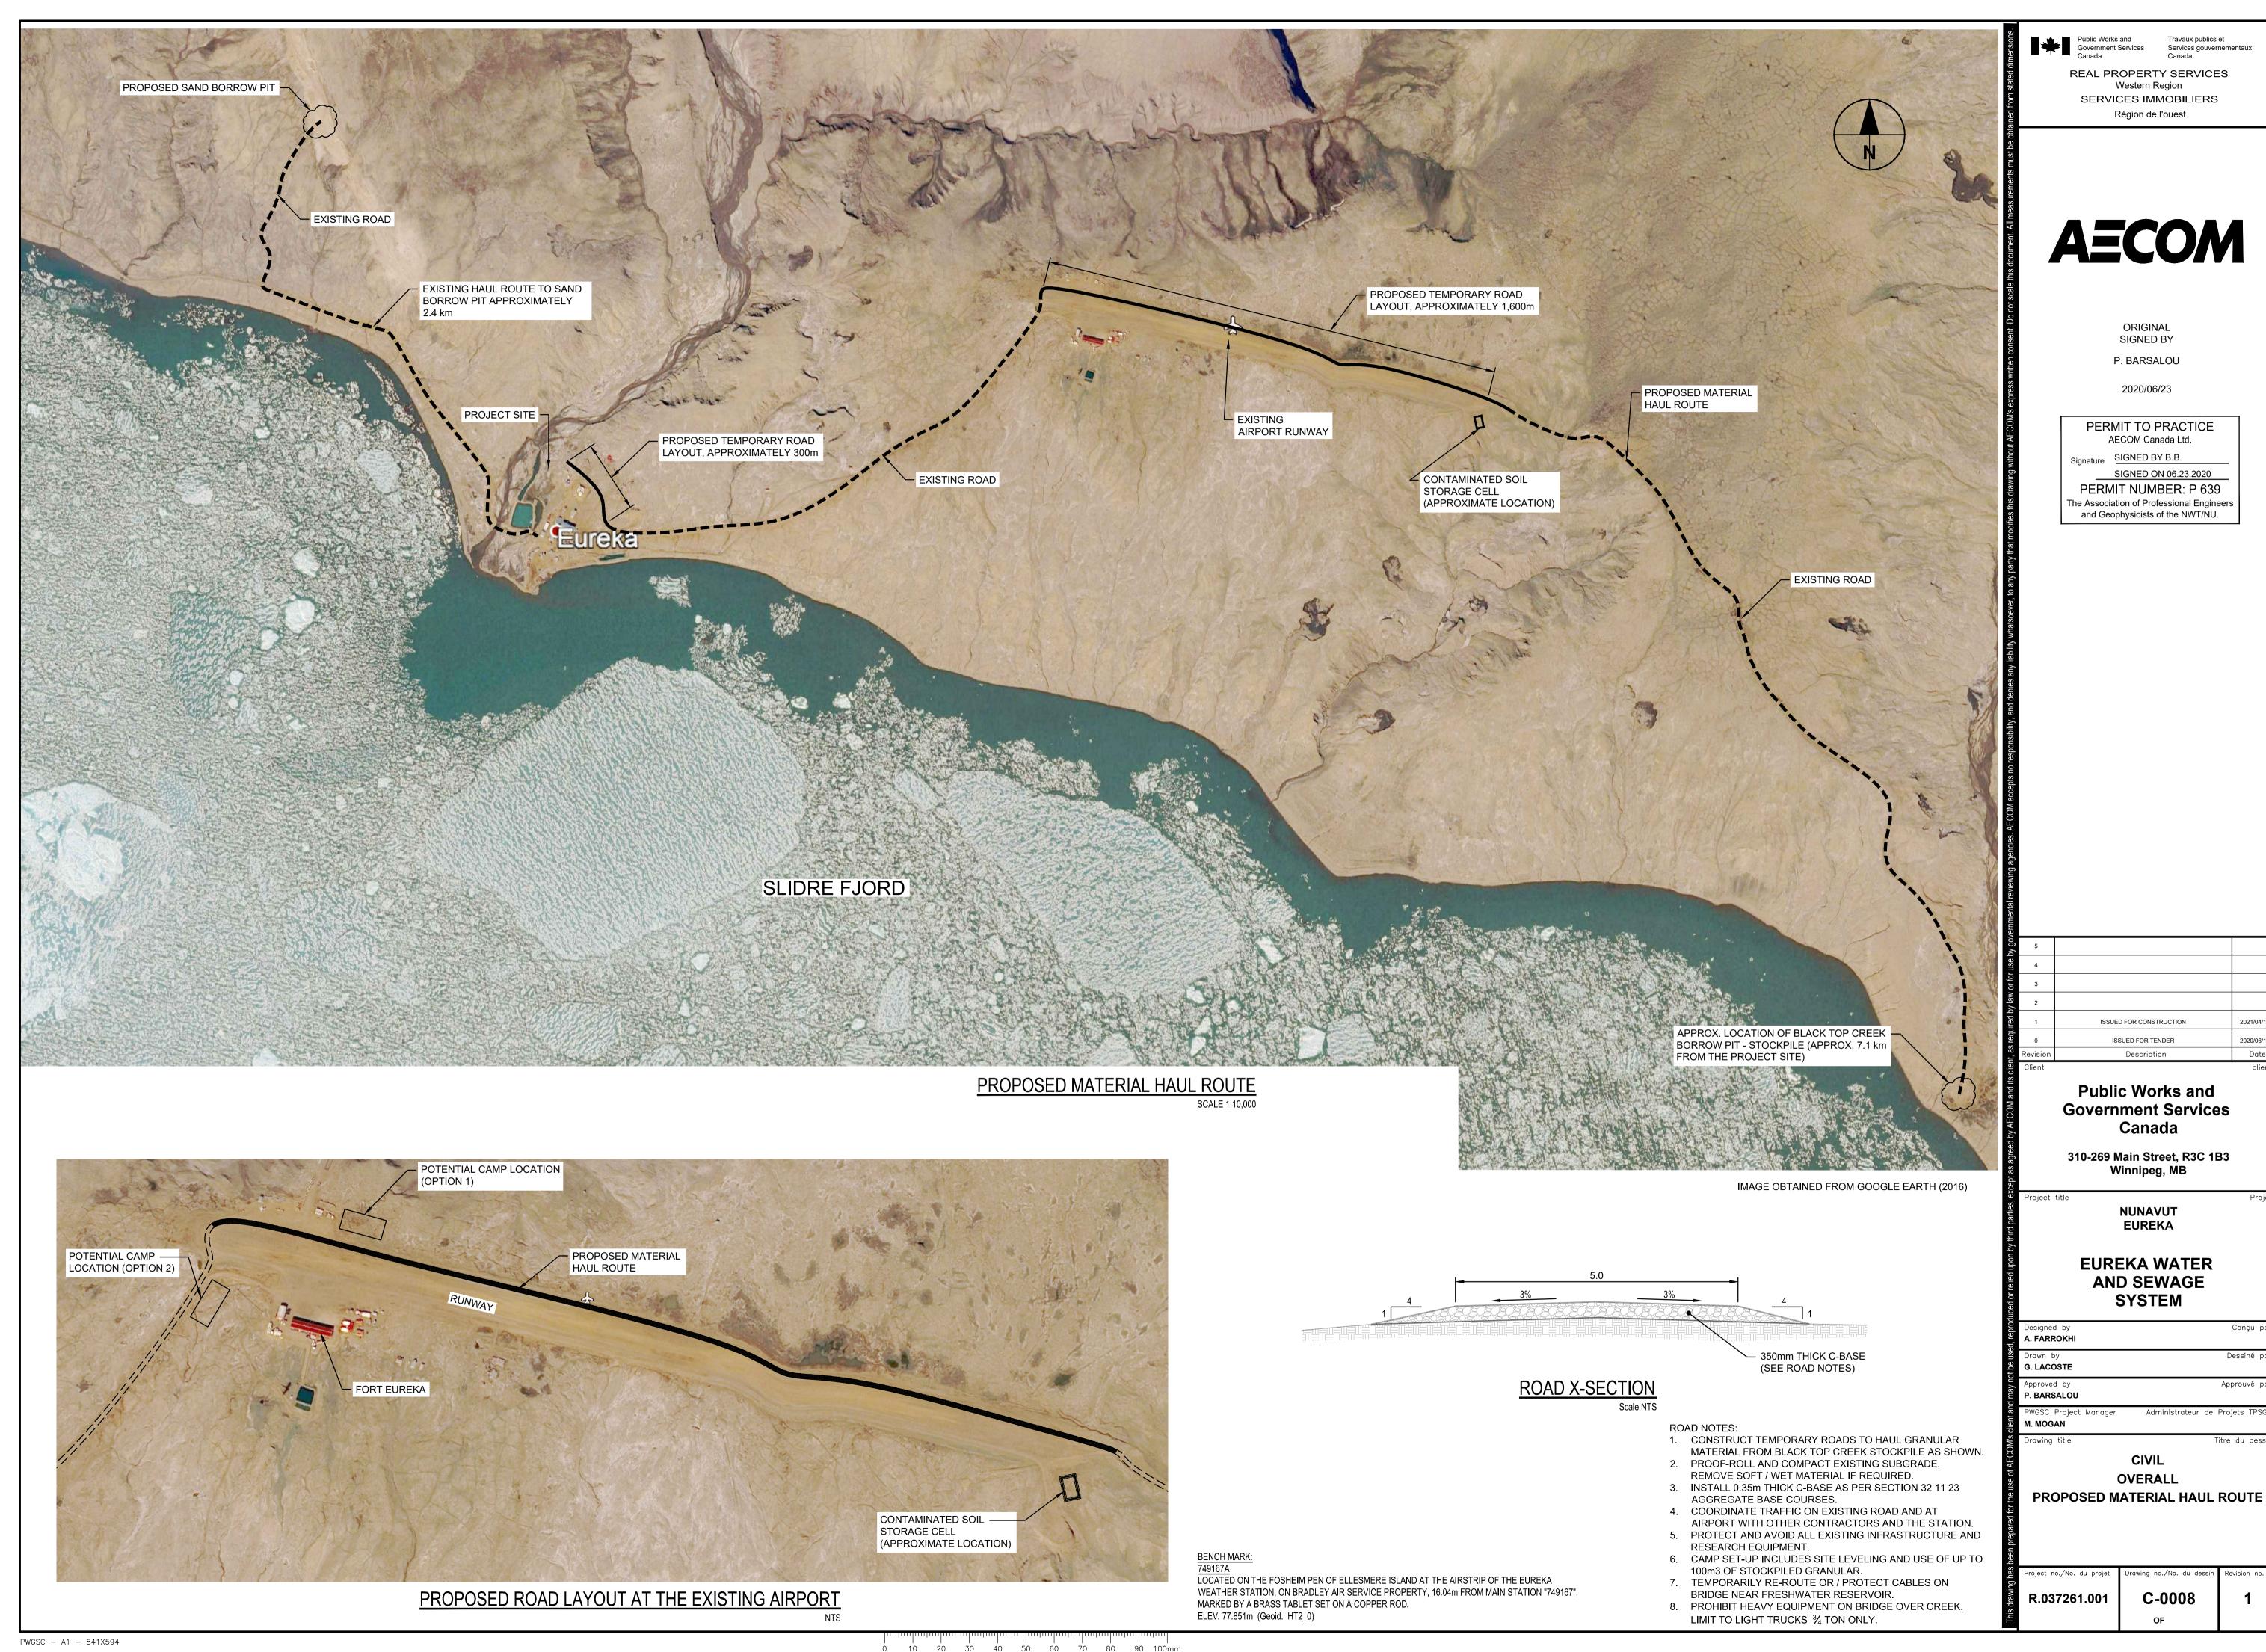

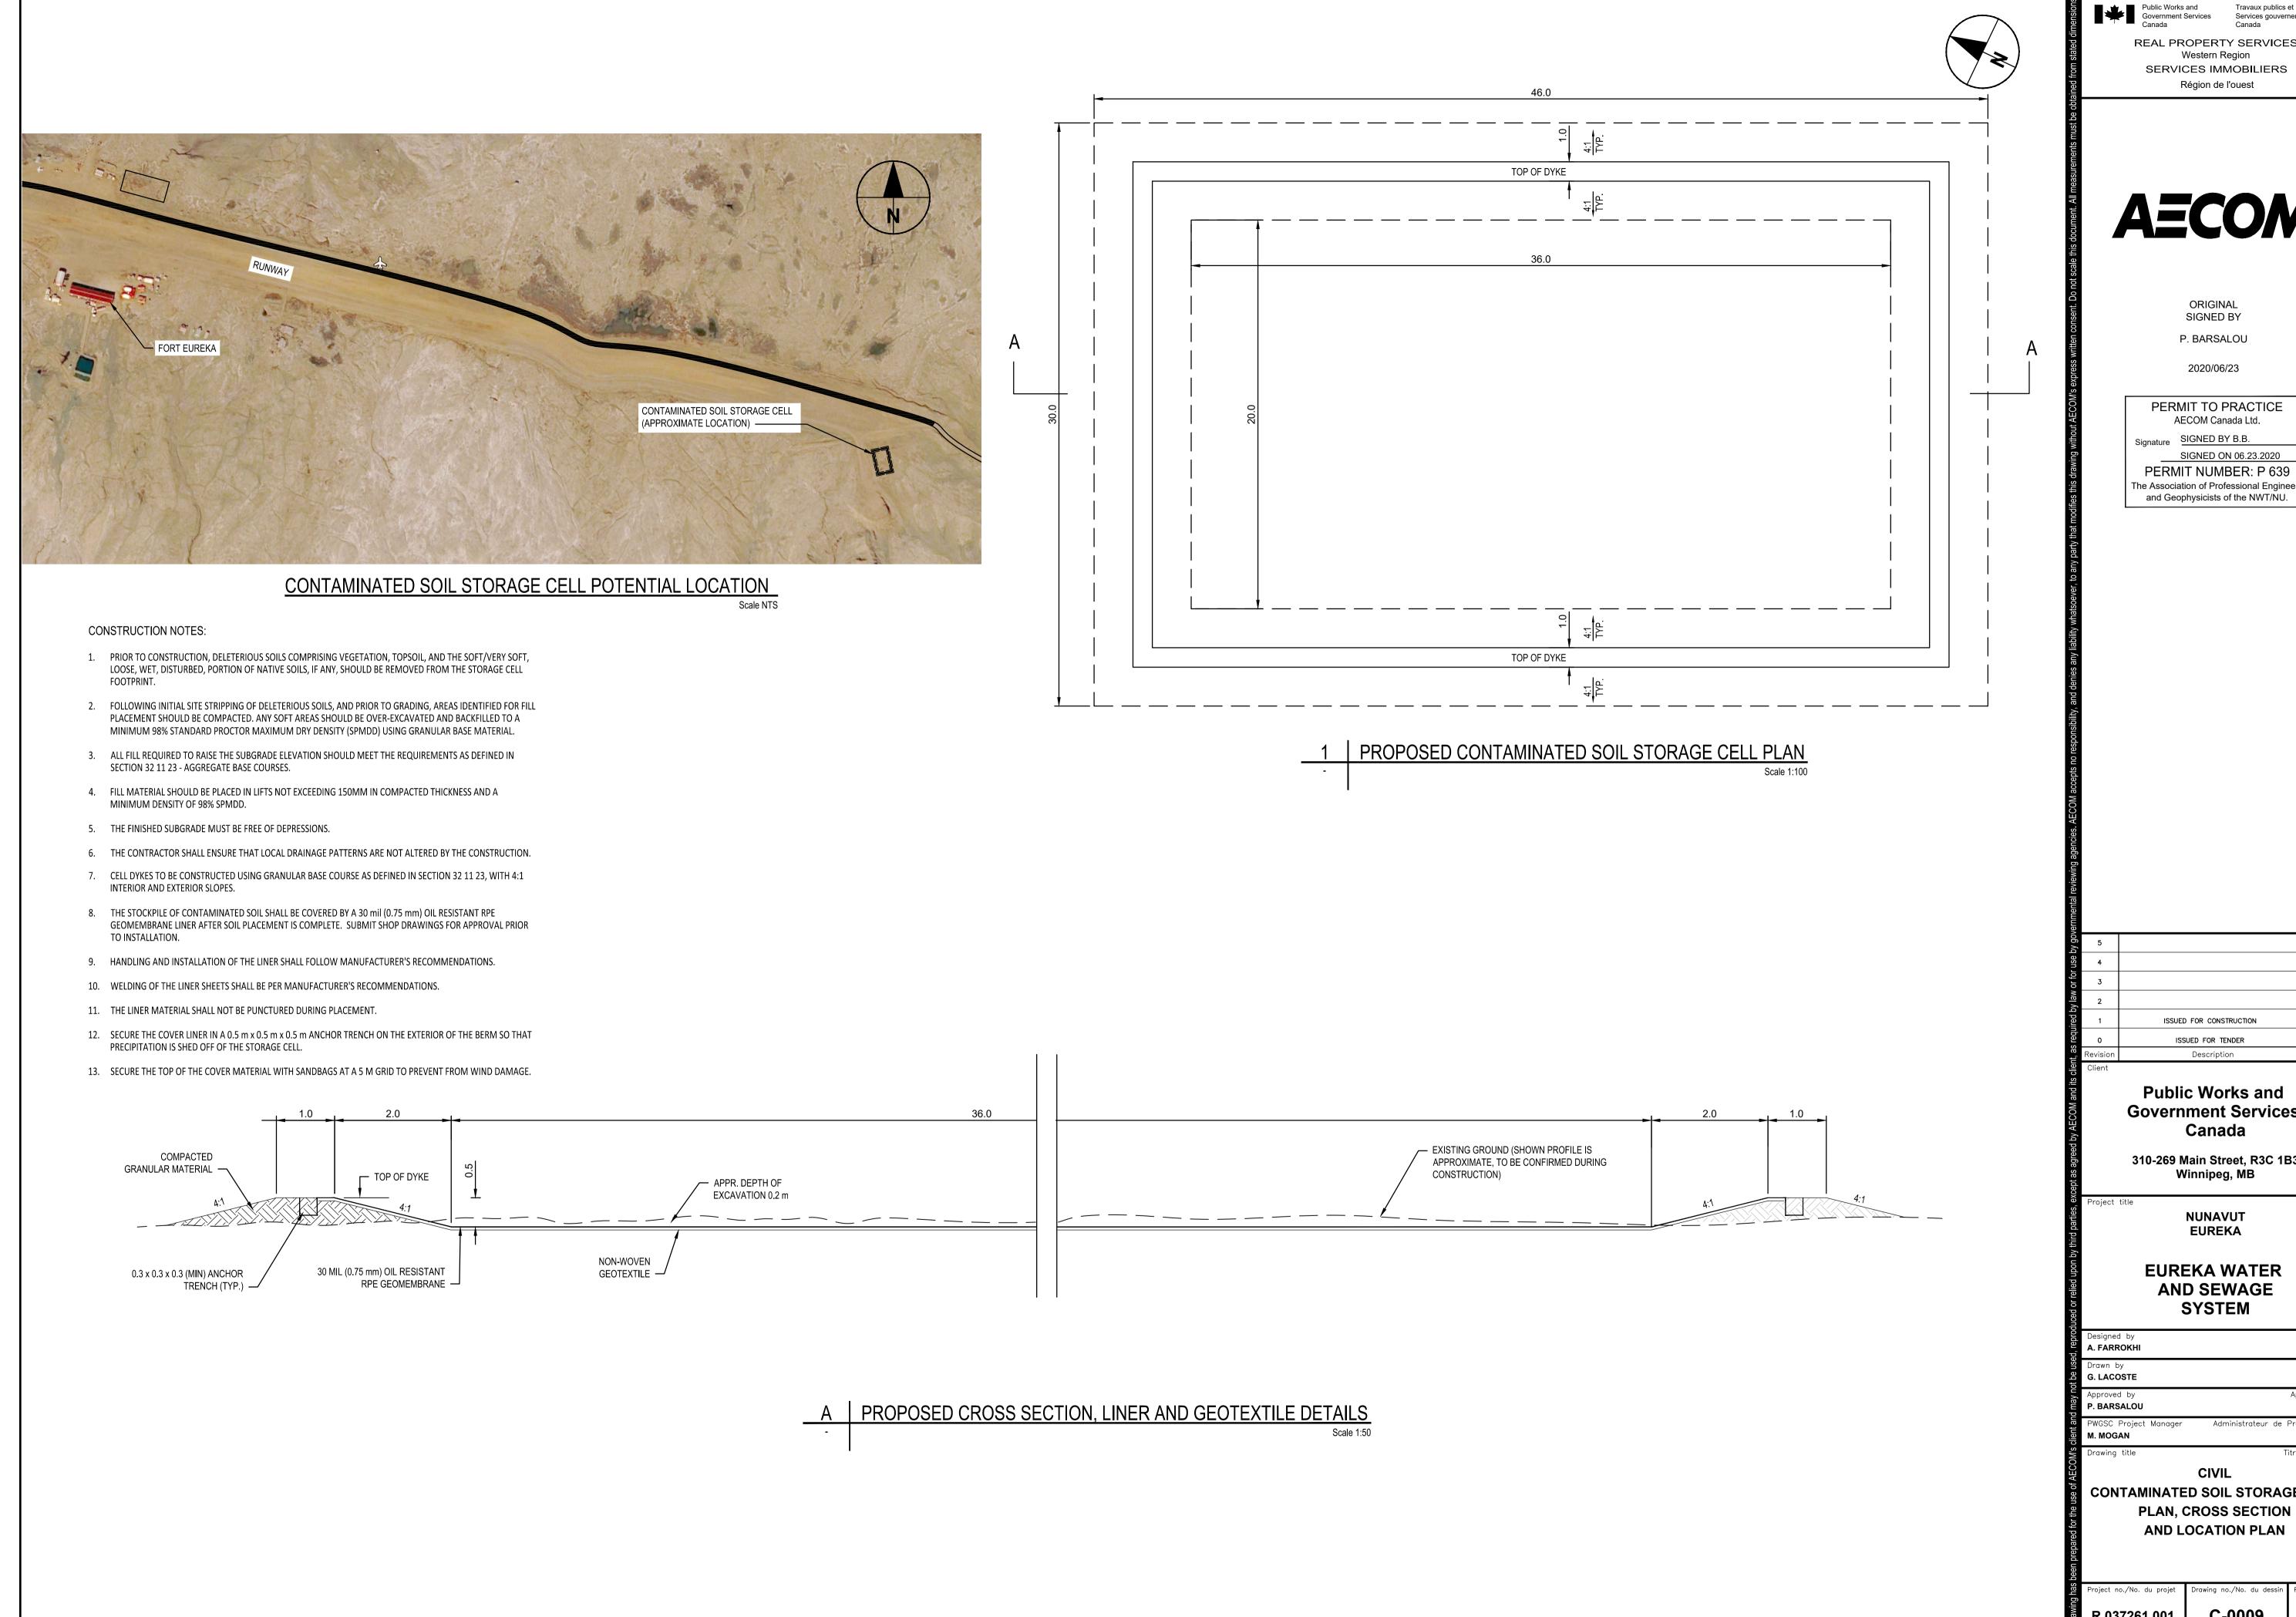

REAL PROPERTY SERVICES SERVICES IMMOBILIERS

AECOM

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SIGNED ON 06.23.2020 PERMIT NUMBER: P 639 The Association of Professional Engineers

Public Works and Government Services


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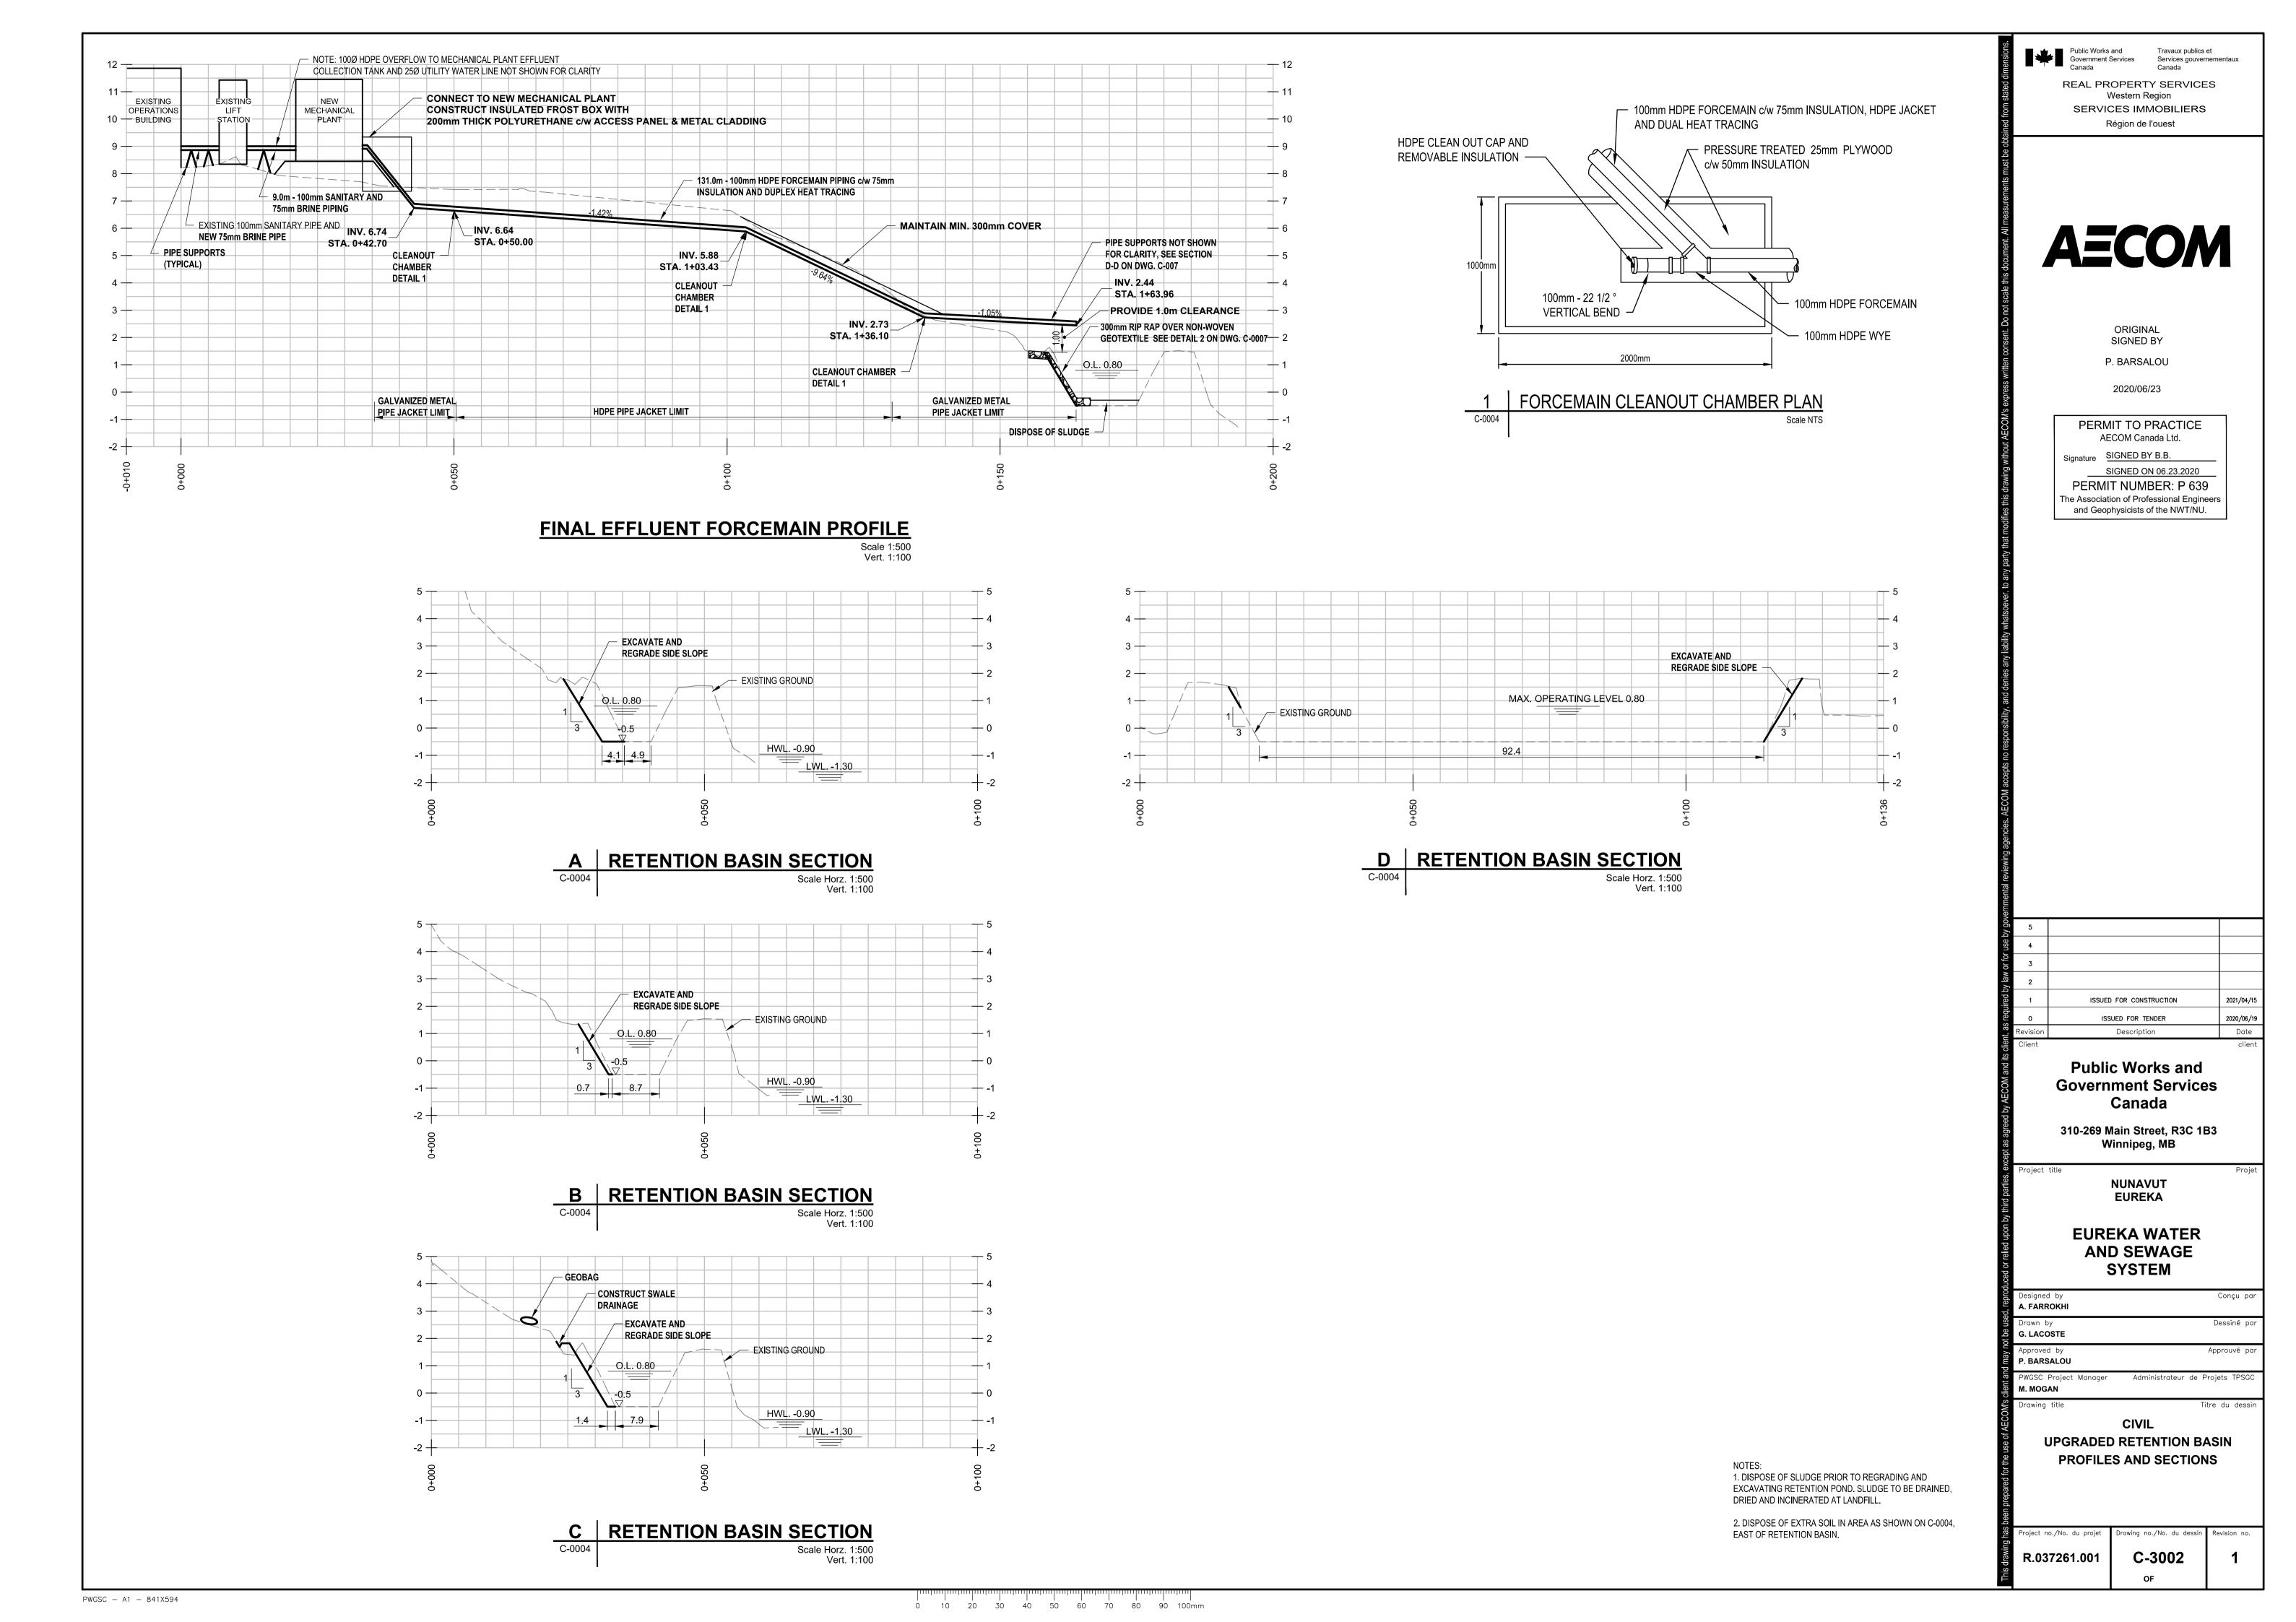
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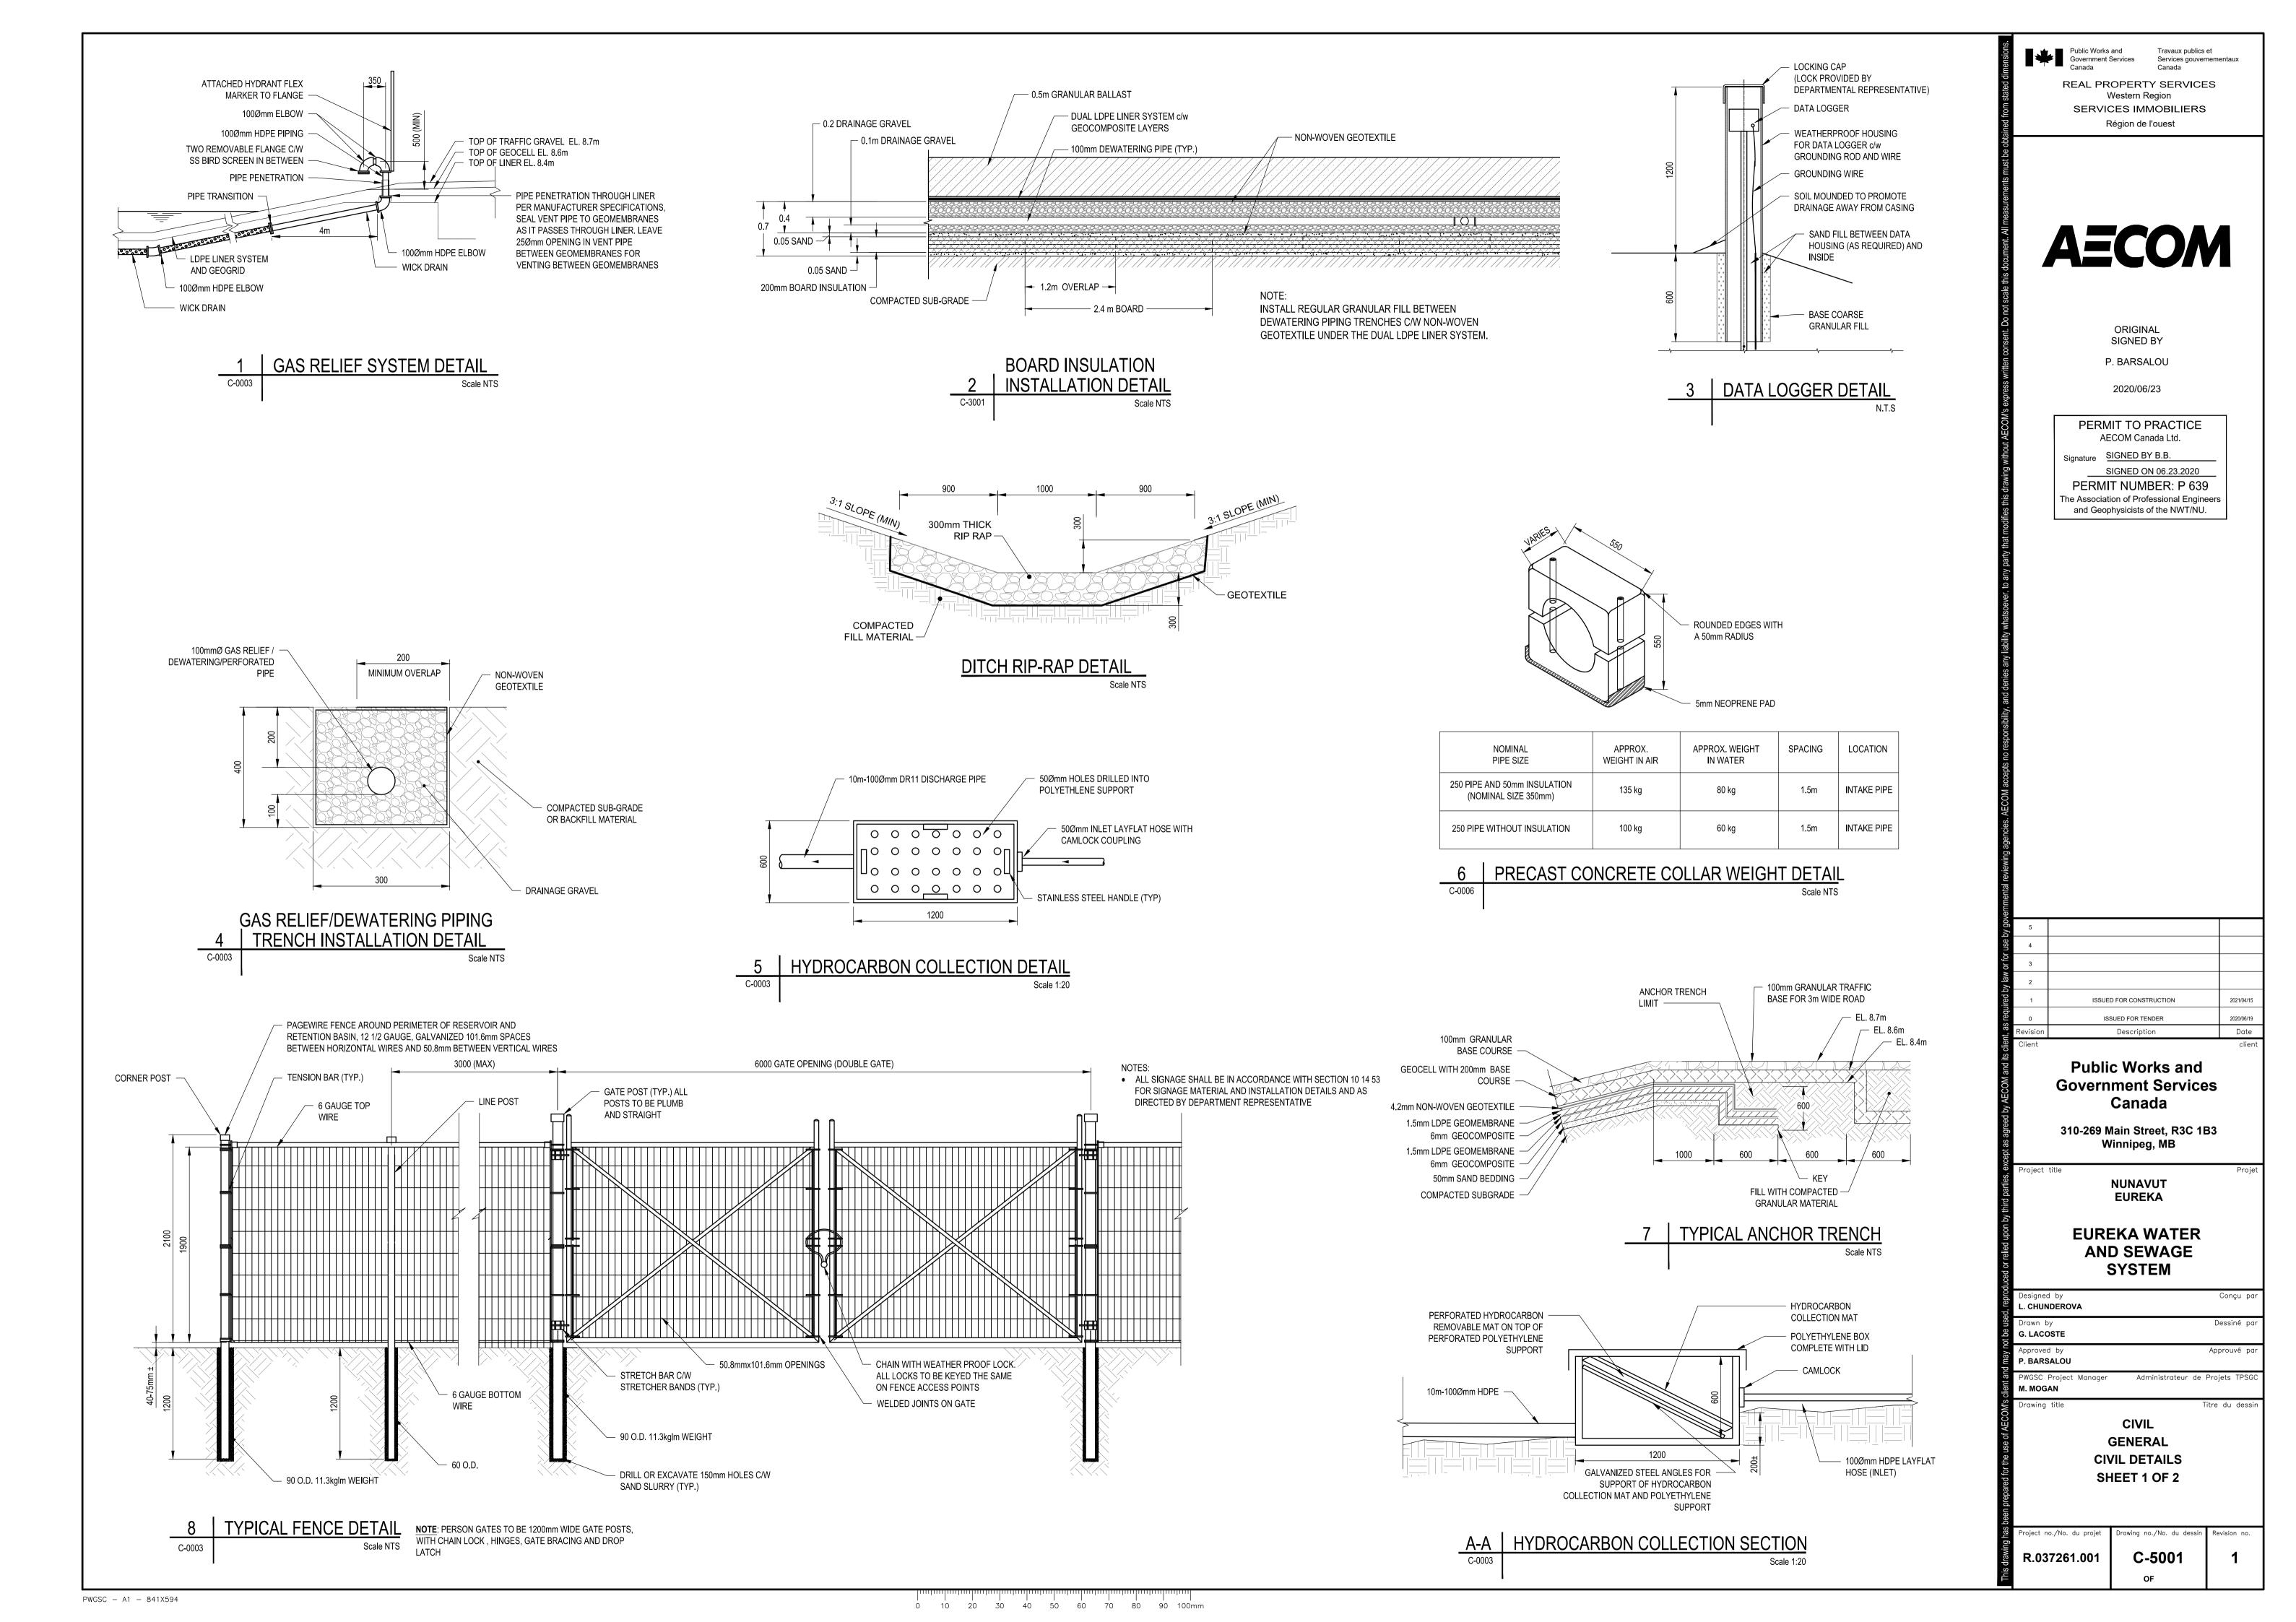
Designed by	Conçu par
A. FARROKHI	
Drawn by	Dessiné par
G. LACOSTE	
Approved by	Approuvé par
P. BARSALOU	
PWGSC Project Manager	Administrateur de Projets TPSGC
M. MOGAN	
Drawing title	Titre du dessin


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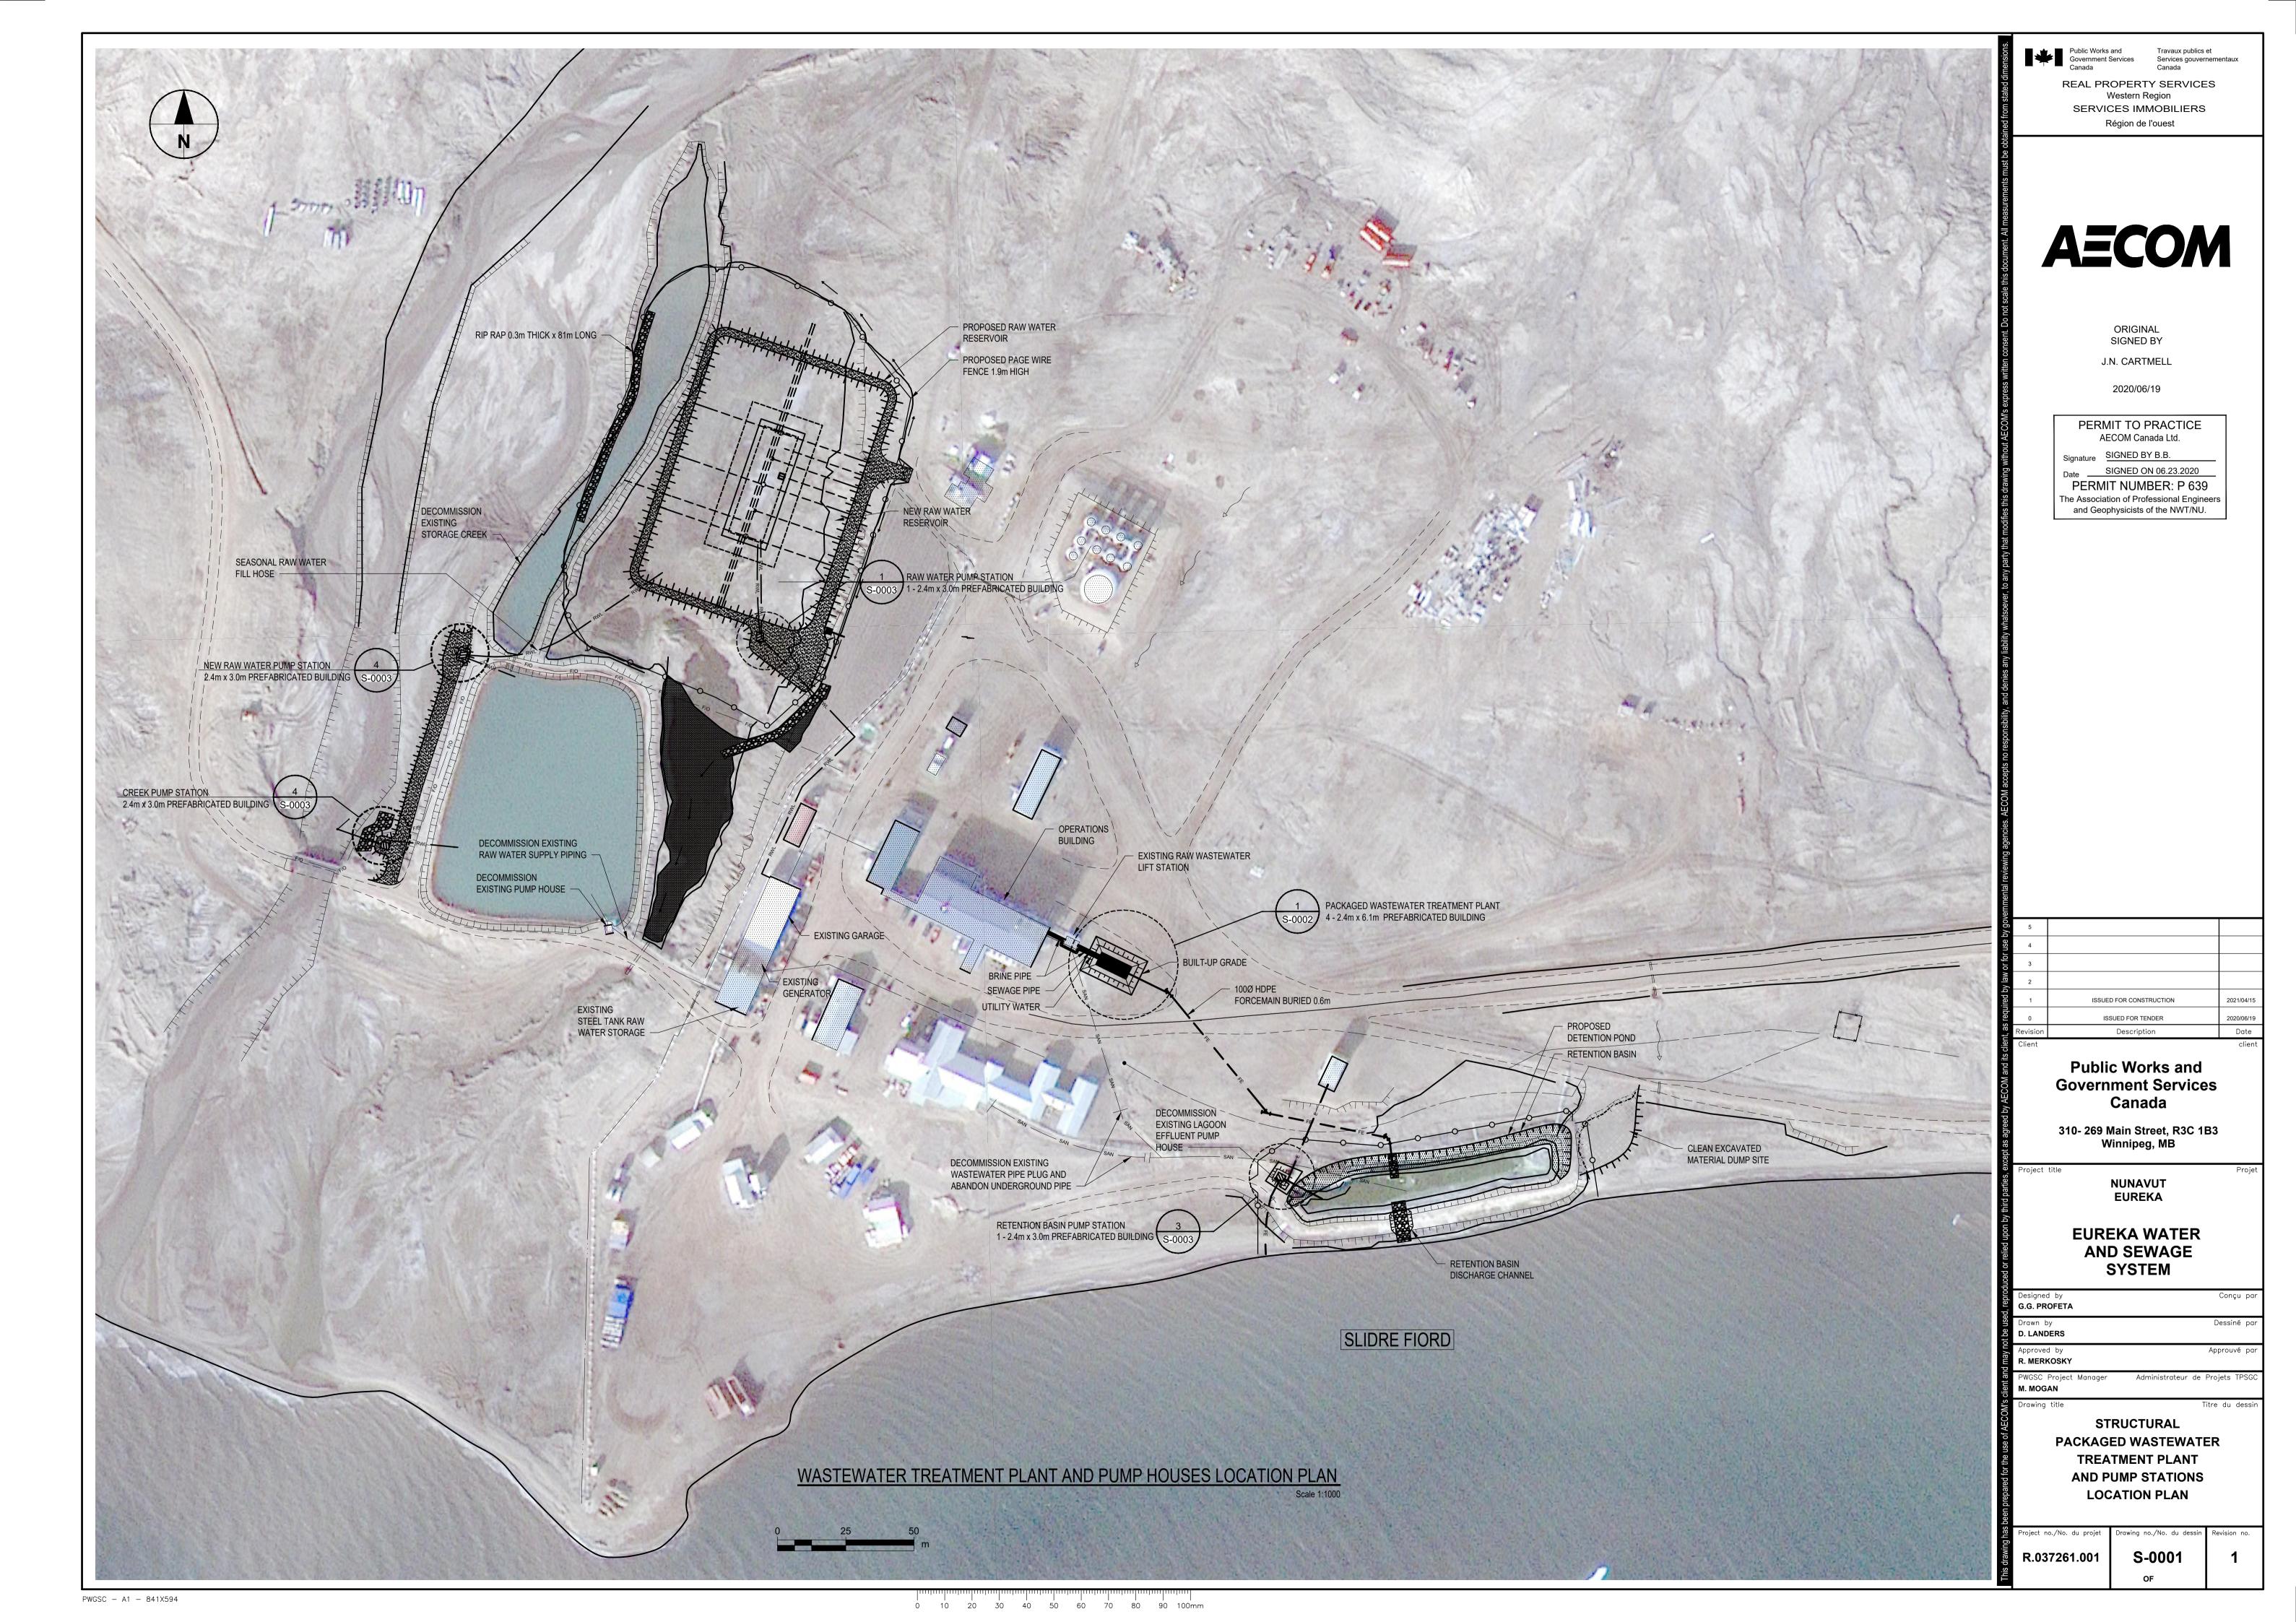
C-0009 R.037261.001









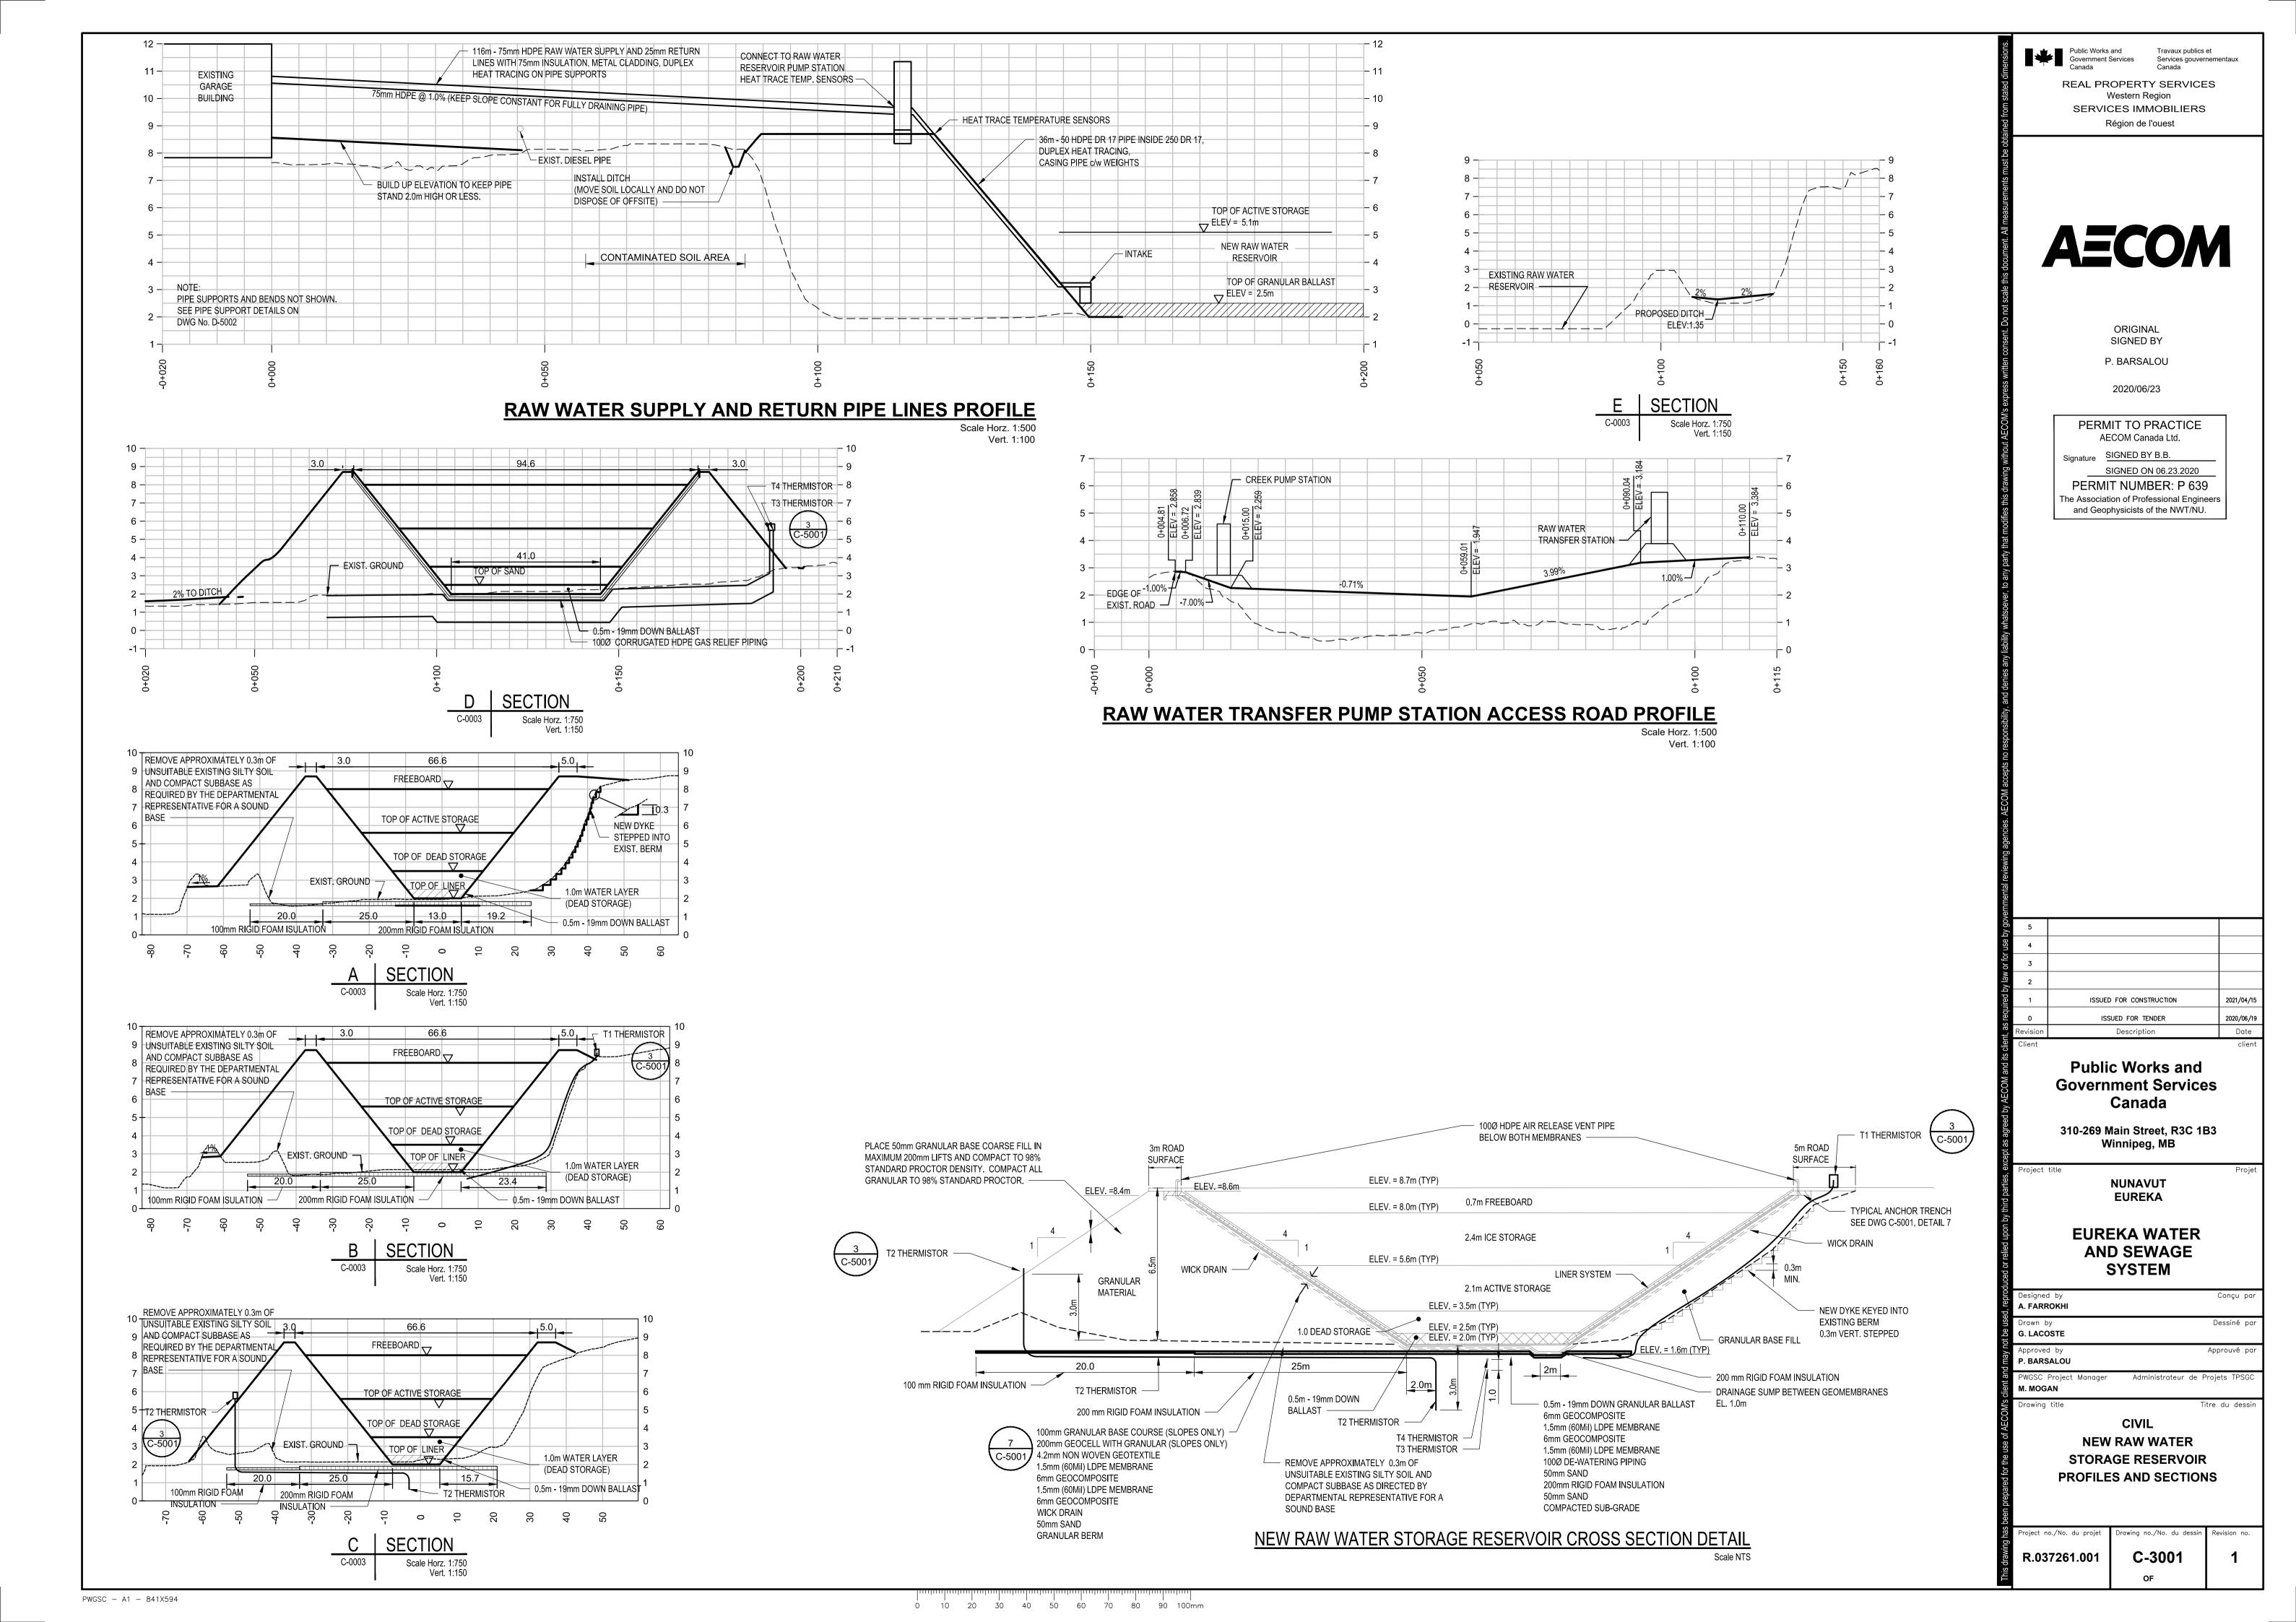

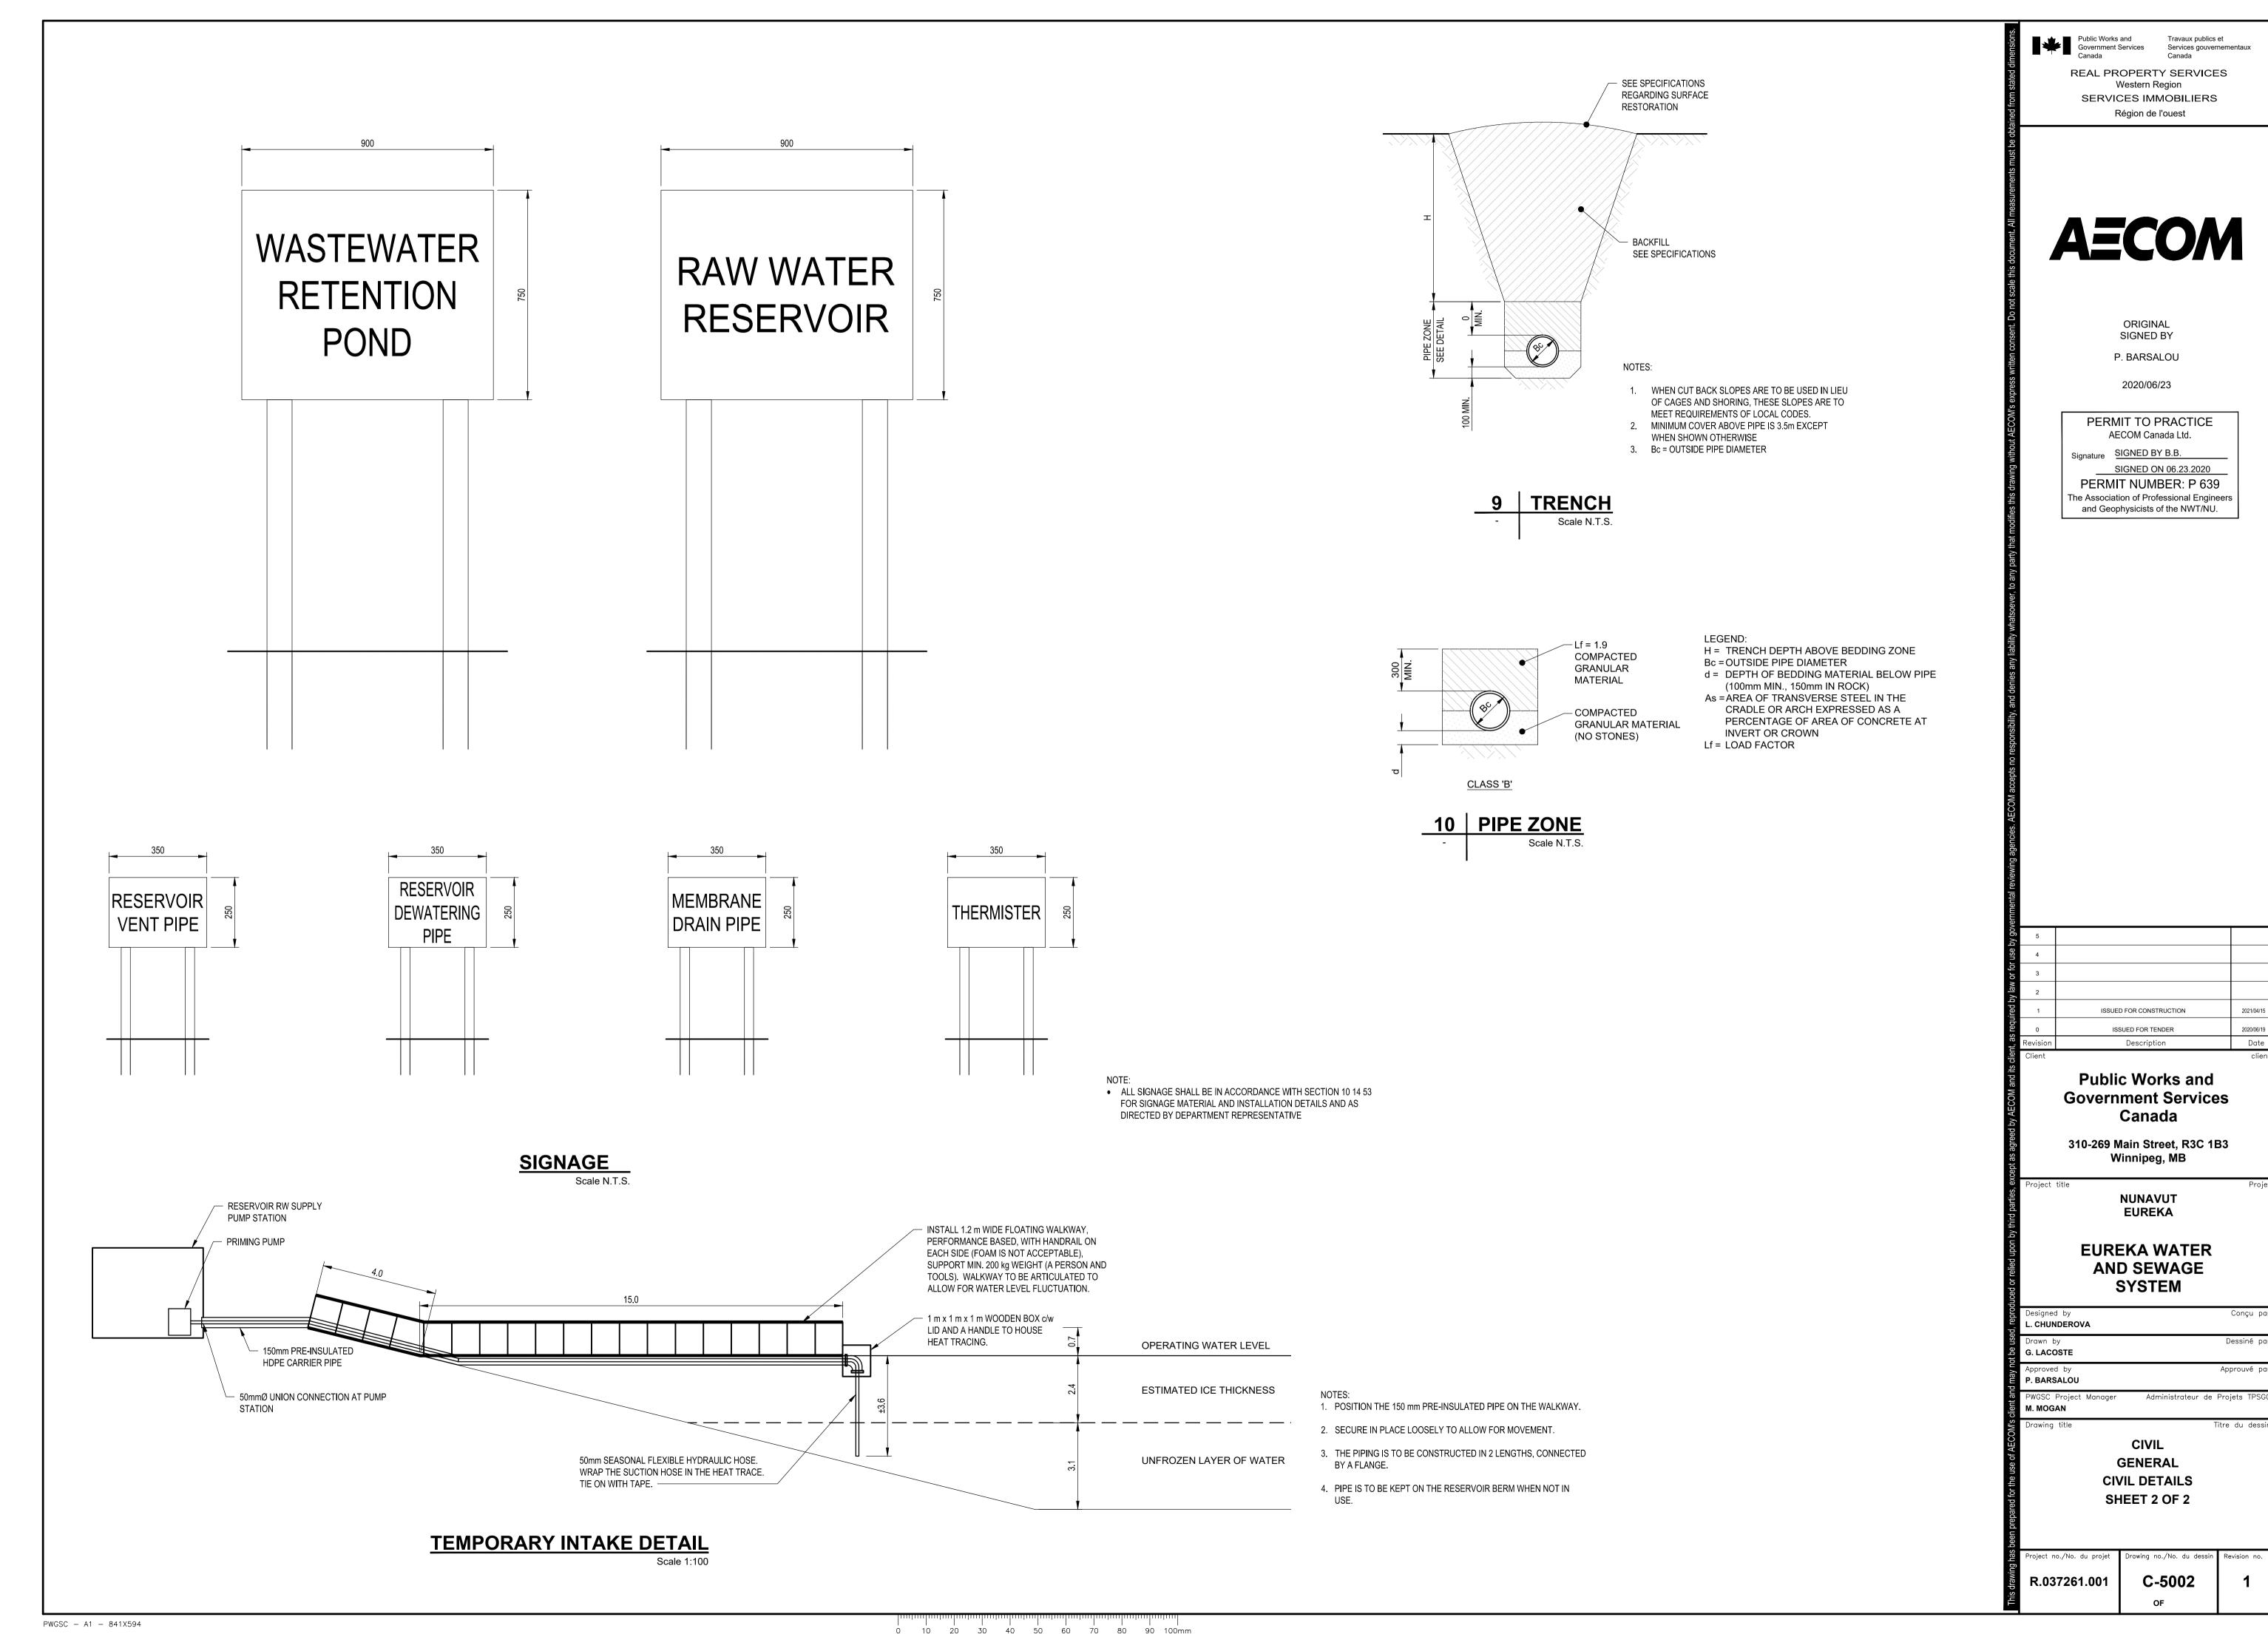

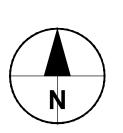

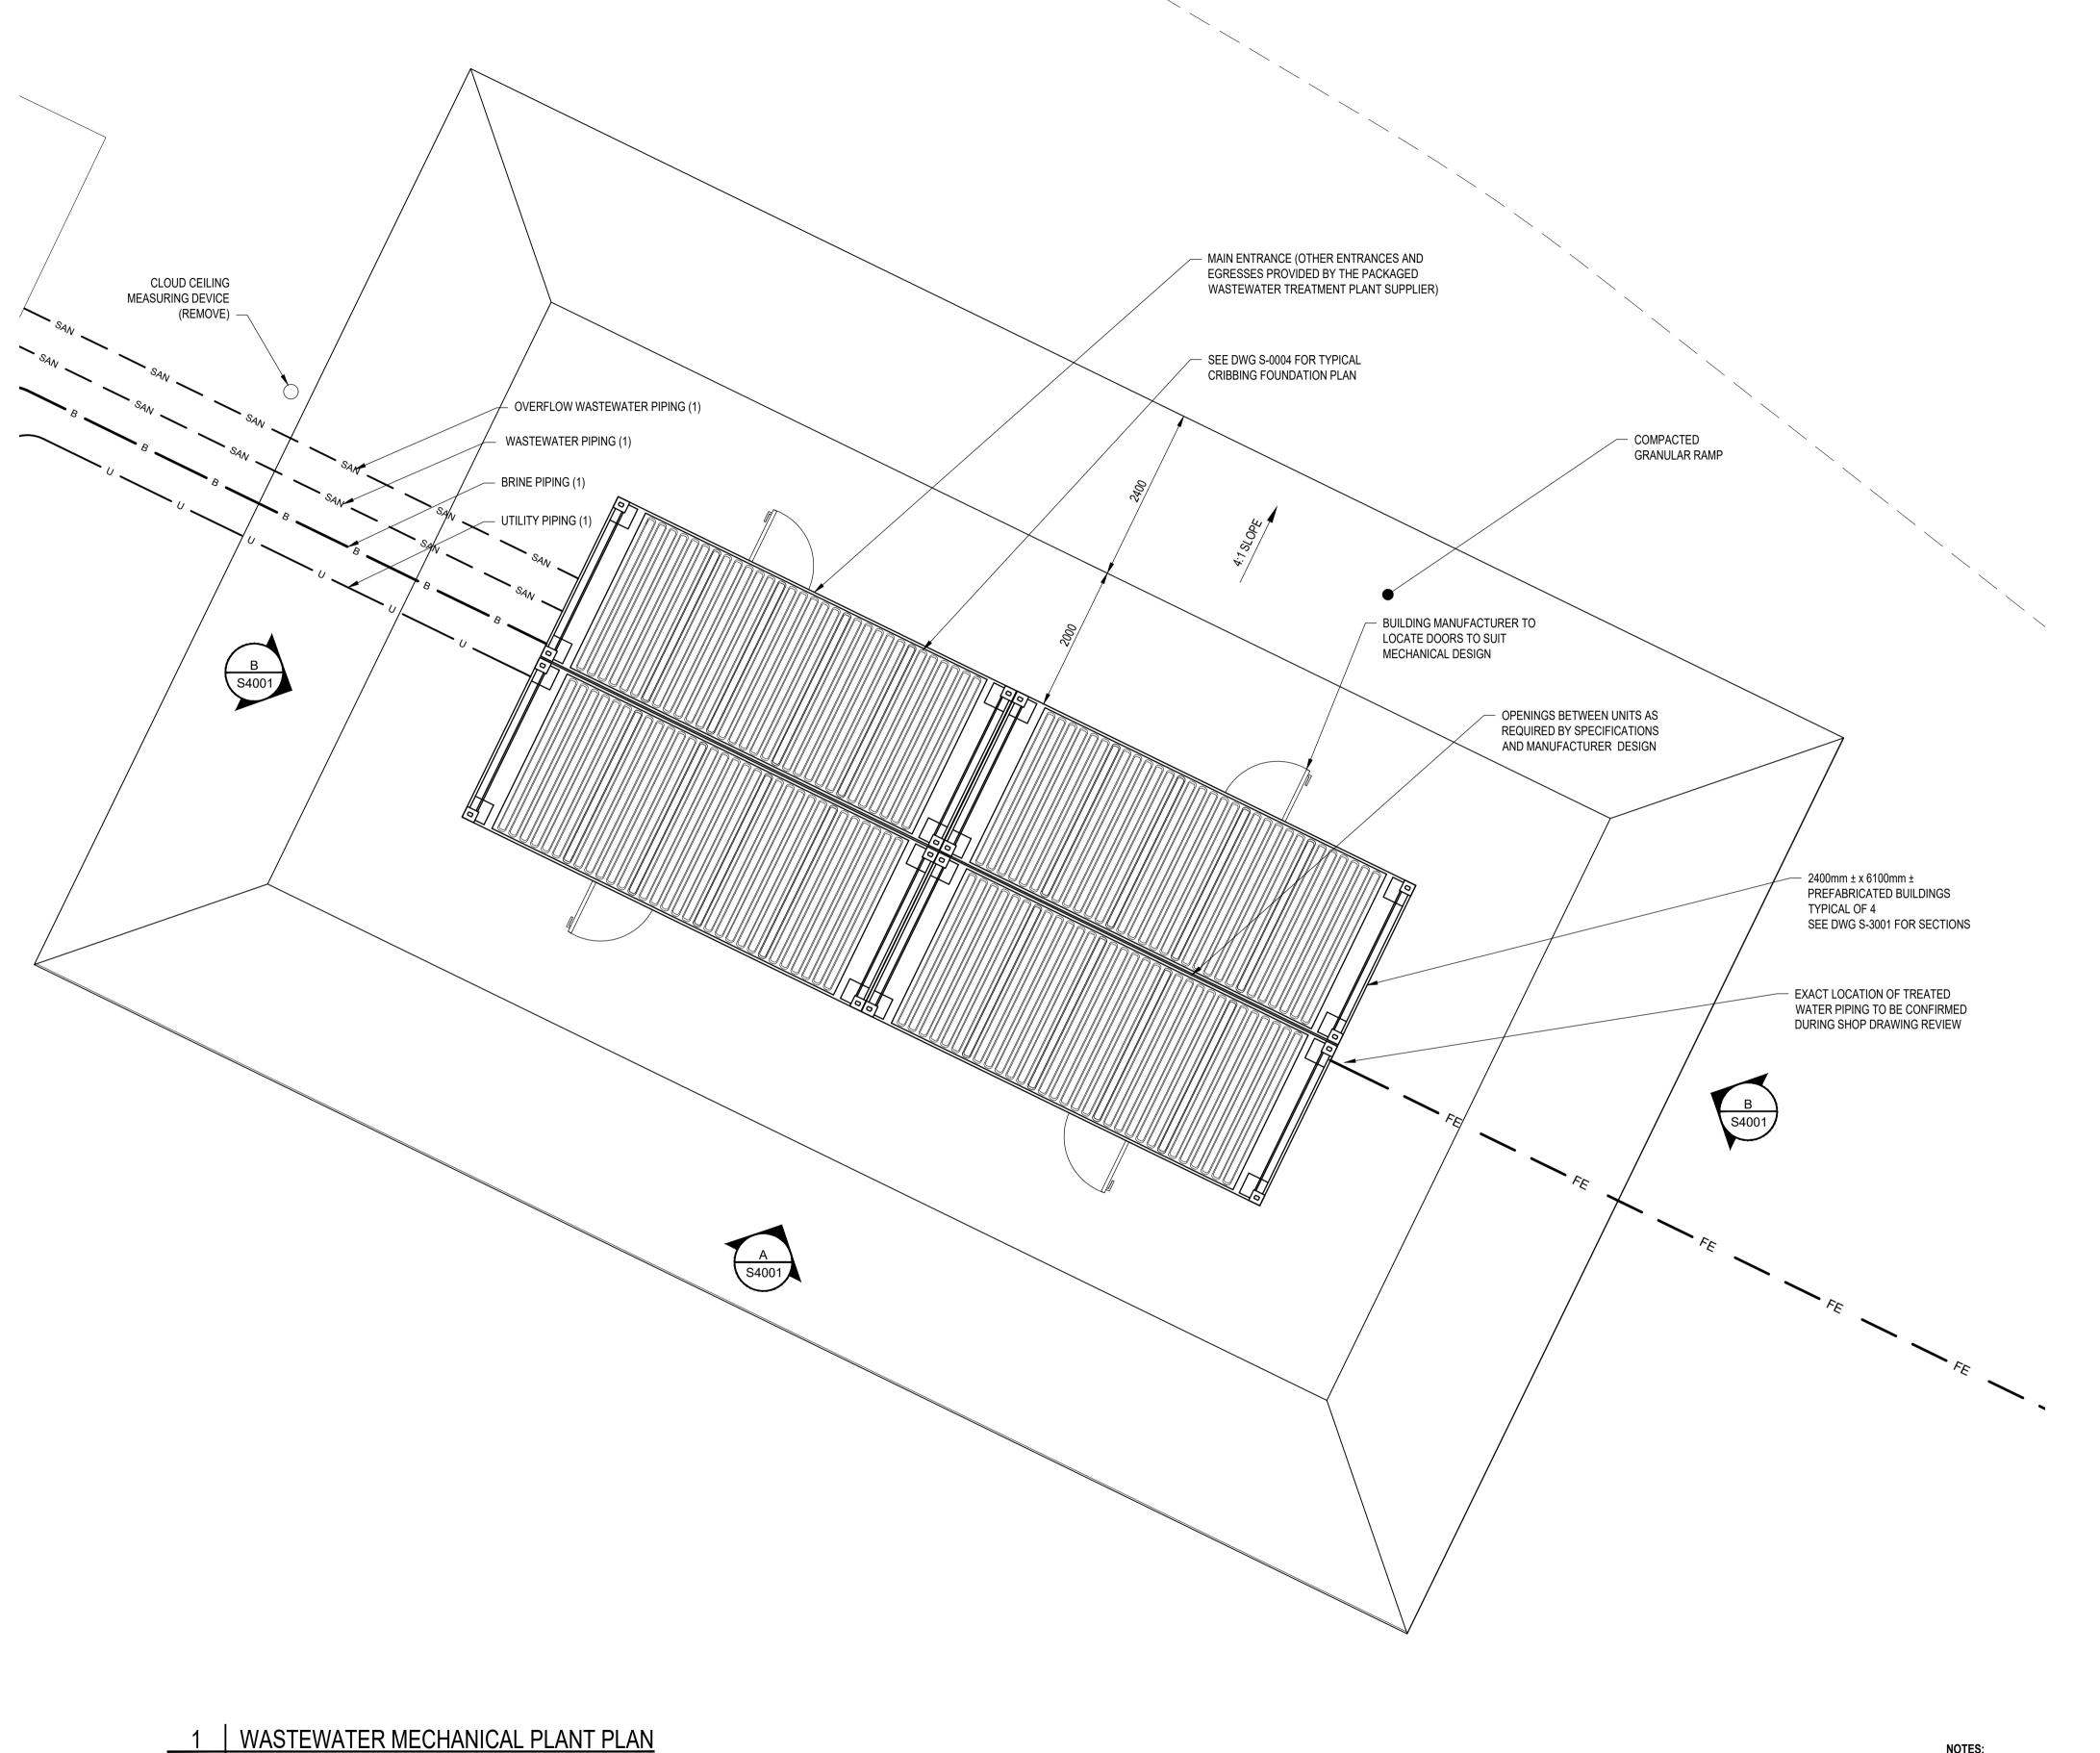

Public Works and Government Services Services gouvernementaux Canada

REAL PROPERTY SERVICES Western Region SERVICES IMMOBILIERS Région de l'ouest

AECOM

ORIGINAL SIGNED BY J.N. CARTMELL

2020/06/19

PERMIT TO PRACTICE AECOM Canada Ltd.

Signature SIGNED BY B.B.

Date SIGNED ON 06.23.2020 PERMIT NUMBER: P 639 The Association of Professional Engineers and Geophysicists of the NWT/NU.

ISSUED FOR CONSTRUCTION ISSUED FOR TENDER

Public Works and Government Services Canada

310- 269 Main Street, R3C 1B3 Winnipeg, MB

NUNAVUT EUREKA

EUREKA WATER AND SEWAGE

SYSTEM


Designed by **G.G. PROFETA** D. LANDERS R. MERKOSKY M. MOGAN


> Titre du dessi STRUCTURAL PACKAGED WASTEWATER


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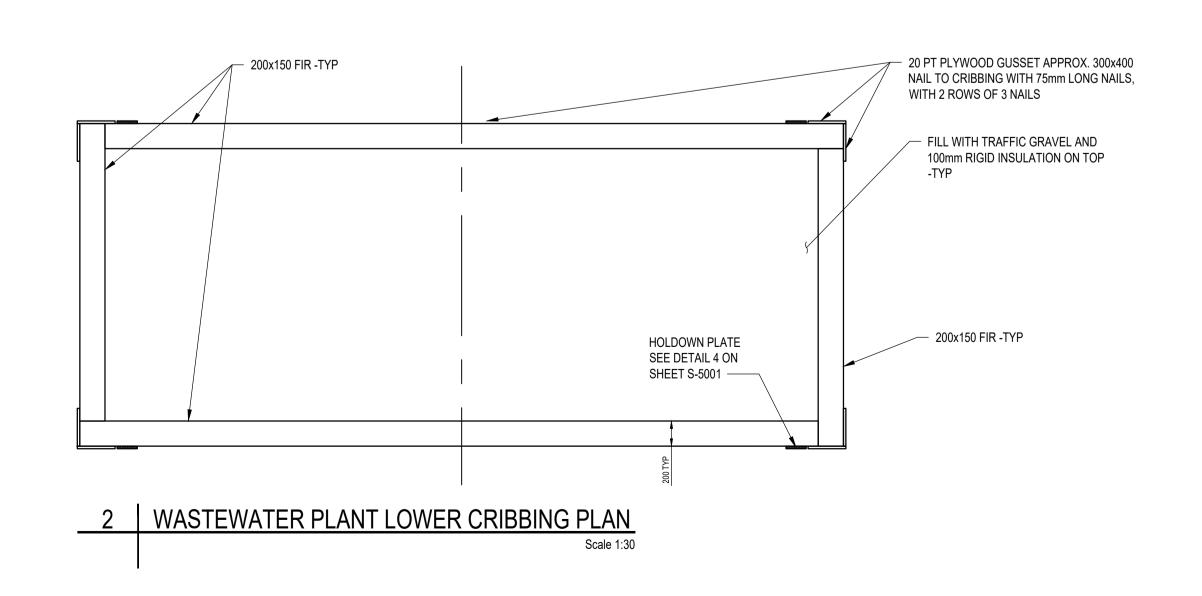
S-0002 R.037261.001


- 1. EXACT LOCATIONS OF INCOMING PIPING TO BE DETERMINED DURING SHOP DRAWING REVIEW.
- 2. 4 PREFABRICATED BUILDINGS ARE SHOWN, HOWEVER THIS MAY BE REDUCED IF THE CONTRACTOR CAN PROVIDE FEWER LARGER CONTAINERS OR IF LESS SPACE IS REQUIRED.
- BUILDINGS TO BE LEVELED AND FASTENED TOGETHER.




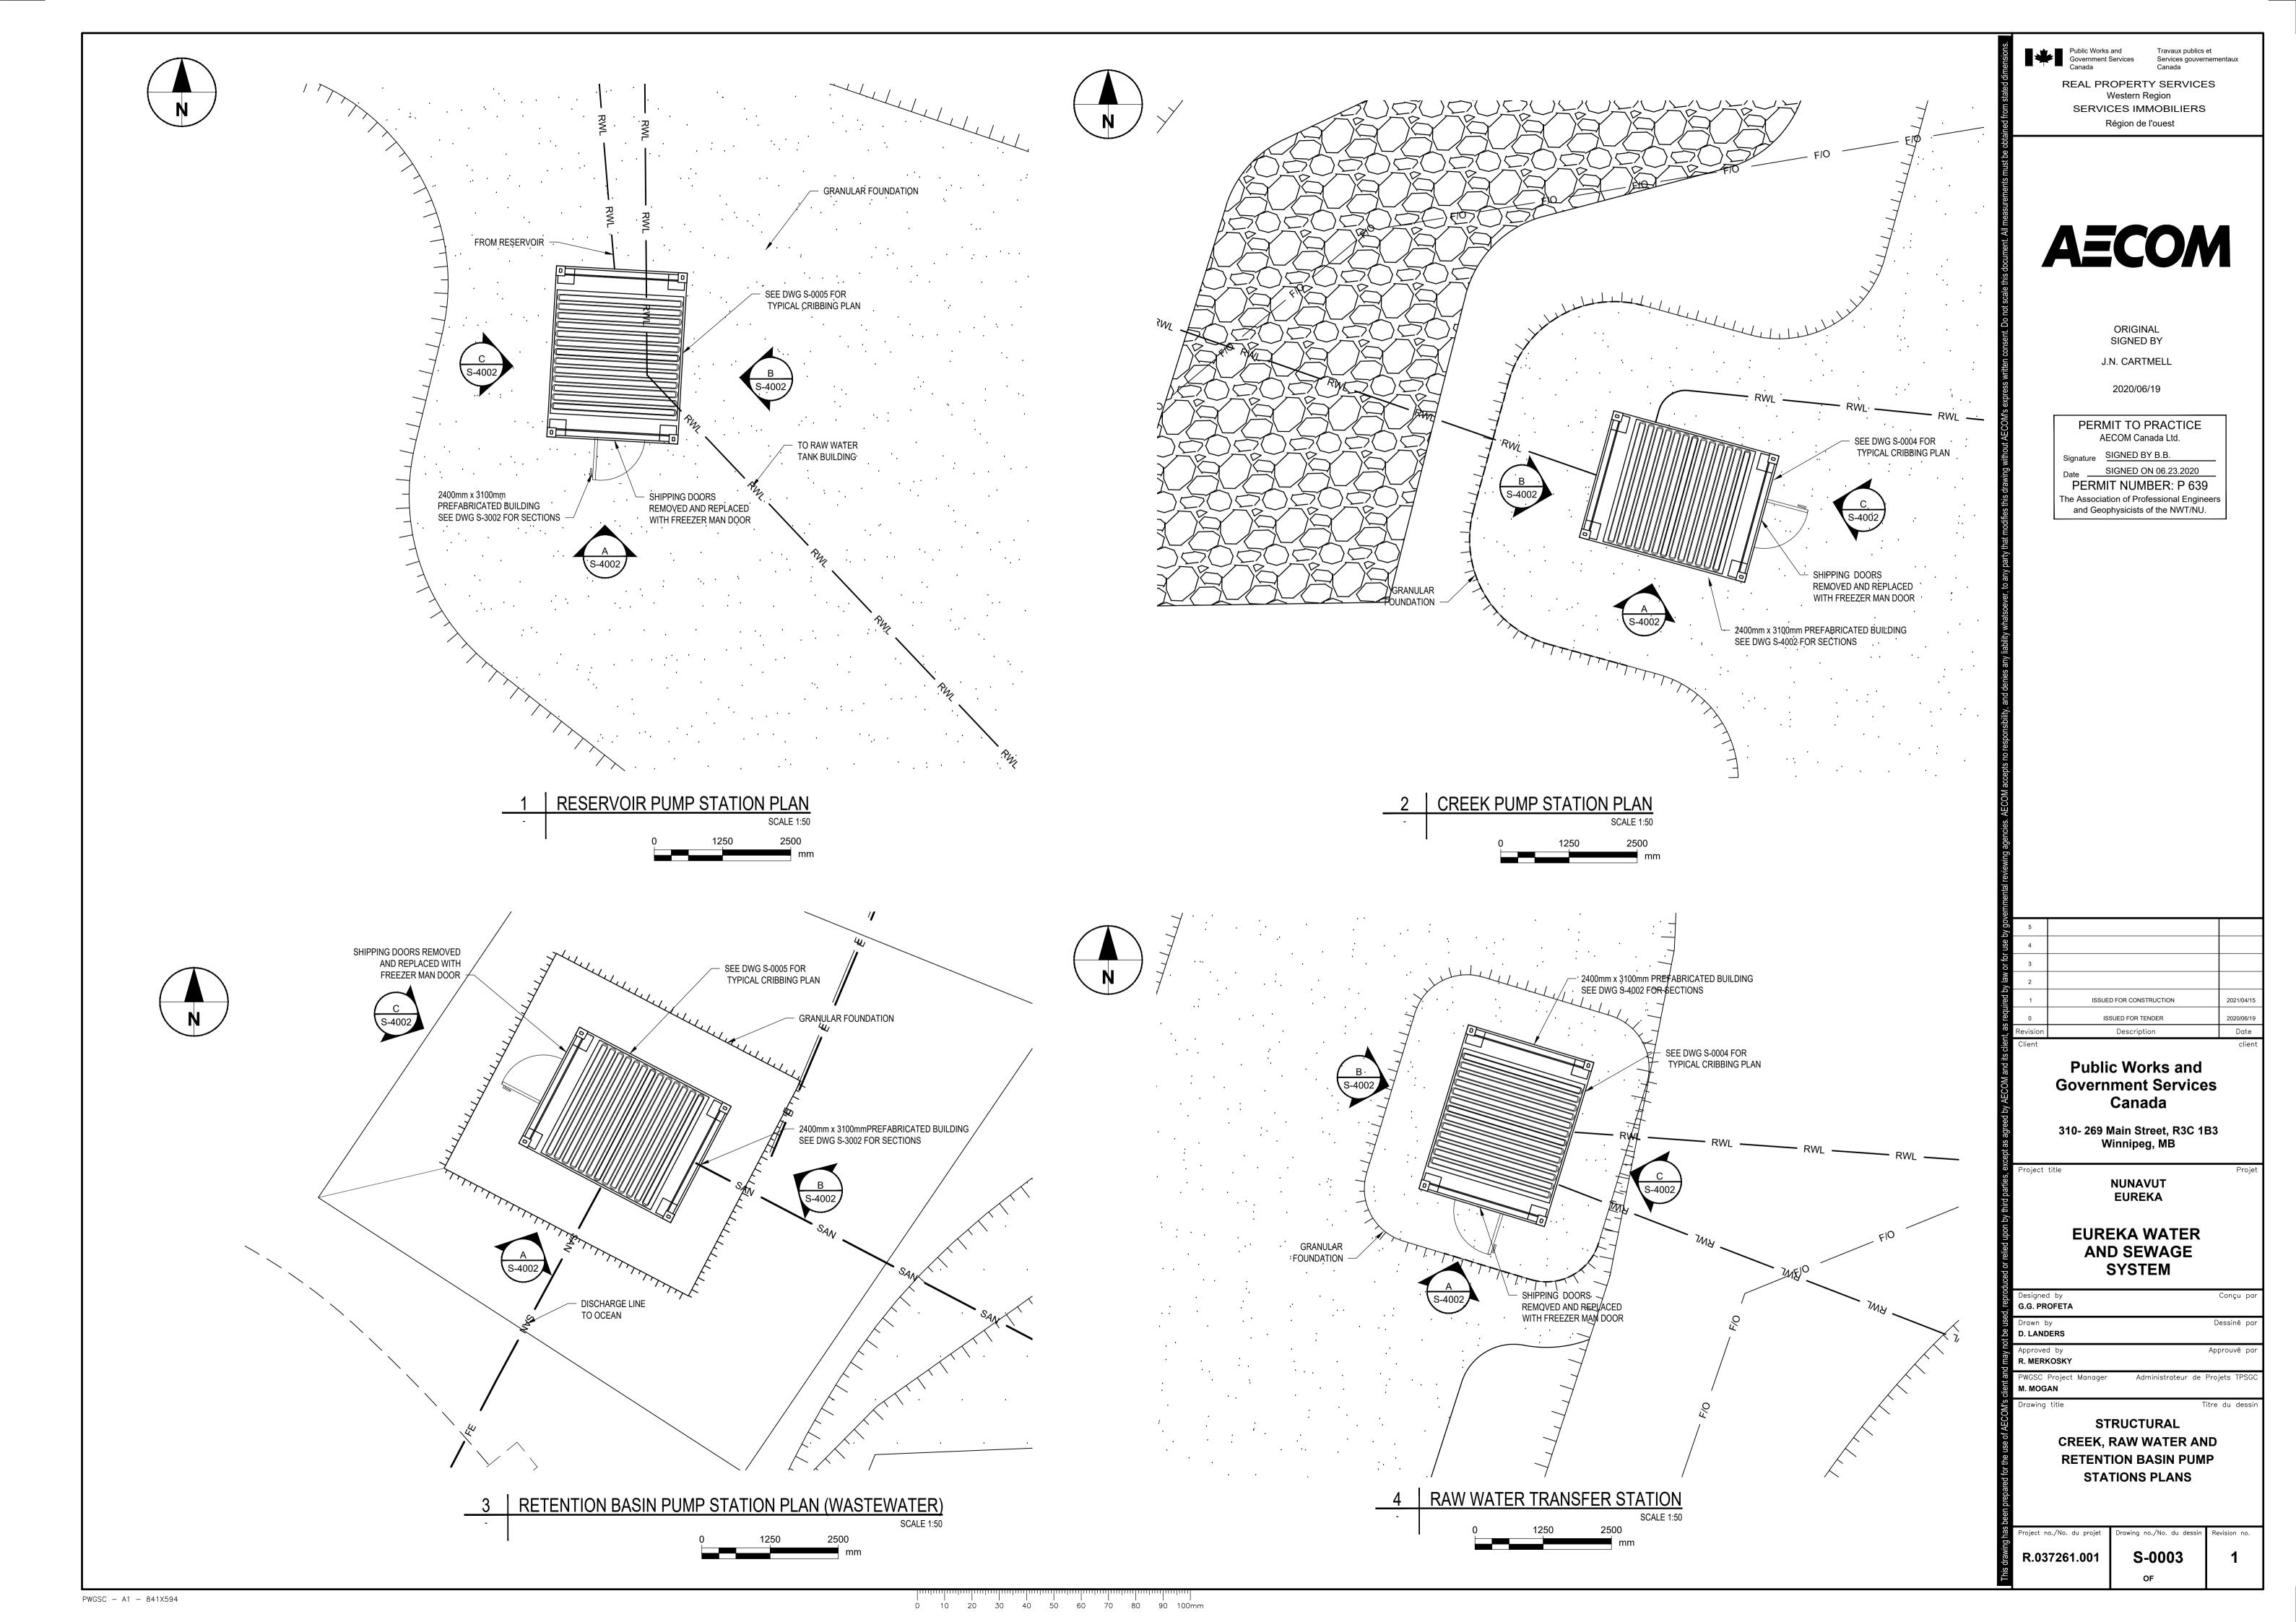


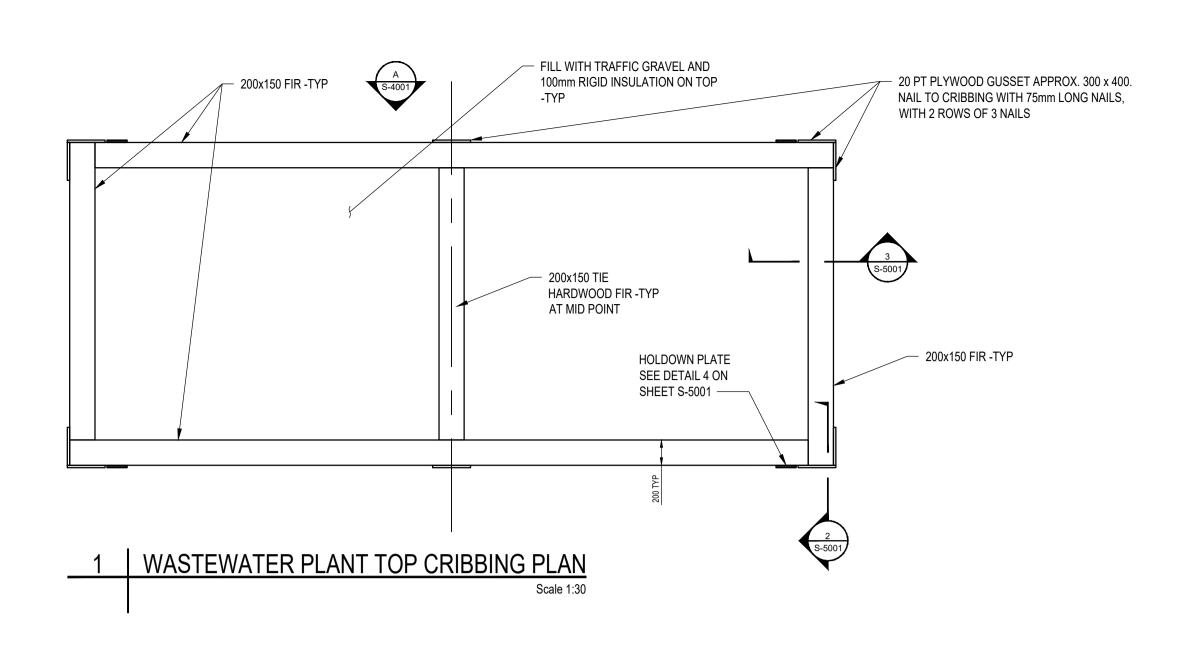

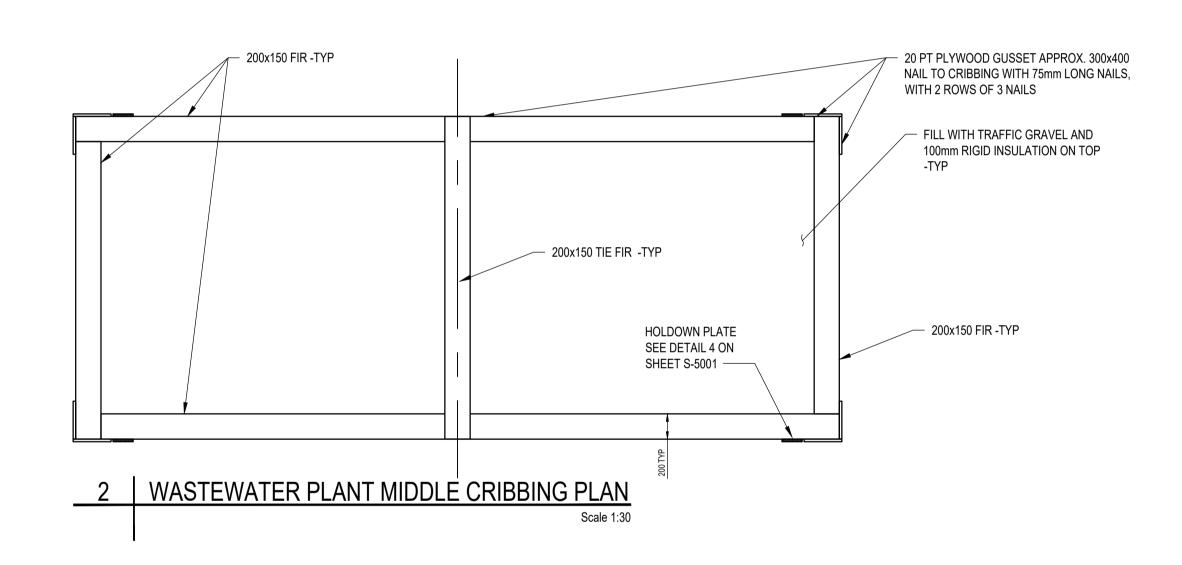

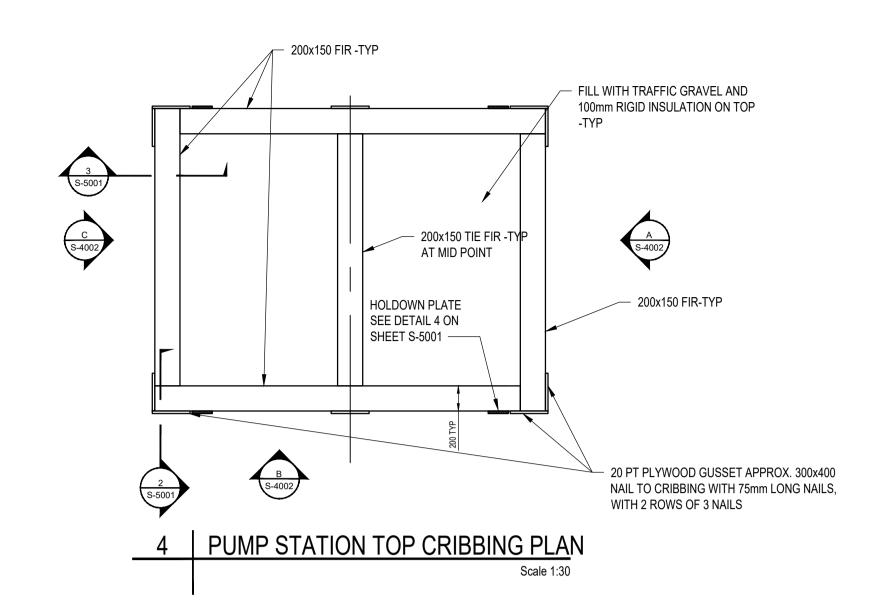

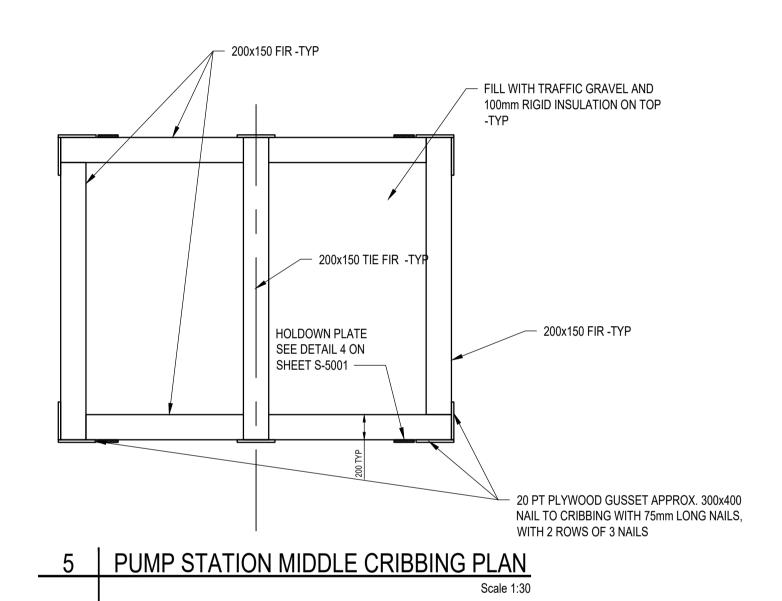

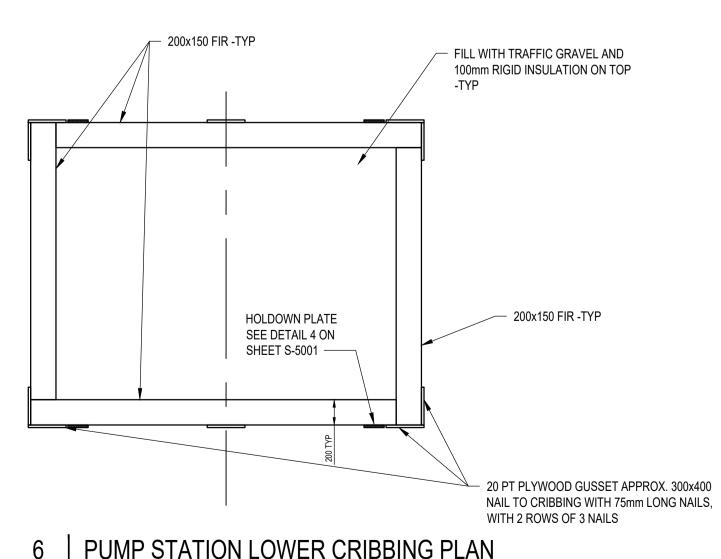

6 PUMP STATION LOWER CRIBBING PLAN
Scale 1:30

0 750 1500 mm

- CRIBBING TYPICAL FOR CREEK PUMP HOUSE, RAW WATER PUMP HOUSE AND RETENTION BASIN PUMP HOUSE
 SIZES TO MATCH ACTUAL DIMENSIONS OF PREFABRICATED
- BUILDINGS

 3. SEE DWG S-5001 FOR ANCHORING SYSTEM

DRAWING NOTE:

Public Works and Government Services Canada

Public Works and Services Government Serv

REAL PROPERTY SERVICES
Western Region
SERVICES IMMOBILIERS
Région de l'ouest

AECOM

ORIGINAL SIGNED BY J.N. CARTMELL

2020/06/19

PERMIT TO PRACTICE
AECOM Canada Ltd.
Signature SIGNED BY B.B.

Date SIGNED ON 06.23.2020
PERMIT NUMBER: P 639
The Association of Professional Engineers and Geophysicists of the NWT/NU.

Public Works and Government Services Canada

310- 269 Main Street, R3C 1B3 Winnipeg, MB

NUNAVUT EUREKA

EUREKA WATER AND SEWAGE SYSTEM

Designed by
G.G. PROFETA

Drawn by
D. LANDERS

Approved by
R. MERKOSKY

PWGSC Project Manager
M. MOGAN

Conçu por
Conçu por
Apprové por
Apprové por
Administrateur de Projets TPSG

STRUCTURAL
PACKAGED WASTEWATER
TREATMENT PLANT
AND PUMP STATION

Titre du dess

Project no./No. du projet


R.037261.001


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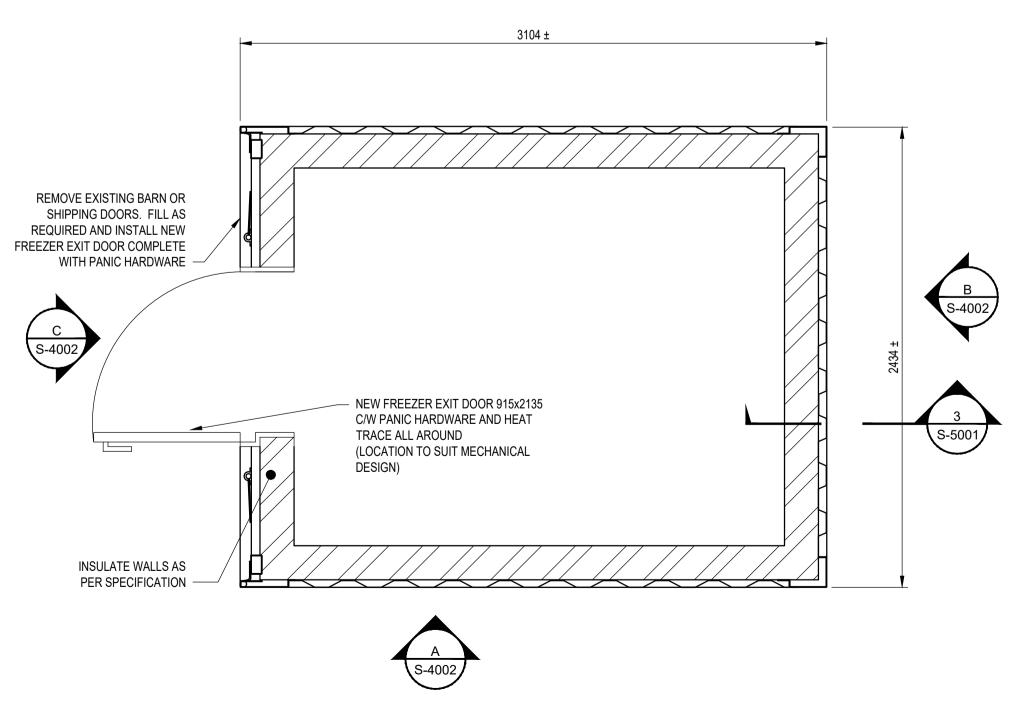
OF

CRIBBING PLANS

PWGSC - A1 - 841X594



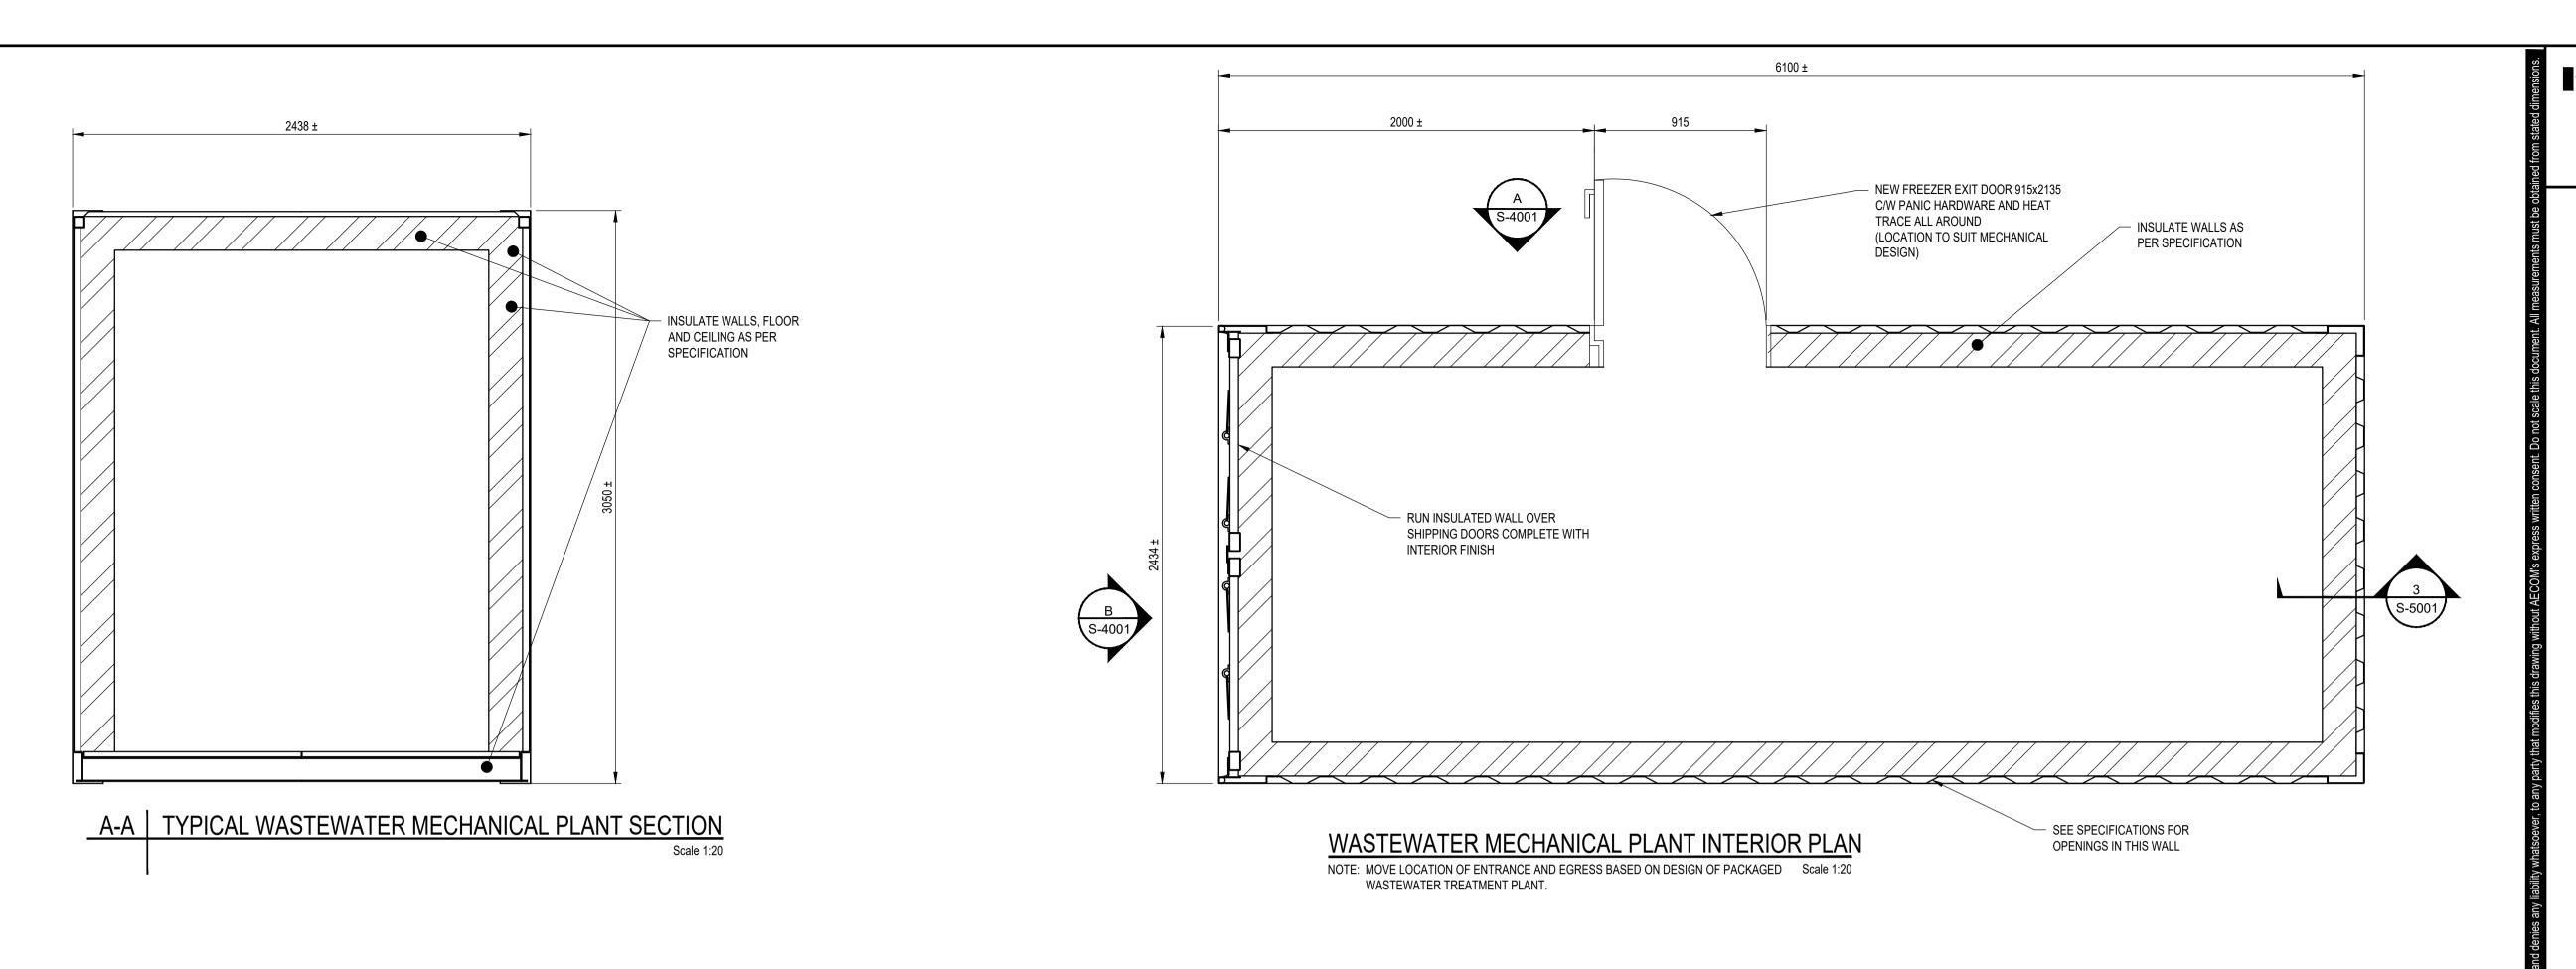

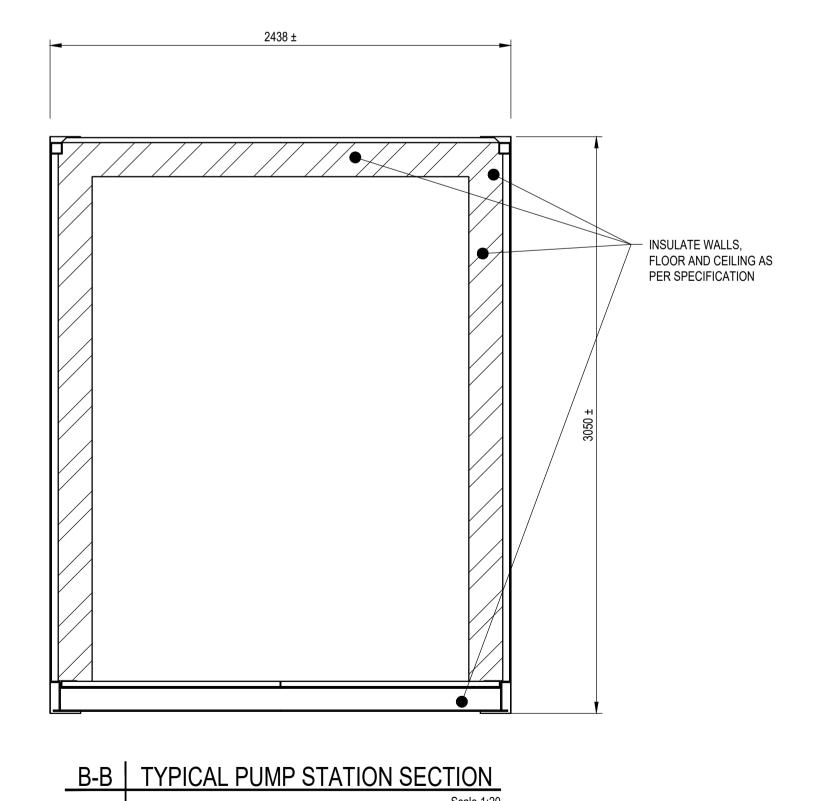

TYPICAL PUMP STATION INTERIOR PLAN

DRAWING NOTES:

- SECTIONS TYPICAL FOR, PACKAGED WASTEWATER TREATMENT PLANT, CREEK PUMP HOUSE, RESERVOIR PUMP HOUSE AND RETENTION BASIN PUMP HOUSE
- INTERMODAL UNITS ARE PURCHASED ITEMS AND ARE DESIGNED AND DETAILED BY VENDOR BASED ON PERFORMANCE SPECIFICATIONS TO CREATE A PREFABRICATED BUILDING.

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Travaux publics et
Services gouvernementaux
Canada

REAL PROPERTY SERVICES

Western Region SERVICES IMMOBILIERS Région de l'ouest



ORIGINAL SIGNED BY J.N. CARTMELL

2020/06/19

PERMIT TO PRACTICE AECOM Canada Ltd.

Signature SIGNED BY B.B.

Date SIGNED ON 06.23.2020

PERMIT NUMBER: P 639

The Association of Professional Engineers

and Geophysicists of the NWT/NU.

1 ISSUED FOR CONSTRUCTION 2
0 ISSUED FOR TENDER 2
evision Description

Public Works and
Government Services
Canada

310- 269 Main Street, R3C 1B3 Winnipeg, MB

NUNAVUT EUREKA

EUREKA WATER AND SEWAGE SYSTEM

Designed by
G.G. PROFETA

Drawn by
Dessiné po
D. LANDERS

Approved by
R. MERKOSKY

PWGSC Project Manager

Administrateur de Projets TPSG

M. MOGAN

Prawing title


STRUCTURAL
PACKAGED WASTEWATER
TREATMENT PLANT AND
TYPICAL PUMP STATION


PLANS AND SECTIONS


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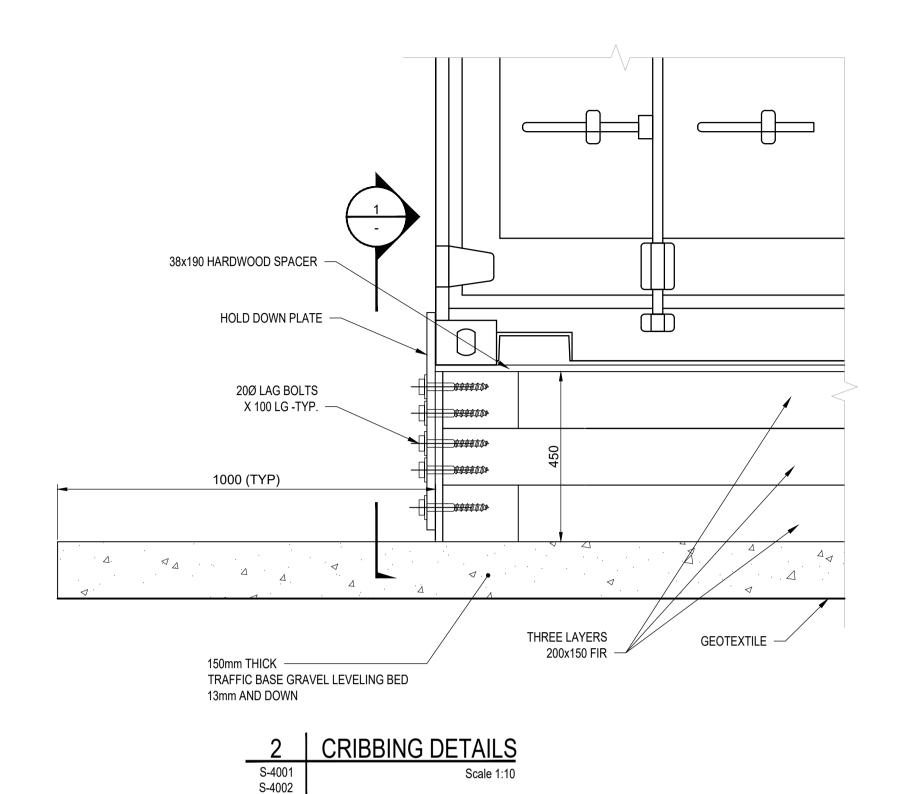
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PWGSC - A1 - 841X594





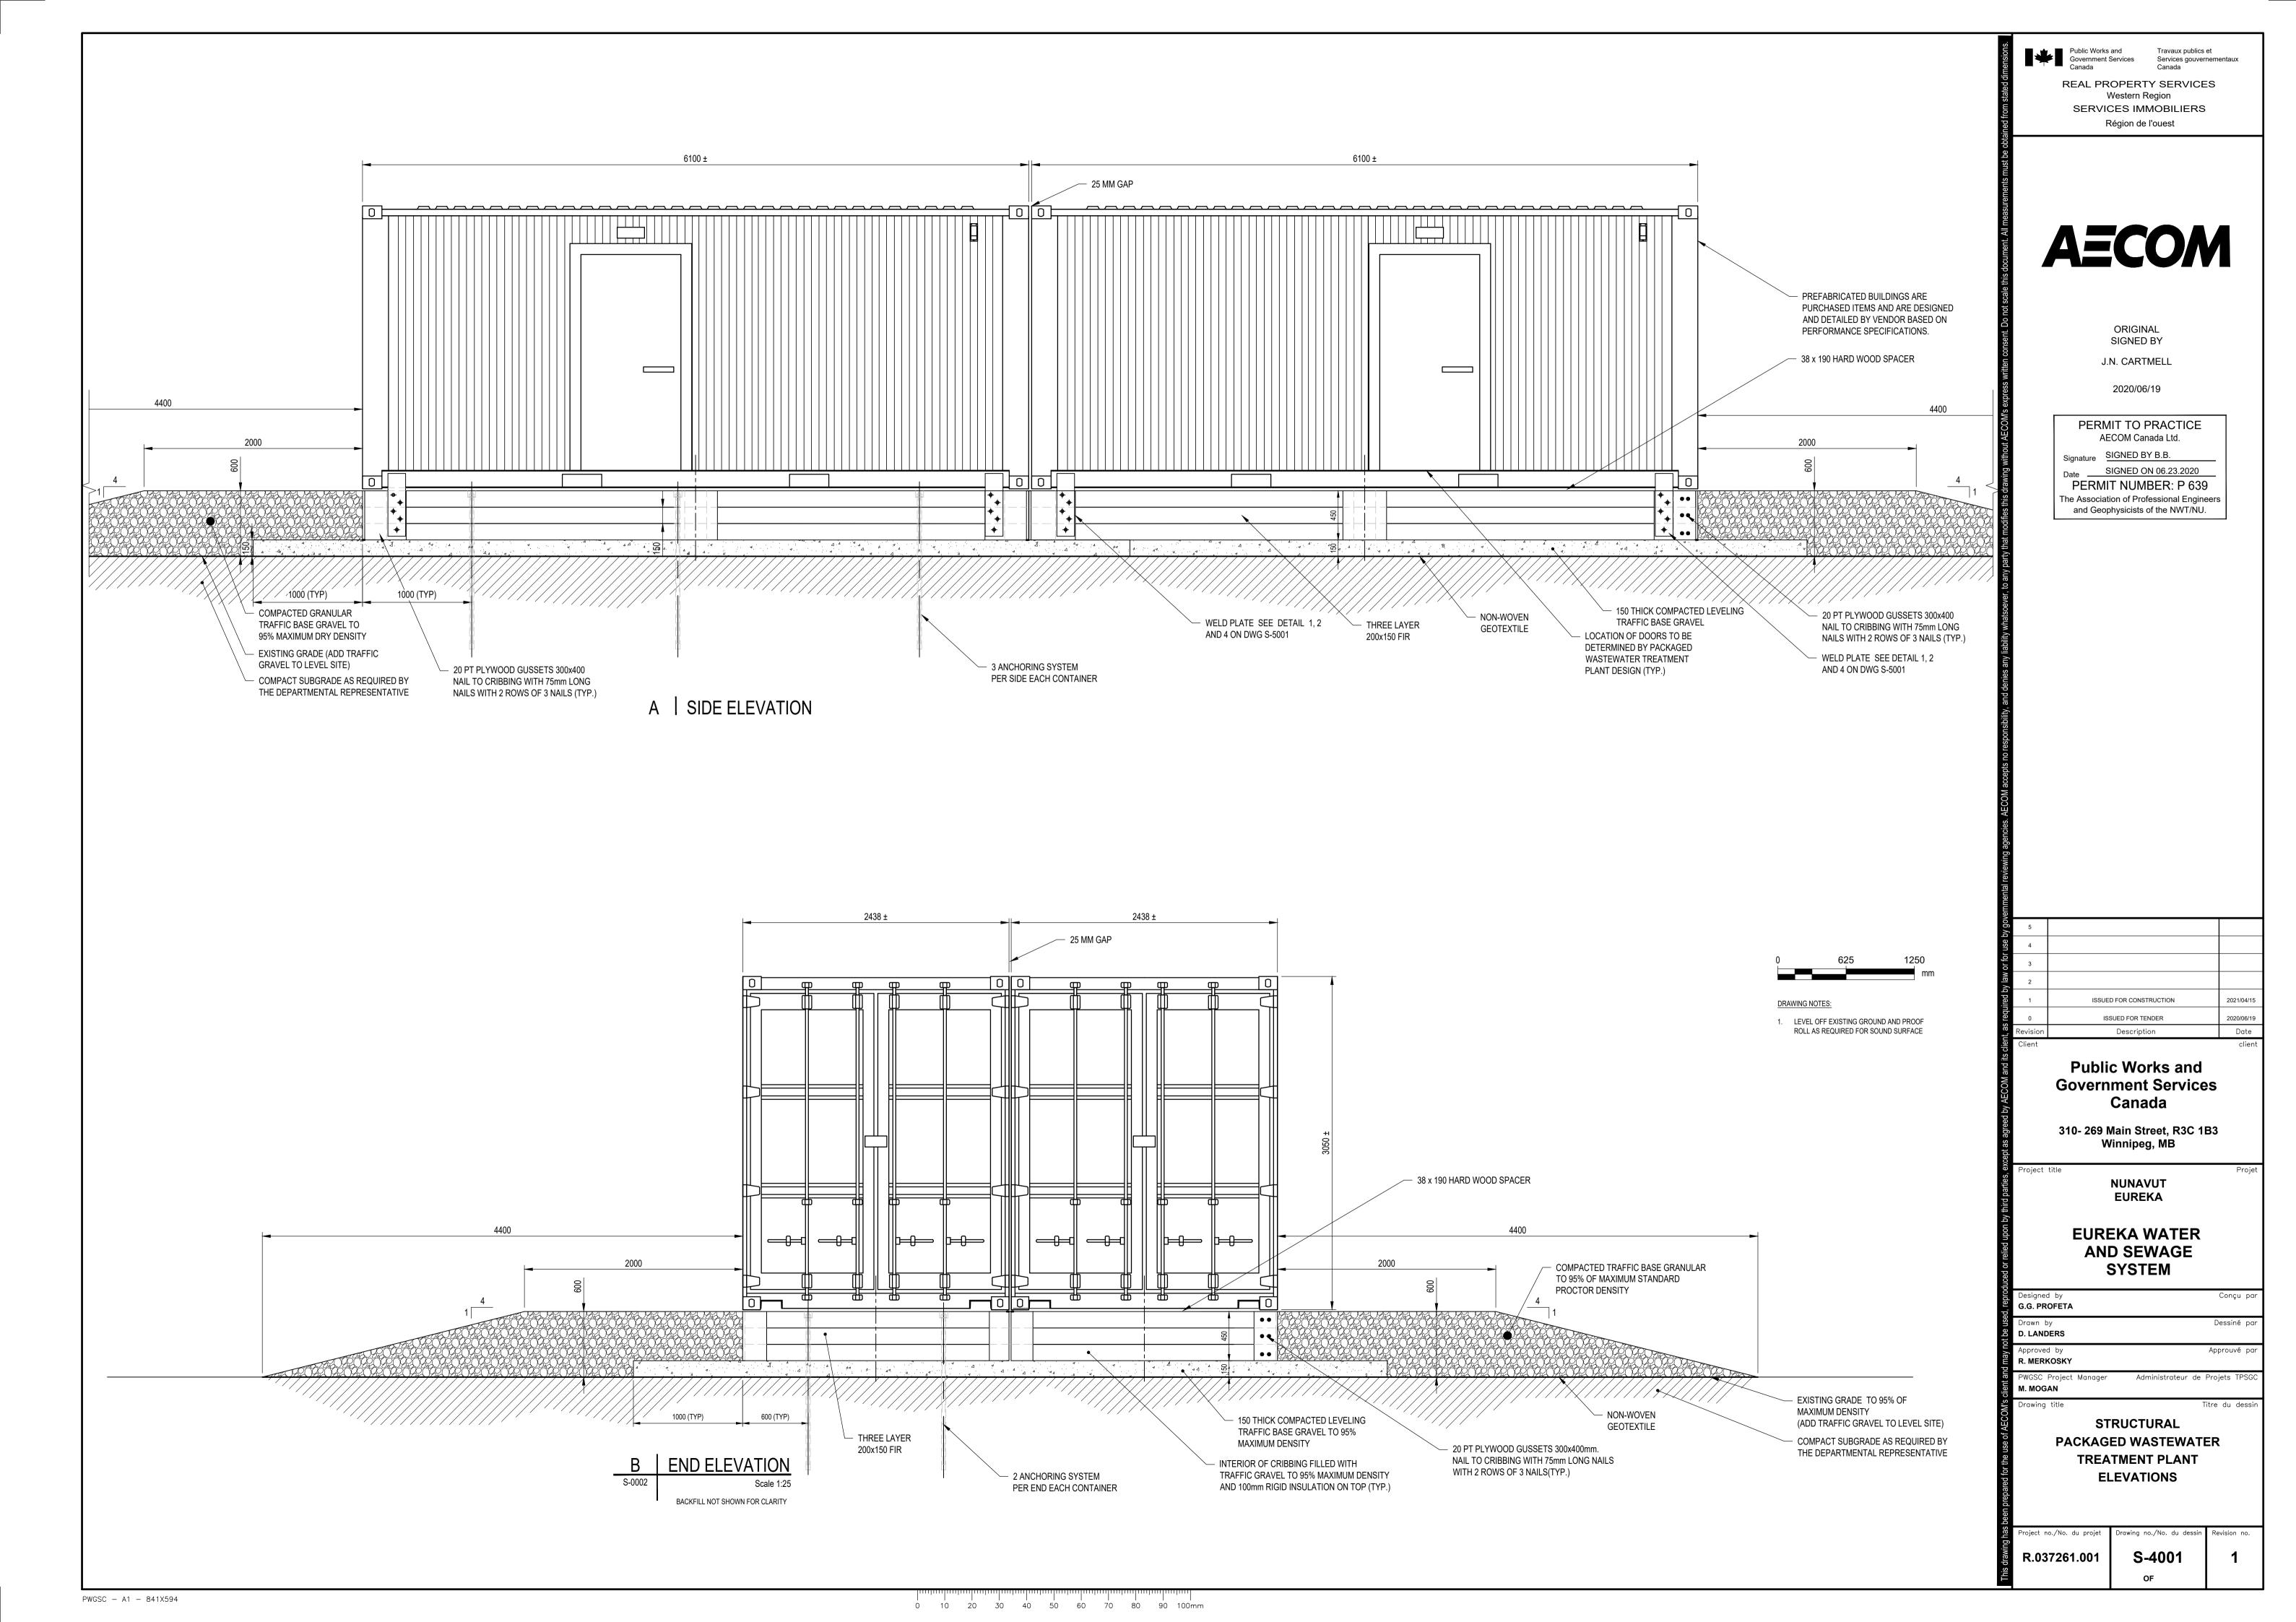


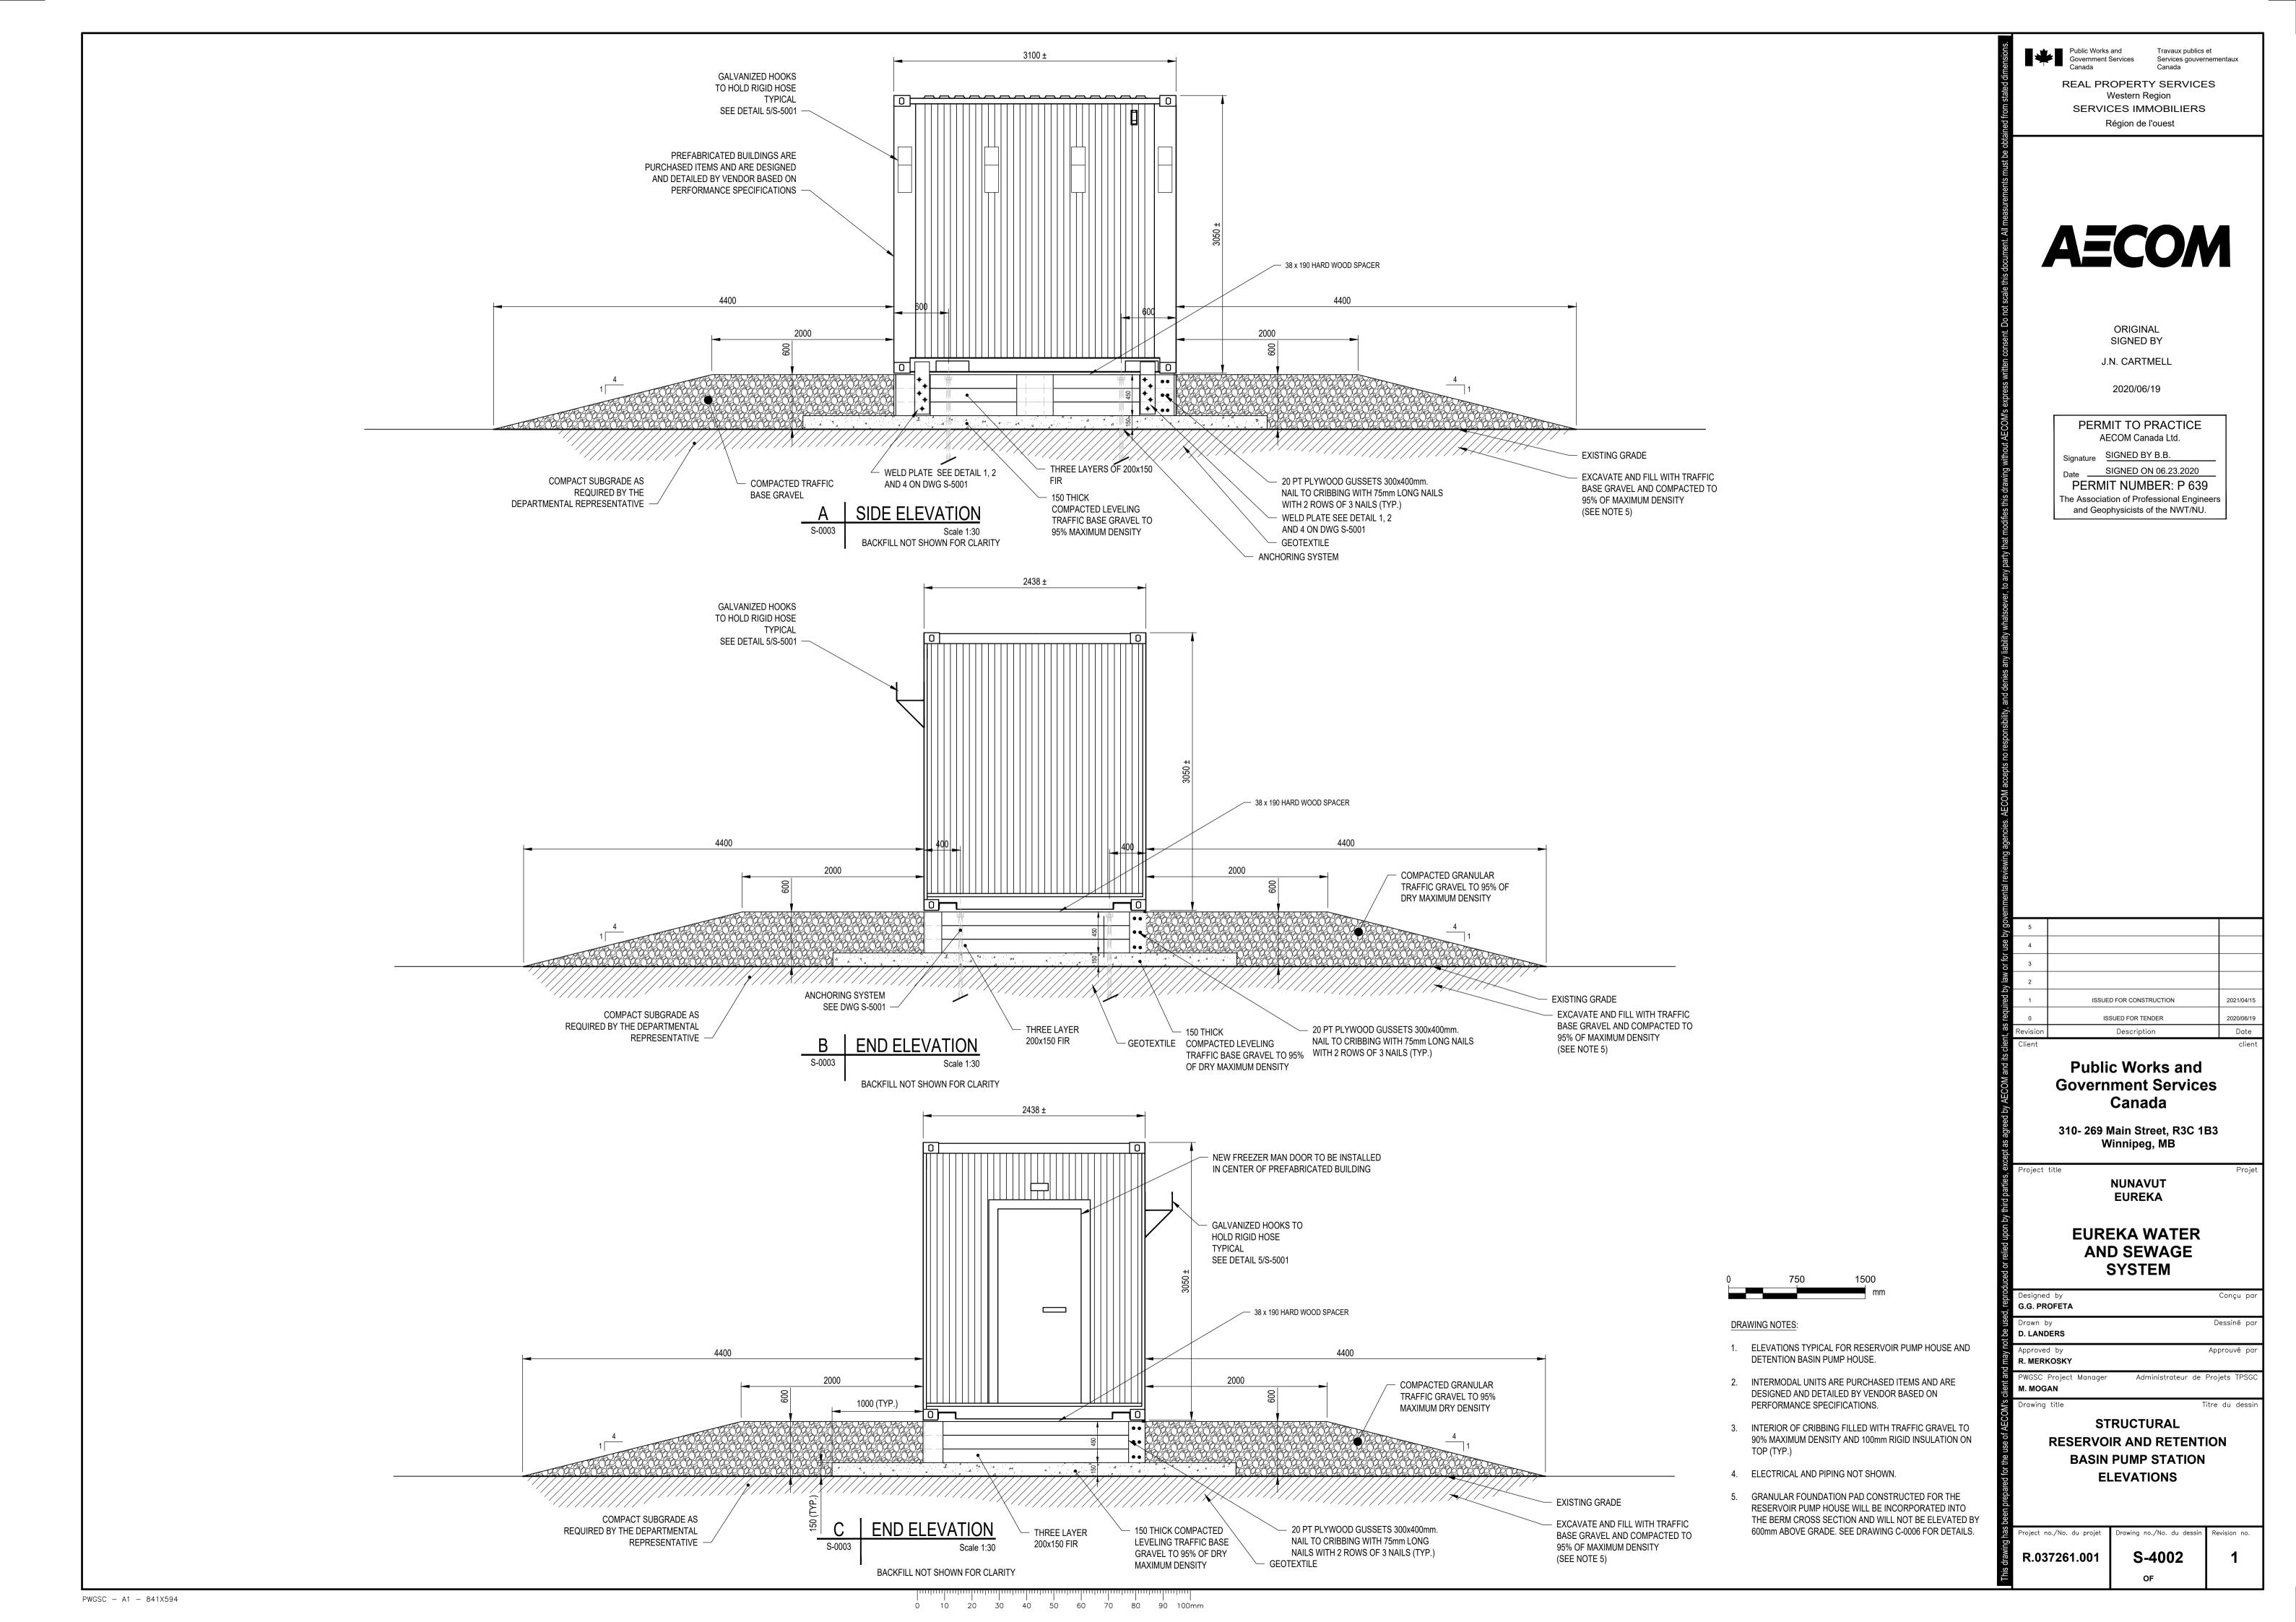

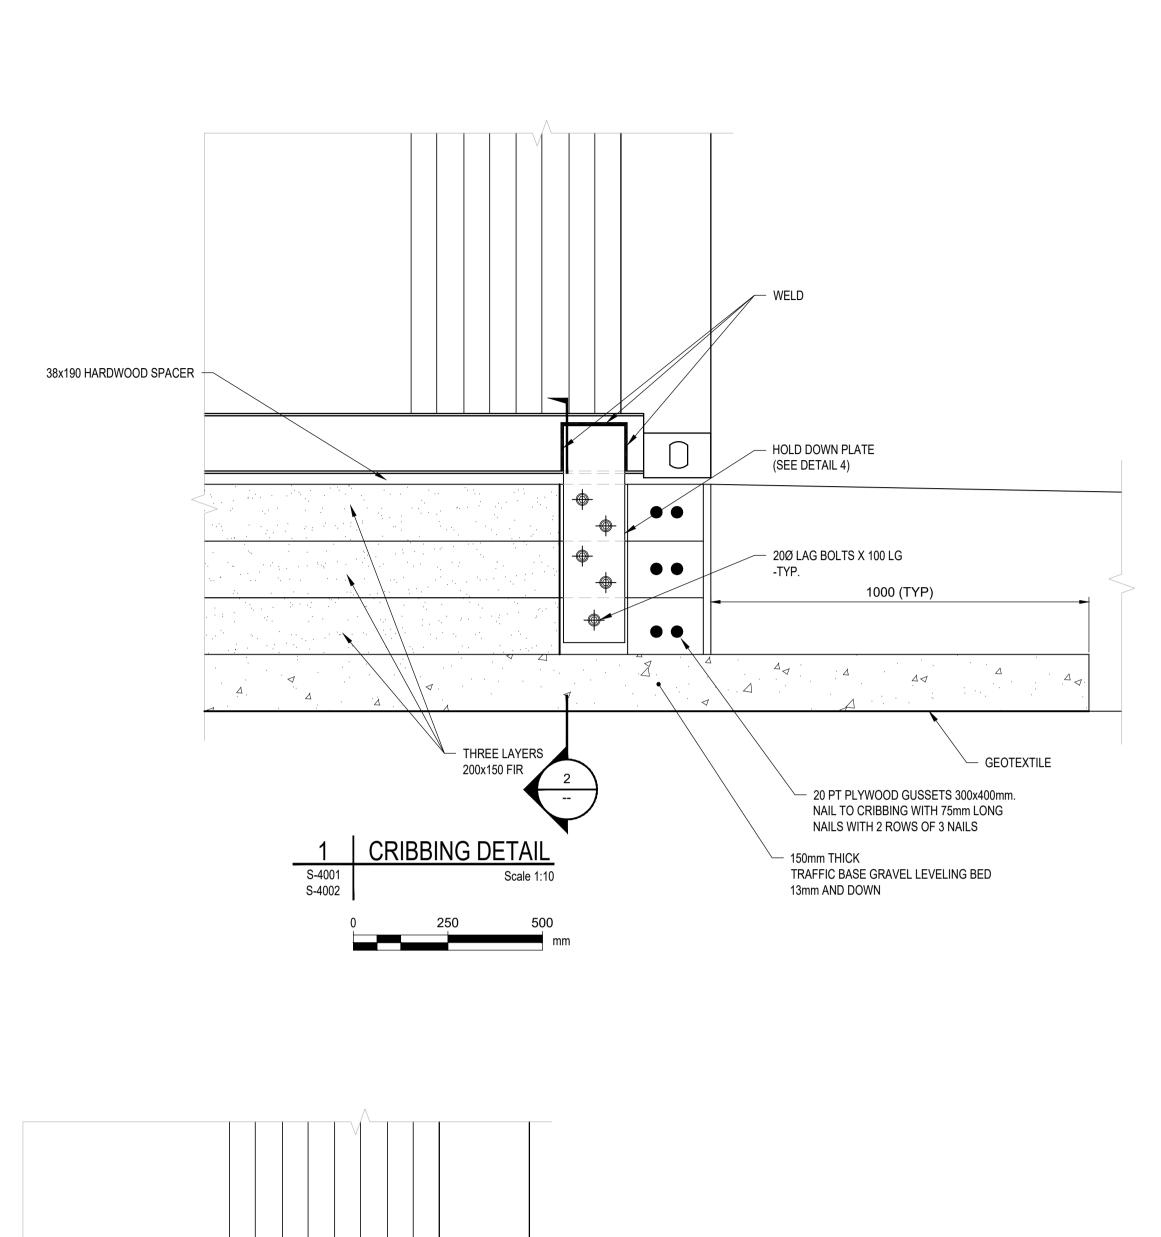
100mm RIGID INSULATION TYPICAL FOR ALL UNITS 38x190 HARDWOOD SPACER CONT.
— NUT AND WASHER - SPACE AS REQ'D 1000 (TYP) 150mm THICK - INTERIOR OF CRIBBING FILLED - 25M REBAR x 1500 LG THREAD TOP 100 TRAFFIC BASE GRAVEL LEVELING BED 13mm AND DOWN GEOTEXTILE WITH TRAFFIC GRAVEL TO 95% MAXIMUM DENSITY AND 100mm RIGID INSULATION ON TOP (TYP.) 38 Ø DRILLED HOLE CRIBBING SECTION 3 S-4001 S-4002 ANCHORING SYSTEM 3 ANCHORS ON THE LONG SIDE AND 2

ON THE END OF EACH CONTAINER UNIT

TYPICAL FOR ALL CONTAINERS

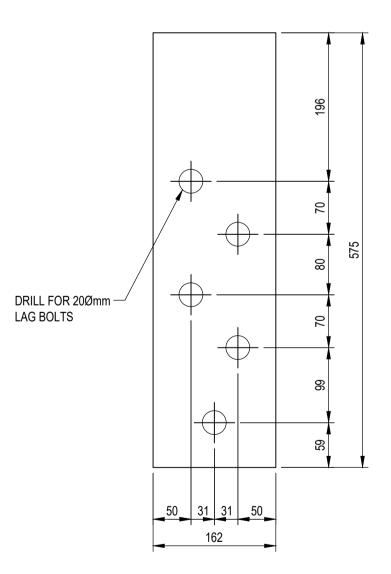



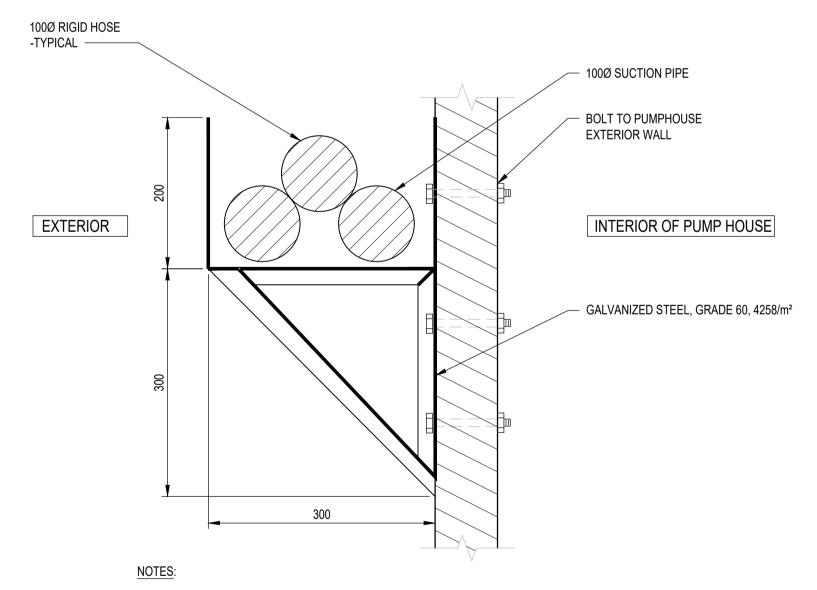

1. ALL STEEL HOT DIPPED GALVANIZED AFTER FABRICATION.

2. SECURE WITH APPROVED ANCHORS TO MATCH WALL CONSTRUCTION.

TYPICAL SUPPORT FOR RIGID HOSE STORAGE

DRAWING NOTES:

- 1. DETAILS TYPICAL FOR PACKAGED WASTEWATER TREATMENT PLANT, CREEK PUMP HOUSE, RESERVOIR PUMP HOUSE AND RETENTION BASIN PUMP HOUSE
- TEMPERATURE TO MANUFACTURERS LIMITS).

Public Works and Government Services Canada

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REAL PROPERTY SERVICES Western Region SERVICES IMMOBILIERS Région de l'ouest



ORIGINAL SIGNED BY J.N. CARTMELL

2020/06/19

PERMIT TO PRACTICE AECOM Canada Ltd.

Signature SIGNED BY B.B. Date SIGNED ON 06.23.2020 PERMIT NUMBER: P 639 The Association of Professional Engineers and Geophysicists of the NWT/NU.

ISSUED FOR CONSTRUCTION ISSUED FOR TENDER Public Works and

> **Government Services** Canada 310- 269 Main Street, R3C 1B3

Winnipeg, MB

NUNAVUT **EUREKA**

EUREKA WATER AND SEWAGE SYSTEM

G.G. PROFETA Dessiné po D. LANDERS Approuvé po R. MERKOSKY

M. MOGAN STRUCUTRAL


PACKAGED WASTEWATER TREATMENT PLANT **AND PUMP STATIONS** CRIBBING DETAILS


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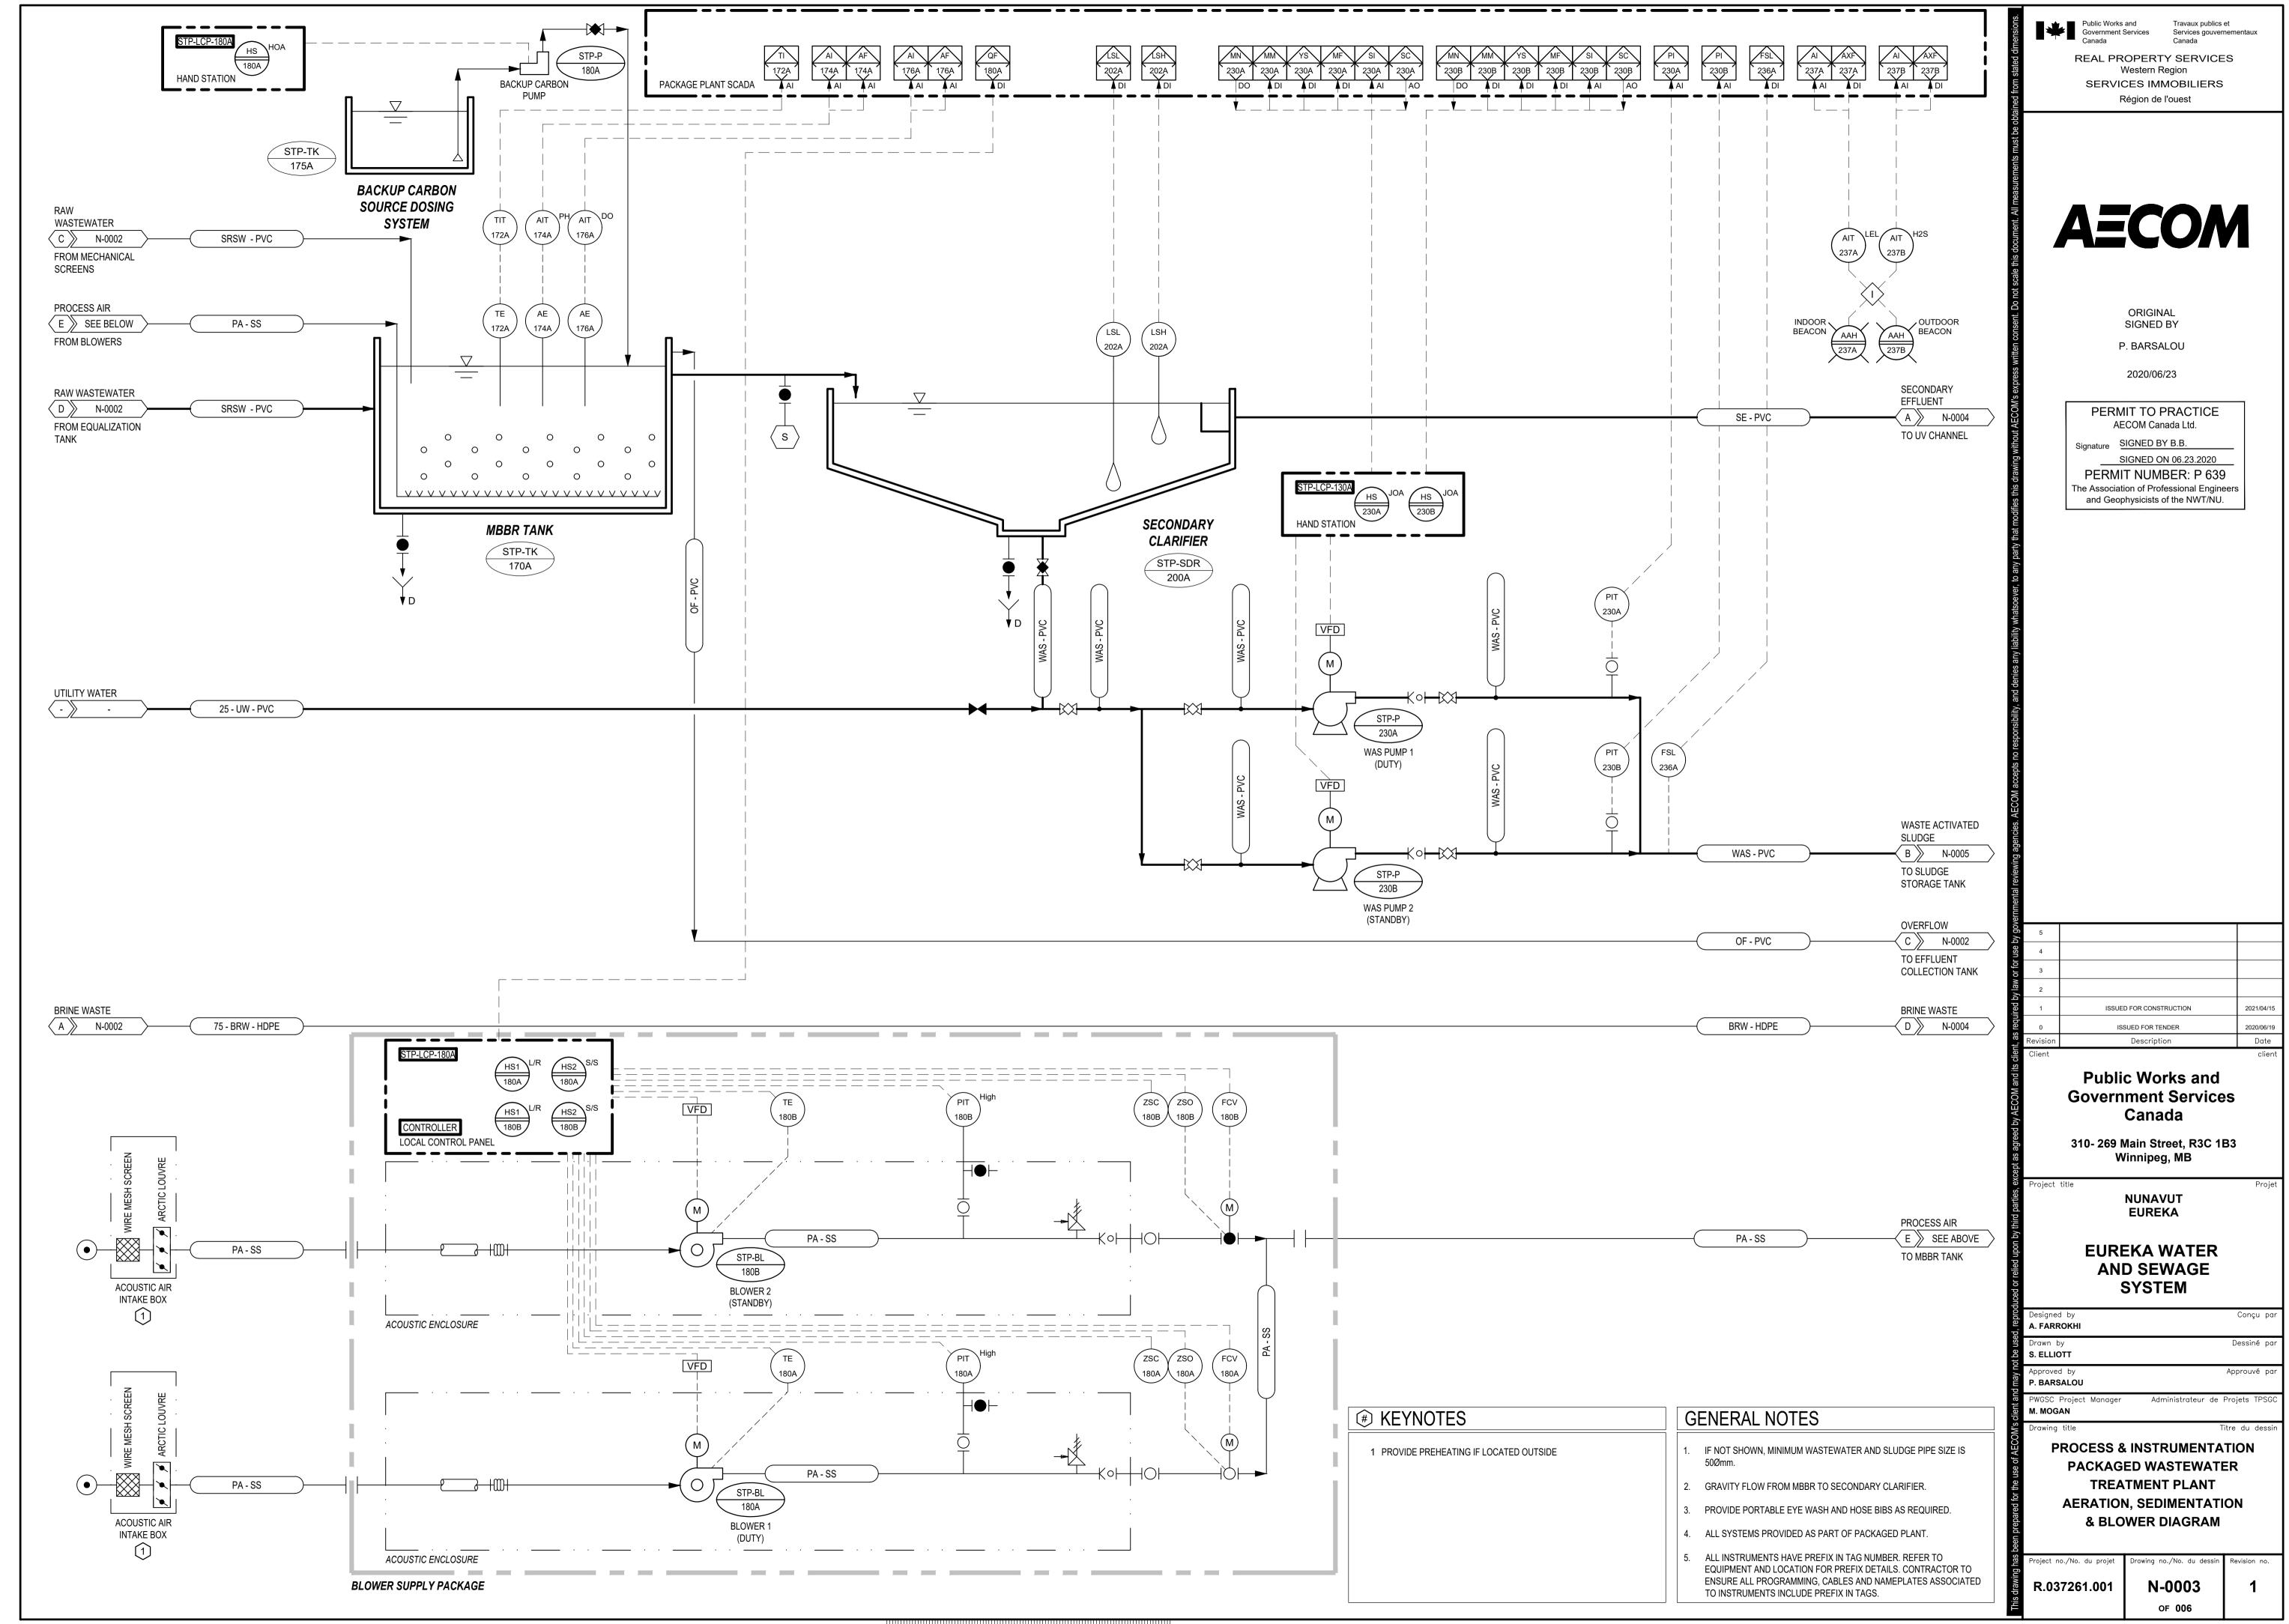
S-5001 R.037261.001


2. GROUT FOR THE ANCHORS INTO THE GROUND SHOULD BE SIKAGROUT ARCTIC 100 OR EQUAL (CONFIRM GROUND


3. ALL FASTENERS (NAILS AND LAG SCREWS) TO BE HOT DIPPED GALVANIZED.




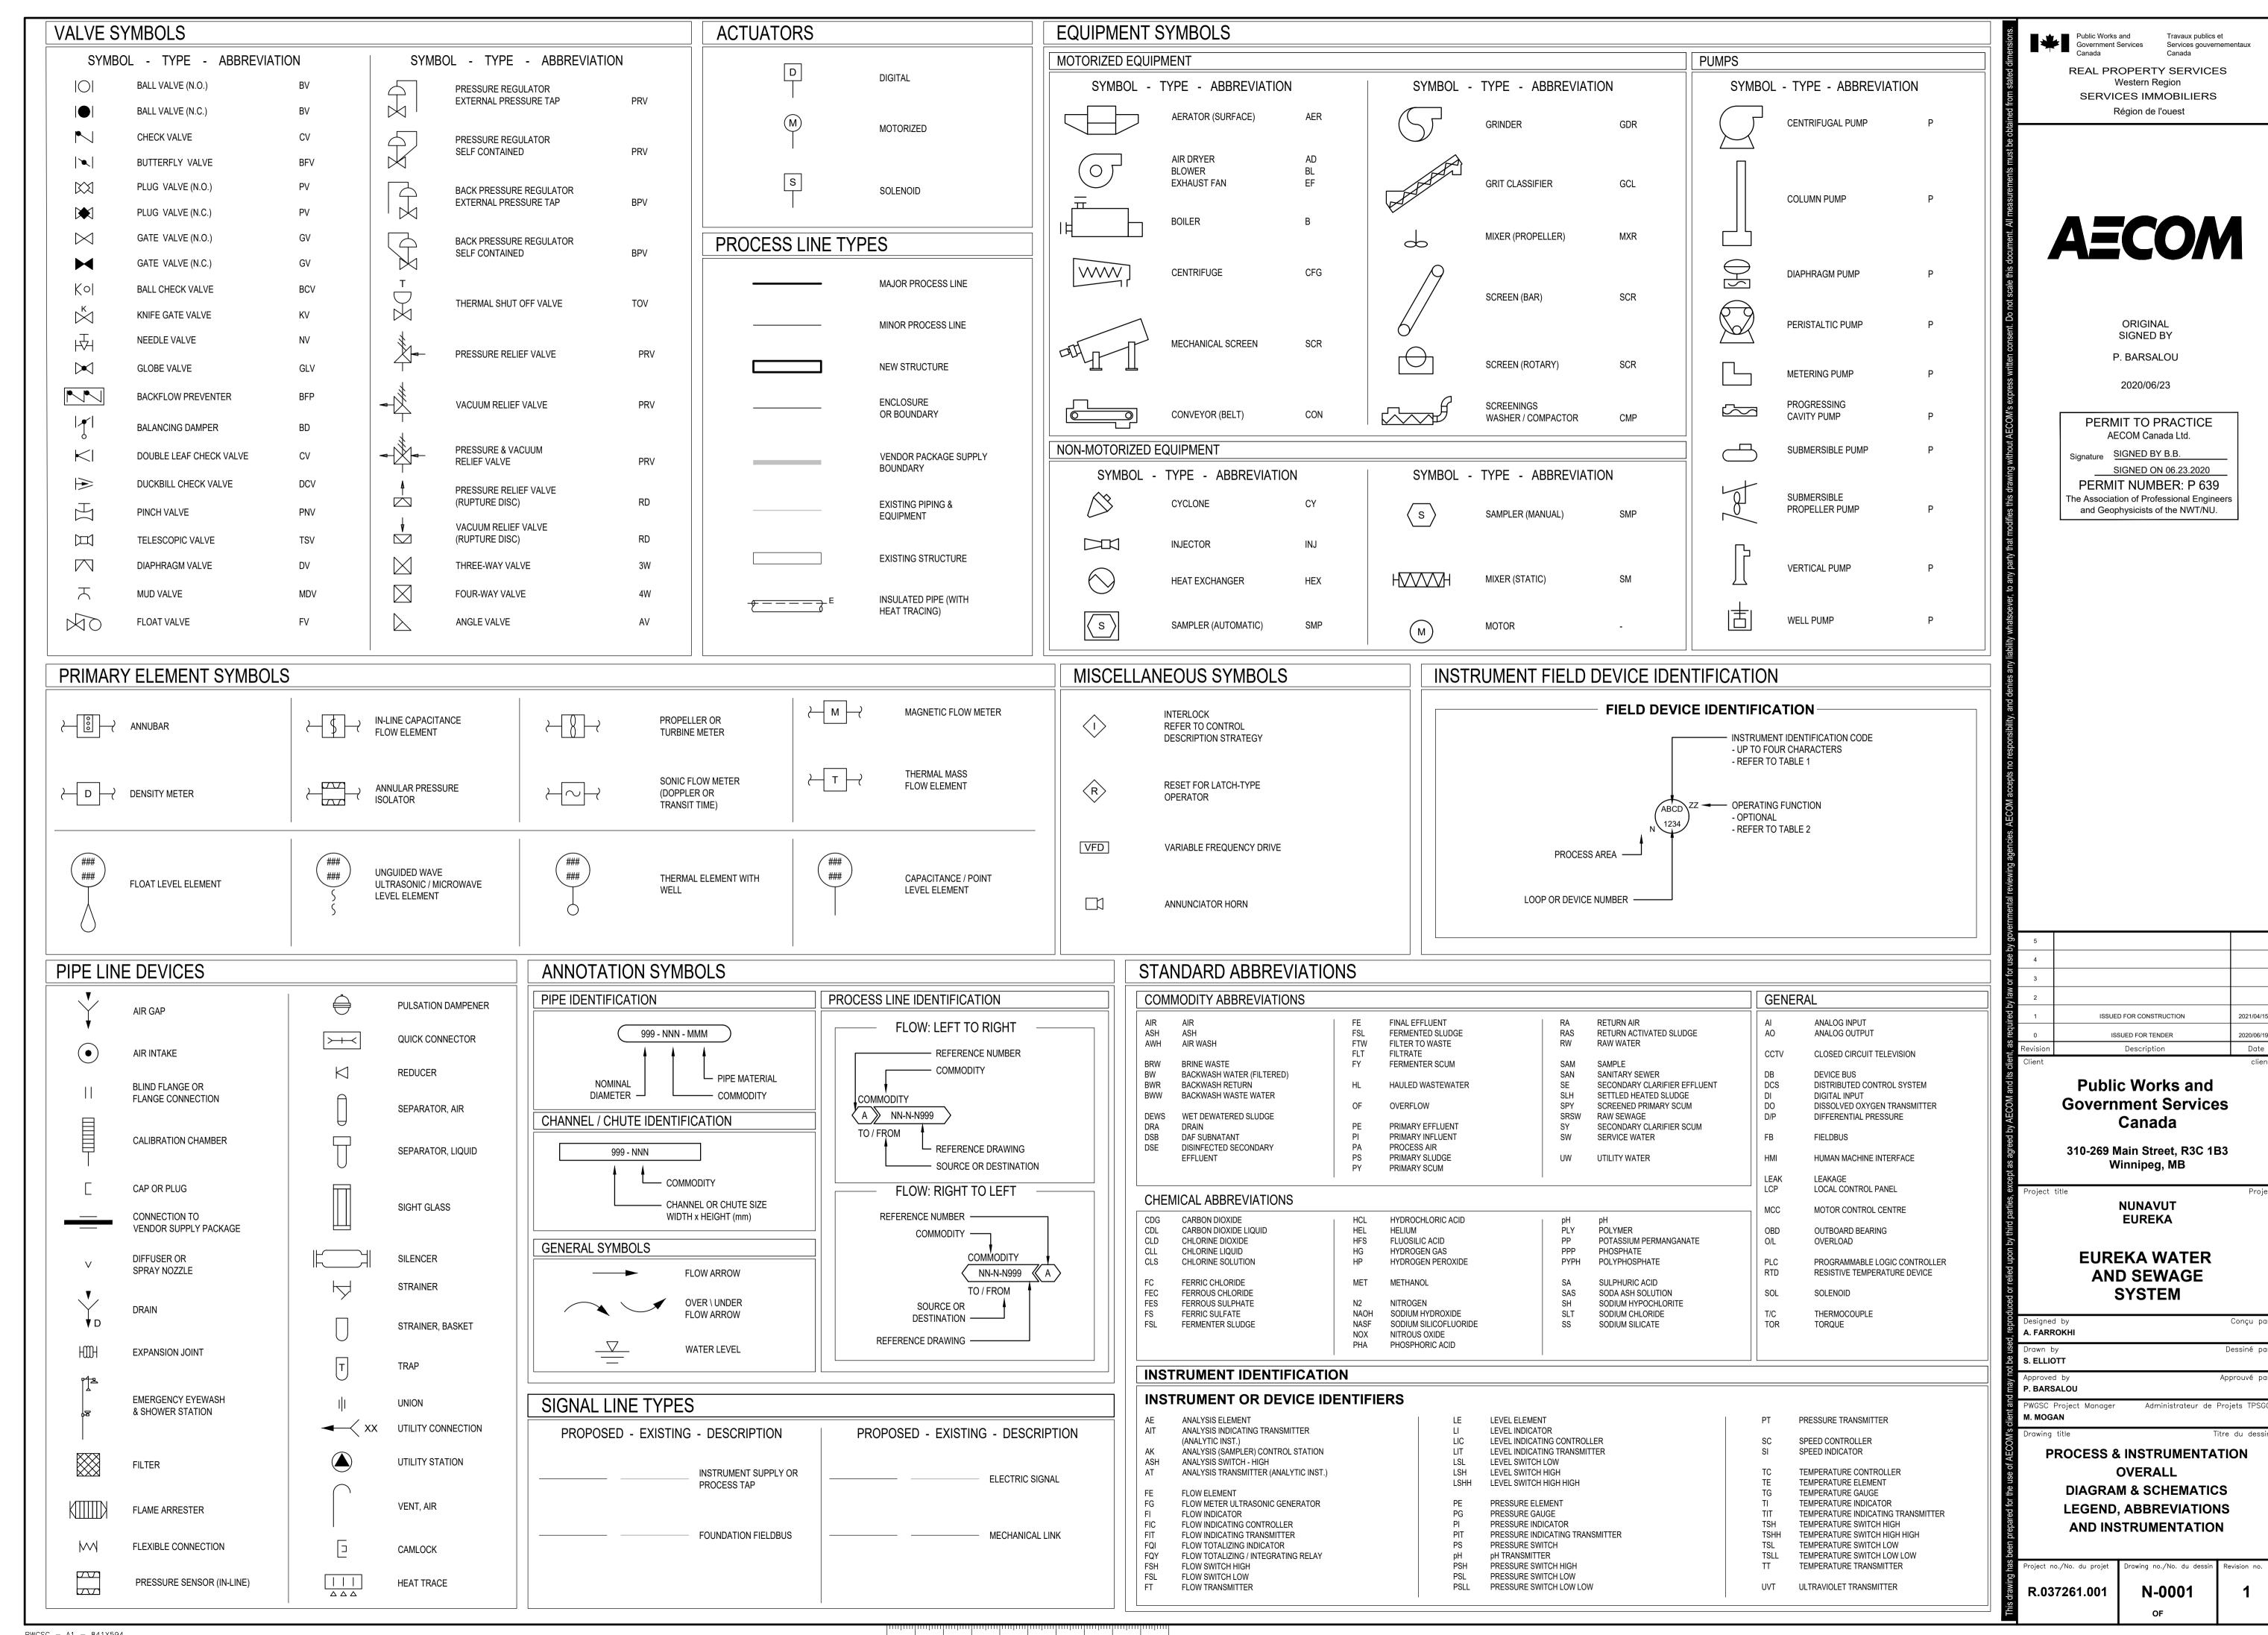


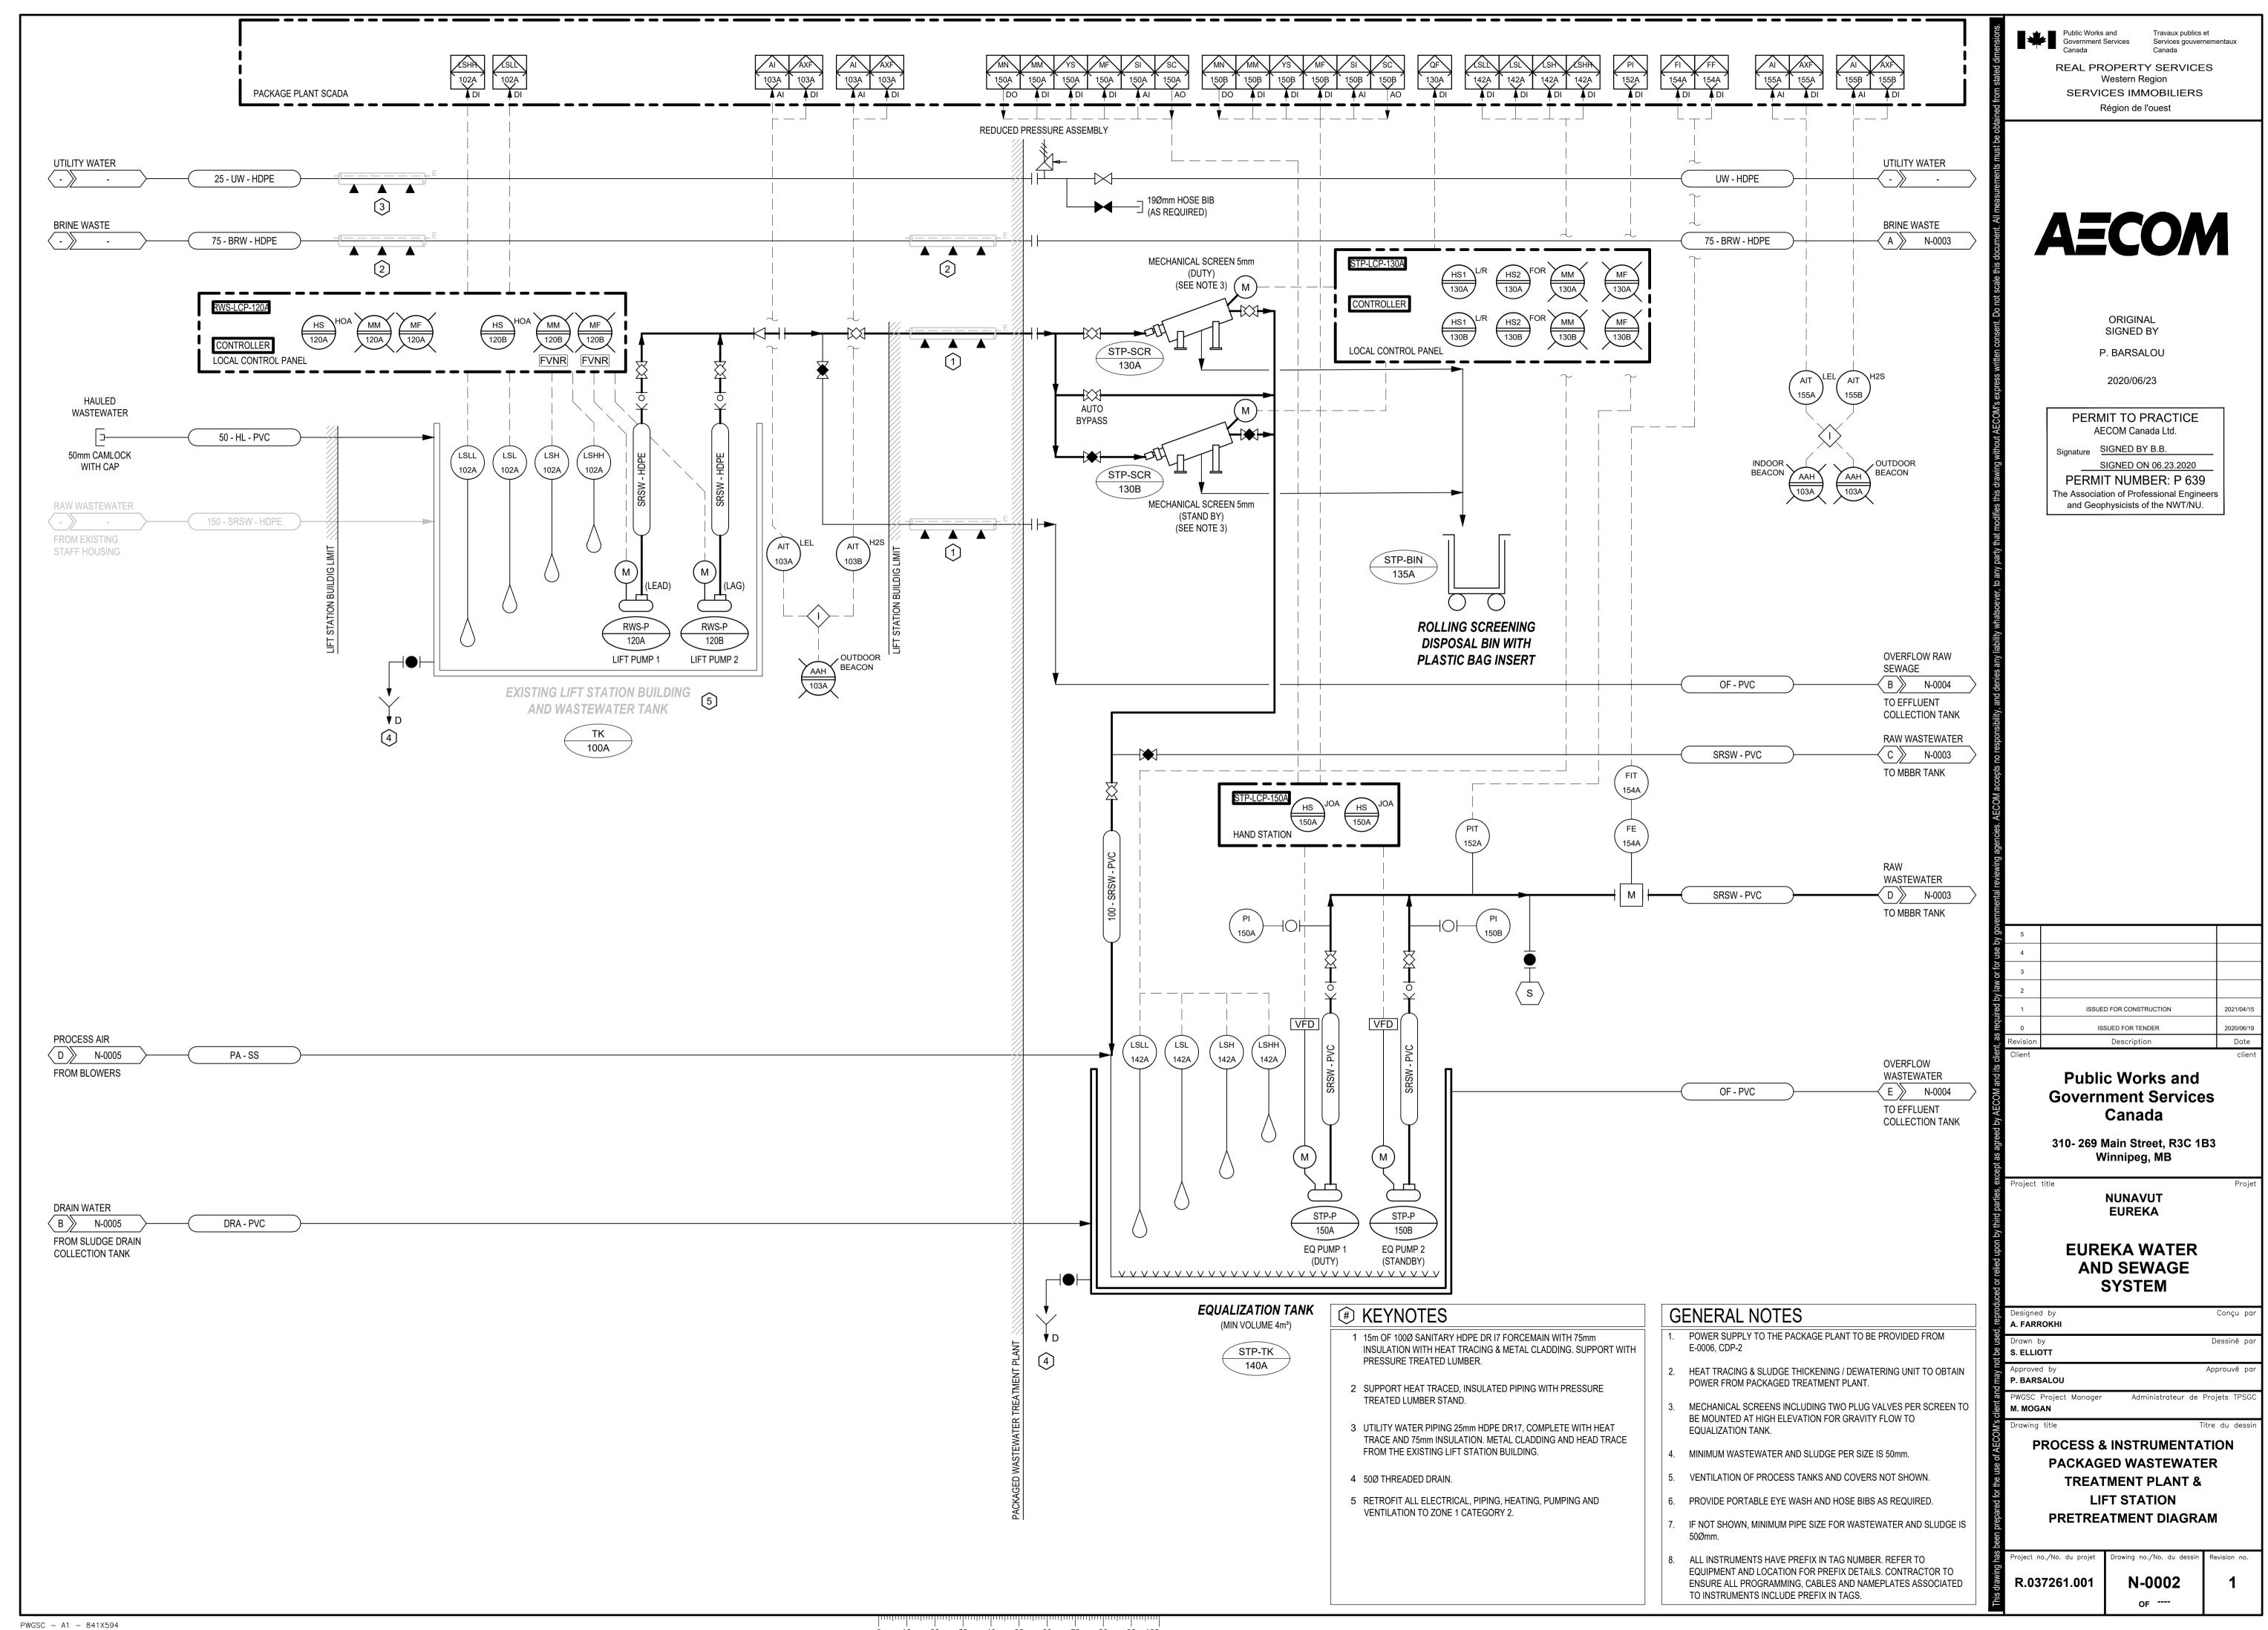


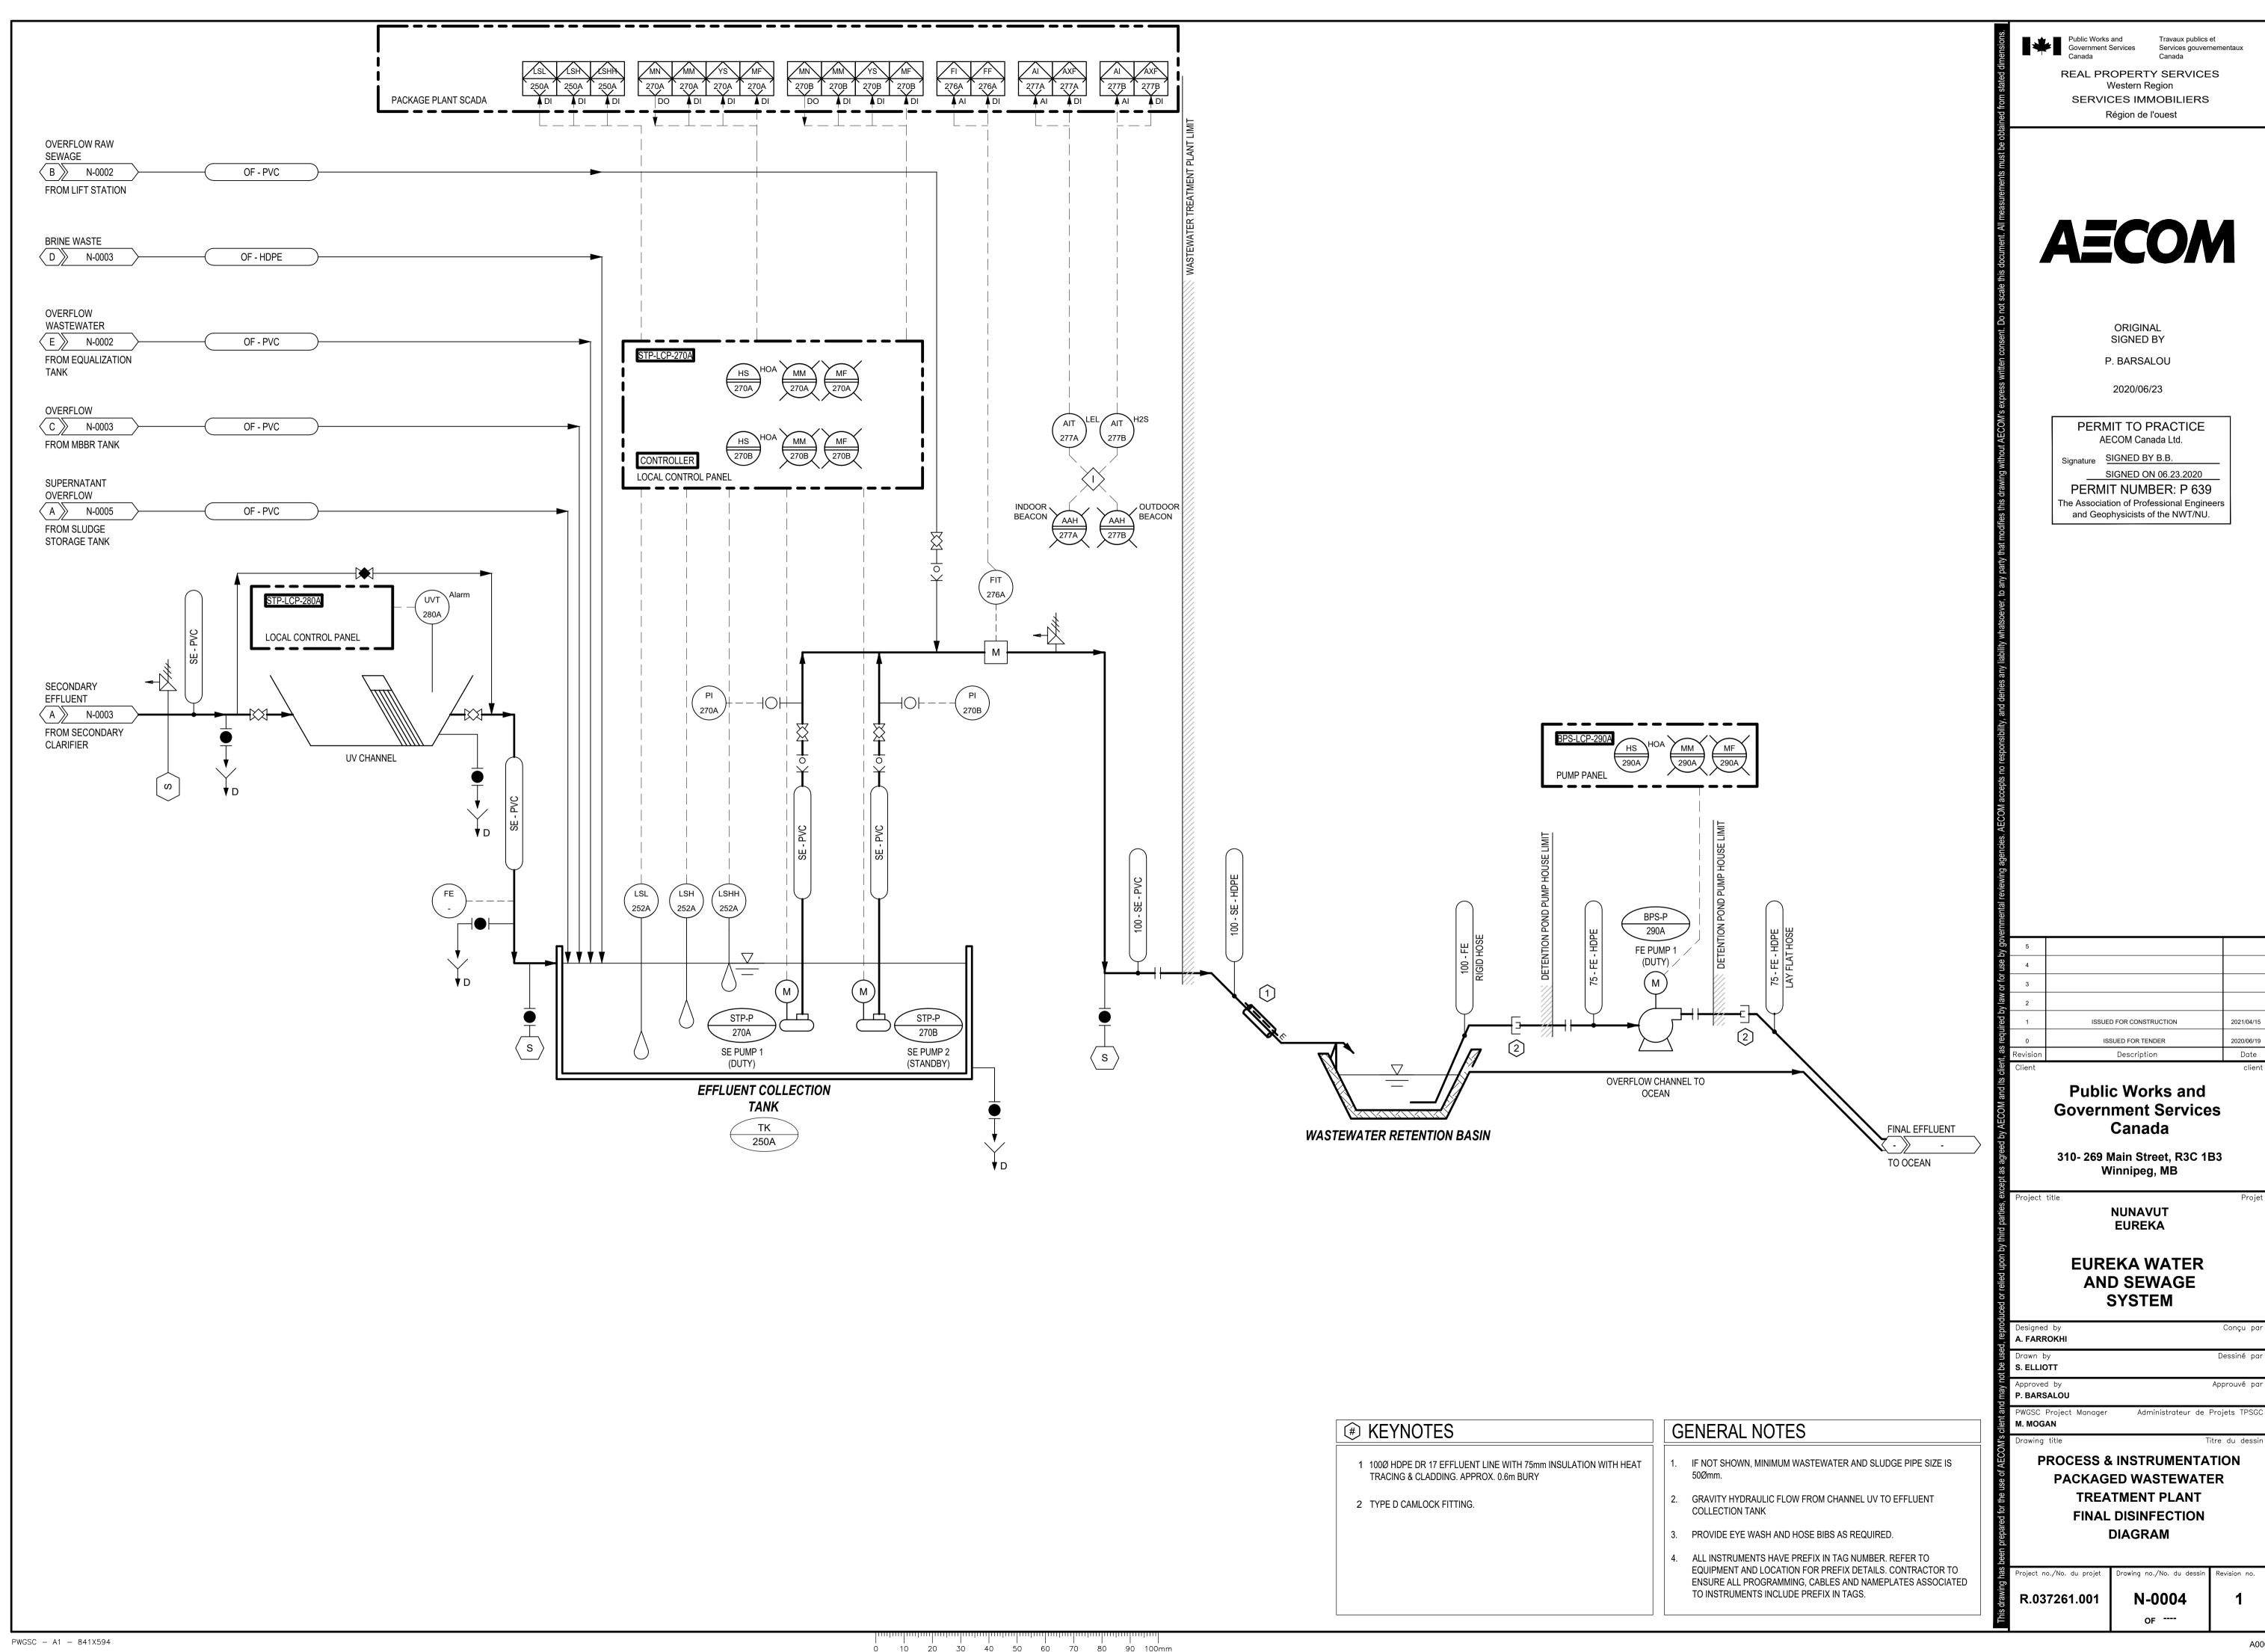


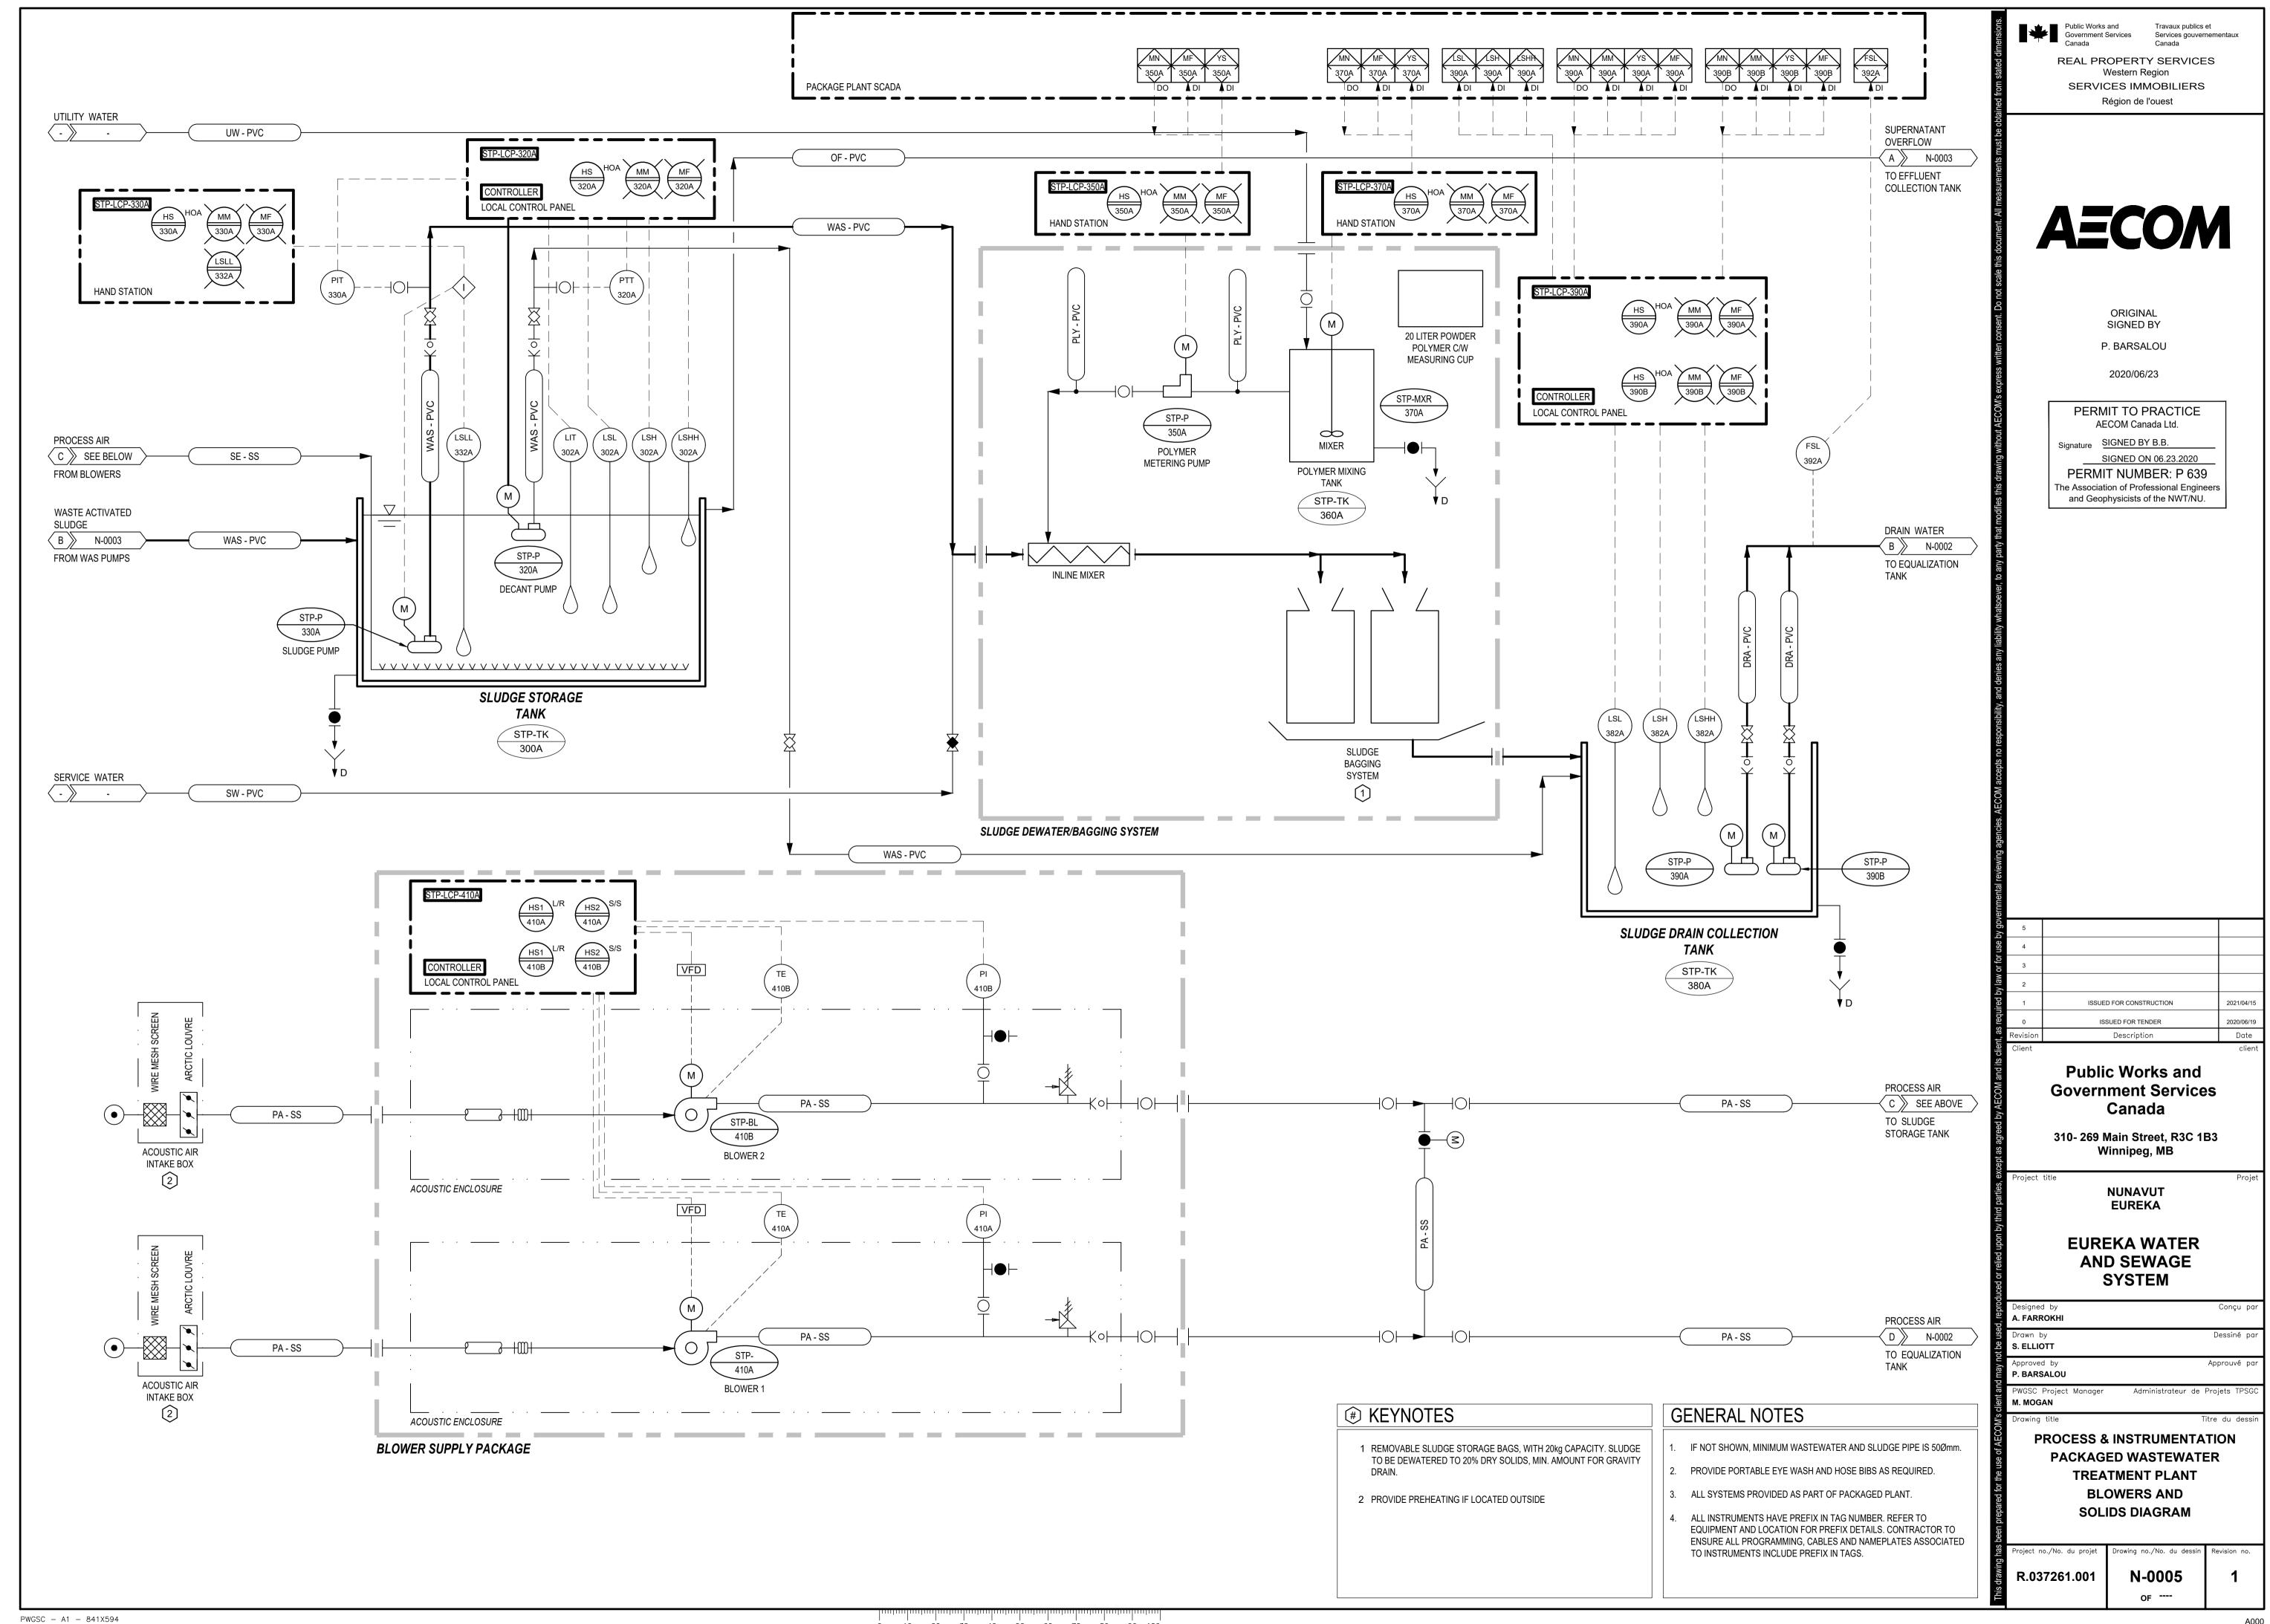

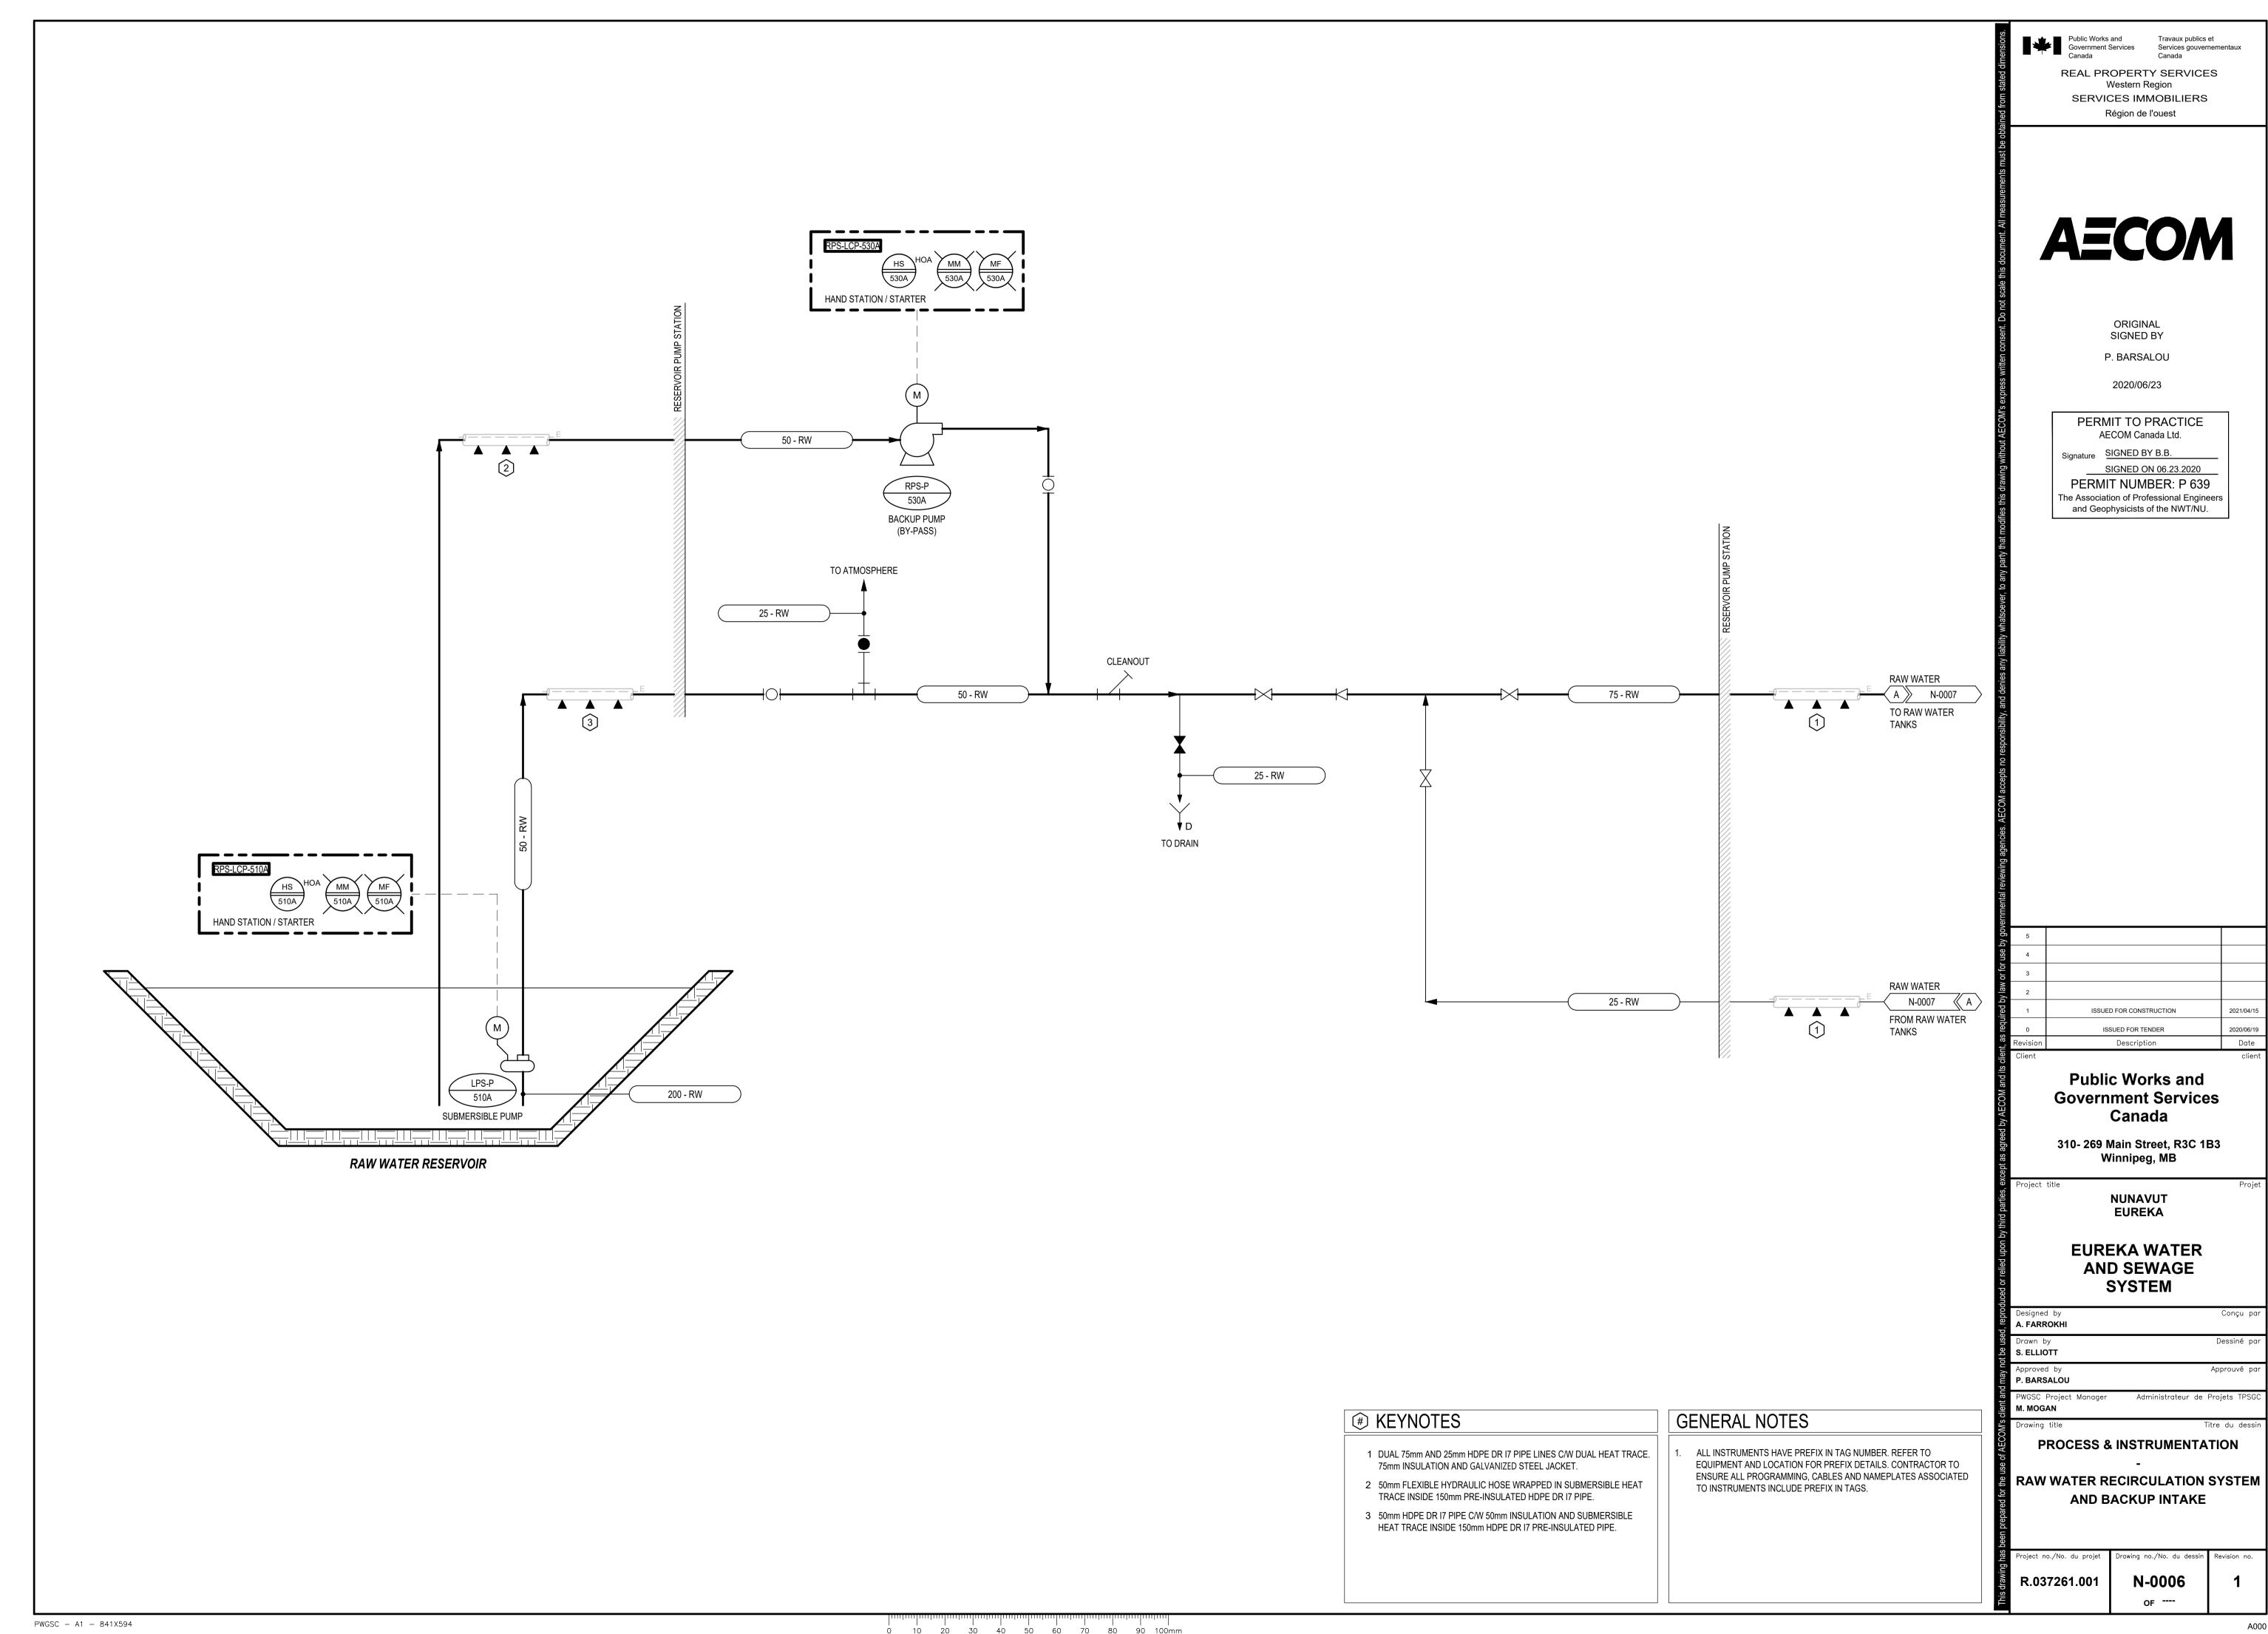


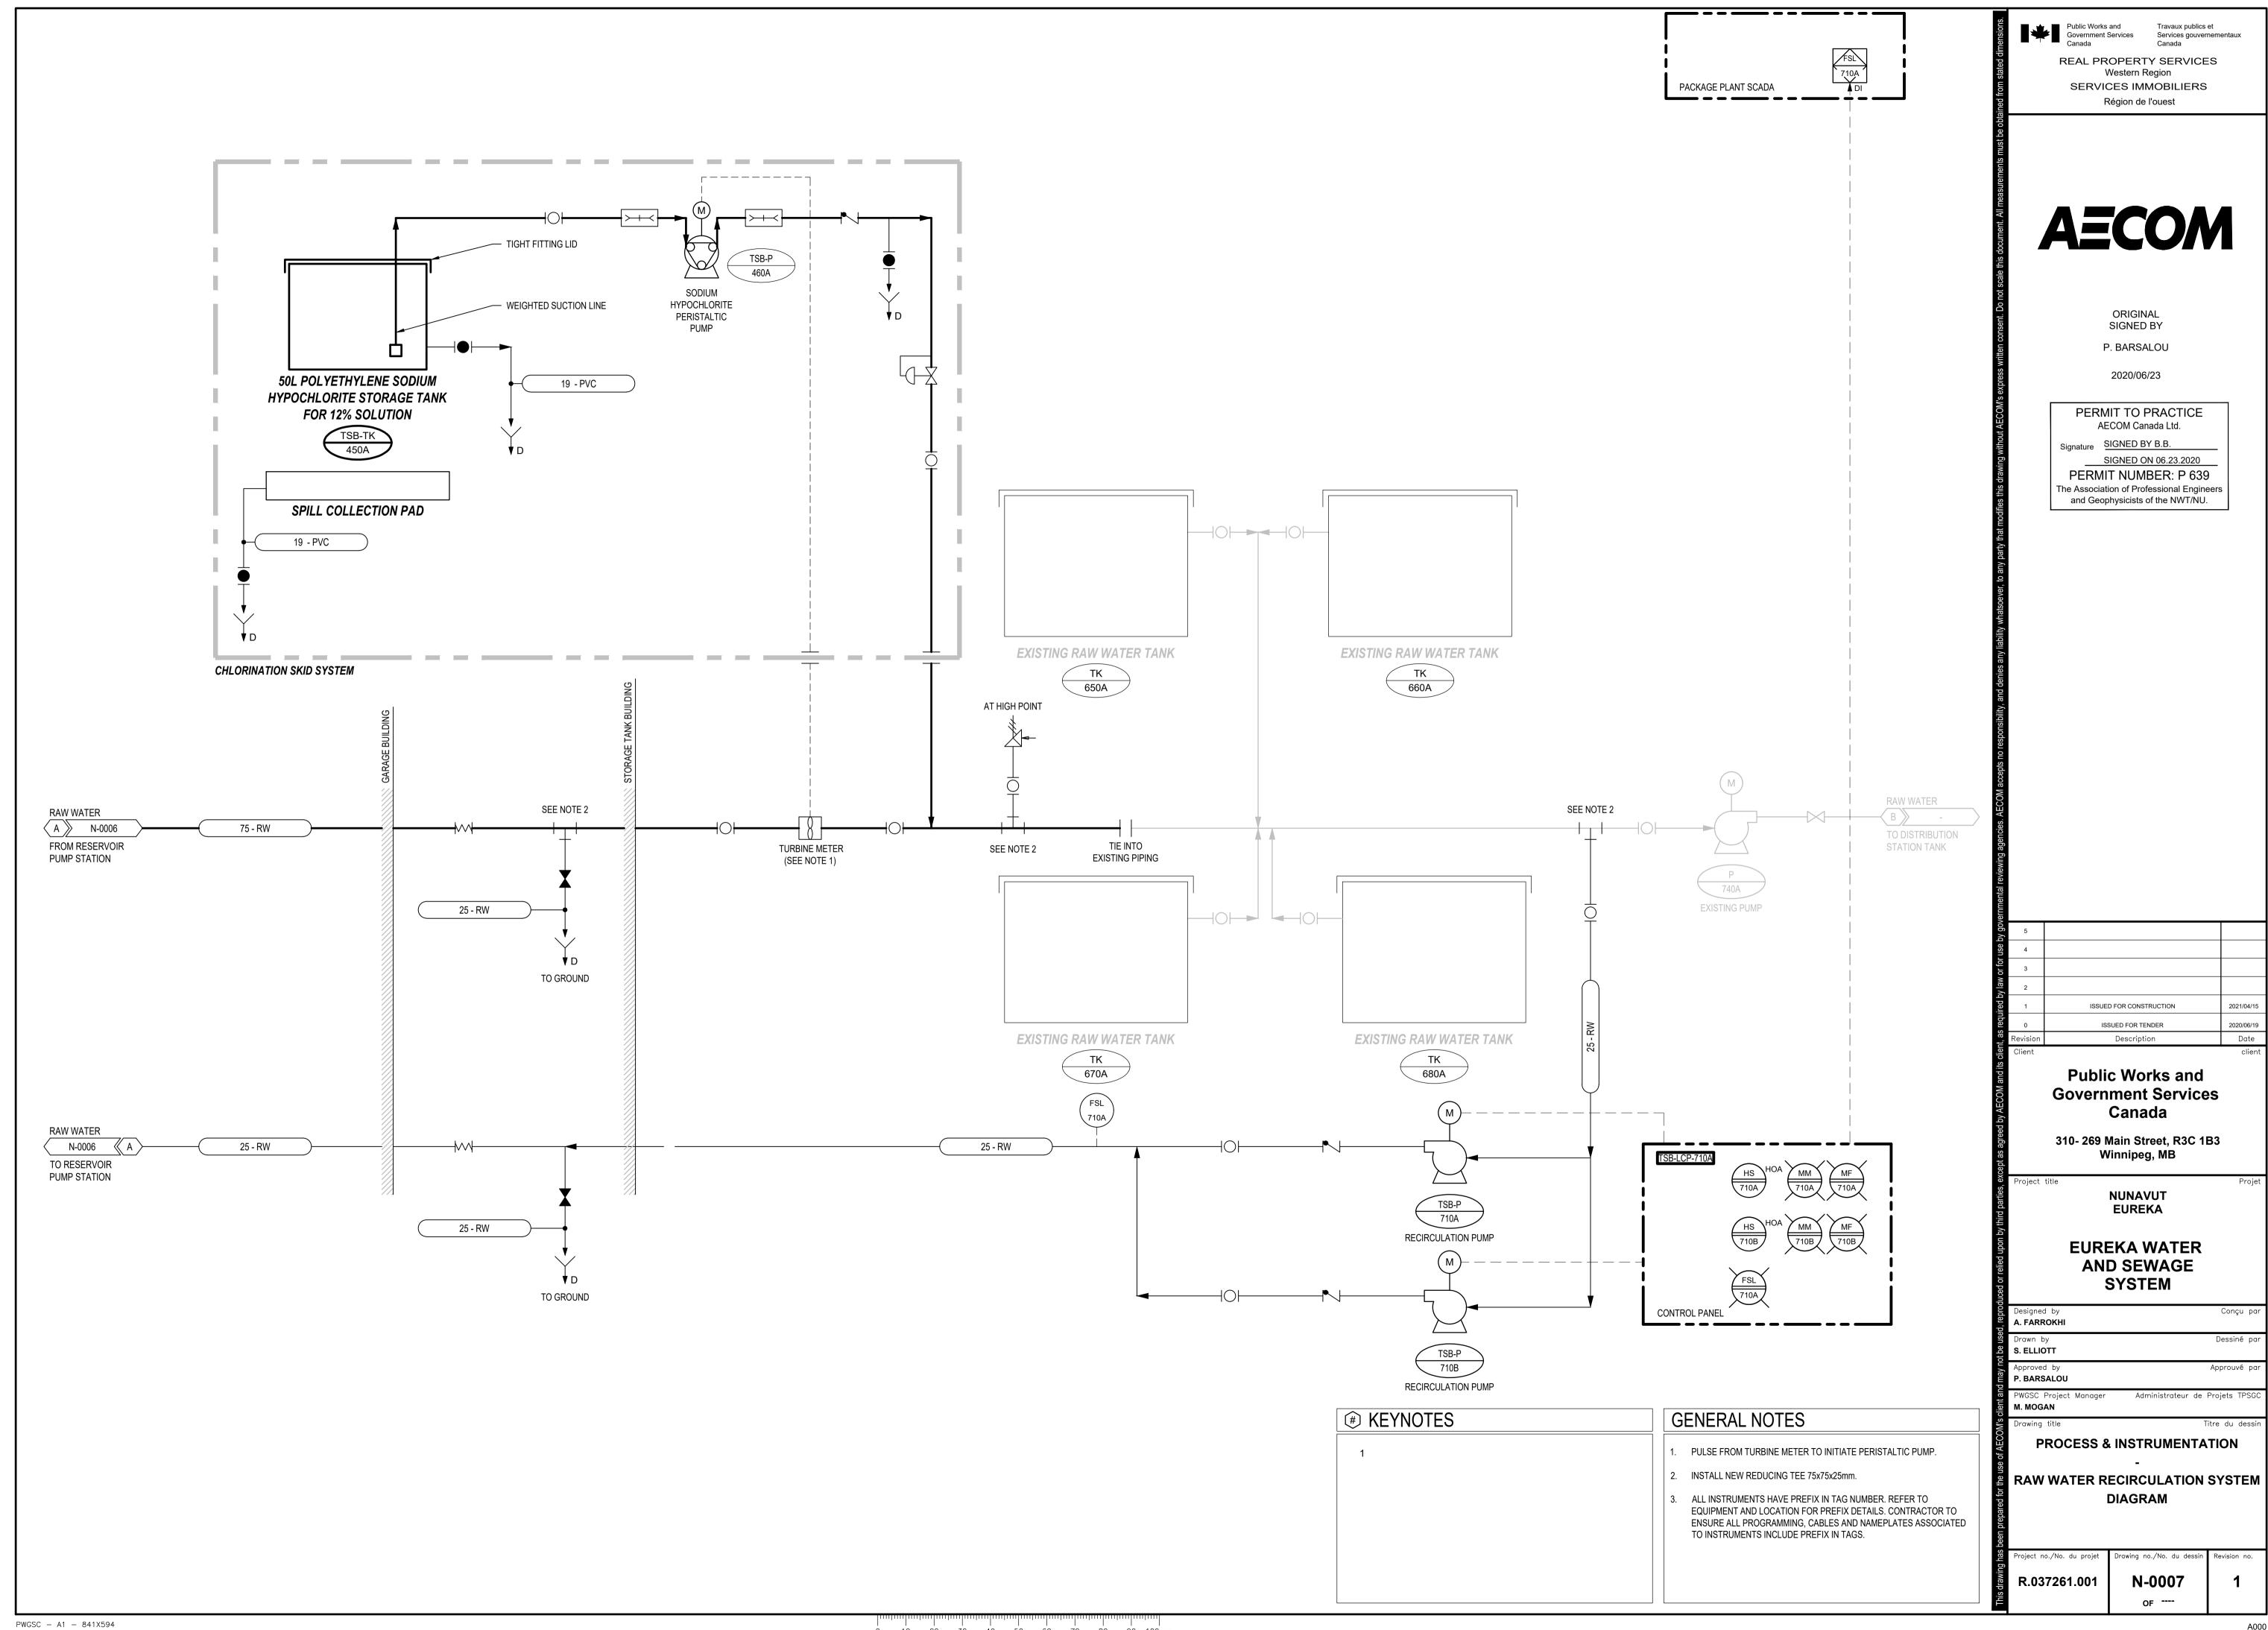


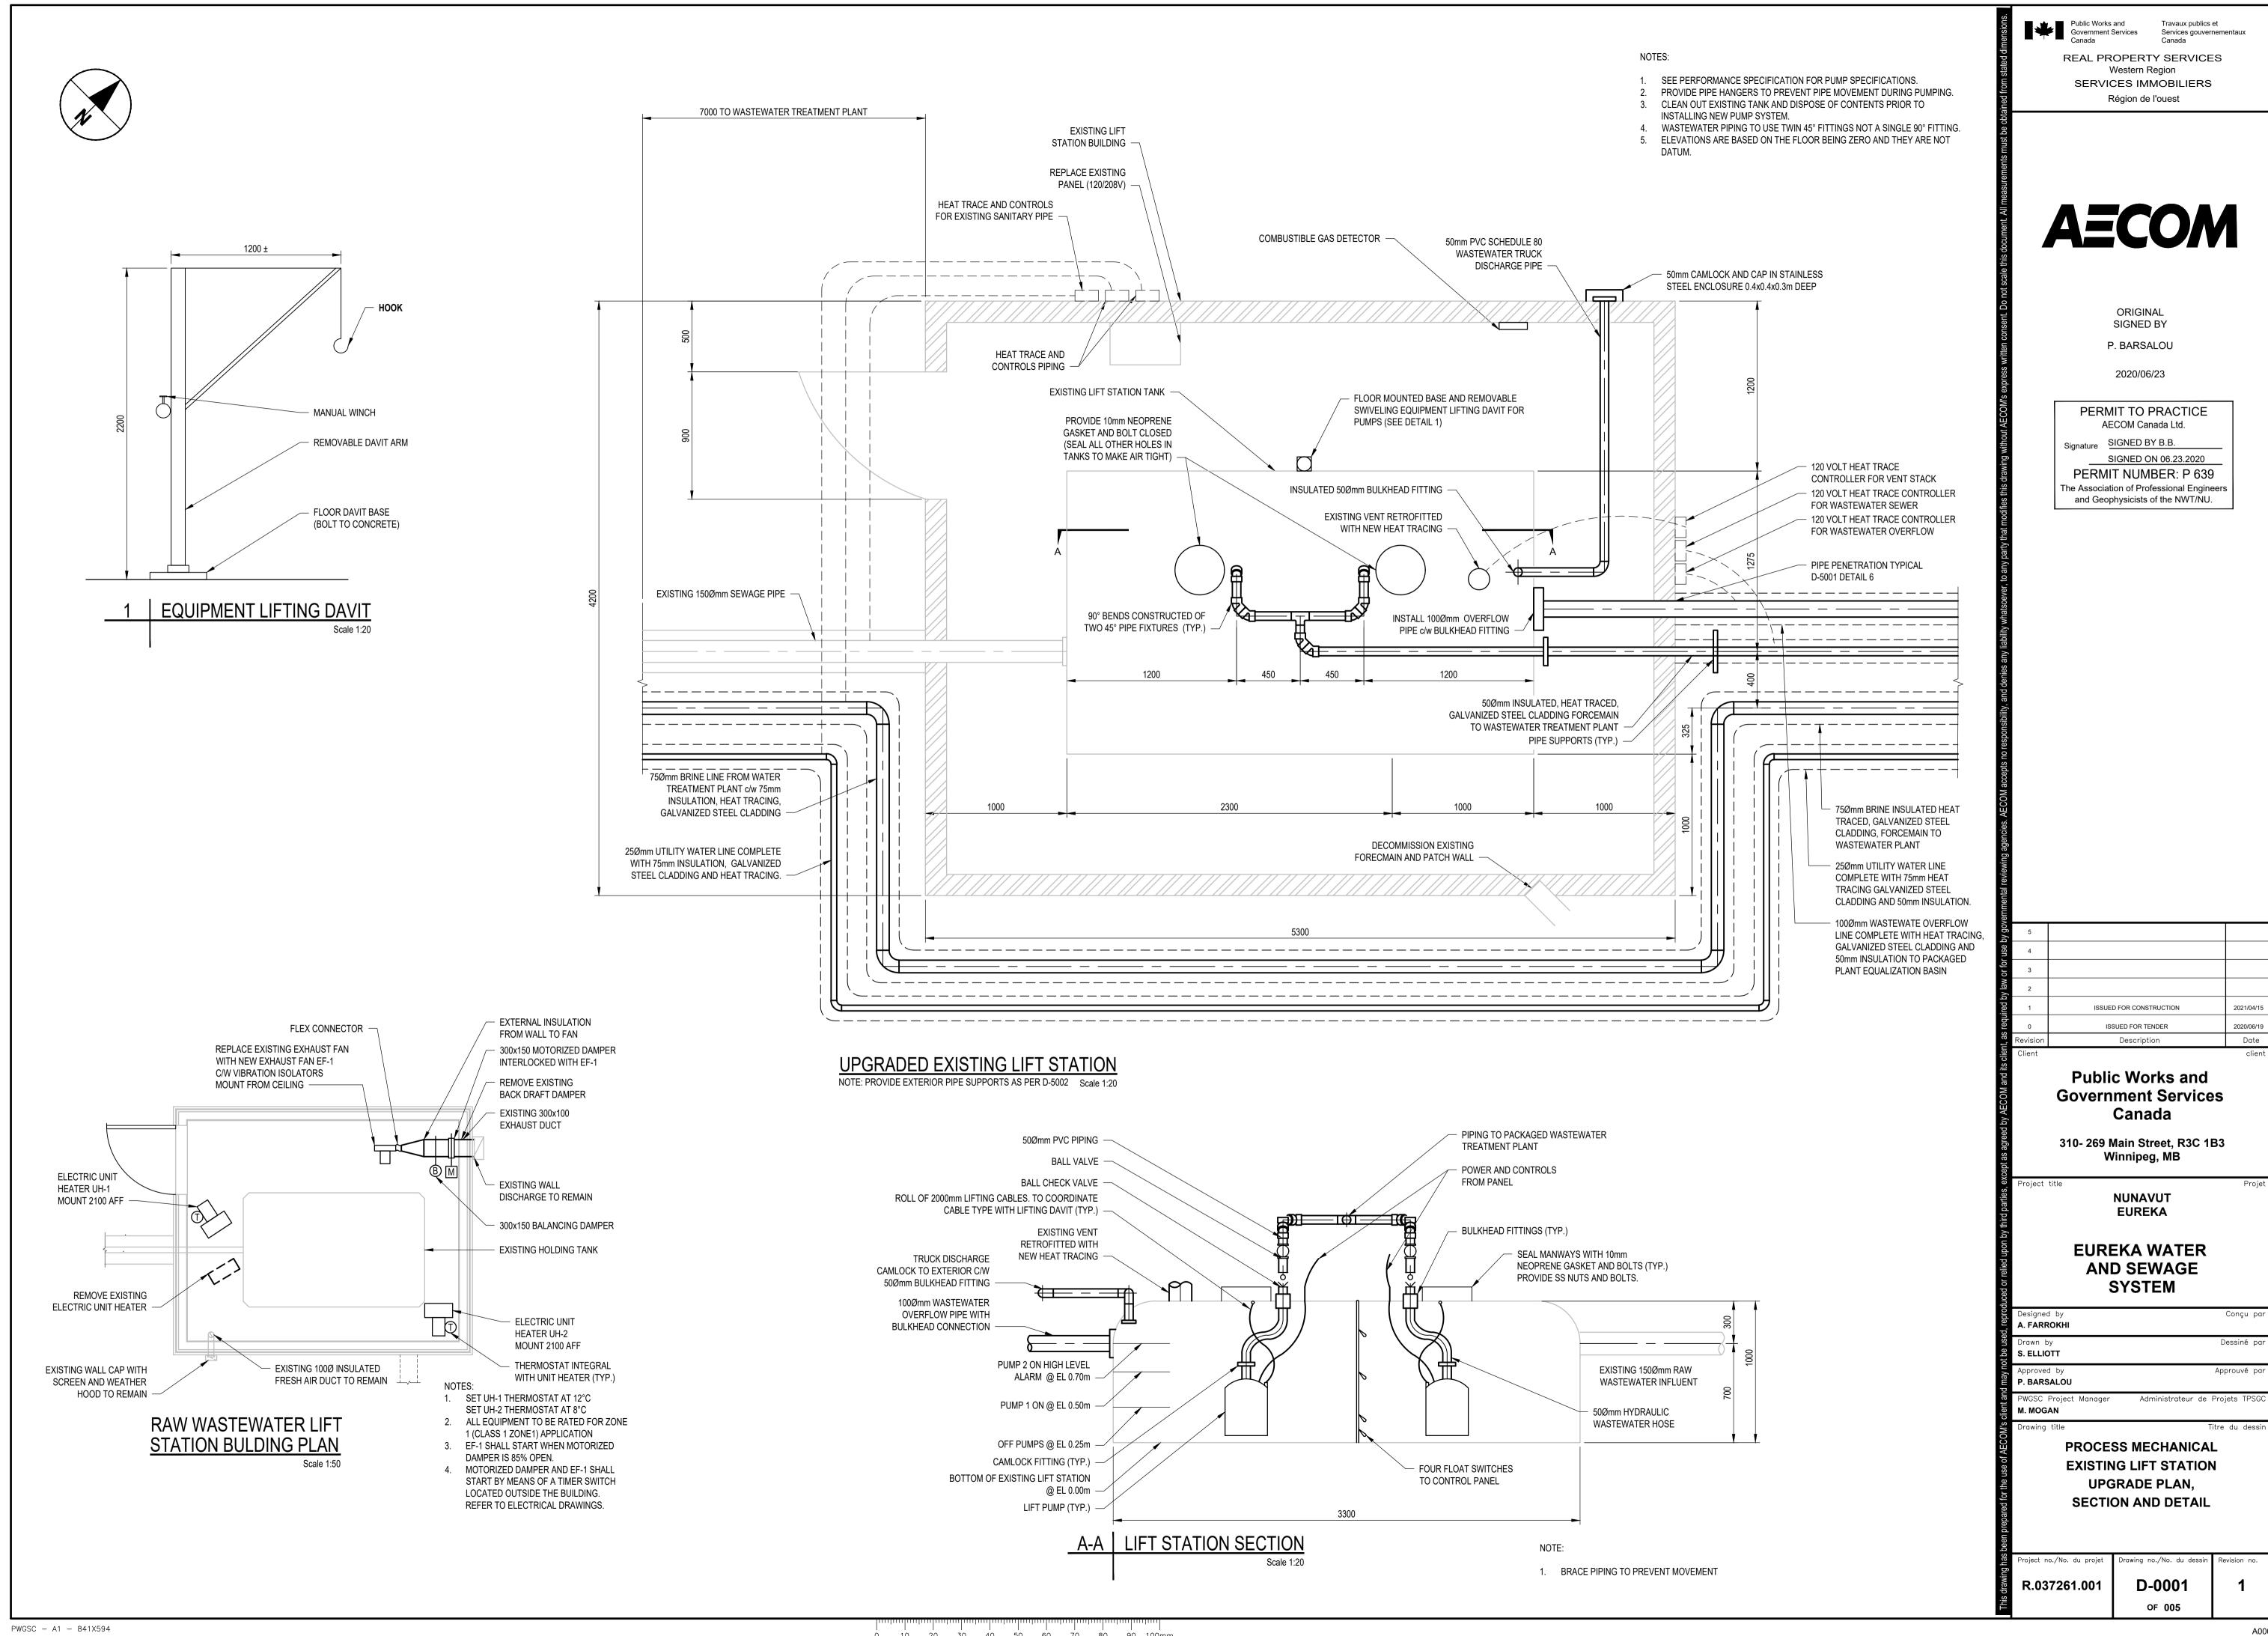


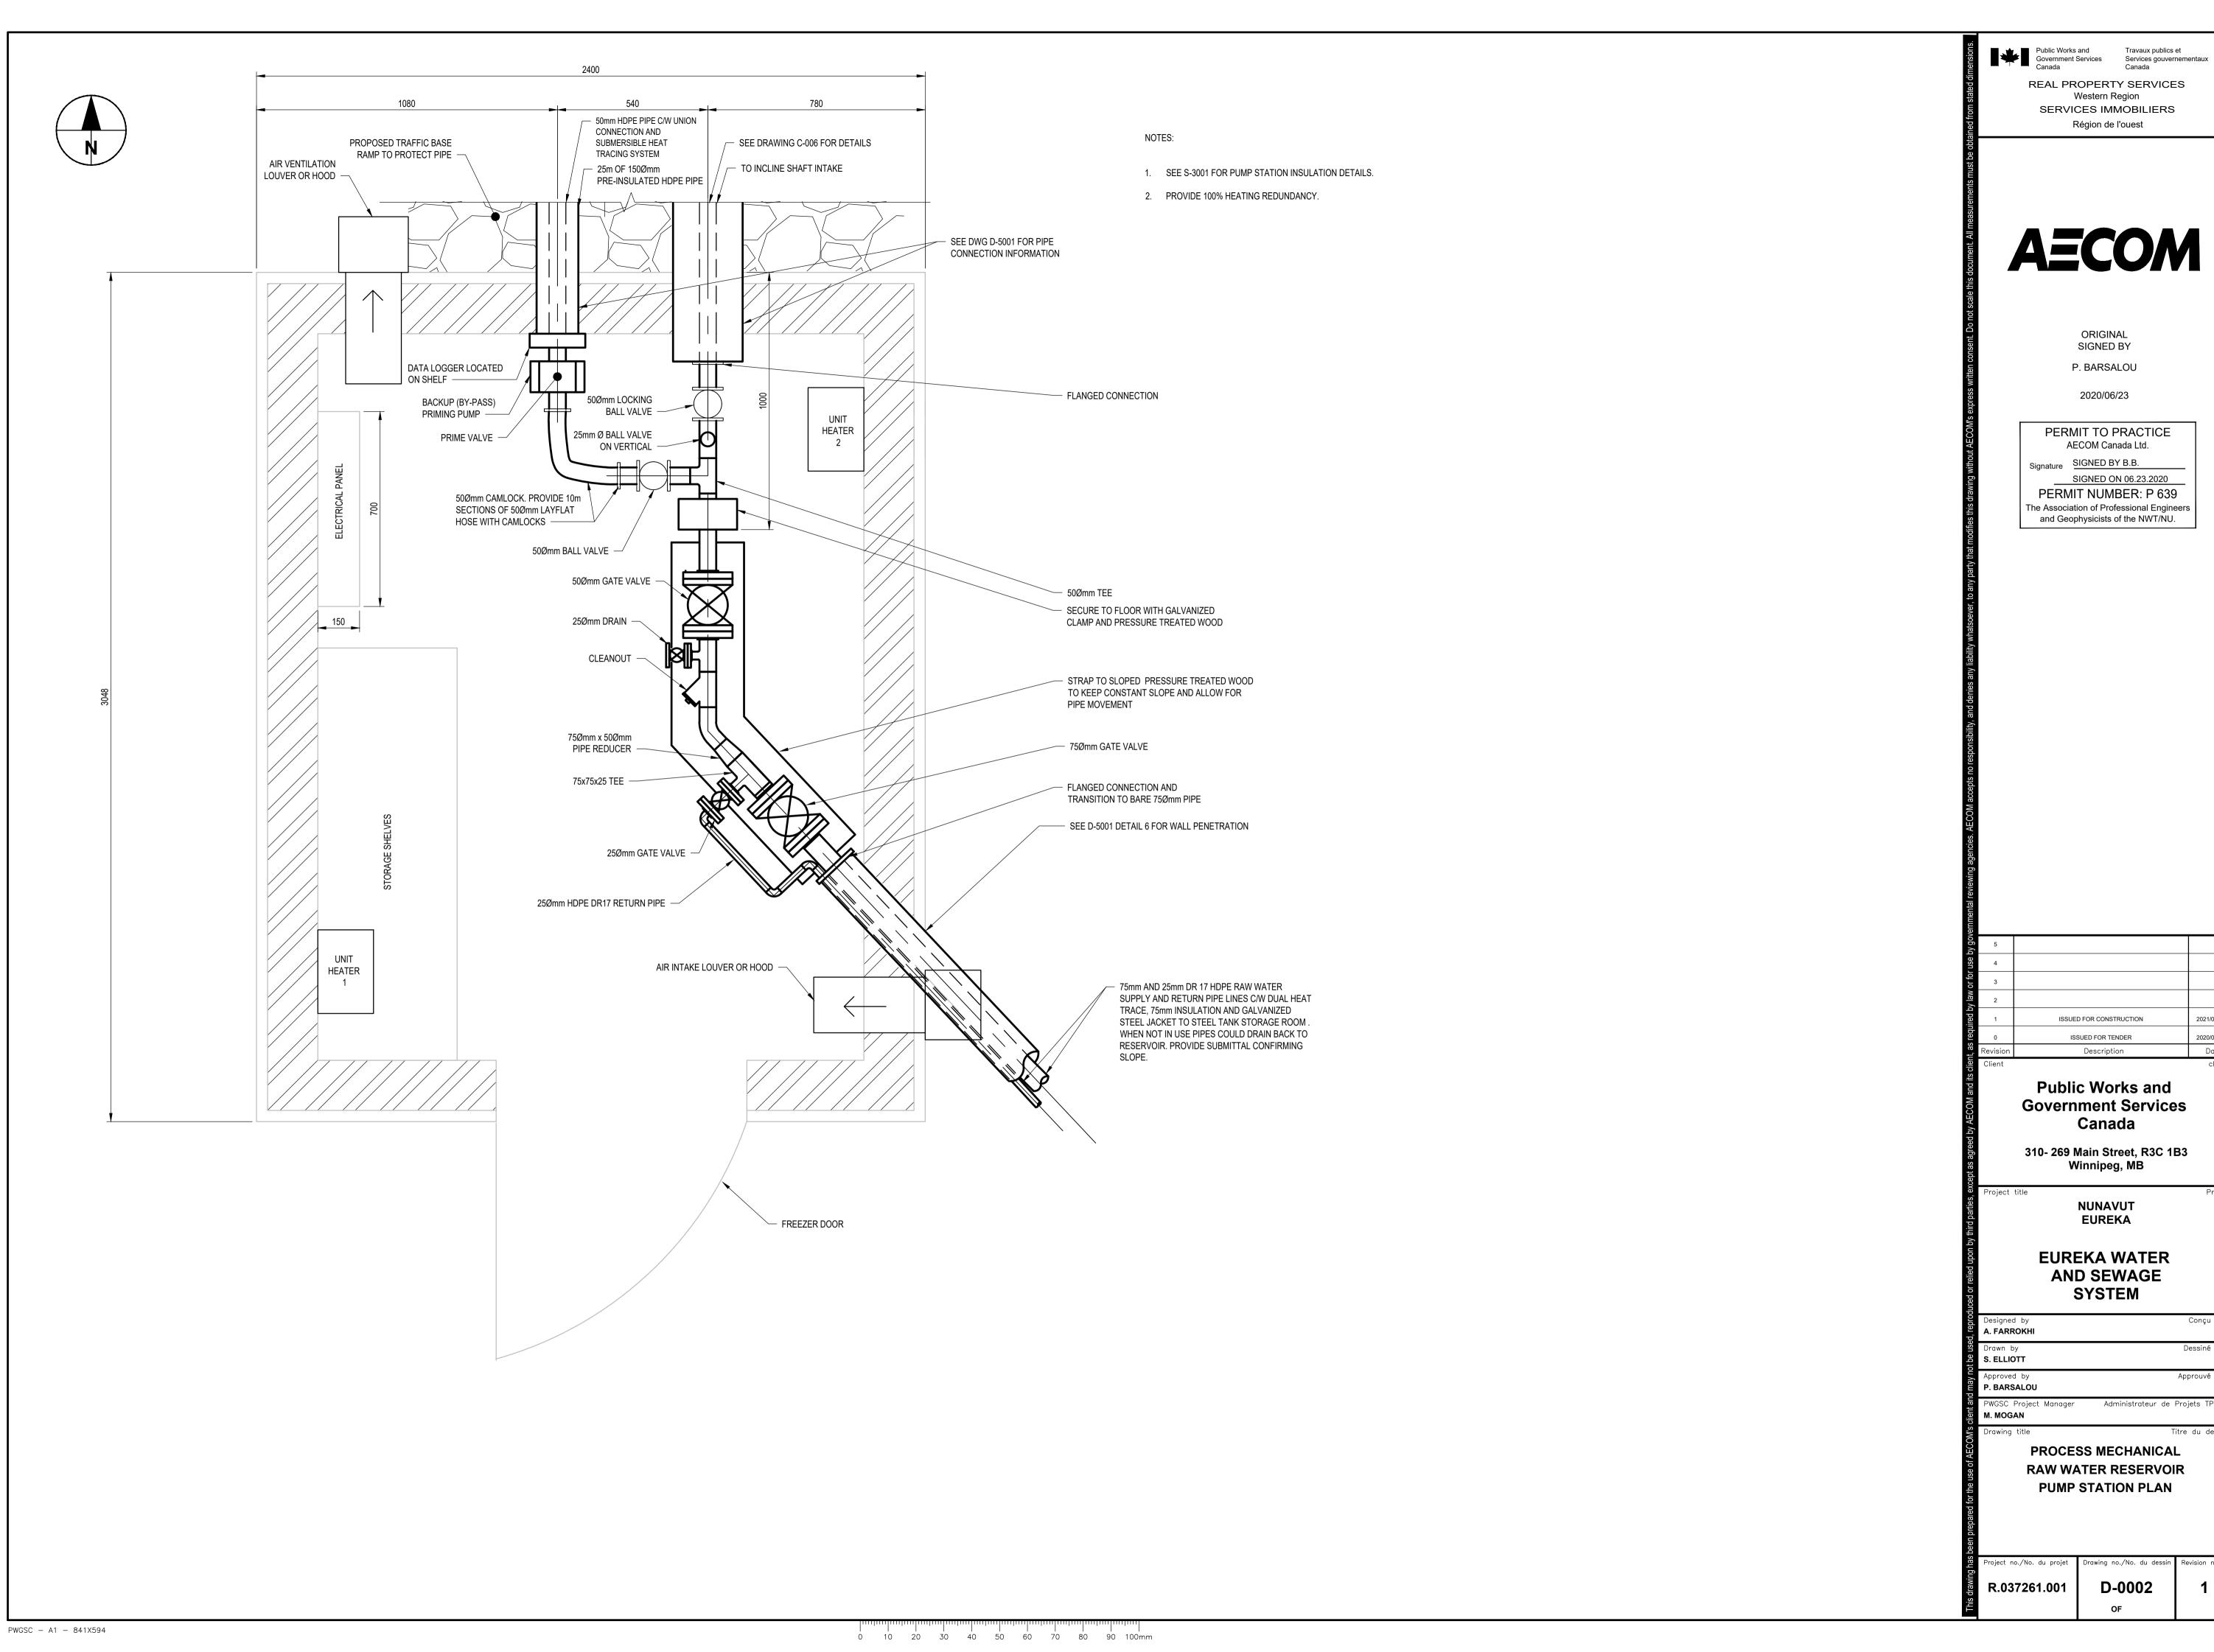


A000

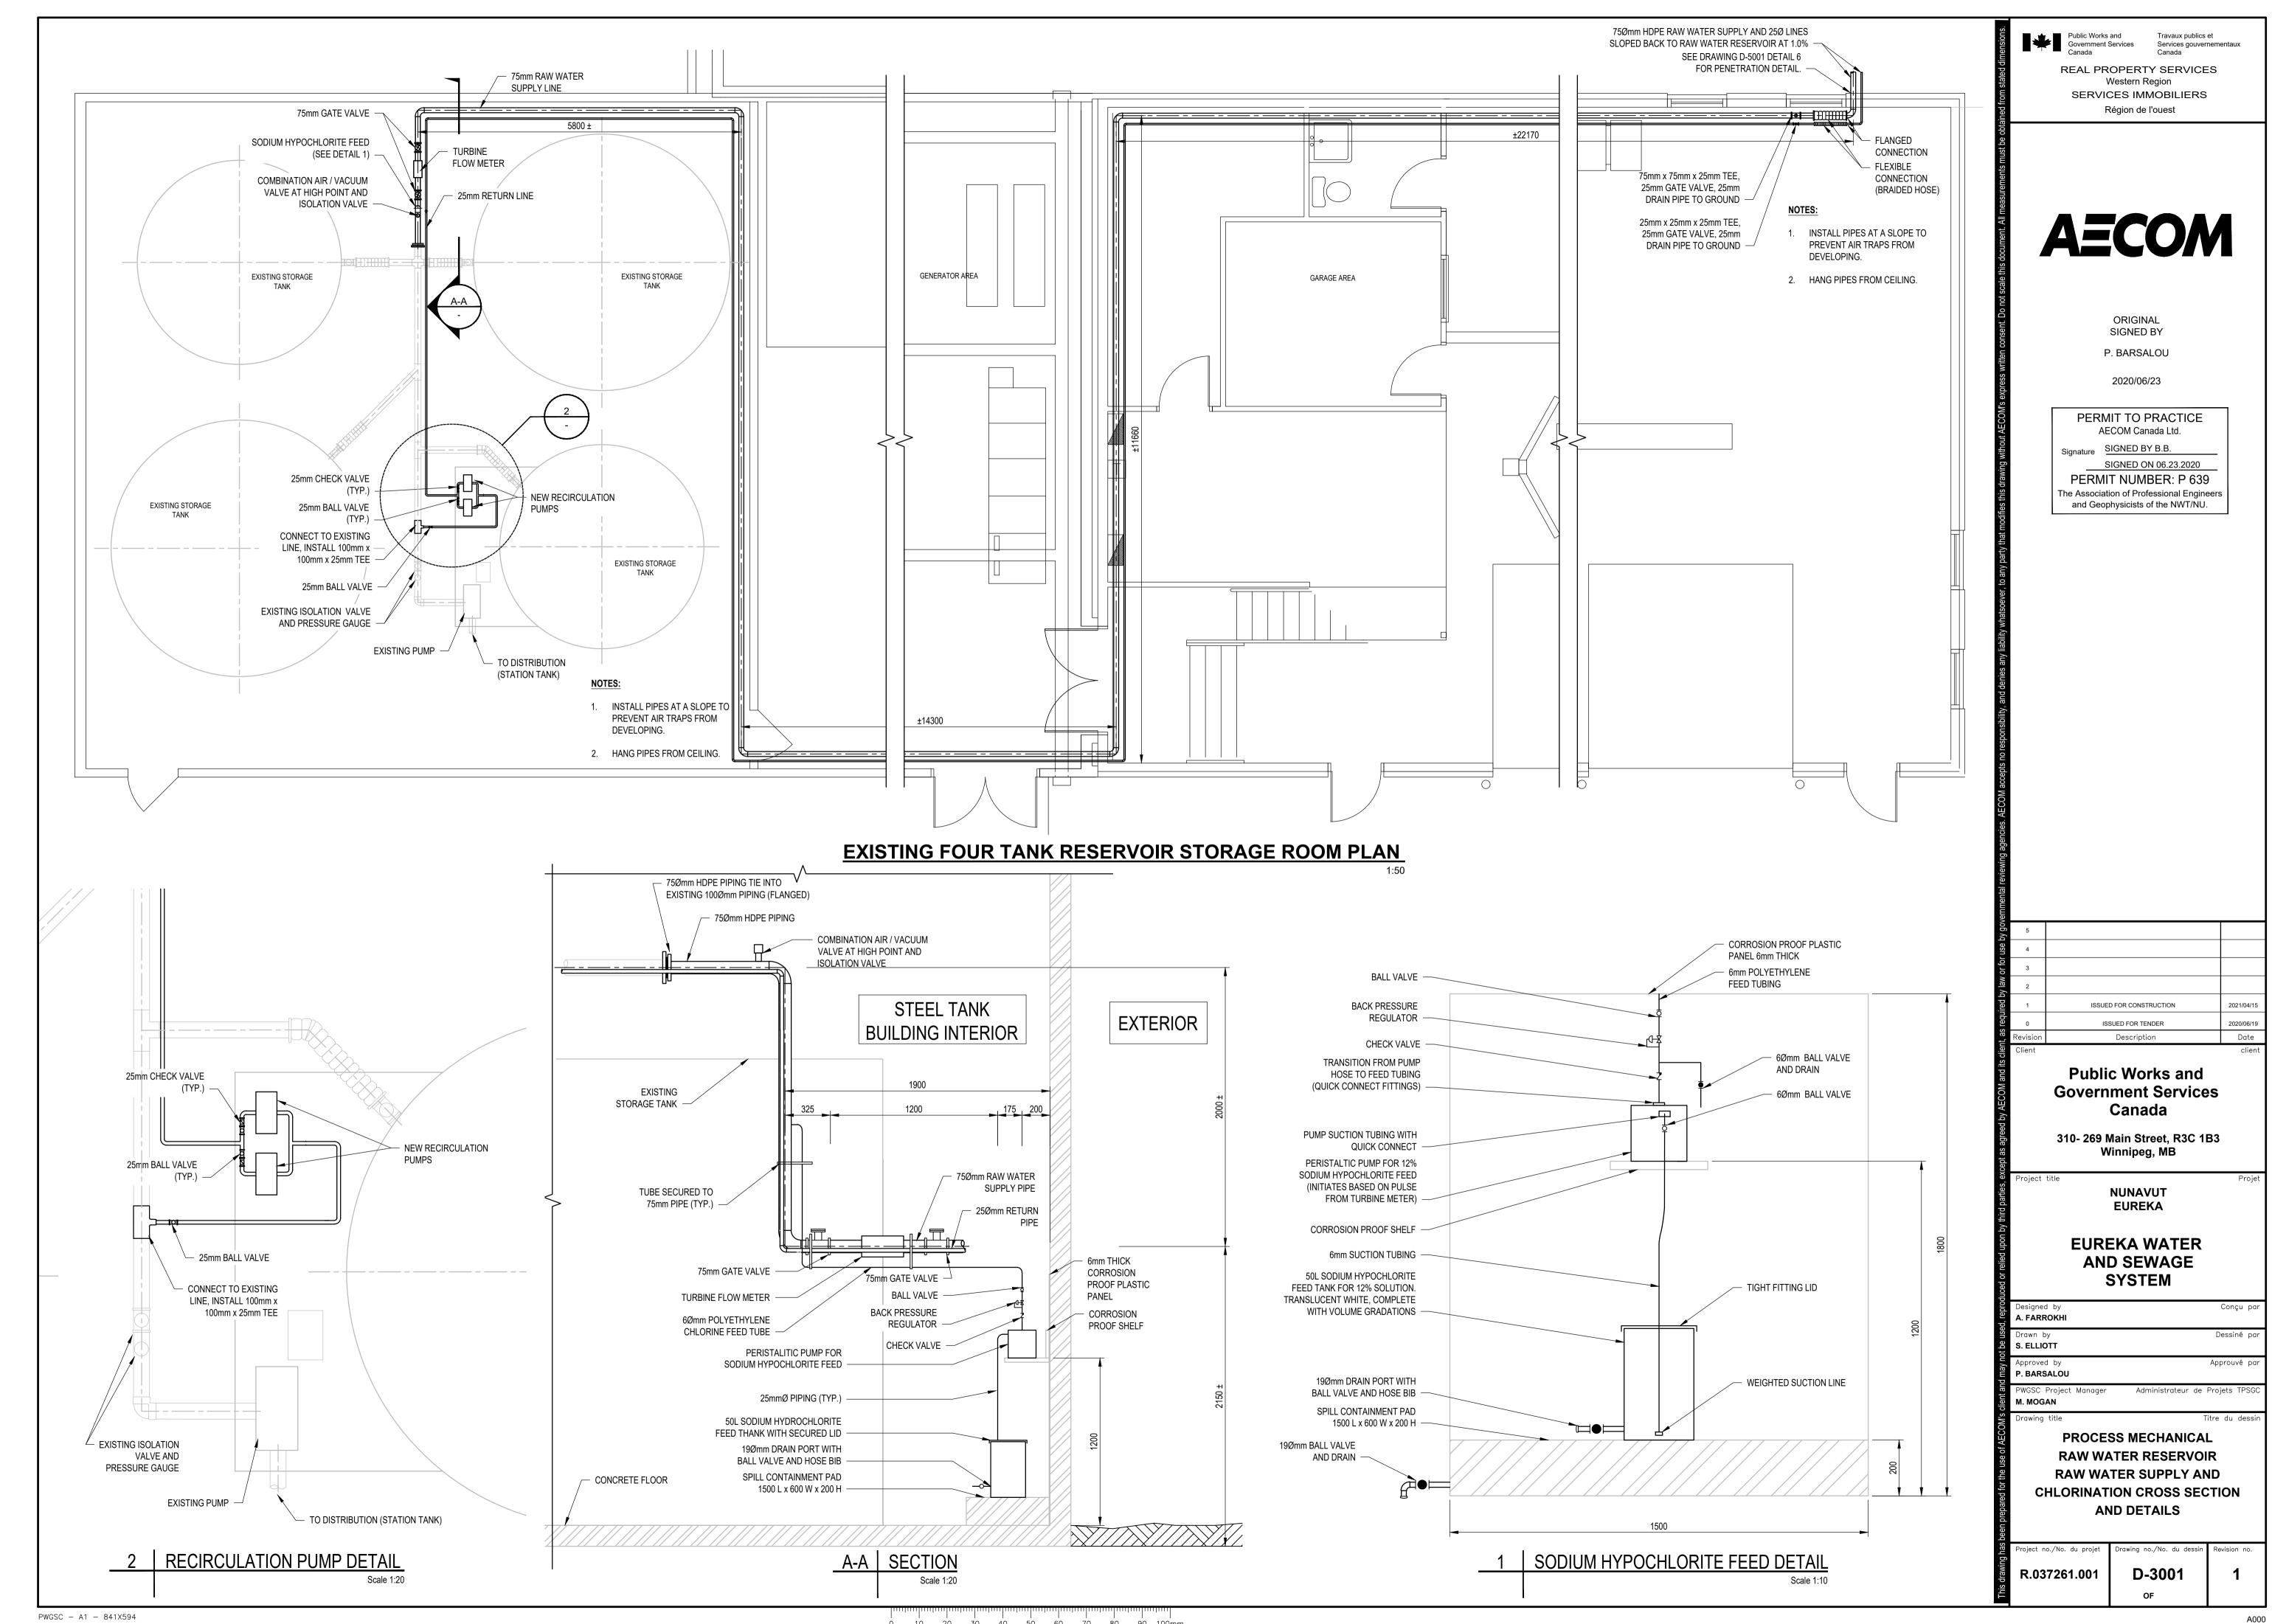

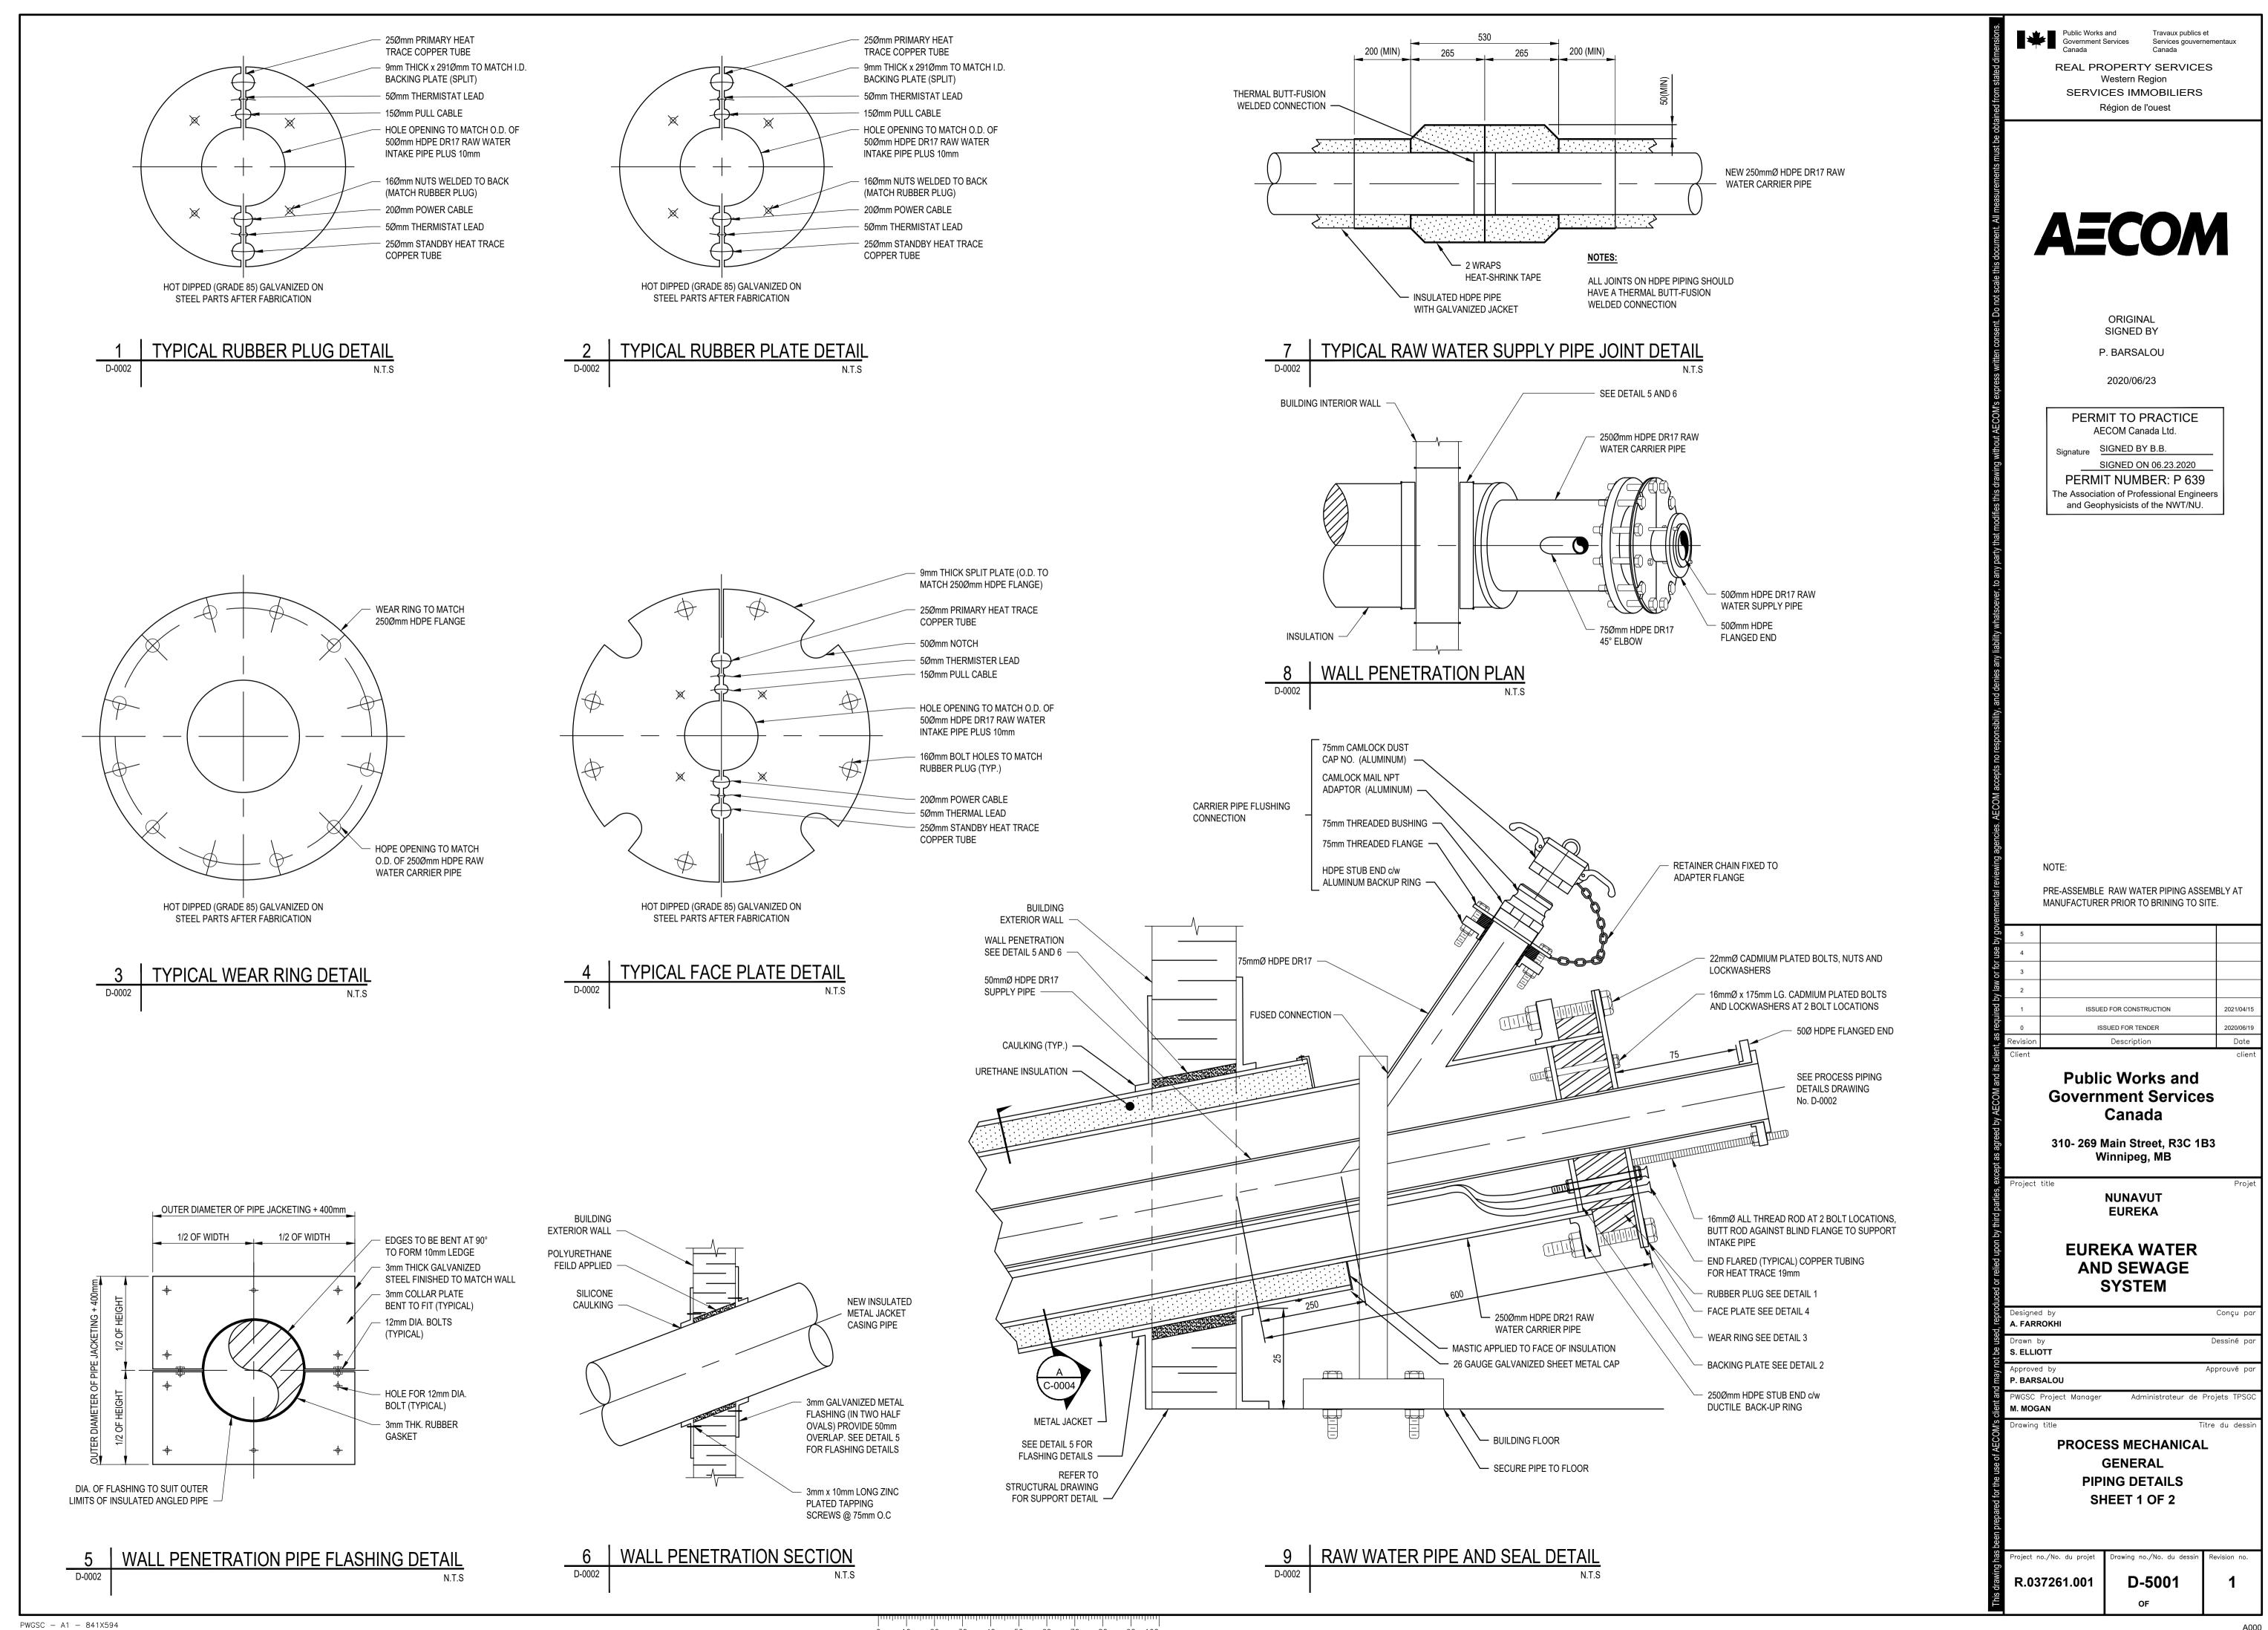

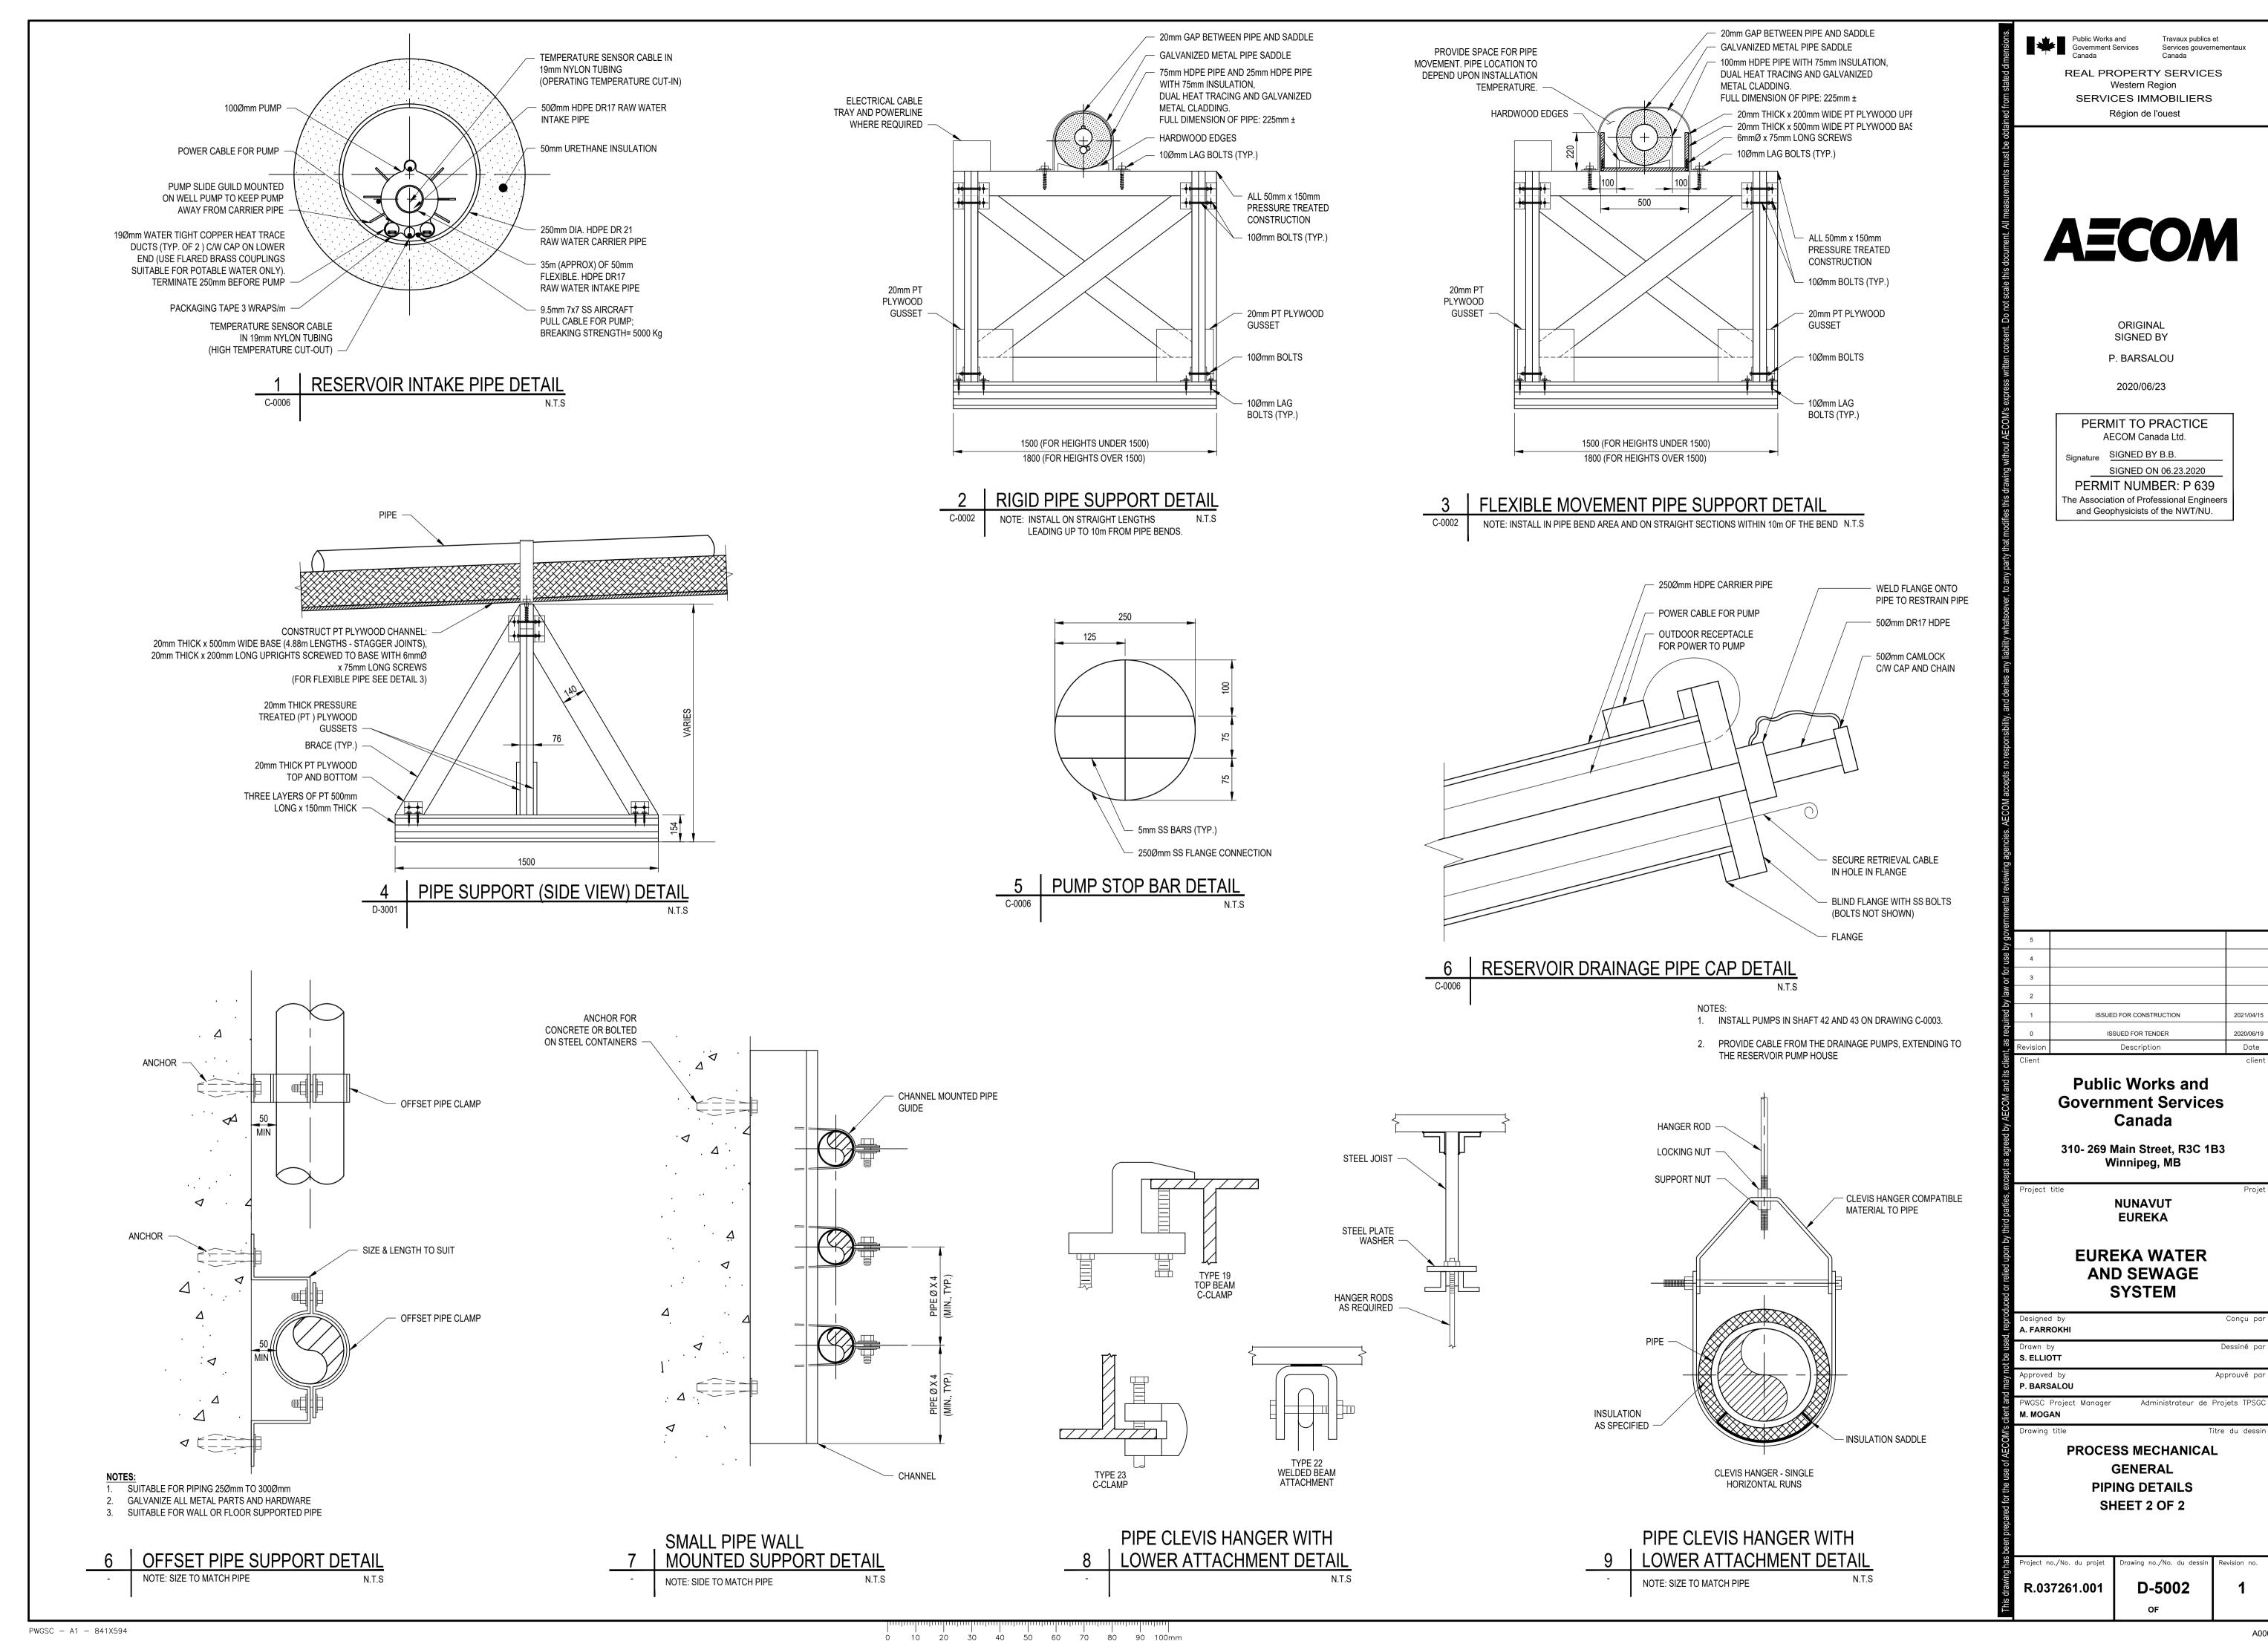

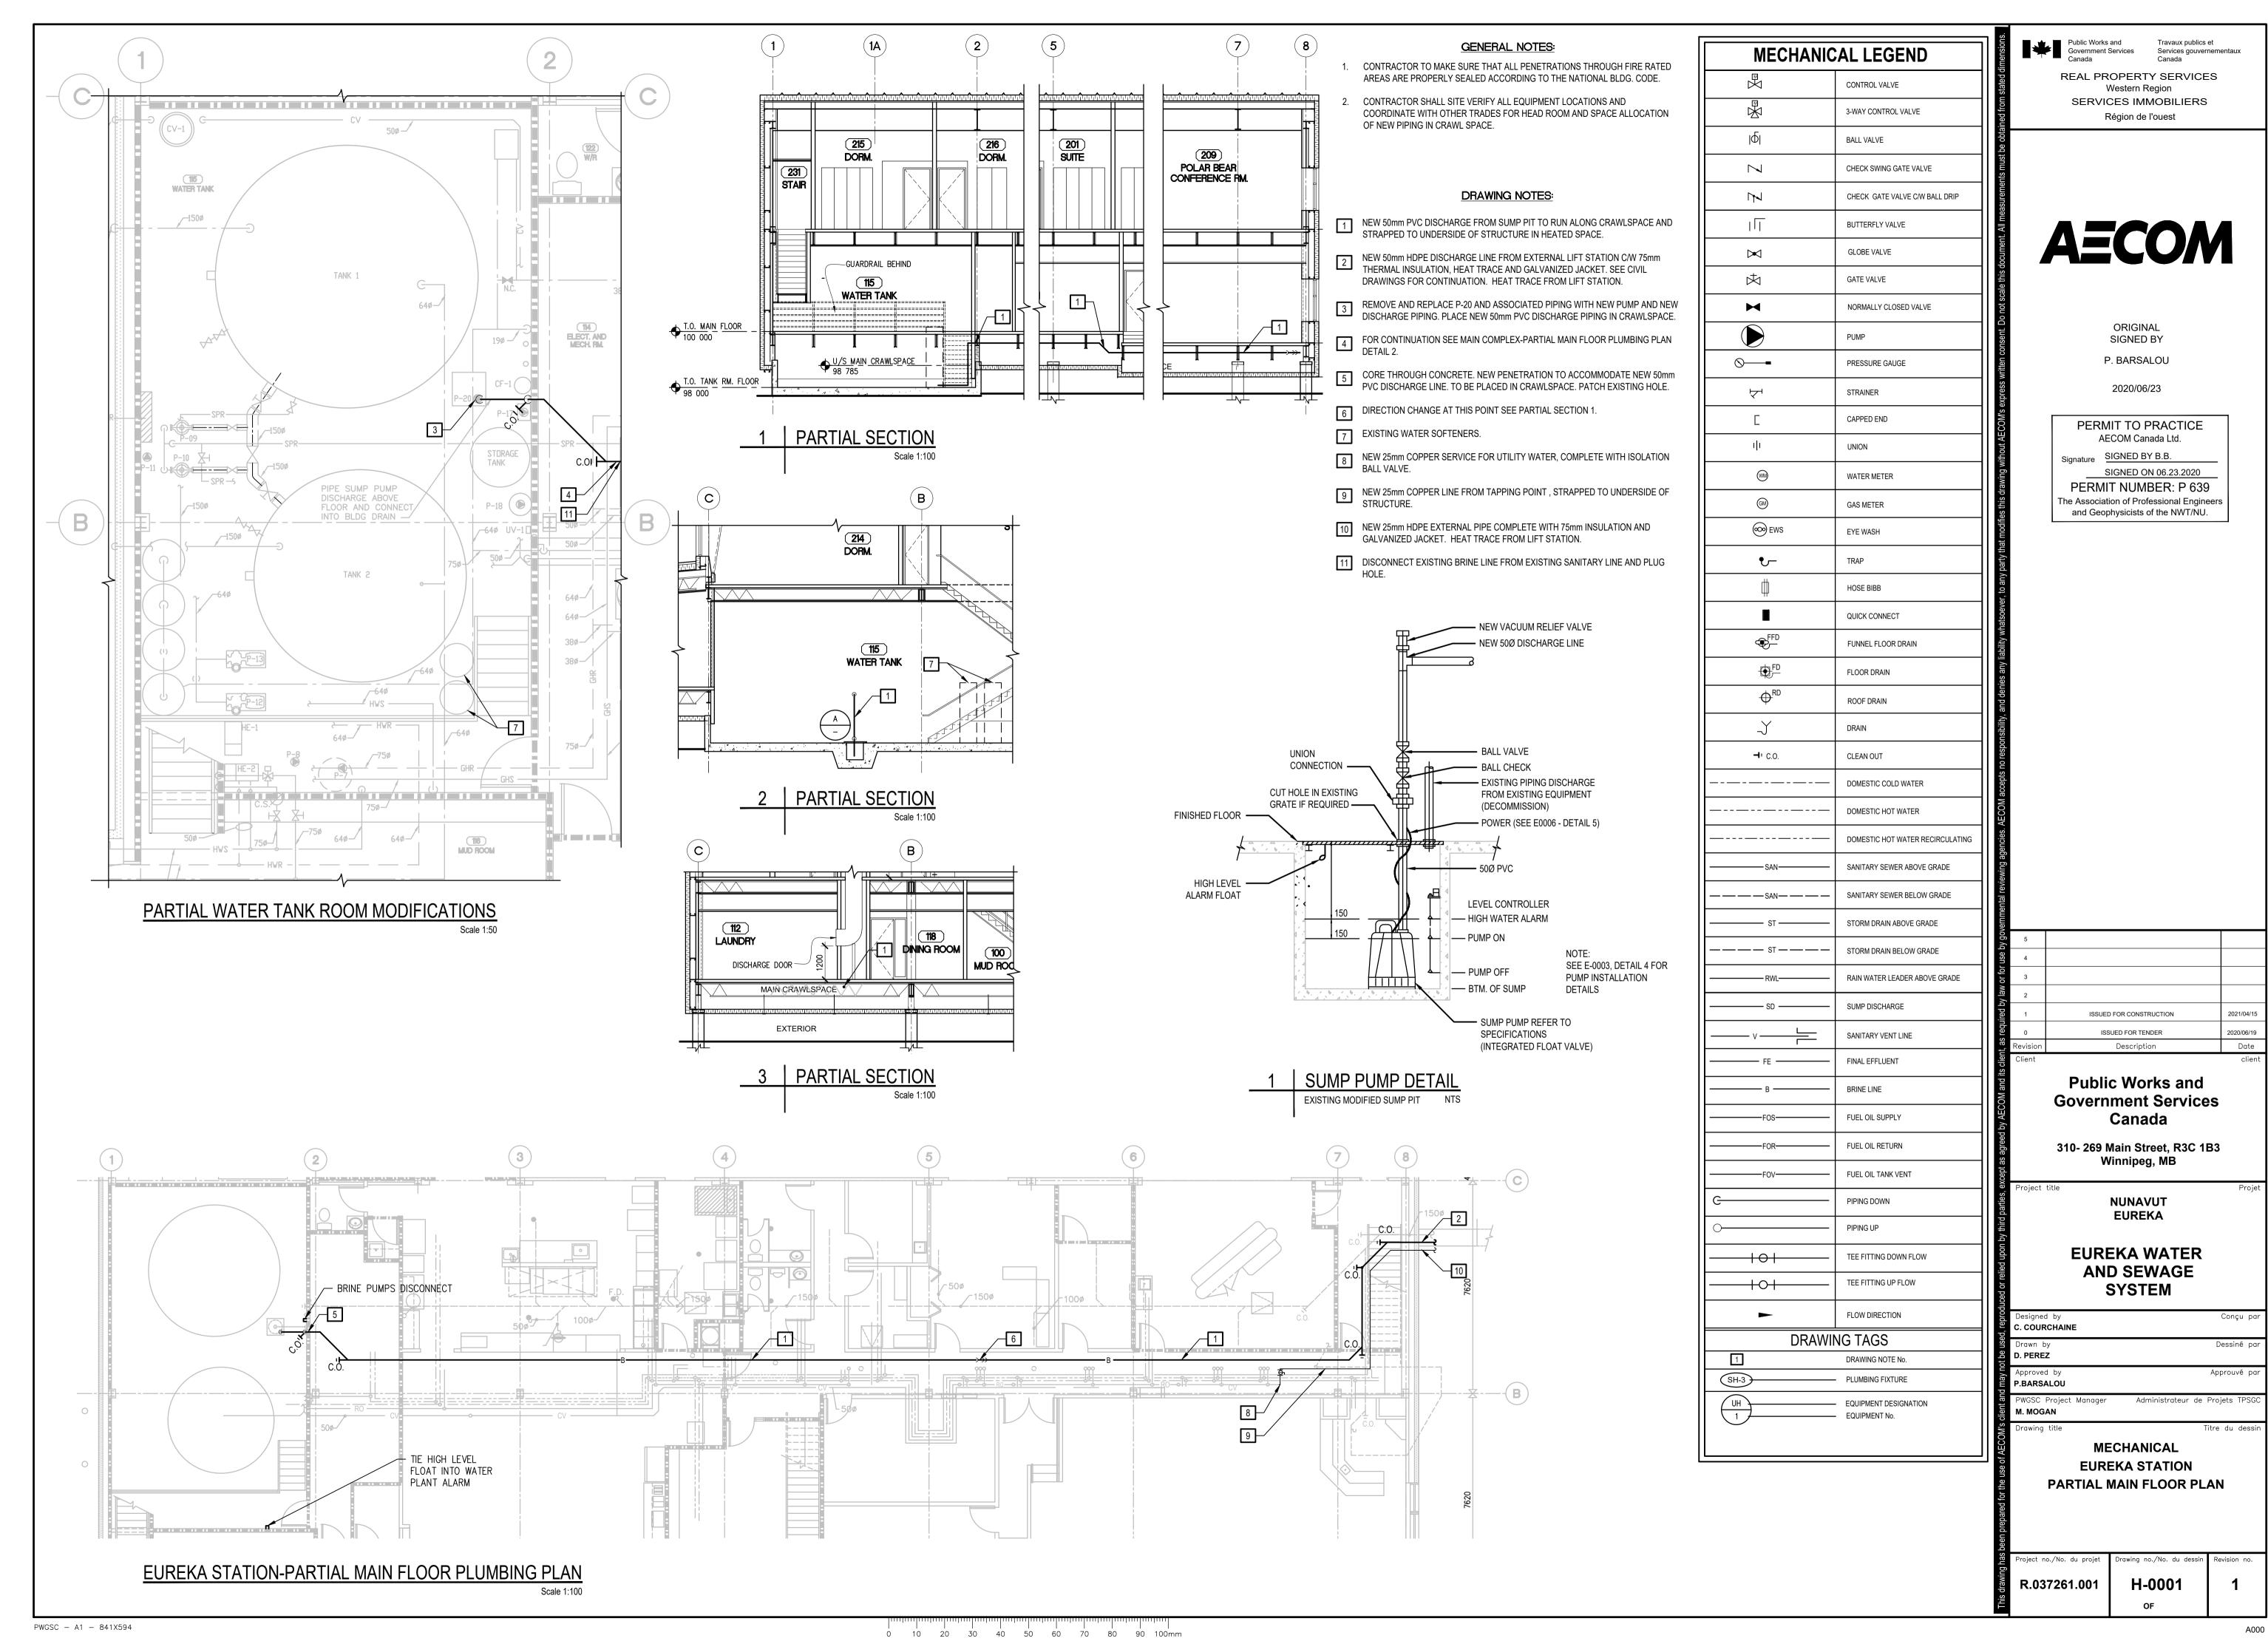

					LEGEND				
	PC	WER			LIGHTING		SECURI	TY	
☆ *	WITHDRAWABLE CONNECTION	DUPLEX RE	CEPTACLE		LED LUMINAIRE - SUSPENDED		CARD READER		
Ť	LOW VOLTAGE POWER CIRCUIT BREAKER (LVPCB)	ABOVE COL	INTER RECEPTACLE		LED LUMINAIRE - WALL MOUNTED	DPS	DOOR POSITION SWITCH		
O 800AF O LSIG 600AT	MODIFIERS: 800AF - FRAME LSIG - TRIP FUNCTIONS 600AT - TRIP FUNCTIONS: 100% - 100% RATED	DRYER REC	EPTACLE		LED WALL PACK	MD	MOTION DETECTOR		
	LOW VOLTAGE THERMAL/MAGNETIC BREAKER		ROUND RECEPTACLE	모	EXTERIOR WALL MOUNTED	•	PUSHBUTTON FOR DOOR BUZZER		
(Ŝ TM	MODIFIERS: 3P - # OF POLES 120A - TRIP	SPLIT-FEED	RECEPTACLE		WALL MOUNTED EXIT LIGHT APPROVIO AC DECUMPED		DOOR BUZZER		
0 3P 120A	FUNCTIONS: 100% - 100% RATED MCP - MOTOR PROTECTOR	GROUND FA	AULT (GFCI) RECEPTACLE		WALL MOUNTED EXIT LIGHT - ARROWS AS REQUIRED	KP (c)	KEYPAD		
(TA MCP	MOTOR CIRCUIT PROTECTOR, MAGNETIC ONLY MODIFIERS: 7A CONTINUOUS RATING. 3 POLE UNLESS	240V RECER	PTACLE		WALL MOUNTED EXIT LIGHT WITH REMOTE HEADS	\P	PAN/TILT/ZOOM (PTZ) CAMERA		
[₉]	OTHERWISE NOTED.	120V DIREC	T CONNECTION / POWER ROUGH-IN		DUAL FACEPLATE EXIT SIGN - SUSPENDED				
K	DISCONNECT SWITCH (SINGLE LINE)	600V DIREC	T CONNECTION / POWER ROUGH-IN		BATTERY PACK C/W HEADS AS INDICATED				
	KIRK KEY INTERLOCK	SPECIAL 600	0V RECEPTACLE		WALL MOUNTED EMERGENCY REMOTE HEADS		CABLE	S	
~	THERMAL OVERLOAD DEVICE	DISCONNEC	CT SWITCH (FLOOR PLAN)	PC	PHOTO ELECTRIC CELL		- OVERHEAD	_	
⊢	CONTACT - NORMALLY OPEN		CONNECT SWITCH	OS	OCCUPANCY SENSOR				
 	CONTACT - NORMALLY CLOSED	COMBINATIO	ON DISCONNECT/	#	LUMINAIRE TYPE		BURIED		
×	CAPACITOR C/W KVAR RATING	MAGNETICT	MOTOR STARTER	- √	LIGHTING SWITCH Y=3: THREE WAY				
DM	DIGITAL METERING		MBINATION MOTOR STARTER		Y=4: FOUR WAY Y=D: DIMMER Y=PL: PILOT LIGHT		ABBREVIA	ATIONS	5
SPD	SURGE PROTECTION DEVICE	UNIT HEATE			Y=OS: OCCUPANCY SENSOR	AHU AI	R HANDLE UNIT	LSIG	LONG-TIME, SHORT-TIME, INSTANTANEOUS, GROUND FAULT TRIP BREAKER
TVSS	TRANSIENT VOLTAGE SURGE SUPPRESSOR	PANEL BOA	RD - SURFACE MOUNTED				BOVE FINISHED FLOOR	MAU	MAKE-UP AIR UNIT
VFD	VARIABLE FREQUENCY DRIVE		L BOARD - FLUSH MOUNTED				JTOMATIC TRANSFER SWITCH ACK	MCC	MOTOR CONTROL CENTER
M	UTILITY METER	TRANSFORM	MER				JILDING MANAGEMENT SYSTEM	MD mmC	MOTORIZED DAMPER MILLIMETRE CONDUIT
\Box	ELECTRIC MOTOR - SINGLE	♦ HAND DRYE			COMMUNICATION		ATTERY CHARGER CABINET ANADIAN ELECTRICAL CODE	MP	MECHANICAL POWER PANEL 120/208V
\mathcal{O}	PHASE ELECTRIC MOTOR - THREE	☐ TERMINAL IN	MOTOR STARTER COMPARTMENT	4	VOICE OUTLET		EILING FAN/AIR CONDITIONER		NORMALLY CLOSED NORMALLY OPEN
P	PHASE	TERMINAL IN			DATA OUTLET		JSTOMER SERVICE TERMINATION ENCLOSURE 0V DISTRIBUTION PANEL BOARD	ОН	OVERHEAD
	DISTRIBUTION TRANSFORMER	INDICATING I		4	VOICE/DATA OUTLET		STRIBUTED CONTROL SYSTEM		OCCUPANCY SENSOR POWER MANAGEMENT CONTROL SYSTEM
Δ	DELTA CONNECTION	G R = RED A = AMBER G = GREEN			VOICE/DATA GOTLET		STRIBUTED CONTROL UNIT		POWER PANEL 120/208V
\forall	WYE CONNECTION		OLTAGE SUPPRESSOR		FIRE ALARM	DRI DI	GITAL REMOTE INTERFACE		RED ROOF TOP UNIT
Ť	WYE WITH SOLIDLY GROUNDED NEUTRAL	DUCT HEATE	R		MANUAL PULL STATION		CHAUST FAN QUIPMENT		RATE OF RISE
	GROUND	1Ø MOTOR			WALL MOUNTED HORN	ETR EL	ECTRICAL CABLE TRAY	SPM SS	SMART POWER METER SOFT STARTER
<u>÷</u>	CONNECTION	49 WINDING TEN	MPERATURE PROTECTION		WALL MOUNTED HORN/STROBE		RE ALARM CONTROL PANEL MOKE/HEAT DETECTOR	SP	SECURITY PANEL
O/ 100A #X	DISCONNECT SWITCH #X - NEMA	O CIRCUIT BRE	AKER) I	WALL MOUNTED STROBE	FK PL	JLL STATION	SPD SPT	SURGE PROTECTION DEVICE SPLITTER
6	RATING		ANSFORMER	₩	SMOKE DETECTOR		BRE.COMMUNICATIONS CABINET JLL VOLTAGE NON REVERSING STARTER		SWITCHBOARD
(°	STARTER - FVNR, FULL VOLTAGE	POTENTIAL T	RANSFORMER	•	HEAT DETECTOR		ILL VOLTAGE REVERSING STARTER		TRANSFORMER UNIT HEATER
<u> </u>	NON-REVERSING	3Ø МОТОК			RATE OF RISE THERMAL DETECTOR		ROUND DRN/STROBE		UNINTERRUPTABLE POWER SUPPLY
Ġ S		FUSE			DUCT SMOKE DETECTOR		FRARED		UPS DISTRIBUTION PANEL BOARD WHITE
ζ		J JUNCTION BO	DΧ	} 	END OF LINE RESISTOR		STRUMENTATION CABLE TRAY ONTROL PANEL		WATERPROOF
ledo	GROUND ROD			IM	INSULATION MODULE		GHTING PANEL 120/208V		EXPLOSION PROOF
						LCB LI	GHTING CONTROL PANEL	YLW	YELLOW

Public Works and Government Services Services gouvernementaux Canada

REAL PROPERTY SERVICES Western Region SERVICES IMMOBILIERS Région de l'ouest



SIGNED BY R. BOGDANOV

2020/06/23

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Signature SIGNED BY B.B. SIGNED ON 06.23.2020 PERMIT NUMBER: P 639 The Association of Professional Engineers

and Geophysicists of the NWT/NU.

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> **Public Works and Government Services** Canada

> 310- 269 Main Street, R3C 1B3 Winnipeg, MB

NUNAVUT EUREKA

EUREKA WATER AND SEWAGE SYSTEM

Designed by R. BOGDANOV Drawn by **R. CHAVEZ** Dessiné par P. BARSALOU M. MOGAN

> **ELECTRICAL LEGEND**

E-0000 R.037261.001 OF ----

LCP LIGHTING CONTROL PANEL

Titre du dessir



 EXISTING
 LEGEND - PLAN
 NEW

 — P
 ABOVEGROUND CABLE
 — P

 — — UG
 UNDERGROUND CABLE
 — — — UG

NOTES

- 1. CABLE ROUTES SHOWN ARE APPROXIMATE. SITE CONDITIONS MAY REQUIRE MODIFICATION OF ROUTE.
- 2. CONTRACTOR IS RESPONSIBLE FOR ALL SITE UNDERGROUND AND OVERHEAD SERVICES WITHIN THE WATER AND WASTEWATER INFRASTRUCTURE AND ASSOCIATED TRENCHING ROUTES.
- 3. CONTRACTOR TO BE RESPONSIBLE FOR ALL CABLES AND SERVICES DAMAGED BY CONSTRUCTION ACTIVITIES.
- 4. FENCE GROUNDING AS PER 36-312 OF CEC.

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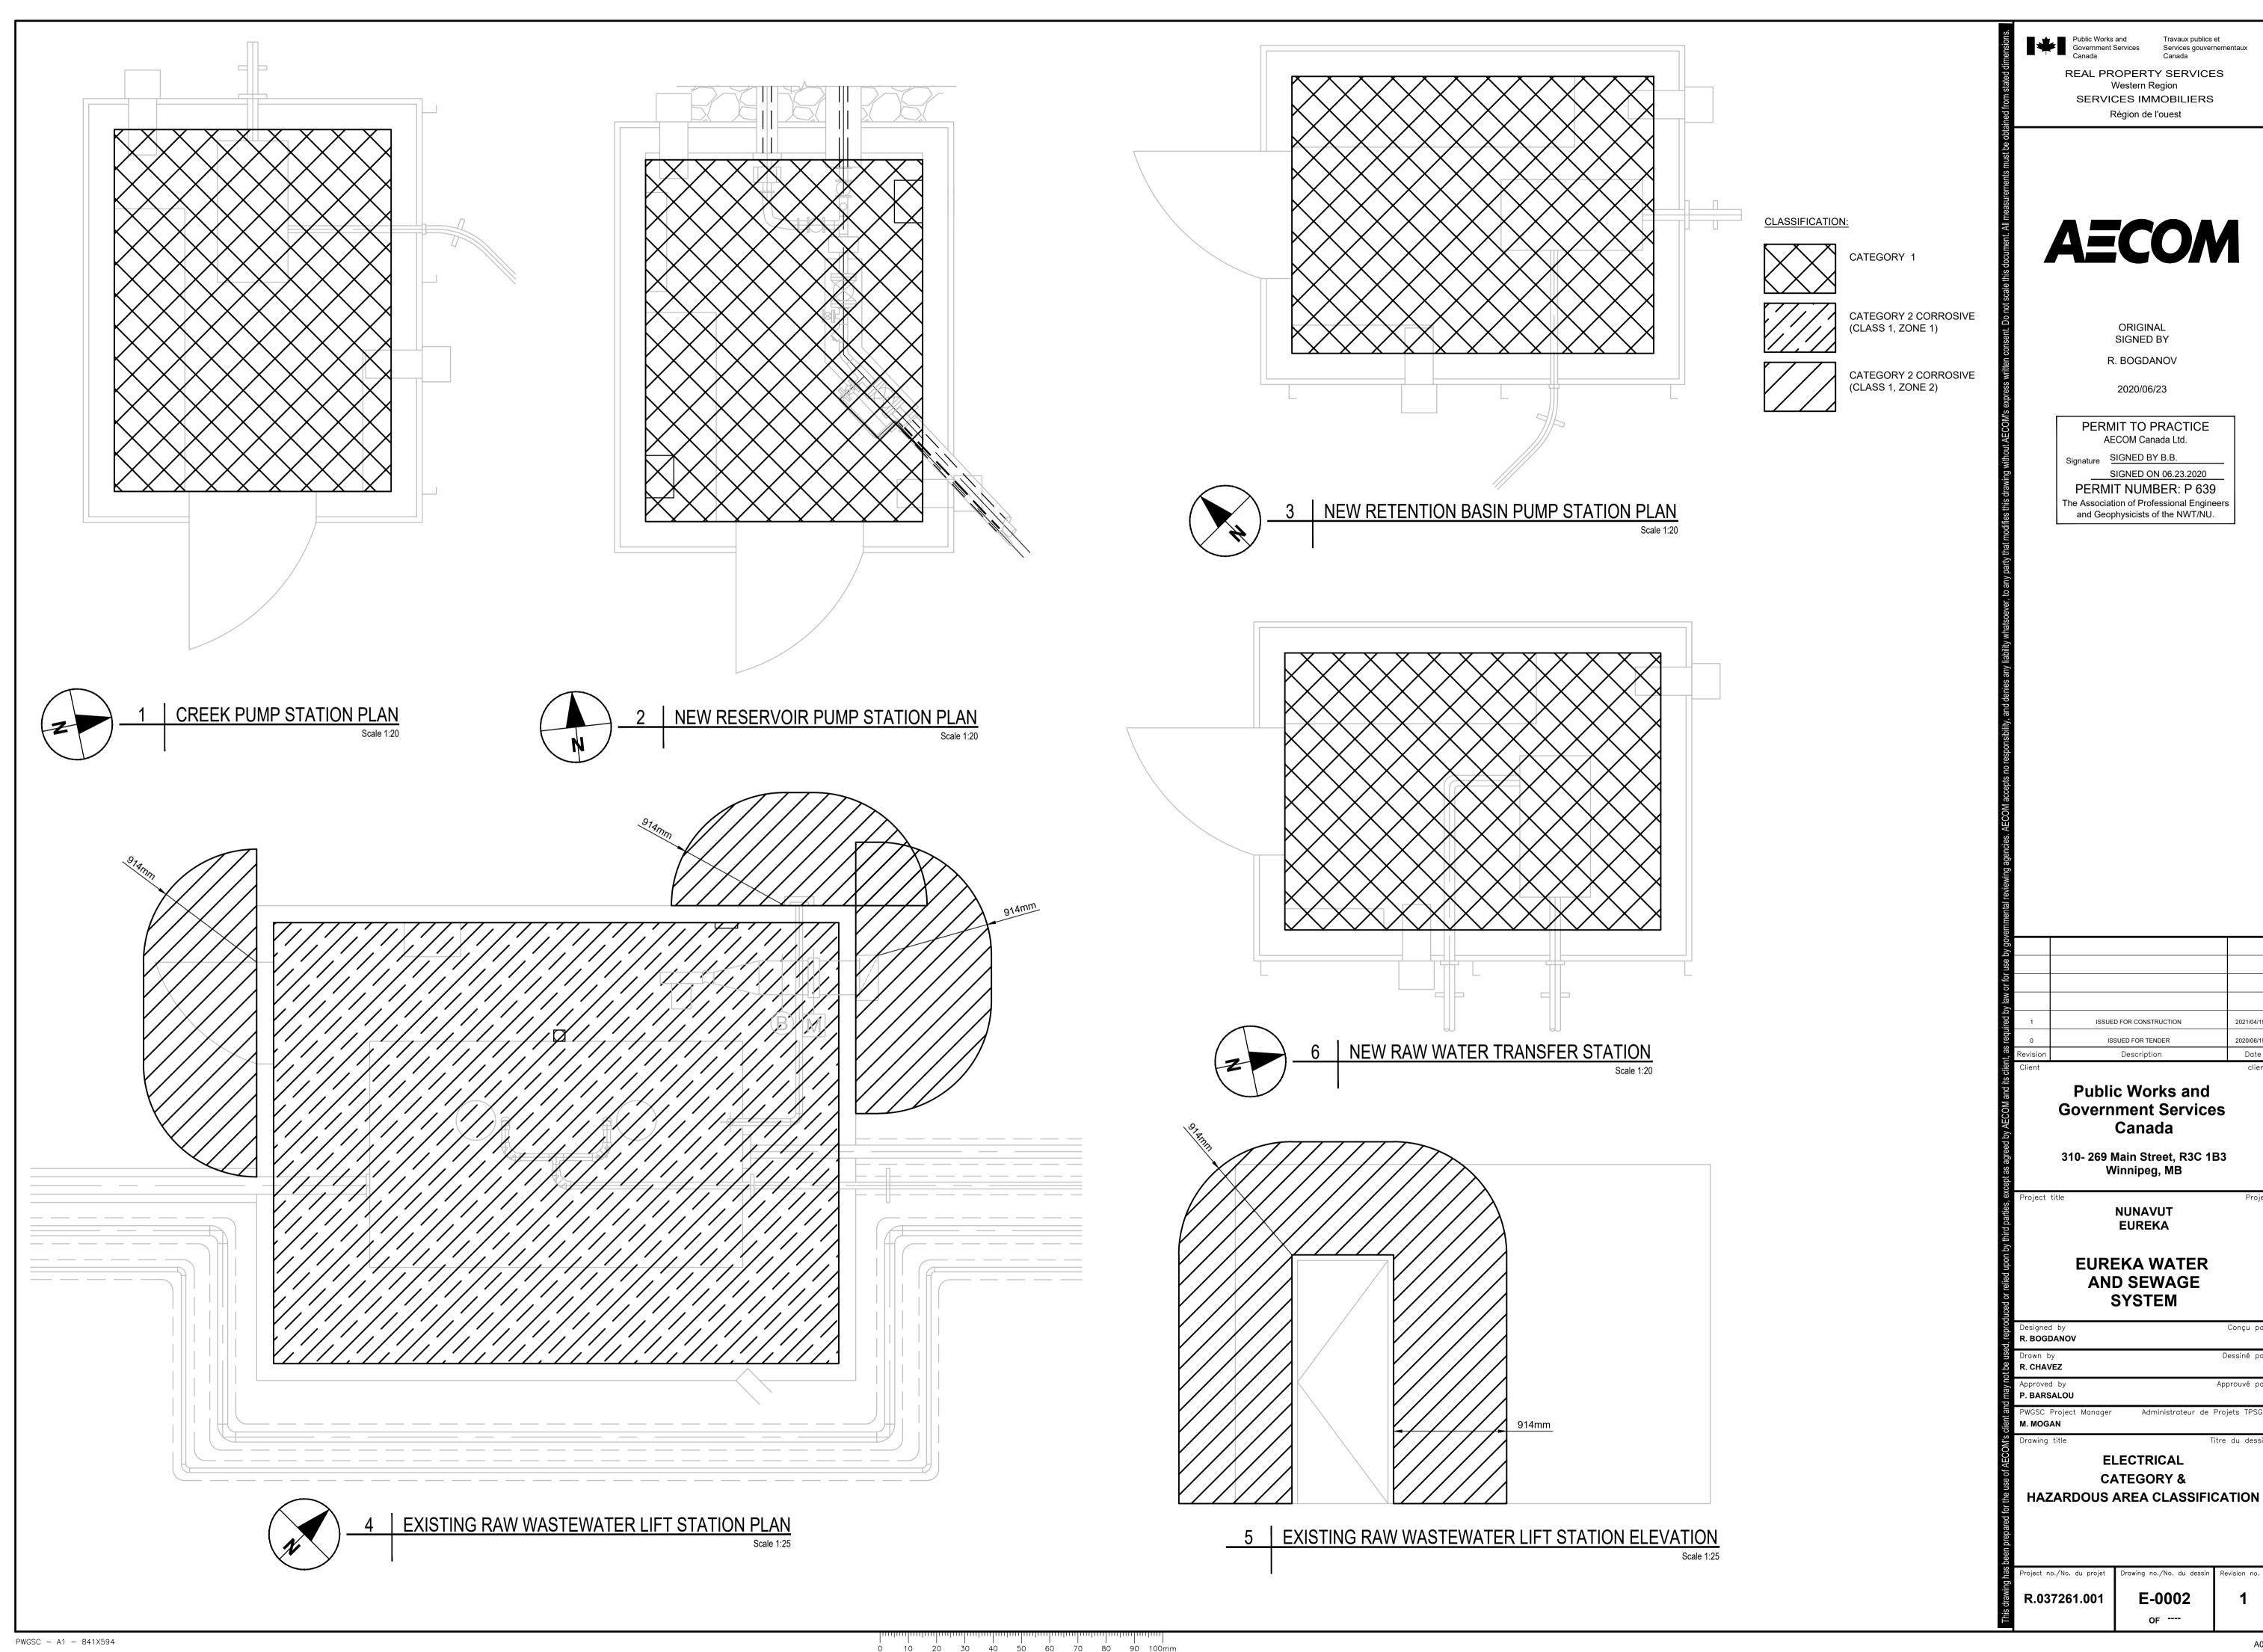
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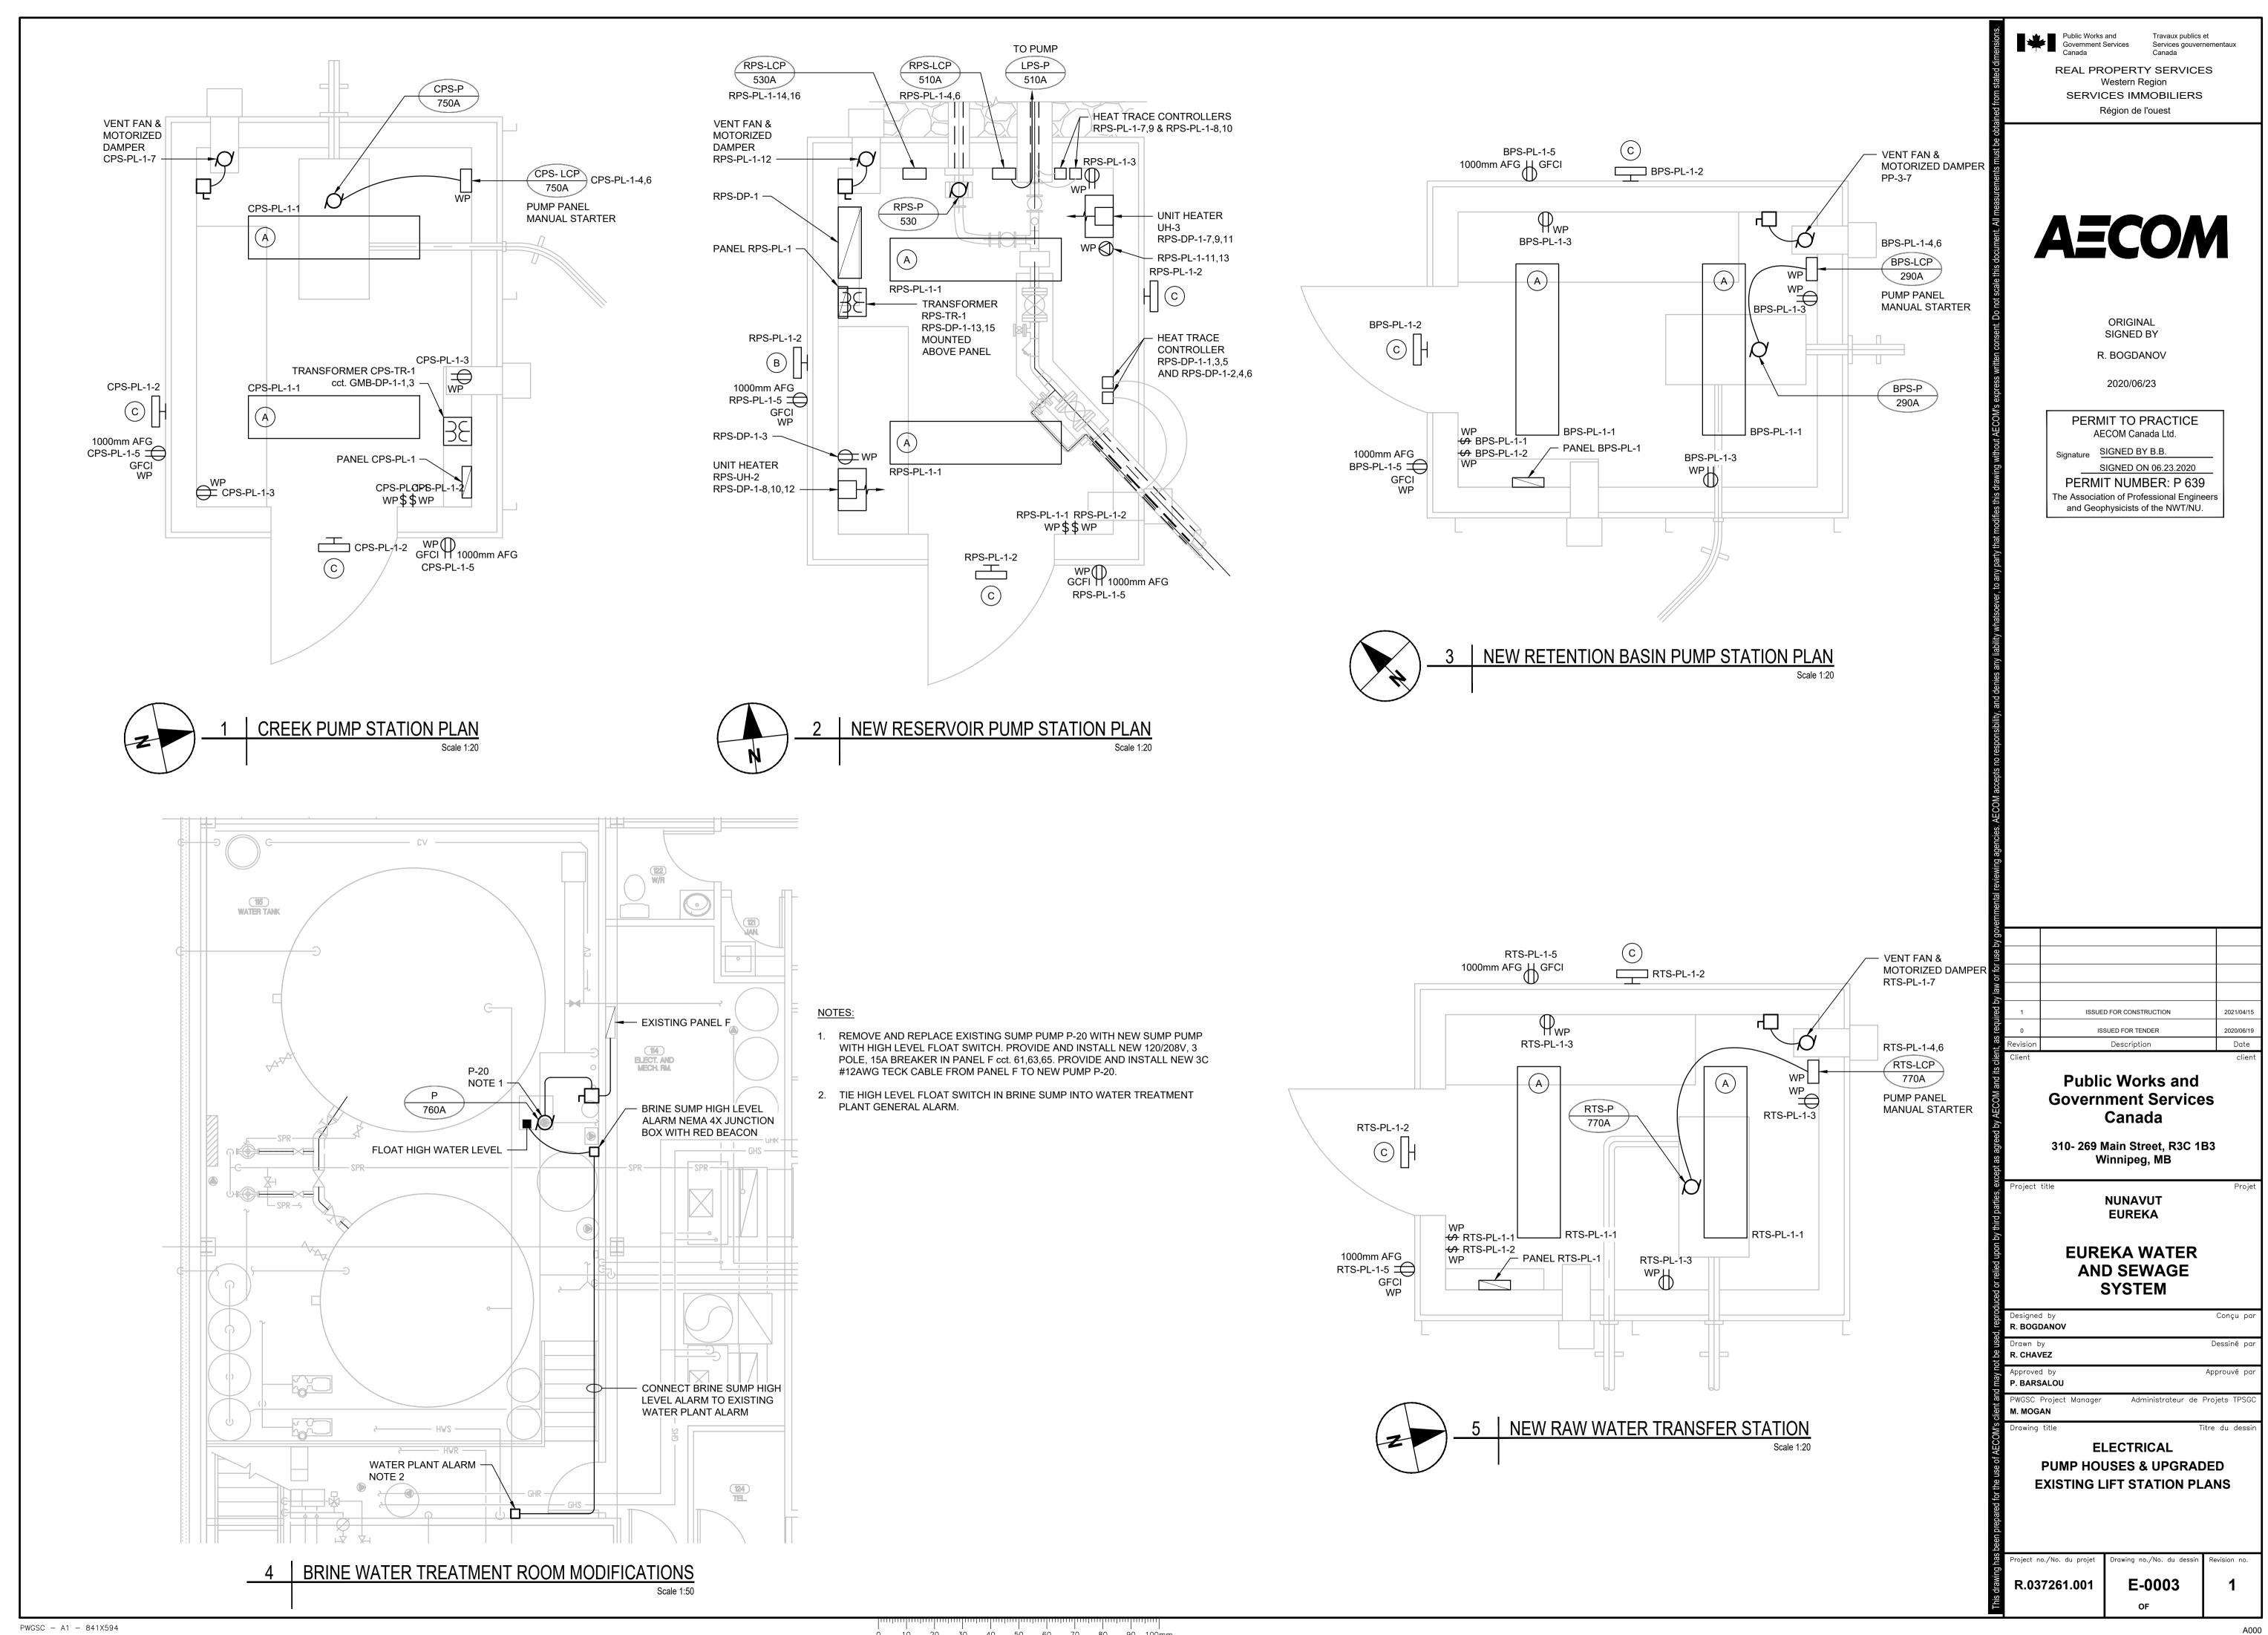
EUREKA WATER AND SEWAGE SYSTEM


R. BOGDANOV	20\$2 P.D.
Drawn by R. CHAVEZ	Dessiné par
Approved by P. BARSALOU	Approuvé par
PWGSC Project Manager M. MOGAN	Administrateur de Projets TPSGC
Drawing title	Titre du dessin
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SITE PLAN

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DEMOLITION NOTES:

- 1. THE ELECTRICAL CONTRACTOR SHALL NOT DISCONNECT EQUIPMENT AND ELECTRICAL CIRCUITS WITHOUT PRIOR NOTIFICATION AND PERMISSION FROM THE DEPARTMENTAL REPRESENTATIVE.
- 2. DEMOLISH ALL ELECTRICAL EQUIPMENT IN LIFT STATION BUILDING INCLUDING BUT NOT LIMITED TO PUMPS, ELECTRICAL PANEL, LIGHTING FIXTURES, CONDUITS AND WIRING, INSTRUMENTS, SWITCHES, CONTROL PANELS, ETC. ALL DEMOLISHED EQUIPMENT SHALL BE RETURNED TO OWNER.
- 3. CONTRACTOR WILL BE RESPONSIBLE FOR PATCHING ALL OPENINGS IN EXISTING CONSTRUCTION AFTER REMOVAL OF EQUIPMENT AND ELECTRICAL DEVICES.

INSTALLATION NOTES:

- 1. ALL ELECTRICAL EQUIPMENT IN LIFT STATION SHALL BE ZONE 1 HAZARDOUS LOCATION RATED (SECTION 18, CEC).
- 2. ALL ELECTRICAL INSTALLATION SHALL MEET REQUIREMENTS OF SECTION 18, CEC FOR ZONE 1 (CLASS 1, ZONE 1).
- 3. ZONE 2 RATED 30 MINUTE MECHANICAL TIMER TO ENERGIZE MOTORIZED DAMPER. WHEN DAMPER IS FULLY OPEN TURN ON EXHAUST FAN EF-1.
- 4. GENERAL ALARM FROM PACKAGED PLANT TO BE WIRED TO GENERAL LIFT STATION ALARM.
- 5. TIE NEW PANEL INTO EXISTING LIFT STATION ALARM. REPLACE WIRE TO MEET ZONE 1 RATING.
- USE HAZARDOUS LOCATION RATED FOR ZONE 1 TECK CABLES WITH XP RATED TECK CONNECTORS FOR ALL CABLING WITHIN THE RAW WASTEWATER LIFT STATION.

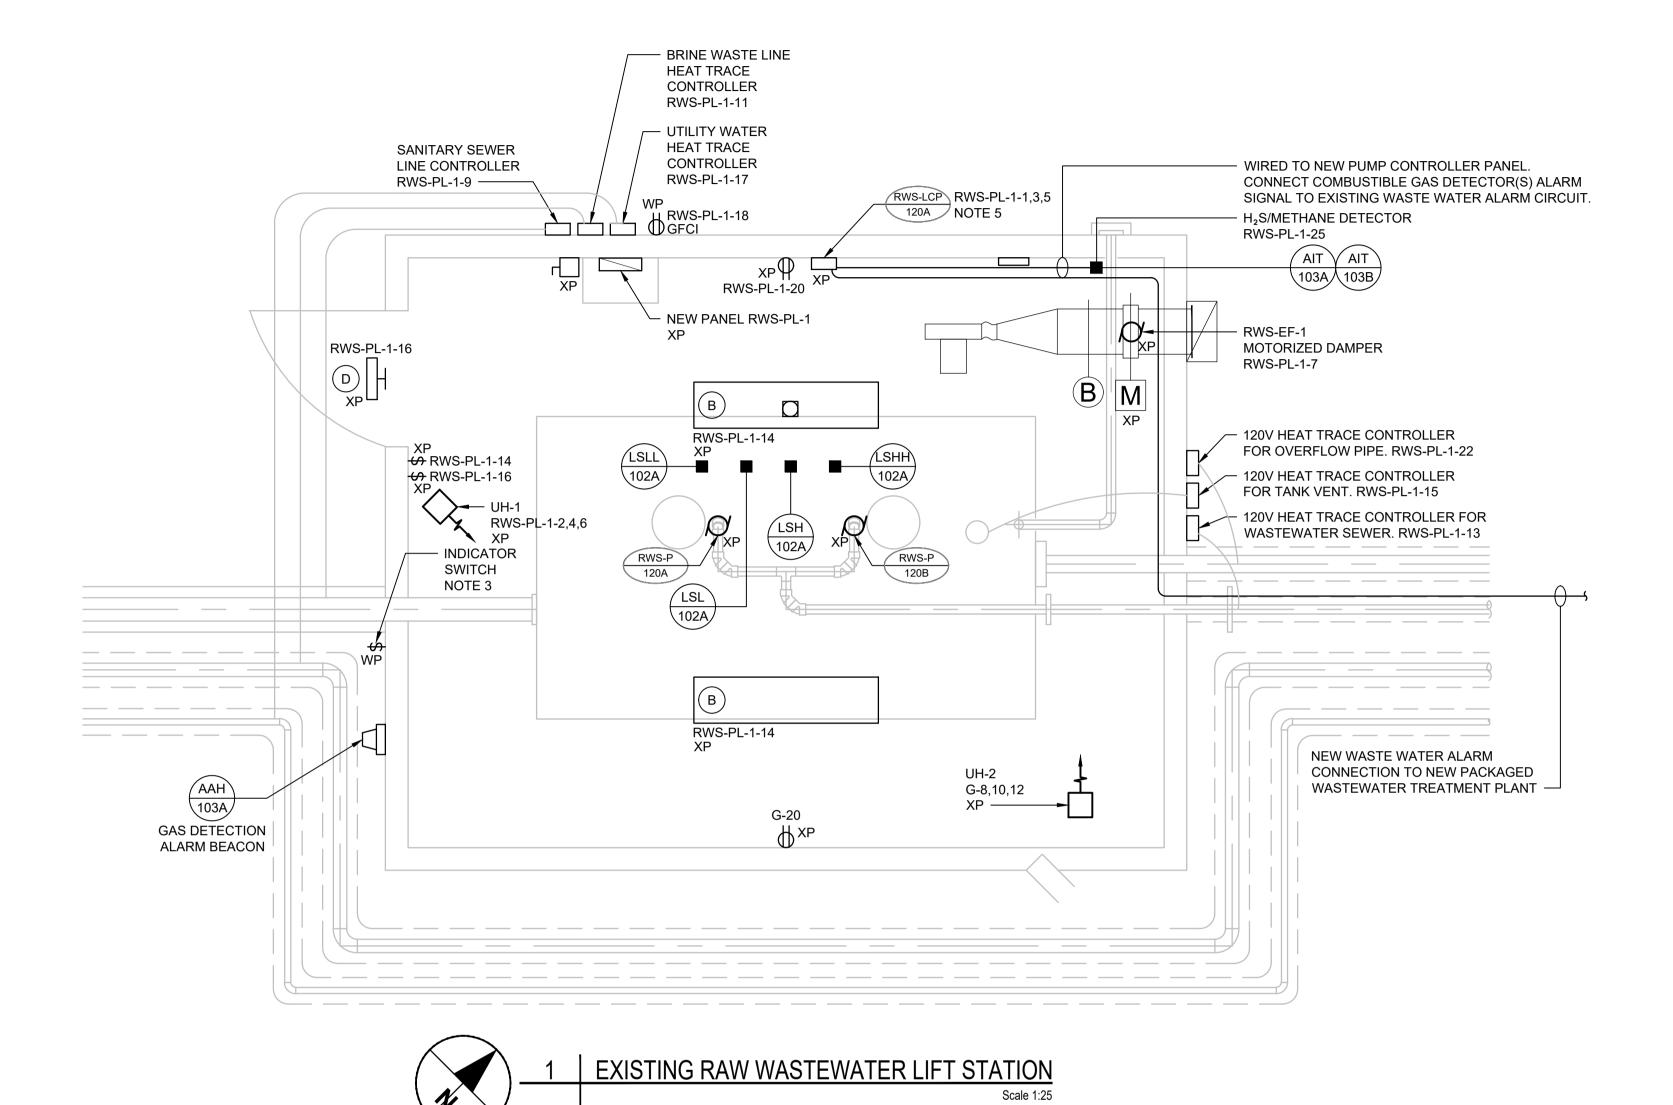Public Works and Government Services Canada

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ORIGINAL SIGNED BY R. BOGDANOV

2020/06/23

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SIGNED ON 06.23.2020

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ob lissued for construction 2021/04/18

1 ISSUED FOR CONSTRUCTION 2021/04/18

0 ISSUED FOR TENDER 2020/06/19

Revision Description Date

Client Client

Public Works and Government Services Canada

310- 269 Main Street, R3C 1B3 Winnipeg, MB

Project title

NUNAVUT EUREKA

EUREKA WATER AND SEWAGE SYSTEM

Designed by

R. BOGDANOV

Drawn by

R. CHAVEZ

Approved by

P. BARSALOU

PWGSC Project Manager

M. MOGAN

Dessiné po

Approuvé po

Administrateur de Projets TPSG

M. MOGAN

Drawing title

Titre du dess


ELECTRICAL
EXISTING LIFT STATION PLAN

Project no./No. du projet Drawing no./No. du dessin Revision no.

Revision no.


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2 EXISTING CHLORINATION SYSTEM FOR DEMOLITION

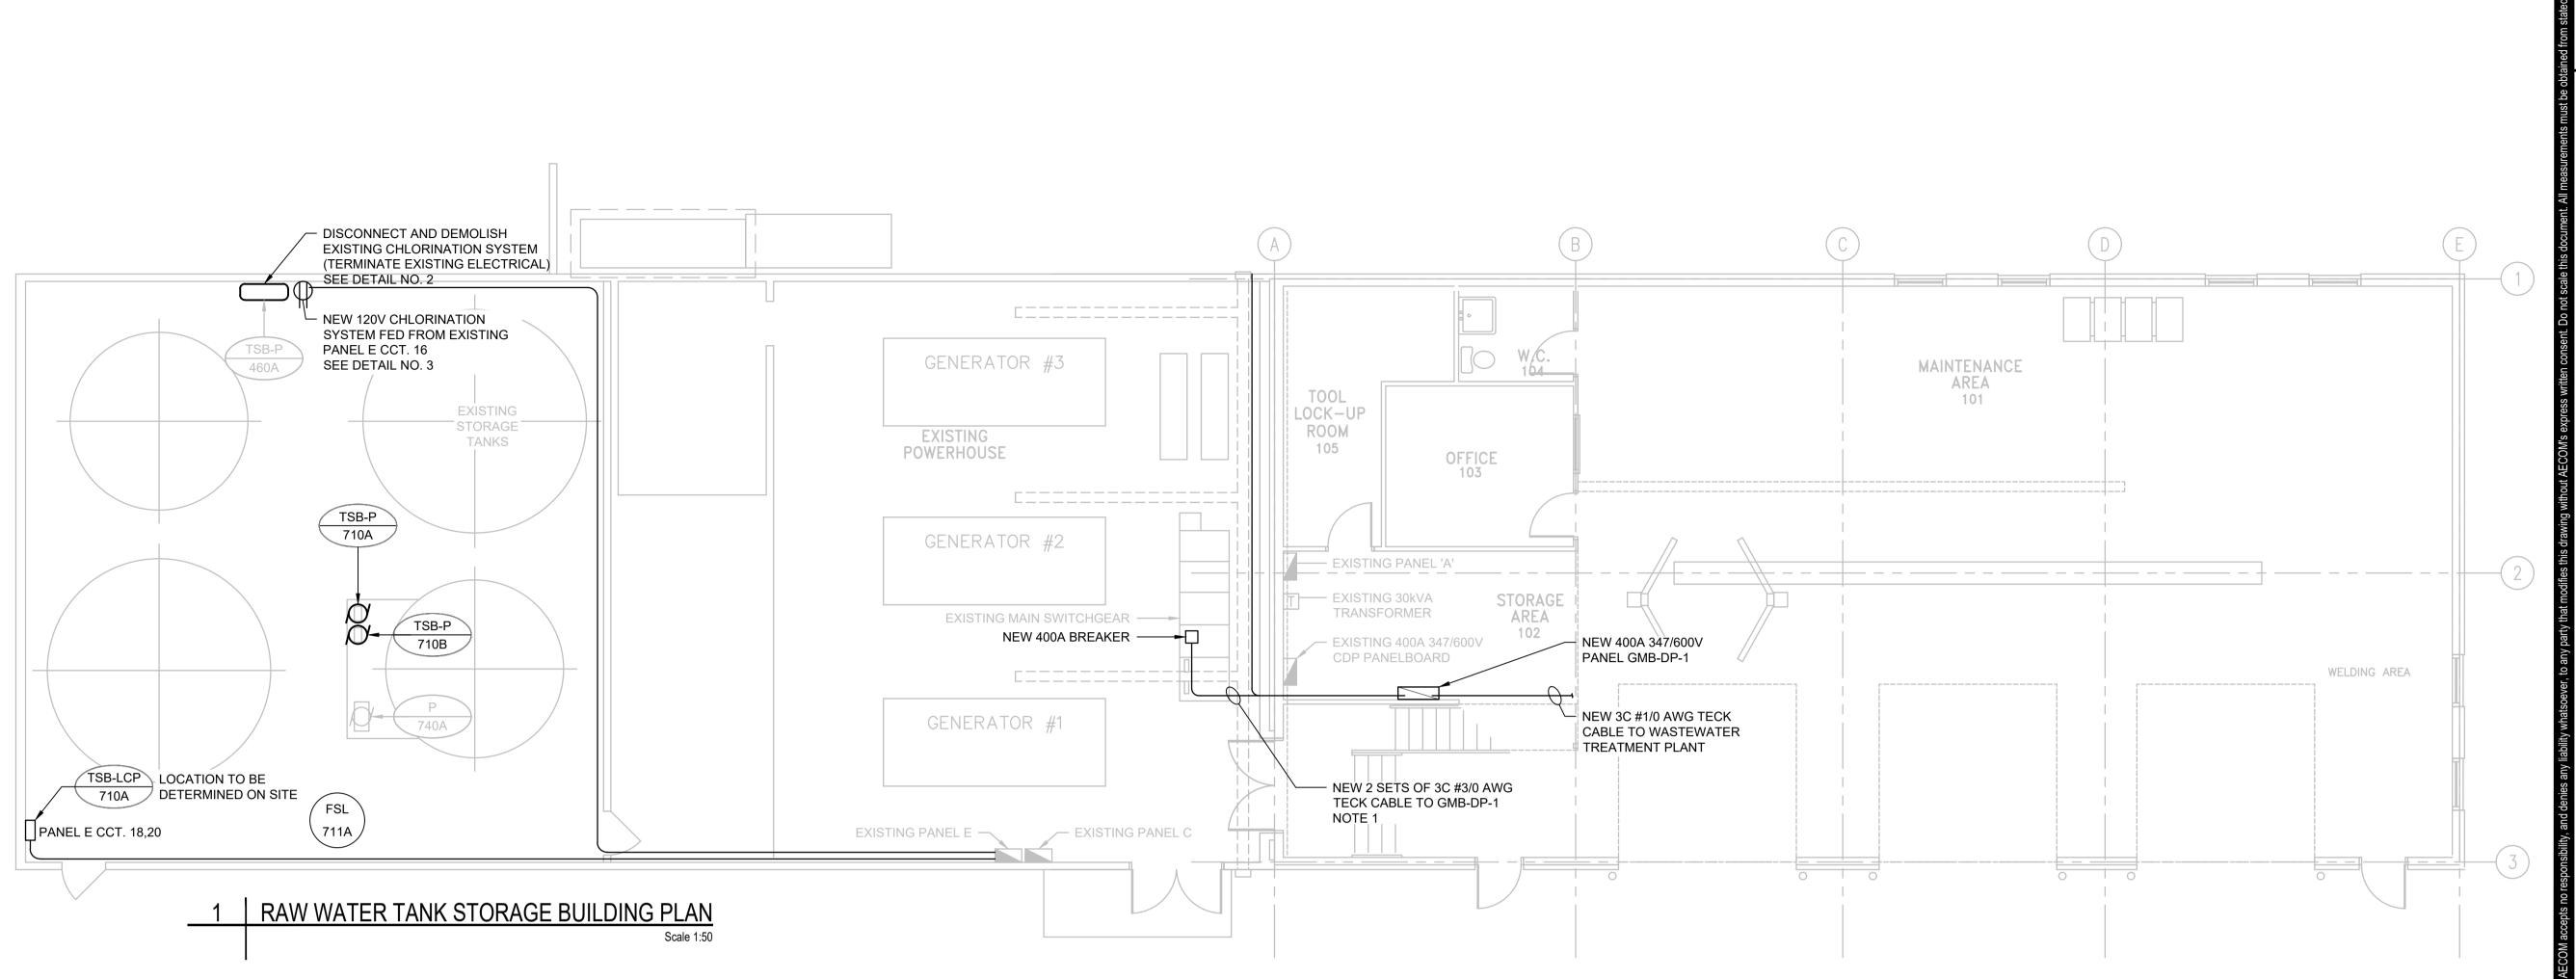

3 NEW CHLORINATION SYSTEM

NOTES:

1. MAINTAIN 100% SPACING BETWEEN POWER CABLES OR DE-RATE CABLES ACCORDING TO TABLE 5C OF CEC. PROVIDE BARRIER BETWEEN POWER AND CONTROL CABLES.

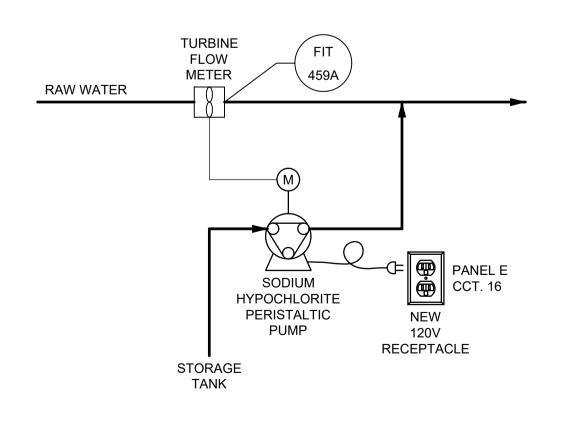AECOM

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NUNAVUT **EUREKA**

> **EUREKA WATER AND SEWAGE**

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ed, repro	Designed by R. BOGDANOV			Conçu par
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d may no	Approved by P. BARSALOU			Approuvé par
f AECOM's client and may not be	PWGSC Project M. MOGAN	Manager	Administrateur	de Projets TPSGC
S/MC	Drawing title			Titre du dessin
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GENERATOR BUILDING PLAN

E-0005 R.037261.001

CCT. NO.	DESCRIPTION	BKR	Α	В	BKR	DESCRIPTION	CCT. NO.
1	LIGHTING	15A	*		15A	EXTERIOR LIGHTING	2
3	RECEPTACLES	15A		*	15A	CPS-LCP-750A	4
5	EXTERIOR RECEPTACLES	15A	*		2P	CPS-LCP-750A	6
7	VENT. FAN	15A		*	15A	SPARE	8
9	SPARE	15A	*		15A	SPARE	10
11	SPACE			*		SPACE	12
13	SPACE		*			SPACE	14
15	SPACE			*		SPACE	16
17	SPACE		*			SPACE	18
19	SPACE			*		SPACE	20
21	SPACE		*			SPACE	22
23	SPACE			*		SPACE	24
25	SPACE		*			SPACE	26
27	SPACE			*		SPACE	28
29	SPACE		*			SPACE	30
/OL TA	25. 420/240V 4 Dhoop 2 Wire				LOCATION	ODEEN DUMB OTATION	
	GE: 120/240V, 1 Phase, 3 Wire				FED FROM :	CREEK PUMP STATION	

BREAKER I.C.: 10KA

MOUNTING: SURFACE

MAINS: 400A

NOTES:

MOUNTING: SURFACE

CCT. NO.	DESCRIPTION	BKR	А	В	С	BKR	DESCRIPTION	CCT.
1	CREEK PUMP HOUSE	20A	*			30A	RAW WATER RESERVOIR	2
3	CREEK PUMP HOUSE	2P		*		2P	PUMP HOUSE	4
5					*			6
7	FAN #1	15A 3P	*			15A 3P	FAN #2	8
9				*				10
11	RAW WASTEWATER LIFT STATION				*		NEW PACKAGED WASTEWATER TREATMENT PLANT	12
13		30A 3P	*			90A 3P		14
15				*				16
17	NEW RAW WATER	15A			*			18
19	TRANSFER STATION	2P	*			30A 3P	SPARE	20
21	SPARE	15A		*				22
23	SPARE	15A			*		SPACE	24
25	SPACE		*				SPACE	26
27	SPACE			*			SPACE	28
29	SPACE				*		SPACE	30

FEEDER:

BREAKER I.C. : 25KA

	LUMINAIRE SCHEDULE								
SYMBOL	LABEL	TYPE	VOLTS	LAMP	DESCRIPTION	MOUNTING			
	A	LED	120V	N/A	INDUSTRIAL LINEAR LED LUMINAIRE WITH FIBERGLASS HOUSING , STAINLESS STEEL WIRE GUARD, 3500K, MINIMUM 50000 LIFETIME HOURS, NEMA 4X. ARCTIC WEATHER RATED.	CEILING MOUNTED			
	В	LED	120V	N/A	INDUSTRIAL LINEAR LED LUMINAIRE, STAINLESS STEEL WIRE GUARD, 3500K, MINIMUM 50000 LIFETIME HOURS, RATED FOR ZONE 1 (CLASS 1, ZONE 1 HAZARD LOCATION)	CEILING MOUNTED			
	С	LED	120V	N/A	LED LUMINAIRE WITH DIE-CAST ALUMINUM HOUSING, GASKETED, STAINLESS STEEL WIRE GUARD, RATED FOR OUTDOOR AND ARCTIC WEATHER INSTALLATIONS.	WALL MOUNTED			
	D	LED	120V	N/A	LED LUMINAIRE WITH DIE-CAST ALUMINUM HOUSING, GASKETED, STAINLESS STEEL WIRE GUARD, RATED FOR CLASS 1, ZONE 2. ARCTIC WEATHER RATED.	WALL MOUNTED			

CCT. NO.	DESCRIPTION	BKR	А	В	BKR	DESCRIPTION	CCT NO.	
1	LIGHTING	15A	*		15A	EXTERIOR LIGHTING	2	
3	RECEPTACLES	15A		*	15A	DDC L OD 540A	4	
5	EXTERIOR RECEPTACLES	15A	*		2P	RPS-LCP-510A		
7	HEAT TRACE CONTROLLER	20A		*	20A	HEAT TRACE CONTROLLER	8	
9	GFCI	2P	*		2P	GFC	10	
11	DDC L OD 540A	15A		*	15A	VENT FAN	12	
13	RPS-LCP-510A	2P	*		15A	SPARE	14	
15	SPARE	15A		*	15A	SPARE	16	
17	SPACE		*			SPACE	18	
19	SPACE			*		SPACE	20	
21	SPACE		*			SPACE	22	
23	SPACE			*		SPACE	24	
25	SPACE		*			SPACE	26	
27	SPACE			*		SPACE	28	
29	SPACE		*			SPACE	30	
VOLTA	GE: 120/240V, 1 Phase, 3 Wire				LOCATION	ON : NEW RESERVOIR PUMP STATION		
MAIN B	REAKER: 60A				FED FROM: RPS-TR-1			
MAINS:	100A				FEEDER	₹:		
MOUNT	TING: SURFACE				BREAKE	ER I.C. : 10KA		
NOTES	:							

CCT. NO.	DESCRIPTION	BKR	A	В	С	BKR	DESCRIPTION	CCT NO
1			*					
3	RWS-LCP-120A	20A 3P		*		20A 3P	5kW RWS-UH-1 UNIT HEATER	4
5		0.			*			
7	EF-1 MOTORIZED DAMPER	15A	*					
9	SANITARY SEWER HEAT TRACE	15A		*		20A 3P	5kW RWS-UH-2 UNIT HEATER	10
11	BRINE LINE HEAT TRACE	15A			*			
13	WASTEWATER SEWER HEAT TRACE	15A	*			15A	LIGHTING	
15	TANK VENT HEAT TRACE	15A		*		15A	5A EXTERIOR LIGHTING	
17	UTILITY WATER HEAT TRACE	15A			*	15A	EXTERIOR RECEPTACLE	18
19			*			15A	INTERIOR RECEPTACLES	20
21	SPARE	20A 3P		*		15A	OVER FLOW HEAT TRACE	22
23					*	15A	SPARE	24
25			*			15A	SPARE	26
27	SPARE	15A 3P		*		15A	SPARE	28
29		0.			*	15A	SPARE	30
	GE: 120/208V, 3 Phase, 4 Wire				-		RAW WASTEWATER LIFT STATION	
	REAKER: 100A				FED FROM: RWS-TR-1			
MAINS:						EDER :		
MOUNT NOTES	TING: SURFACE				BR	EAKER I.C	C. : 10KA	

CCT. NO.	DESCRIPTION	BKR	А	В	С	BKR	DESCRIPTION	CCT NO
1			*					2
3	HEAT TRACE 15A * 15A 3P 3P		15A 3P	HEAT TRACE	4			
5					*	.		6
7			*					8
9	5kW UNIT HEATER RPS-UH-1	15A 3P		*		15A 3P	5kW UNIT HEATER RPS-UH-2	10
11					*			12
13	PANEL RPS-PL-1	15A	*					14
15	PANEL RPS-PL-1	2P		*		15A 3P	SPARE	16
17	SPACE				*			18

INTERNAL GFCI PROTECTION, GFCI BREAKERS NOT REQUIRED.

1. PROVIDE GFCI BREAKERS FOR HEAT TRACE CONTROLLERS.

2. ZONE 1, CATEGORY 2 RATED.

MAINS: 225A

MOUNTING: SURFACE

CCT. NO.	DESCRIPTION	BKR	A	В	BKR	DESCRIPTION	CCT NO.
1	LIGHTING	15A	*		15A	EXTERIOR LIGHTING	2
3	RECEPTACLES	15A		*	15A	BPS-LCP-290A	
5	EXTERIOR RECEPTACLES	15A	*		2P		
7	VENT. FAN	15A		*	15A	SPARE	8
9	SPARE	15A	*		15A	SPARE	10
11	SPACE			*		SPACE	12
13	SPACE		*			SPACE	14
15	SPACE			*		SPACE	16
17	SPACE		*			SPACE	18
19	SPACE			*		SPACE	20
21	SPACE		*			SPACE	22
23	SPACE			*		SPACE	24
25	SPACE		*			SPACE	26
27	SPACE			*		SPACE	28
29	SPACE		*			SPACE	30
VOLTA	GE: 120/240V, 1 Phase, 3 Wire				LOCATION	ON : NEW RETENTION BASIN PUMP STA	ATION
MAIN B	REAKER: 60A				FED FR	OM : HYD-01	
MAINS:	100A				FEEDER	₹:	
MOUNT	TING: SURFACE				BREAKE	ER I.C. : 10KA	

CCT. NO.	DESCRIPTION	BKR	А	В	С	BKR	DESCRIPTION	CCT NO.	
1	TANK ROOM UNIT HEATERS	15A	*						
3	TANK ROOM LIGHTS	15A		*		40A 3P	SPARE	4	
5	TANK ROOM PLUGS	15A			*				
7	ROOF FANS	15A	*			20A	HEAT TRACE GFI	8	
9	HEAT TRACE	15A		*		20A	LIGHT	10	
11	SPACE				*	20A	LUCLIDAY	12	
13			*			2P	HIGH BAY	14	
15		15A 3P		*		15A	CHLORINATION SYSTEM	16	
17					*	15A	TSB-LCP-710A	18	
19		30A	*			2P	15B-LCP-710A	20	
21	UNKNOWN	2P		*		15A	SPARE	22	
23	SPARE	15A			*	15A	SPARE	24	
25	SPARE	15A	*			15A	SPARE	26	
27	SPACE			*			SPACE	28	
29	SPACE				*		SPACE	30	
VOLTA	GE: 120/240V, 3 Phase, 3 Wire				LC	OCATION : RAV	W WATER TANK STORAGE BUILD	ING	
	REAKER:				FED FROM:				
MAINS:					FE	EDER :			
MOUNT	TING: SURFACE				BF	REAKER I.C. :	10KA		

	NE	W PAN	1E	L	RTS-F	PL-1	
CCT. NO.	DESCRIPTION	BKR	А	В	BKR	DESCRIPTION	CCT NO.
1	LIGHTING	15A	*		15A	EXTERIOR LIGHTING	2
3	RECEPTACLES	15A		*	15A 2P RTS-LCP-770A		4
5	EXTERIOR RECEPTACLES	15A	*				6
7	VENT. FAN	15A		*	15A	SPARE	8
9	SPARE	15A	*		15A	SPARE	10
11	SPACE			*		SPACE	12
13	SPACE		*			SPACE	14
15	SPACE			*		SPACE	16
17	SPACE		*			SPACE	18
19	SPACE			*		SPACE	20
21	SPACE		*			SPACE	22
23	SPACE			*		SPACE	24
25	SPACE		*			SPACE	26
27	SPACE			*		SPACE	28
29	SPACE		*			SPACE	30
29	SPACE		*			SPACE	3
/OLTA	GE: 120/240V, 1 Phase, 3 Wire				LOCATION	: RAW WATER TRANSFER STATION	
/AIN B	REAKER: 60A				FED FROM	: RTS-TR-1	
//AINS:	100A				FEEDER:		
/OUNT	ING: SURFACE				BREAKER I.	.C. : 10KA	

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REAL PROPERTY SERVICES Western Region

SERVICES IMMOBILIERS Région de l'ouest

SIGNED BY R. BOGDANOV

2020/06/23

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NUNAVUT EUREKA

EUREKA WATER AND SEWAGE SYSTEM


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	Drawn by R. CHAVEZ		Dessiné par
d may not be	Approved by P. BARSALOU		Approuvé par
OM's client and	PWGSC Project M. MOGAN	Manager	Administrateur de Projets TPSGC
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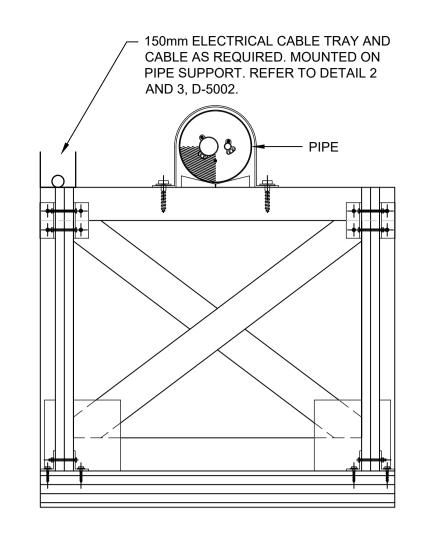
ELECTRICAL SCHEDULES

E-0006 R.037261.001


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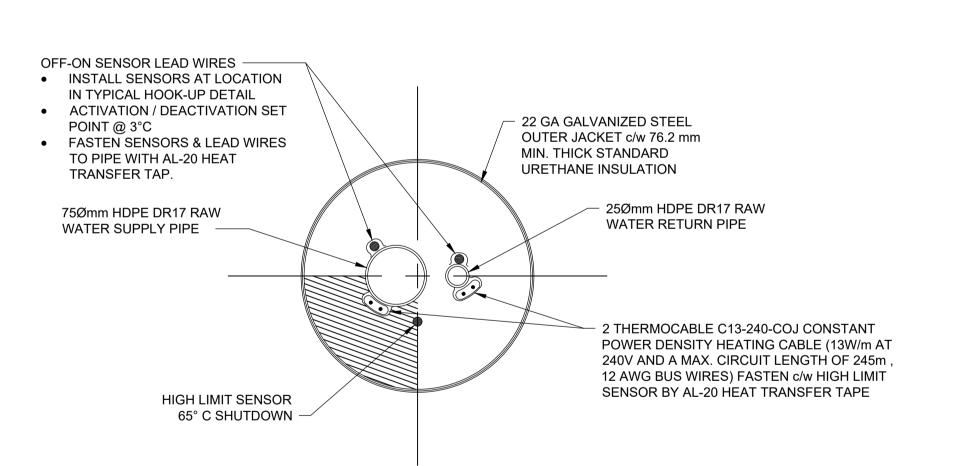


1 CABLE TRAY AND PIPE SUPPORT DETAIL

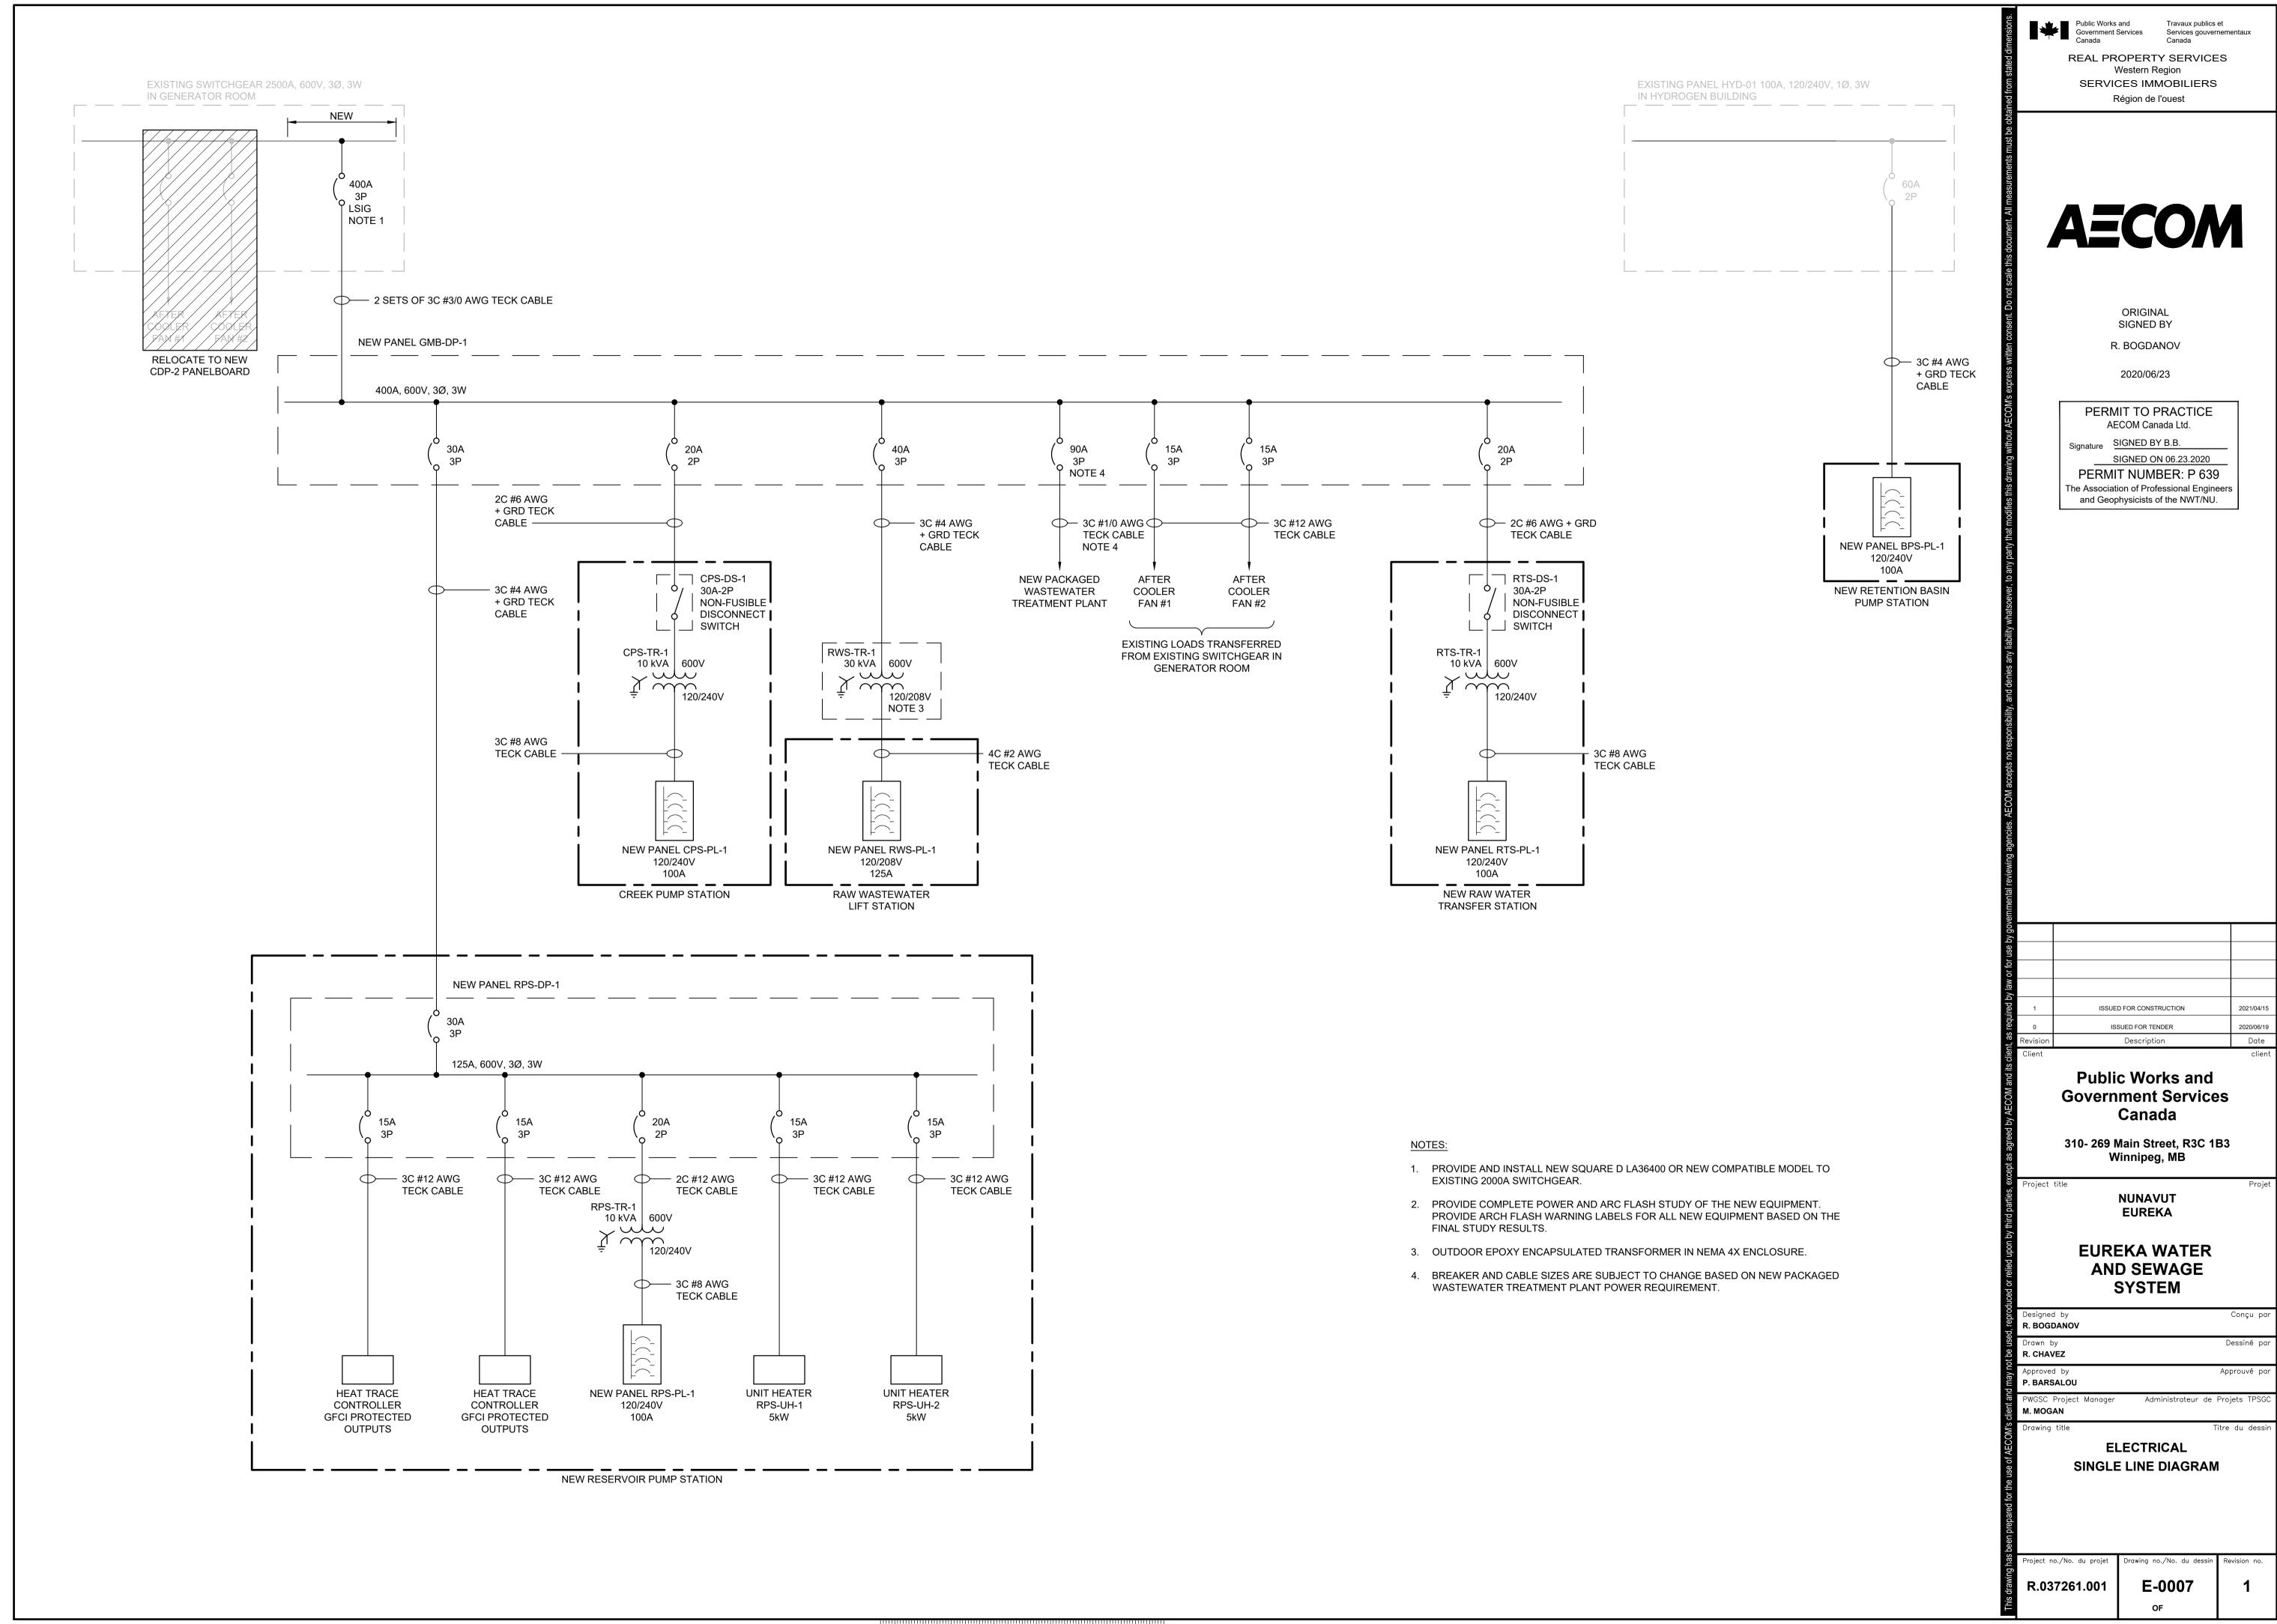

- SENSORS TO BE 2-LEAD-TYPE THERMISTORS WHICH SENSE TEMP. CHANGE WITH CHANGE IN ELECTRICAL RESISTANCE.
- REQUIRE EXTRA LONG LEAD FOR ON-OFF SENSOR AS DETAILED

(THERMISTORS, CONTROLLER, ELECTRIFICATION AND EXTENSION OF SERVICE TO BE BY OTHERS)

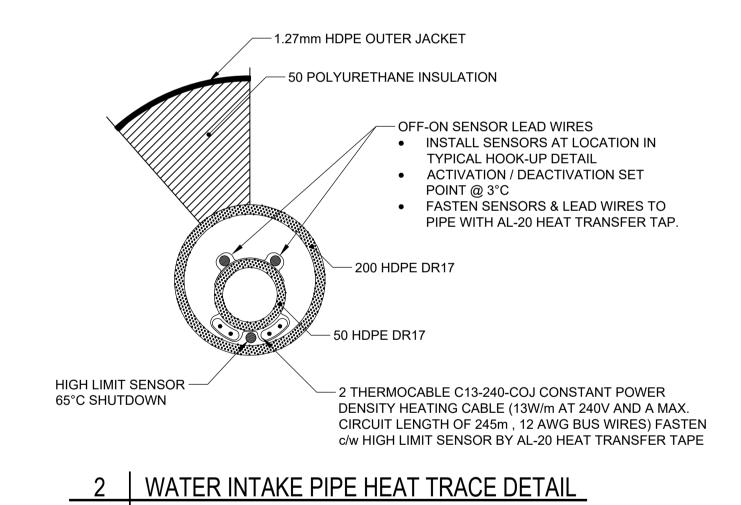

3 RAW WATER SUPPLY AND RETURN PIPE DETAIL

Public Works and Government Services Services gouvernementaux Canada

REAL PROPERTY SERVICES Western Region SERVICES IMMOBILIERS Région de l'ouest



ORIGINAL SIGNED BY R. BOGDANOV

2020/06/23

PERMIT TO PRACTICE AECOM Canada Ltd.

Signature SIGNED BY B.B.

SIGNED ON 06.23.2020 PERMIT NUMBER: P 639 The Association of Professional Engineers and Geophysicists of the NWT/NU.

1	ISSUED FOR CONSTRUCTION	2021/04/15
0	ISSUED FOR TENDER	2020/06/19
Revision	Description	Date
Client		client

Public Works and **Government Services** Canada

310- 269 Main Street, R3C 1B3 Winnipeg, MB

NUNAVUT

EUREKA WATER AND SEWAGE

SYSTEM

EUREKA

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